MAINE TURNPIKE AUTHORITY

MICHAEL J. CIANCHETTE, CHAIR JANE L. LINCOLN, MEMBER THOMAS J. ZUKE, MEMBER ANDREW MCLEAN, MEMBER NINA A. FISHER, MEMBER BRUCE VAN NOTE, MEMBER EX-OFFICIO

PETER S. MERFELD, P.E., INTERIM EXECUTIVE DIRECTOR

CONTRACT 2025.02 PORTLAND AREA PAVEMENT REHABILITATION NORTHBOUND MM 42.0 TO MM 49.3

LOCATION MAP

PORTLAND

BIDDEFORD KENNEBUNK

WELLS

NORTH BERWICK YORK MAINLINE PLAZA

SOUTH

OGUNQUIT

YORK BEACH

PORTSMOUTH

ATLANTIC OCEAN

11/12/24 11/12/24

CONTRACT 2025.02

PORTLAND AREA PAVEMENT REHABILITATION

HATB



INDEX OF SHEETS

SHEET NO.

DESCRIPTION TITLE SHEET **GENERAL NOTES** TYPICAL SECTIONS

22-50 GENERAL PLANS

MISCELLANEOUS DETAILS 13-21 TRAFFIC CONTROL DETAILS

	ESTIMATED QUANTITIES		
ITEM NO.	DESCRIPTION	TOTAL QUANTITY	UNI
202,202	REMOVING PAVEMENT SURFACE - MAINLINE	37,500	SY
202.205	RUMBLE STRIPS	54,000	EΑ
203.20	COMMON EXCAVATION	70	CY
304.10	AGGREGATE SUBBASE COURSE - GRAVEL	345	CY
304.14	AGGREGATE BASE COURSE - TYPE A	260	CY
403.208/	HOT MIX ASPHALT - 12.5 MM NOMINAL MAXIMUM SIZE (POLYMER MODIFIED)	23,000	T
403.211	HOT MIX ASPHALT, 9.5 MM NOMINAL MAXIMUM SIZE (SHIMMING)	600	T
403.213	HOT MIX ASPHALT, I2.5 MM NOMINAL MAXIMUM SIZE (BASE AND INTERMEDIATE BASE COURSE)	1,900	T
409.152	BITUMINOUS TACK COAT TRACKLESS - APPLIED	20,000	GAL
424.3231	ASPHALT RUBBER MASTIC CRACK SEALER - APPLIED	36,000	LB
424.324	ASPHALT RUBBER MASTIC CRACK SEALER WITH AGGREGATE	4,000	LB
427.09	PAVEMENT CRACK REPAIR	300	LF
470.08	BERM DROPOFF CORRECTION - GRINDINGS	41,800	LF
470.081	BERM CORRECTION	2,600	LF
604.18	ADJUSTING MANHOLE OR CATCH BASIN TO GRADE	38	EΑ
606.178	GUARDRAIL BEAM	300	LF
606.352	REFLECTORIZED BEAM GUARDRAIL DELINEATORS	120	EA
606.353	REFLECTORIZED FLEXIBLE GUARDRAIL MARKER	5	EΑ
606.3621	GUARDRAIL ADJUST, SINGLE RAIL	3,050	LF
606.3622	GUARDRAIL ADJUST, DOUBLE RAIL	2,200	LF
606.471	SINGLE OFFSET BLOCK - W-BEAM	10	EΑ
606.48	SINGLE GALVANIZED STEEL POST	15	EΑ
627.73	TEMPORARY 6 INCH PAVEMENT MARKING TAPE	15,700	LF
627.731	TEMPORARY 6 INCH BLACK PAVEMENT MARKING TAPE	2,600	LF
627.78	TEMPORARY PAVEMENT MARKING LINE, WHITE OR YELLOW	1,000	LF
627.812	TEMPORARY RAISED PAVEMENT MARKERS	5,000	EΑ
627.94	PAVEMENT MARKING TAPE	9,050	LF
627.941	PAVEMENT MARKING TAPE - DOTTED WHITE LANE LINE, 6-INCH WIDTH	3,/50	LF
627.944	PAVEMENT MARKINGS - RECESSED TAPE - WORDS, ARROW AND STOP BARS	270	SF
629.05	HAND LABOR, STRAIGHT TIME	30	HR
631.12	ALL PURPOSE EXCAVATOR (INCLUDING OPERATOR)	25	HR
631.133	SKID STEER (INCLUDING OPERATOR)	20	HR
631.172	TRUCK-LARGE (INCLUDING OPERATOR)	30	HR
631.32	CULVERT CLEANER (INCLUDING OPERATORS)	25	HR
631.36	FOREMAN	25	HR
652.30	FLASHING ARROW	4	EΑ
652.312	TYPE III BARRICADES	15	EΑ
652.33	DRUM	450	EΑ
652.34	CONE	450	EΑ
<i>652.35</i>	CONSTRUCTION SIGNS	2,500	SF
652.361	MAINTENANCE OF TRAFFIC CONTROL DEVICES	1	LS
652 . 41	PORTABLE-CHANGEABLE MESSAGE SIGN	5	EΑ
652.47	SEQUENTIAL FLASHING WARNING LIGHTS	80	EΑ
659.10	MOBILIZATION	1/	LS

GENERAL NOTES

- I. EXISTING UTILITIES ON THESE PLANS WERE COMPILED FROM EXISTING PLANS AND VARIOUS OTHER SOURCES. LOCATIONS ARE NOT GUARANTEED TO BE ACCURATE NOR IS IT GUARANTEED THAT ALL UTILITIES ARE SHOWN. NO SEPARATE OR ADDITIONAL COMPENSATION WILL BE ALLOWED TO THE CONTRACTOR DUE TO ANY VARIANCE BETWEEN THE DATA SHOWN ON THE PLANS AND THE ACTUAL FIELD CONDITIONS ENCOUNTERED. THE CONTRACTOR IS REQUIRED TO CALL DIG SAFE AT 1-888-344-7233 AT LEAST 72 HOURS PRIOR TO THE START OF WORK, ALL PROPOSED SIGN AND EXCAVATION LOCATIONS SHALL BE MARKED AT THE NOTIFICATION TIME. THE RESIDENT ENGINEER SHALL BE PROVIDED AN ELECTRONIC COPY OF ALL DIG SAFE TICKETS WITHIN 24 HOURS OF THEIR RELEASE FOR PROJECT NOTIFICATIONS AND 3RD PARTY UTILITY LOCATOR COORDINATION.
- 2. THE CONTRACTOR SHALL NOTIFY ALL NON-MEMBERS THROUGH WWW.OKTODIG.COM OR AS OTHERWISE REQUIRED BY THE MAINE PUBLIC UTILITIES COMMISSION. ALL PROPOSED SIGN AND EXCAVATION LOCATIONS SHALL BE MARKED AT THE NOTIFICATION TIME, THE RESIDENT ENGINEER SHALL BE PROVIDED AN ELECTRONIC COPY OF ALL NON-MEMBER NOTIFICATIONS WITHIN 24 HOURS OF THEIR RELEASE
- 3. THE CONTRACTOR SHALL NOTIFY THE RESIDENT 10 CALENDAR DAYS PRIOR TO SUBMITTING ANY UTILITY LOCATE REQUESTS AS NOTED ABOVE SO THAT THE RESIDENT CAN ARRANGE FOR MAINE TURNPIKE UNDERGROUND UTILITY LOCATION. ALL PROPOSED SIGN AND EXCAVATION LOCATIONS SHALL BE MARKED AT THE NOTIFICATION TIME. NO EXCAVATION SHALL BE PERMITTED UNTIL THE AUTHORITY HAS LOCATED AND MARKED ITS UNDERGROUND UTILITIES.
- 4. FOLLOWING THE COMPLETION OF THE INITIAL UTILITY LOCATE THE CONTRACTOR WILL GPS LOCATE ALL UTILITIES WITHIN THE PROJECT LIMITS AND PROVIDE A COPY OF THE DIG SAFE RECORDS TO THE AUTHORITY. THE CONTRACTOR, ACTING AS THE AUTHORITY'S THIRD-PARTY LOCATOR, SHALL BE RESPONSIBLE FOR REMARKING ALL MAINE TURNPIKE FACILITIES WHEN A DIG SAFE UTILITY IS CALLED FOR THE PROJECT. THIS WORK SHALL BE CONSIDERED INCIDENTAL TO
- 5. MATERIALS AND EQUIPMENT SHALL NOT BE STORED UNDER OR IN CLOSE PROXIMITY TO HIGHWAY STRUCTURES UNLESS THE CONTRACTOR RECEIVES WRITTEN PERMISSION FROM THE RESIDENT.
- 6. THE CONTRACTOR SHALL MEASURE THE EXISTING CROSS SLOPES FOR LANE 1, 2, 3, AND THE INSIDE AND OUTSIDE SHOULDER EVERY \(\frac{1}{2} \) MILE AND REPORT TO THE RESIDENT PRIOR TO MILLING. PAYMENT FOR THIS WORK SHALL BE CONSIDERED INCIDENTAL TO 403 PAY ITEMS.

DRAINAGE NOTES

I. NO EXISTING DRAINAGE SHALL BE ABANDONED, REMOVED OR PLUGGED WITHOUT APPROVAL OF THE RESIDENT.

EROSION CONTROL

- I. ADDITIONAL MEASURES MAY BE PROPOSED BY THE CONTRACTOR DUE TO SITE OR WEATHER CONDITIONS THE RESIDENT MAY DIRECT THE CONTRACTOR TO IMPLEMENT ADDITIONAL MEASURES, ANY ADDITIONAL MEASURES APPROVED BY THE RESIDENT WILL BE MEASURED FOR PAYMENT.
- 2. ALL TEMPORARY EROSION CONTROL DEVICES SHALL BE INSTALLED IN ACCORDANCE WITH THE MAINE DEPARTMENT OF TRANSPORTATION BEST MANAGEMENT PRACTICES.
- 3. JOAM, SEED, AND MUICH REQUIRED TO REPAIR PROJECT DISTURBED AREAS, AS DIRECTED BY THE RESIDENT, WILL NOT BE MEASURED FOR PAYMENT BUT SHALL BE INCIDENTAL TO THE CONTRACT.

<u>GUARDRAIL INSTALLATION AND MODIFICATION NOTES</u>

- I. THE CONTRACTOR SHALL FOLLOW ALL MANUFACTURER'S INSTALLATION INSTRUCTION FOR THE INSTALLATION AND/OR MODIFICATION OF ANY AND ALL GUARDRAIL COMPONENTS TO BE INSTALLED OR MODIFIED UNDER THIS CONTRACT. THE CONTRACTOR SHALL NOTIFY THE RESIDENT IF THE CONTRACTOR DISCOVERS CONFLICTS OR IRREGULARITIES OF ANY SORT BETWEEN THE MANUFACTURER'S INSTALLATION INSTRUCTIONS AND THESE CONTRACT DOCUMENTS.
- 2. THE CONTRACTOR IS REQUIRED TO HAVE AN APPROVED CRASH WORTHY END TREATMENT ON ALL GUARDRAIL ENDS IN ALL WORK AREAS AT THE END OF EACH DAY. THE CONTRACTOR SHALL ENSURE THAT ENOUGH TIME EXISTS IN THE WORK DAY TO COMPLETE ALL MODIFICATION AND/OR INSTALLATIONS TO END TERMINALS. THE CONTRACTOR SHALL ENSURE THAT ALL PARTS AND MANPOWER ARE ON-SITE PRIOR TO UNDERTAKING ANY GUARDRAIL MODIFICATIONS.
- 3. MID-WAY SPLICE GUARDRAIL HEIGHT SHALL BE INSTALLED OR ADJUSTED TO 3" " HEIGHT. POST SPLICE GUARDRAIL HEIGHT SHALL BE ADJUSTED TO 30" 0", -1/2". MAX GUARDRAIL HEIGHT SHALL BE MEASURED FROM THE EDGE OF PAVEMENT WHEN WITHIN 2 FEET. IF GUARDRAIL IS OFFSET FROM EDGE OF PAVEMENT GREATER
 THAN 2 FEET. THEN HEIGHT OF RAIL SHALL BE MEASURED AT GROUND ELEVATION ADJACENT TO EACH POST BELOW THE RAIL TO THE TOP OF GUARDRAIL AND AFTER FINAL GRADING OF SHOULDER. CONTRACTOR SHALL CHECK ALL GUARDRAIL HEIGHTS.
- 4. THE CONTRACTOR SHALL REMOVE AND DISPOSE OF OFF-SITE ALL CUT BOLTS, DISCARDED PARTS, TRASH, PAVEMENT DEBRIS, ETC., AFTER COMPLETING GUARDRAIL MODIFICATIONS AND/OR INSTALLATIONS.
- 5. CONNECTIONS FOR PROPOSED RAIL TO EXISTING RAIL SHALL BE INCIDENTAL TO THE INSTALLATION OF PROPOSED GUARDRAIL.

Scale: Designed by: NOT TO SCALE By Date Revision ONSULTANT PROJECT MANAGER: Dale A. Mitchell, P.E Ву Checked PEM
In Charge of TRC Designed DEB 11\24

HNTB CORPORATION 82 Running Hill Road, Suite 201 South Portland, ME 04106 TEL (207) 774-5155 FAX (207) 228-0909



THE GOLD STAR MEMORIAL HIGHWAY PORTLAND AREA PAVEMENT REHABILITATION NORTHBOUND MM 42.0 TO MM 49.3

GENERAL NOTES

SHEET NUMBER: GN-01

MTA PROJECT MANAGER: Joseph R. Leavitt, P.E.

LIMITS OF OVERLAY WITHOUT GUARDRAIL (58'-0").


LIMITS OF OVERLAY WITH GUARDRAIL (60'-0").

(D) = BERM DROPOFF CORRECTION - GRINDINGS.

A COATING OF HOT RUBBERIZED ASPHALT (ASTM D6690 TYPE IV) SHALL BE APPLIED AT THE TOP SURFACE LIFT TO ALL TRANSVERSE BUTT JOINTS AND LONGITUDINAL JOINTS EXCEPT WHERE THE NOTCHED WEDGE IS USED. INCIDENTAL TO ITEM 403.2081.

(F) = APPLY DOUBLE LAYER OF TACK ON NOTCHED WEDGE.

& MAINE TURNPIKE

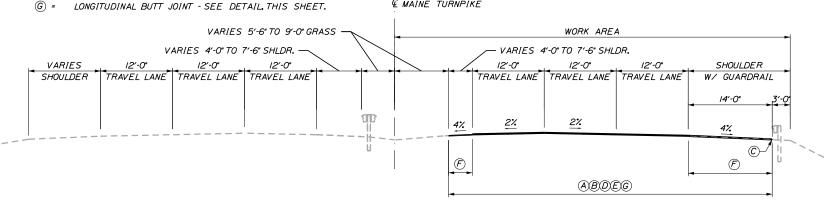

OVERLAY WITH MEDIAN GUARDRAIL AND SHOULDER REHABILITATION

 $\frac{STATION}{2070.95} \stackrel{TO}{=} \frac{STATION}{2I2I.70}$

- 1/2" HOT MIX ASPHALT 12.5mm NOMINAL MAXIMUM SIZE (POLYMER MODIFIED) OVERLAY.
- WHEN MEDIAN GUARDRAIL IS ADJACENT TO THE SHOULDER, MILL TO FACE OF RAIL, OR EDGE OF PAVEMENT, WHICHEVER IS THE LESSER OFFSET.
- BERM DROPOFF CORRECTION GRINDINGS.
- A COATING OF HOT RUBBERIZED ASPHALT (ASTM D6690 TYPE IV) SHALL BE APPLIED AT THE TOP SURFACE LIFT TO ALL TRANSVERSE BUTT JOINTS AND LONGITUDINAL JOINTS EXCEPT WHERE THE NOTCHED WEDGE IS USED. INCIDENTAL TO ITEM 403.2081.
- (E) = APPLY DOUBLE LAYER OF TACK ON NOTCHED WEDGE.
- LIMITS OF 11/2" MILL AND 11/2" FILL SHOULDER REHABILITATION (PRIOR TO 11/2" OVERLAY). WIDTH VARIES, SEE PLANS & NOTES.
- LIMITS OF 11/2" OVERLAY (WIDTH VARIES).

MAINE THE GOLD STAR TURNPIKE **MEMORIAL HIGHWAY** 2. CROWNS FOR ALL COURSES OF PAVEMENT SHALL BE STRAIGHT.

SURFACES PRIOR TO PLACING PROPOSED PAVEMENT.

-EXISTING MEDIAN BARRIER

FROM TPKE &

LONGITUDINAL BUTT JOINT DETAIL

FROM TPKE &

11/2"

EXISTING GUTTER LINE Q

© FUTURE ► GUTTER LINE

11/2" OVERLAY-

VARIARIF -VARTABLE DEPTH MILL (LONGITUDINAL BUTT JOINT)

EXISTING MEDIAN —

TPKE

NOTES:

- 3. PAVEMENT DEPTHS AS SHOWN ON THE PLANS ARE INTENDED TO BE
- 4. MILLED SURFACES SHALL BE CRACK SEALED PRIOR TO FILLING/OVERLAY USING THE MATERIALS DIRECTED BY THE RESIDENT, PAYMENT FOR CRACK SEALING SHALL BE MADE FOR UNDER ITEM 424.324 OR 424.3231.

I. BITUMINOUS TACK COAT IS REQUIRED BETWEEN ALL LIFTS OF PAVEMENT.

BITUMINOUS TACK COAT IS REQUIRED ON ALL EXISTING PAVED OR MILLED

- 5. EXISTING PAVEMENT SURFACE TO BE OVERLAID SHALL BE CRACK SEALED PRIOR TO OVERLAY USING THE MATERIALS DIRECTED BY THE RESIDENT. PAYMENT FOR CRACK SEALING SHALL BE MADE UNDER ITEM 424.324 OR 424.3231.
- 6. FOR AREAS WHERE MILLING THE SHOULDERS EXPOSES UNDERLYING GRAVELS, CONTRACTOR SHALL COMPACT GRAVELS PER STANDARD SPECIFICATION 304, ADD TYPE A GRAVELS AS NEEDED TO ACHIEVE GRADE, THEN PAVE AS CALLED FOR. PAYMENT SHALL BE MADE UNDER ITEM 304.14.
- 7. JOINTS SHALL BE CONSTRUCTED AS THE "NOTCHED WEDGE" TYPE.


PORTLAND AREA PAVEMENT REHABILITATION NORTHBOUND MM 42.0 TO MM 49.3

TYPICAL SECTIONS (1 OF 2)

SHEET NUMBER: TYP-1 CONTRACT: 2025.02

Scale: Designed by: NOT TO SCALE By Date Revision ONSULTANT PROJECT MANAGER: Dale A. Mitchell, P.E Ву Checked Designed 11\24 In Charge of TRC FKK

HNTB CORPORATION 82 Running Hill Road, Suite 201 South Portland, ME 04106 TEL (207) 774-5155 FAX (207) 228-0909

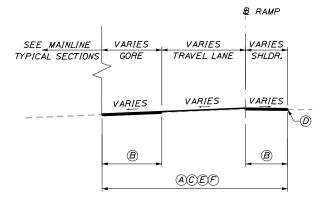


RAMP AND GORE REHABILITATION

 STATION
 TO
 STATION
 42
 NB
 OFF)


 208-53
 216-59
 (EXIT 42
 NB
 ON)

- A = 1/2" HOT MIX ASPHALT 12.5mm NOMINAL MAXIMUM SIZE (POLYMER MODIFIED) OVERLAY.
- (B) = LIMITS OF 1/2* MILL AND 1/2* FILL SHOULDER REHABILITATION (PRIOR TO 1/2* OVERLAY). HMA FILL TO MATCH EXISTING, WIDTH VARIES, SEE PLANS & NOTES.
- C = LIMITS OF 11/2" RAMP OVERLAY (WIDTH VARIES).
- D) = BERM DROPOFF CORRECTION GRINDINGS.
- (E) = A COATING OF HOT RUBBERIZED ASPHALT (ASTM D6690 TYPE IV) SHALL BE APPLIED AT THE TOP SURFACE LIFT TO ALL TRANSVERSE BUTT JOINTS AND LONGITUDINAL JOINTS EXCEPT WHERE THE NOTCHED WEDGE IS USED. INCIDENTAL TO ITEM 403,2081.
- F = APPLY DOUBLE LAYER OF TACK ON NOTCHED WEDGE.

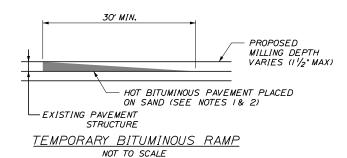

NOTES


- I. HOT MIX ASPHALT FOR TEMPORARY RAMPS SHALL NOT BE MEASURED FOR PAYMENT, BUT SHALL BE INCIDENTAL TO ITEM 403 2081
- 2. REMOVAL OF TEMPORARY BITUMINOUS RAMPS WILL NOT BE MEASURED FOR PAYMENT, BUT SHALL BE INCIDENTAL TO ITEM

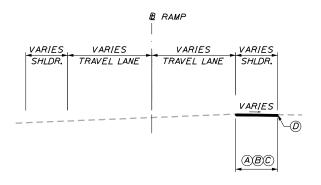

RAMP SHOULDER 1 1/2" MILL AND FILL REHABILITATION

STATION TO STATION 201-30 (EXIT 44 NB OFF)


- A) = 1½"HOT MIX ASPHALT 12.5mm NOMINAL MAXIMUM SIZE (POLYMER MODIFIED)-MILL AND FILL.
- (B) = A COATING OF HOT RUBBERIZED ASPHALT (ASTM D6690 TYPE IV) SHALL BE APPLIED AT THE TOP SURFACE LIFT TO ALL TRANSVERSE BUTT JOINTS AND LONGITUDINAL JOINTS EXCEPT WHERE THE NOTCHED WEDGE IS USED. INCIDENTAL TO ITEM 403.2081.
- © = LIMITS OF 1/2" MILL AND 1/2" FILL SHOULDER REHABILITATION. HMA FILL TO MATCH EXISTING, WIDTH VARIES, SEE PLANS & NOTES.
- D = BERM DROPOFF CORRECTION GRINDINGS.

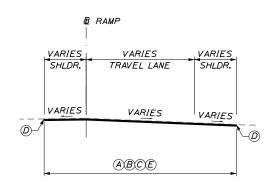


RAMP I 1/2" MILL AND FILL AND I 1/2" OVERLAY REHABILITATION

STATION TO STATION (EXIT 48 NB OFF)

- (POLYMER MODIFIED MILL AND FILL.
- B = A COATING OF HOT RUBBERIZED ASPHALT (ASTM D6690 TYPE IV) SHALL BE APPLIED AT THE TOP SURFACE LIFT TO ALL TRANSVERSE BUTT JOINTS AND LONGITUDINAL JOINTS EXCEPT WHERE THE NOTCHED WEDGE IS USED, INCIDENTAL TO ITEM 403,2081.
- \bigcirc = APPLY DOUBLE LAYER OF TACK ON NOTCHED WEDGE.
- D = BERM DROPOFF CORRECTION GRINDINGS.
- (E) = LIMITS OF 11/2" MILL AND 11/2" FILL REHABILITATION. HMA FILL TO MATCH EXISTING, WIDTH VARIES, SEE PLANS & NOTES.

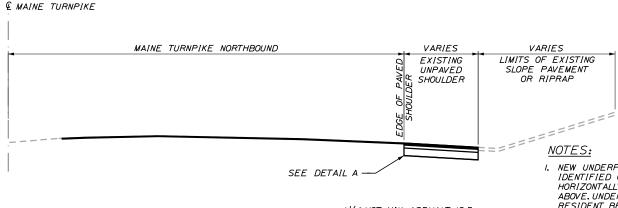

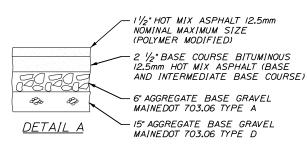

UNDERPASS PAVING DETAIL

NOT TO SCALE

- I. NEW UNDERPASS PAVEMENT SHALL BE INSTALLED AT LOCATIONS IDENTIFIED ON THE PLANS AND SHALL NOT EXTEND HORIZONTALLY BEYOND THE LIMITS OF THE BRIDGE FASCIA ABOVE. UNDERPASS PAVING LIMITS SHALL BE APPROVED BY THE RESIDENT BEFORE PAVING BEGINS.
- 2. THE LIMITS OF PROPOSED PAVING SHALL BE GRUBBED 6
 INCHES OR AS DIRECTED BY THE RESIDENT, PAID UNDER ITEM
 203.20 COMMON EXCAVATION.
- 3. AT THE DIRECTION OF THE RESIDENT, THE CONTRACTOR SHALL NOT REMOVE AND REPLACE EXISTING SUBBASE GRAVEL THAT MEETS THE REQUIREMENTS OF TYPE D GRAVEL FOLLOWING ACCEPTANCE OF THE SUBBASE MATERIAL, THE CONTRACTOR SHALL SHIM THE SUBBASE LAYER AS REQUIRED TO ALLOW FOR THE SPECIFIED PAVEMENT THICKNESS USING AGGREGATE BASE COURSE, TYPE A. THE CONTRACTOR WILL BE PAID BASED ON THE ACTUAL QUANTITY OF MATERIAL REMOVED AND REPLACED.
- 4. FINAL GUTTER LINE SLOPE SHALL MATCH OR IMPROVE EXISTING SWALE SLOPE, AS DIRECTED BY RESIDENT.
- 5. LOAM, SEED, AND MULCH REQUIRED TO REPAIR PROJECT DISTURBED AREAS, AS DIRECTED BY THE RESIDENT, WILL NOT BE MEASURED FOR PAYMENT BUT SHALL BE INCIDENTAL TO THE CONTRACT

Scale:

NOT TO SCALE

NO. Revision

By Date

CONSULTANT PROJECT MANAGER: Dale A. Mitchell, P.E.

By Date

Designed PEM 11\24 Checked EPR 11\24

Drawn

EKK 11\24 In Charge of TRC 11\24

HNTB CORPORATION 82 Running Hill Road, Suite 201 South Portland, ME 04106 TEL (207) 774-5155 FAX (207) 228-0909



THE GOLD STAR MEMORIAL HIGHWAY


PORTLAND AREA PAVEMENT REHABILITATION NORTHBOUND MM 42.0 TO MM 49.3

TYPICAL SECTIONS (2 OF 2)

SHEET NUMBER: TYP-2

CONTRACT: 2025.02


4 OE 50

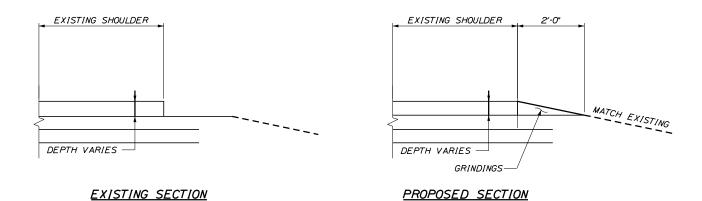

<u>DETAIL A</u> BERM DROPOFF CORRECTION WITHOUT GUARDRAIL NOT TO SCALE

EXISTING SHOULDER VARIES EXISTING SHOULDER ___VARIES _ GRINDINGS-DEPTH VARIES — DEPTH VARIES DEPTH VARIES


> DETAIL B BERM DROPOFF CORRECTION WITH GUARDRAIL NOT TO SCALE

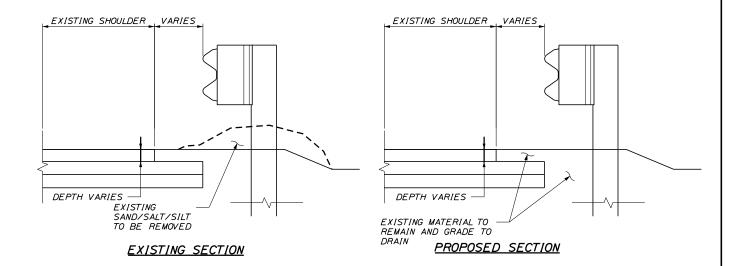

DETAIL C BERM CORRECTION NOT TO SCALE

NOTES:

- I. BERM DROPOFF CORRECTION WILL BE PLACED AT ALL LOCATIONS WHEN NEEDED UNLESS OTHERWISE DIRECTED BY THE RESIDENT.
- 2. BERM DROPOFF CORRECTION OF 3°OR MORE SHALL BE PLACED PRIOR TO SHIFTING TRAFFIC TO THE LANE ADJACENT TO THE SHOULDER REQUIRING CORRECTION.

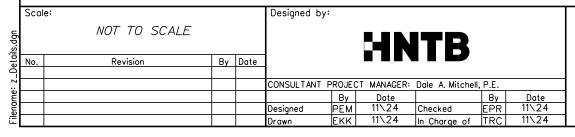

EXISTING SECTION

HNTB CORPORATION 82 Running Hill Road, Suite 201 South Portland, ME 04106 TEL (207) 774-5155 FAX (207) 228-0909

PROPOSED SECTION




THE GOLD STAR **MEMORIAL HIGHWAY**

PORTLAND AREA PAVEMENT REHABILITATION NORTHBOUND MM 42.0 TO MM 49.3

MISCELLANEOUS DETAILS 1

SHEET NUMBER: DET-01

MTA PROJECT MANAGER: Joseph R. Leavitt, P.E.

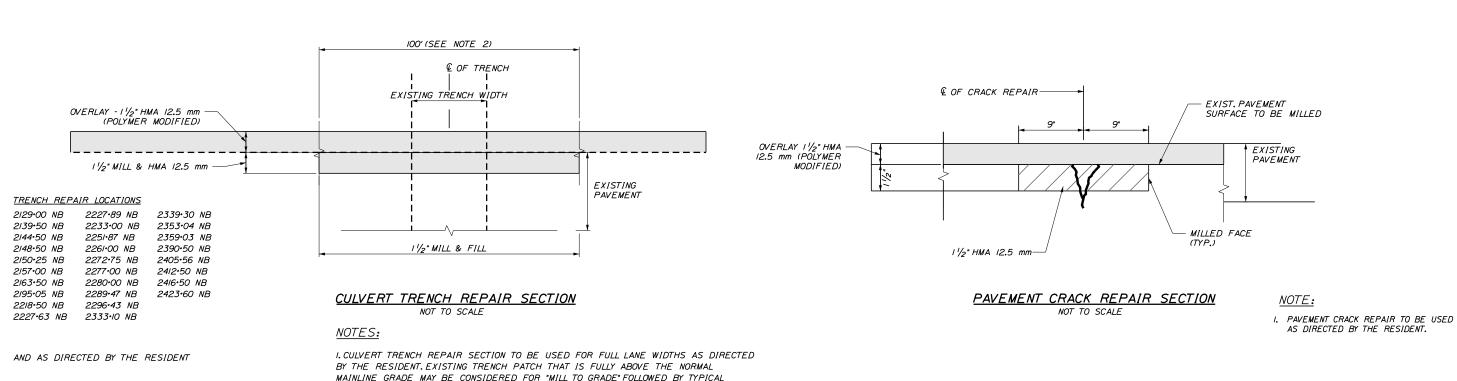


MAINLINE GRADE MAY BE CONSIDERED FOR "MILL TO GRADE" FOLLOWED BY TYPICAL OVERLAY PROCEDURES, AS DIRECTED BY THE RESIDENT.

2. CULVERT TRENCH REPAIR LENGTH SHALL BE 100' IN LENGTH OR AS DIRECTED BY THE RESIDENT.

3. DRAINAGE PATHS REQUIRED FOR TRENCH REPAIR WILL NOT BE MEASURED FOR PAYMENT BUT WILL BE CONSIDERED INCIDENTAL TO THE TRENCH REPAIR ITEM.

4. MILLED AREAS FOR TRENCH REPAIR THAT ARE NOT FILLED WITH PAVEMENT IN THE SAME WORK SHIFT WILL BE REQUIRED TO HAVE TEMPORARY BITUMINOUS RAMPS BEFORE OPENING TO TRAFFIC.

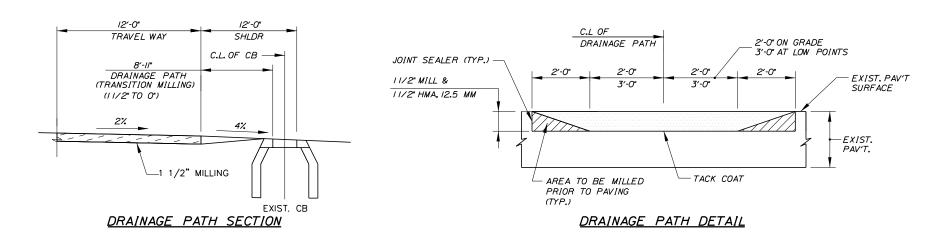

Scale:				Designed by	·:				
No.	NOT TO SCALE						ITB		
No.	Revision	Ву	Date	1					
				CONSULTANT	PROJEC	T MANAGER:	Dale A. Mitchel	I, P.E.	
					Ву	Date		Ву	Date
				Designed	РЕМ	11\24	Checked	EPR	11\24
				Drawn	EKK	11\24	In Charge of	TRC	11\24

HNTB CORPORATION 82 Running Hill Road, Suite 201 South Portland, ME 04106 TEL (207) 774-5155 FAX (207) 228-0909




THE GOLD STAR **MEMORIAL HIGHWAY**

MISCELLANEOUS DETAILS 2

PORTLAND AREA PAVEMENT REHABILITATION

NORTHBOUND MM 42.0 TO MM 49.3

SHEET NUMBER: DET-02 CONTRACT: 2025.02

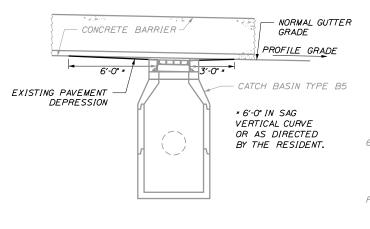

ELEVATION

PROPOSED GUTTER LINE $1^{\prime\prime}\!/_2$ " OVERLAY (OVERLAY SHOWN PROJECTED, SEE PLAN BELOW FOR PROPOSED GRADING) NORMAL EXISTING PAVEMENT GRADE PAVEMENT DEPRESSION IN OVERLAY 6% DEPRESSION -- EXISTING SHOULDER GRADE EXISTING GUTTER LINE FACE OF BARRIER -

PAVEMENT DEPRESSION DETAIL

(SEE NOTES THIS SHEET AND LONGITUDINAL BUTT JOINT DETAIL ON TYP-I)

-REMOVE EXISTING EXIST. GRATE. SEE NOTES 2 AND 3. REMOVE EXISTING FRAME, CONCRETE AND ANCHOR RODS TO SOUND SOUND CONCRETE 4- NO. 4 U BARS EACH SIDEWALL-SEE NOTE 4 EXIST. CATCH BASIN

CONCRETE. REFORM BASIN TO GRADE USING CLASS "AAA" CONCRETE. EXISTING FRAME MAY BE ENCASED IN CONCRETE.

NO. 4

NOTES:

I. EXISTING LOW POINT CATCH BASINS SHALL BE REMOVED, PLATED AND PAVED IN PRIOR TO MILLING.

U BAR

DRILL & GROUT INTO EXISTING CONC.

- 2. ALL EXISTING CATCH BASINS SHALL BE REBUILT WITH THE FRAME AND GRATE SET, AND CONCRETE FINISHED, TO THE FINAL PAVEMENT GRADE. FRAME TO BE SET 1/4" TO 3/8" BELOW GRADE.
- 3. TYPE II CATCH BASINS RESET EXISTING FRAME AND GRATE. IF ANY FRAMES OR GRATES ARE NOT USABLE MTA WILL SUPPLY.
- 4. TYPE IV CATCH BASINS RESET EXISTING FRAME AND GRATE. IF ANY FRAMES OR GRATES ARE NOT USABLE MTA WILL SUPPLY.
- 5. REMOVE UNSOUND CONCRETE (2" MIN.) AND REPLACE WITH NEW CONCRETE IF DIRECTED BY THE RESIDENT.

REBUILD CATCH BASIN TO GRADE - TYPE II NOT TO SCALE


NOTE:

- I. ADJUST ALL EDGE OF TRAVELWAY AND MID-SHOULDER CATCH BASINS TO GRADE.
- 2. GUTTERLINE AND EDGE OF OUTSIDE SHOULDER CATCH BASINS THAT ARE LESS THAN 13/4" BELOW FINAL OVERLAY SURFACE MAY REMAIN AS IS. UNLESS DIRECTED BY THE RESIDENT; ALL OTHERS SHALL BE RESET TO 1 1/2" BELOW FINAL OVERLAY SURFACE. THE CONTRACTOR IS RESPONSIBLE FOR LOCALIZED GRADING AROUND THE ADJUSTED CATCH BASINS.
- 3. MILL TO CREATE DEPRESSION PRIOR TO PAVING. OVERLAY PAVEMENT SHALL BE CONSTRUCTED WITH DEPRESSION GRADING AS SHOWN OR AS DIRECTED BY THE RESIDENT.
- 4. BRICKS SHALL NOT BE USED TO ADJUST FRAMES TO GRADE.
- 5. MANHOLE FRAMES SHALL BE ADJUSTED TO GRADE AS SHOWN ON THE PLANS OR DIRECTED BY THE RESIDENT.
- 6. LOCALIZED MEDIAN GRADING WILL BE REQUIRED, AS DIRECTED BY THE RESIDENT, AND AT THE FOLLOWING CATCH BASIN LOCATIONS:

STA 2151+06 NB STA 2151+75 NB STA 2192+25 NB STA 2223+50 NB STA 2321-80 NB

STA 2419:00 NB

PAYMENT FOR WORK SHALL BE CONSIDERED INCIDENTAL TO 403 PAY ITEMS.

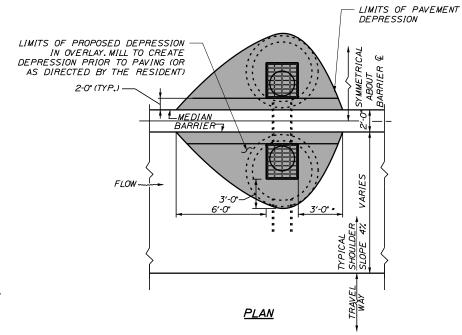

TYPICAL GRADING AT DRAINAGE STRUCTURES ALONG MEDIAN BARRIER N.T.S.

Scale: Designed by: NOT TO SCALE By Date Revision ONSULTANT PROJECT MANAGER: Dale A. Mitchell, P.E Ву esigned EK 11\24 In Charge of TRC

HNTB CORPORATION 82 Running Hill Road, Suite 201 South Portland, ME 04106 TEL (207) 774-5155 FAX (207) 228-0909




THE GOLD STAR **MEMORIAL HIGHWAY**


PORTLAND AREA PAVEMENT REHABILITATION NORTHBOUND MM 42.0 TO MM 49.3

MISCELLANEOUS DETAILS 3

SHEET NUMBER: DET-03

MTA PROJECT MANAGER: Joseph R. Leavitt, P.E.

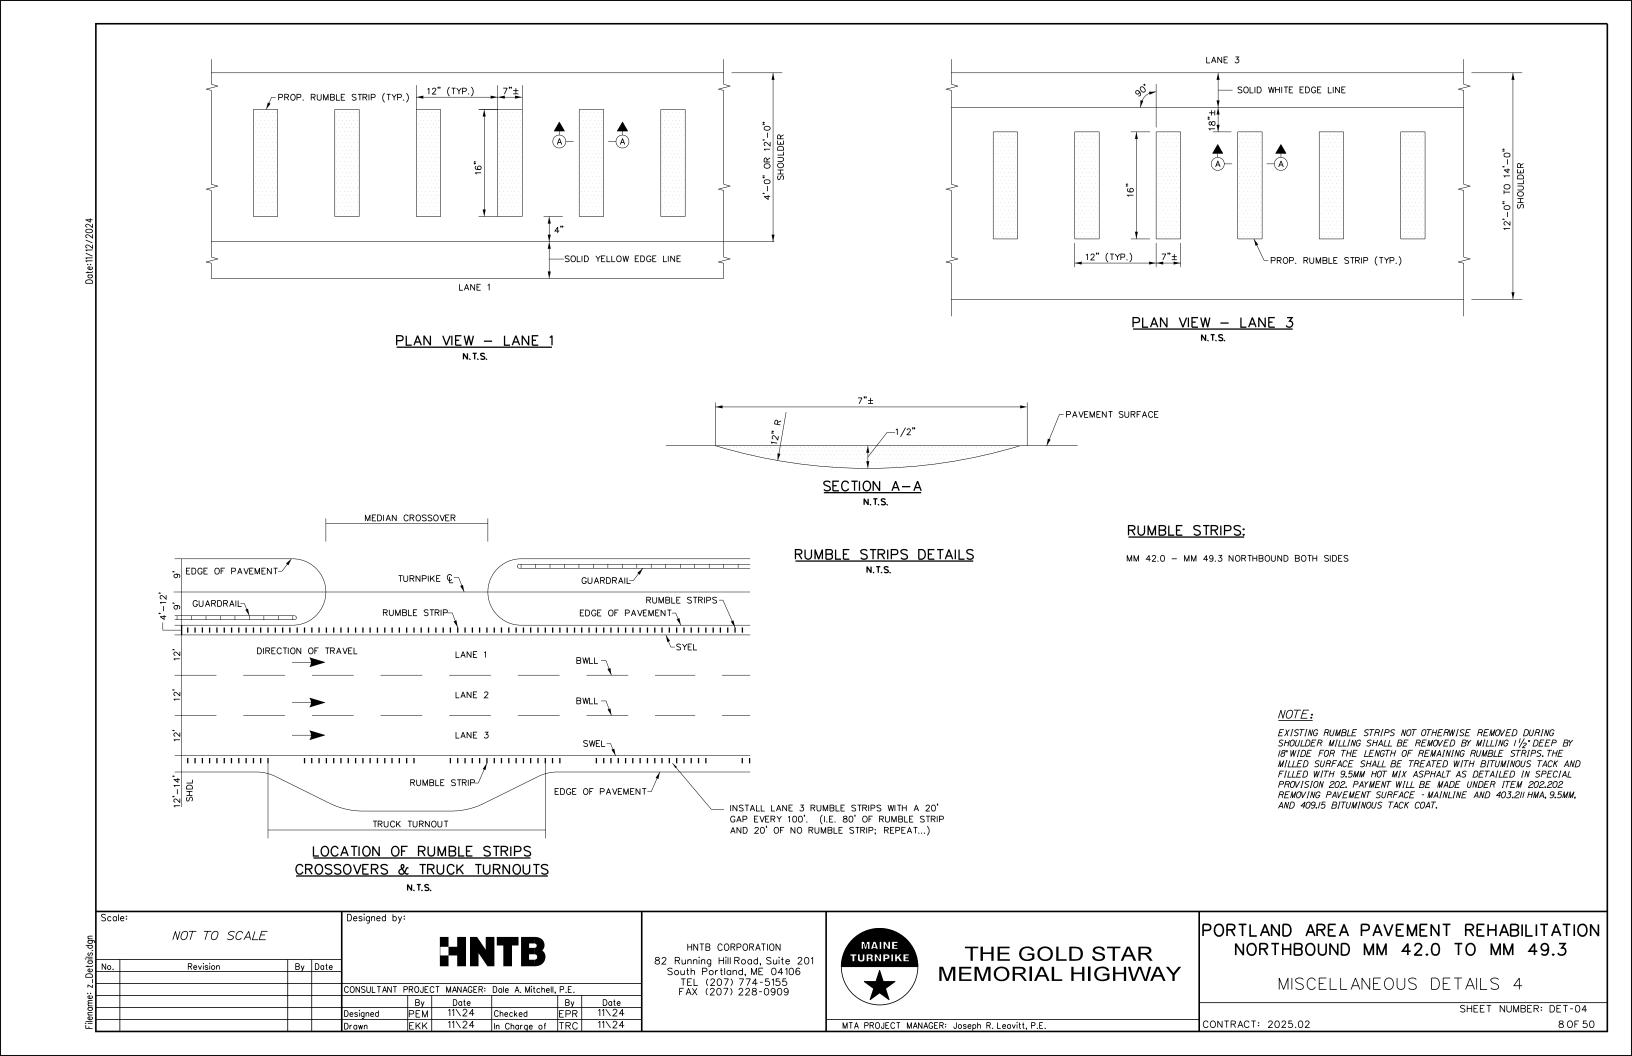


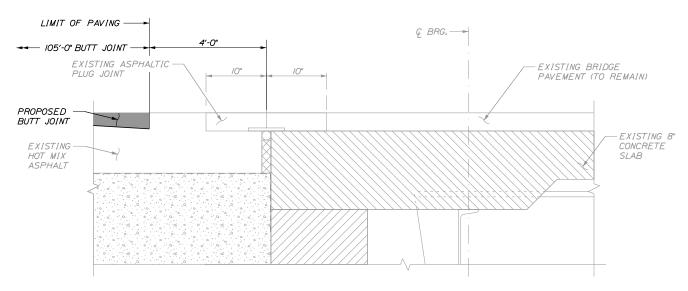

BUTT JOINT LIMIT AT ASPHALTIC PLUG JOINT DETAIL

NOTE:

I. ASPHALTIC PLUG JOINT - PAVING LIMITS SHOW LIMIT OF PROPOSED PAVING BASED ON THE LOCATION OF THE EXISTING ASPHALTIC PLUG JOINT ON THE SOUTHERN ABUTMENT OF THE MAINE CENTRAL RAILROAD BRIDGE AND THE SOUTHERN ABUTMENT OF THE WARREN AVENUE BRIDGE. SEE PLAN VIEW ON GP-24 AND GP-29 FOR ADDITIONAL INFORMATION.

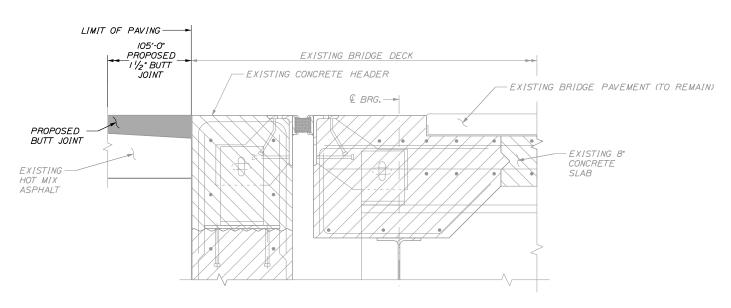

BUTT JOINT LIMIT AT COMPRESSION JOINT DETAIL N.T.S.

<u>NOTE:</u>

I. COMPRESSION JOINT DETAIL - PAVING LIMITS SHOWS LIMIT OF PROPOSED PAVING BASED ON THE LOCATION OF THE EXISTING CONCRETE HEADER ON THE NORTHERN ABUTMENT OF THE MAINE CENTRAL RAILROAD BRIDGE AND BOTH NORTHERN AND SOUTHERN ABUTMENTS OF THE STROUDWATER RIVER BRIDGE. SEE PLAN VIEW ON GP-20 AND GP-24 FOR ADDITIONAL INFORMATION.

Scale:				Designed by	:				
No.	NOT TO SCALE						ITB		
No.	Revision	Ву	Date						
				CONSULTANT	PROJEC	T MANAGER:	Dale A. Mitchel	I, P.E.	
					Ву	Date		Ву	Date
				Designed	PEM	11\24	Checked	BRG	11\24
				Drawn	РЕМ	11\24	In Charge of	TRC	11\24

HNTB CORPORATION 82 Running Hill Road, Suite 201 South Portland, ME 04106 TEL (207) 774-5155 FAX (207) 228-0909




MTA PROJECT MANAGER: Joseph R. Leavitt, P.E.

PORTLAND AREA PAVEMENT REHABILITATION NORTHBOUND MM 42.0 TO MM 49.3

MISCELLANEOUS DETAILS 5

SHEET NUMBER: DET-05
CONTRACT: 2025.02 90F 50

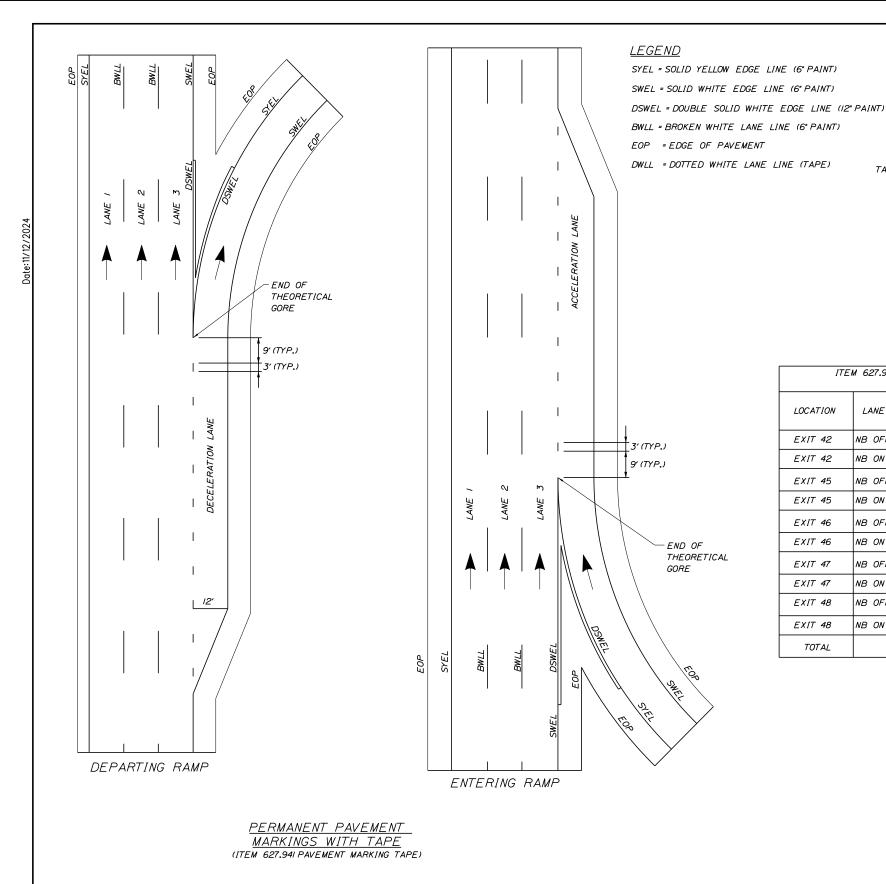

ITEM 627.941 - PAVEMENT MARKING TAPE - DWLL INSTALLATION LOCATIONS *LENGTH* LENGTH BEGIN END LOCATION LANE TYPE OF TAPE (STA) (STA) (LF) (LF) EXIT 42 NB OFF RAMP 2084•64 2088+50 *38*6 97 EXIT 42 NB ON RAMP 2118+39 2123+41 502 126 EXIT 45 NB OFF RAME 2196+00 2209•72 1372 343 NB ON RAMP 2244+32 2252+50 EXIT 45 818 205 NB OFF RAME 2273+50 | 2280+30 170 EXIT 46 680 EXIT 46 NB ON RAMP 2299+00 | 2310+60 1160 290 EXIT 47 NB OFF RAME 2336.00 2343.24 724 181 EXIT 47 NB ON RAMP 2356+91 2370-50 1359 340

2403-50

2428+00

1200

1200

300

300

2352

1'-0"

TAPE WIDTH +/

2416+00

I. ALL EXISTING PAINT MARKINGS SHALL BE REMOVED PRIOR TO INSTALLATION OF ITEM 627.941 PAVEMENT MARKING TAPE AND SHALL BE INCIDENTAL TO INSTALLATION OF THE TAPE.

/'-O"

DWLL

3′-0" 5′-0"

6" WIDTH

/'-O"

ITEM 627.941 DWLL PERMANENT PAVEMENT MARKINGS WITH TAPE GROOVING DETAIL

NTS

DWLL

6" WIDTH

- 2. ON DEPARTING RAMPS, THE DWLL SHALL BEGIN AT THE BEGINNING OF THE TAPER AND EXTEND THE FULL LENGTH OF THE DECELERATION LANE TO THE THEORETICAL GORE MARKINGS.
- 3. ON ENTERING RAMPS, THE DWLL SHALL BEGIN AT THE END OF THE THEORETICAL GORE MARKINGS AND SHALL EXTEND THE FULL LENGTH OF THE ACCELERATION LANE INCLUDING THE TAPER.
- 4. ITEM 627.94I PAVEMENT MARKING TAPE FOR DWLL SHALL BE INSTALLED IN AN "IN-AND-OUT" GROOVING PATTERN. SEE DETAIL
- 5. CONTRACTOR SHALL FOLLOW MANUFACTURERS RECOMMENDATIONS FOR INSTALLATION OF THE TAPE. ANY CHANGES TO INSTALLATION PROCEDURES SHALL BE APPROVED THE BY RESIDENT.
- 6. CONTRACTOR SHALL REMOVE PAVEMENT MARKING LINES ON THE STROUDWATER RIVER BRIDGE, MAINE CENTRAL RAILROAD BRIDGE, AND WARREN AVENUE BRIDGE AS DIRECTED BY THE RESIDENT, UP TO TWO WEEKS PRIOR TO FINAL STRIPING. REMOVING PAVEMENT MARKING LINES WILL NOT BE MEASURED FOR PAYMENT BUT SHALL BE INCIDENTAL TO THE 627 PAVEMENT MARKING PAY ITEMS.

Scale: Designed by: NOT TO SCALE By Date Revision ONSULTANT PROJECT MANAGER: Dale A. Mitchell, P.E Ву Checked PEM
In Charge of TRC Designed 11\24

HNTB CORPORATION 82 Running Hill Road, Suite 201 South Portland, ME 04106 TEL (207) 774-5155 FAX (207) 228-0909



EXIT 48

EXIT 48

TOTAL

NB OFF RAM

NB ON RAMP


THE GOLD STAR **MEMORIAL HIGHWAY**

PORTLAND AREA PAVEMENT REHABILITATION NORTHBOUND MM 42.0 TO MM 49.3

STRIPING DETAILS (1 OF 3)

SHEET NUMBER: DET-06

MTA PROJECT MANAGER: Joseph R. Leavitt, P.E.

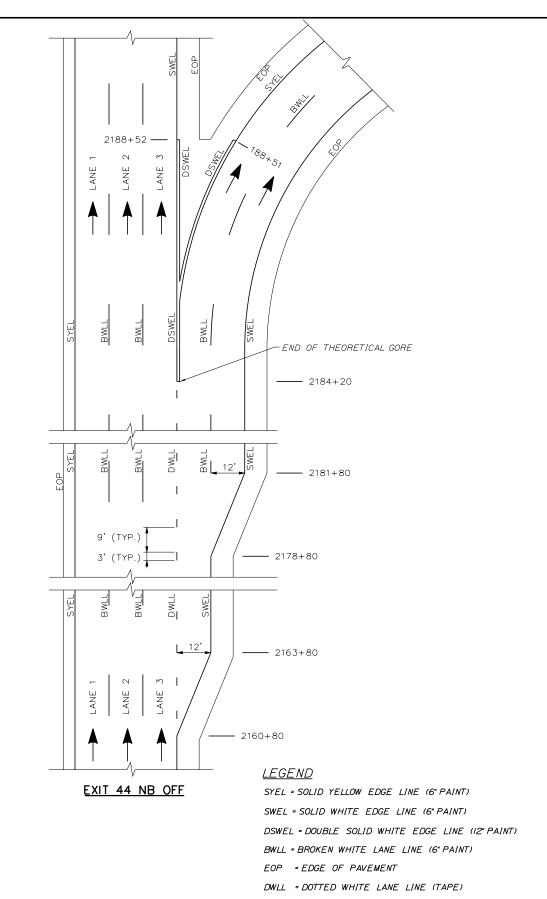

— € TPKE 24'-6" SEE NOTE 3 11'-9" 12'-0" 12'-3" STA. 2461+00 +/-AS DIRECTED BY THE RESIDENT HTEM 627.94 PAVEMENT MARKING TAPE (80' C. TO C.) (TYP.) - PERMANENT PAVEMENT MARKINGS (TYP.) (SEE NOTE 3) — STA. 2069+90 PAVEMENT NB RDWY.

PERMANENT PAVEMENT MARKINGS 3 LANE RDWY

NOTES:

- I. PERMANENT PAVEMENT MARKINGS SHALL BE 6"WIDE LINES INSTALLED BY THE MTA.
- 2. PERMANENT PAVEMENT MARKINGS SHALL BE INSTALLED ON THE NORTHBOUND SIDE ONLY.
- 3. THE OFFSET DISTANCE SHOWN ARE MEASURED FROM THE CENTER OF THE 6* PAINT LINES.
- 4. THE CONTRACTOR WILL PROVIDE LANE CLOSURES FOR THE PERMANENT PAVEMENT MARKINGS.
- 5. GENERAL CONTRACTOR IS RESPONSIBLE FOR PAVEMENT MARKING LAYOUT.

Scale: NOT TO SCALE No. Revision By Date CONSULTANT PROJECT MANAGER: Dale A. Mitchell, P.E. By Date By Date Designed PEM 11\24 Checked EPR 11\24 Drawn PEM 11\24 In Charge of TRC 11\24

HNTB CORPORATION 82 Running Hill Road, Suite 201 South Portland, ME 04106 TEL (207) 774-5155 FAX (207) 228-0909




THE GOLD STAR MEMORIAL HIGHWAY

PORTLAND AREA PAVEMENT REHABILITATION NORTHBOUND MM 42.0 TO MM 49.3

STRIPING DETAILS (2 OF 3)

SHEET NUMBER: DET-07


MTA PROJECT MANAGER: Joseph R. Leavitt, P.E.

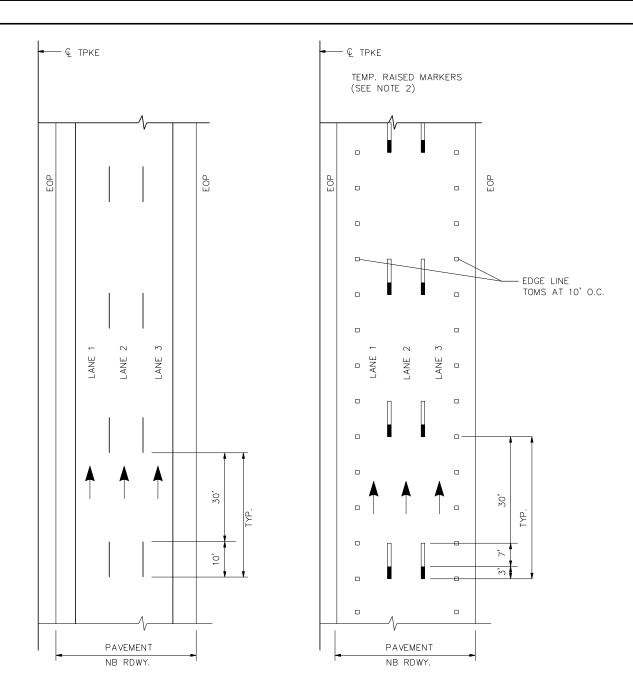

TEMP. PAVEMENT MARKINGS


3 LANE RDWY

- TEMPORARY PAVEMENT MARKINGS ON MILLED PAVEMENT SHALL BE 6" SOLID WHITE, BROKEN WHITE, AND SOLID YELLOW PAINT LINES.
- 2. TEMPORARY PAVEMENT MARKINGS ON NEW HMA 12.5MM, OR SHIM MATERIAL, SHALL BE TEMPORARY RAISED PAVEMENT MARKERS. "SOLID" WHITE AND "SOLID" YELLOW LANE LINES SHALL BE TEMPORARY RAISED PAVEMENT MARKERS SPACED AT 10'-0" O.C. TO O.C. OR ALTERNATING RAISED PAVEMENT MARKER AND 2' PIECES OF TEMPORARY TAPE, PLACED 10' O.C. "BROKEN" WHITE LANE LINES SHALL BE PAVEMENT MARKING TAPE, 3' PIECES SHALL BE PLACED AT 40' O.C. AND OFFSET FROM FINAL STRIPING LOCATION.
- 3. TEMPORARY TAPE SHALL BE USED TO DELINEATE THE EDGE OF RAMP TRAVELWAY FROM GORE TO RAMP BUTT JOINT FOLLOWING MILLING UNTIL IT CAN BE FINAL STRIPED.

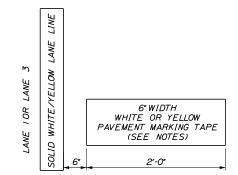

CATCH BASIN MARKING DETAIL

- I. CATCH BASIN MARKINGS TO BE PLACED ADJACENT TO ALL MEDIAN AND SHOULDER CATCH BASINS.
- 2. PAYMENT SHALL BE MADE UNDER ITEM 627.94 PAVEMENT MARKING TAPE.
- 3. TAPE COLOR SHOULD MATCH THE ADJACENT LANE STRIPING.

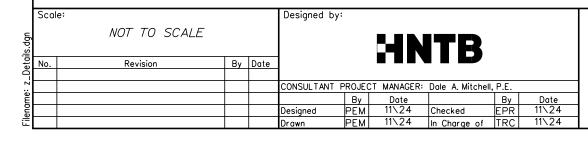


HNTB CORPORATION 82 Running Hill Road, Suite 201 South Portland, ME 04106 TEL (207) 774-5155 FAX (207) 228-0909



THE GOLD STAR **MEMORIAL HIGHWAY** PORTLAND AREA PAVEMENT REHABILITATION NORTHBOUND MM 42.0 TO MM 49.3

STRIPING DETAILS (3 OF 3)

SHEET NUMBER: DET-08 CONTRACT: 2025.02

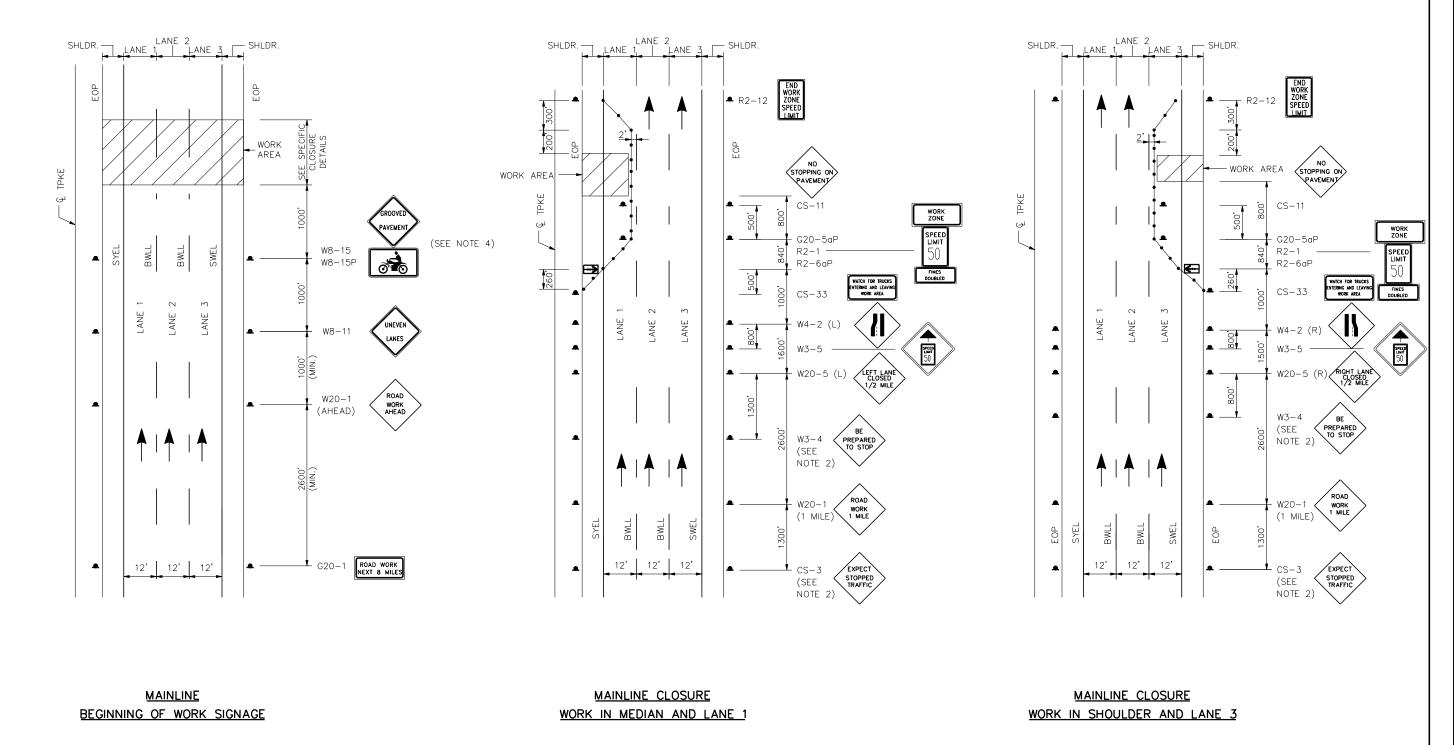

NOTES:

- 1. FOR SIGN DETAILS, SEE SIGN SUMMARY SHEET.
- 2. TO BE USED DURING STOPPAGE OF TRAFFIC.
- 3. DUE TO SEQUENCING OF WORK AREAS, APPROACH SIGNING MAY NEED TO BE MODIFIED AS WORK PROGRESSES.
- 4. PROVIDE W8-15 AND W8-15P AT ALL MILLED LOCATIONS

LEGEND

///= WORK AREA

= CONSTRUCTION SIGN • = DRUM

80' INTERVALS ON TANGENTS

40' INTERVALS ON TAPERS

= PORTABLE - CHANGEABLE MESSAGE SIGN

= FLASHING ARROW BOARD

Scale: Designed by: NOT TO SCALE By Date Revision ONSULTANT PROJECT MANAGER: Dale A. Mitchell, P.E. Ву Checked PEM
In Charge of TRC Designed

HNTB CORPORATION 82 Running Hill Road, Suite 201 South Portland, ME 04106 TEL (207) 774-5155 FAX (207) 228-0909




THE GOLD STAR **MEMORIAL HIGHWAY**

PORTLAND AREA PAVEMENT REHABILITATION NORTHBOUND MM 42.0 TO MM 49.3 TRAFFIC CONTROL MAINLINE CLOSURE

(1 OF 2)

SHEET NUMBER: MOT-01 CONTRACT: 2025.02

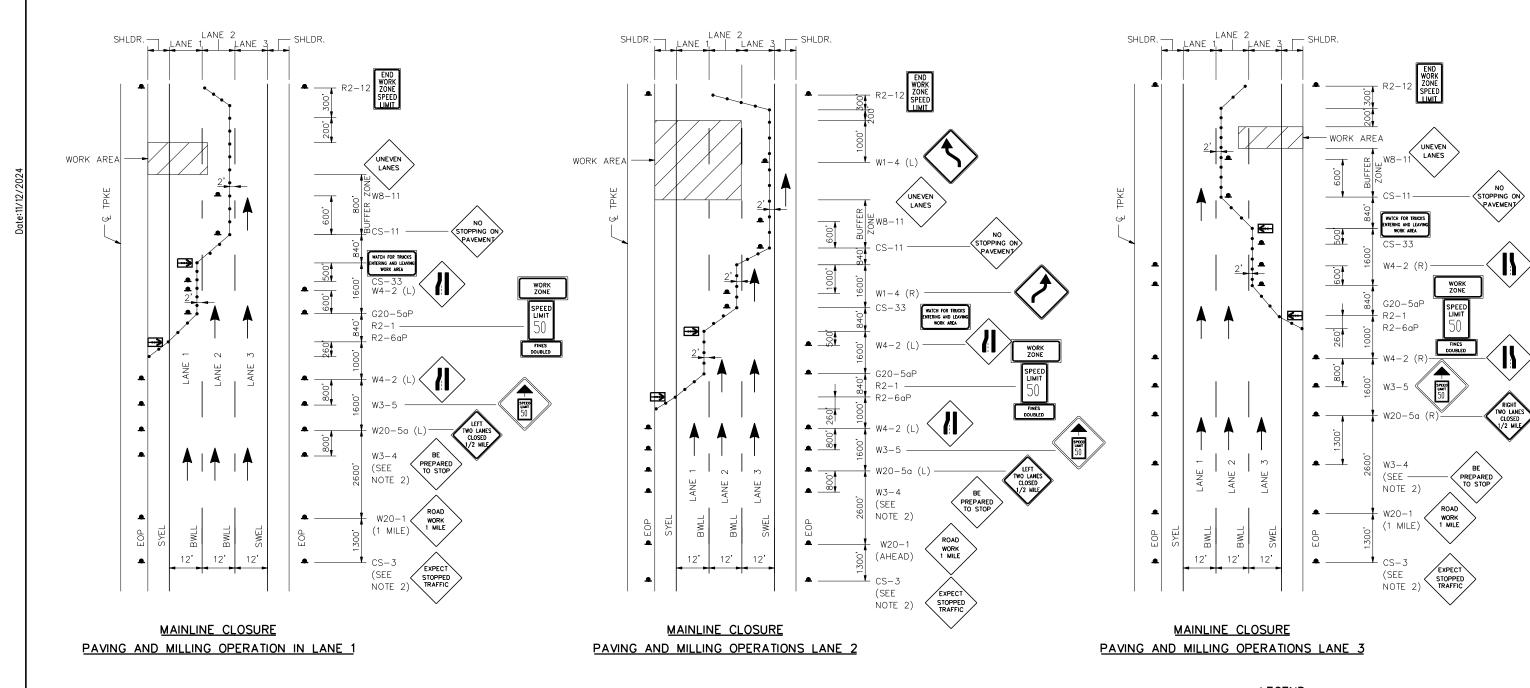

NOTES:

- 1. FOR SIGN DETAILS, SEE SIGN SUMMARY SHEET.
- 2. TO BE USED DURING STOPPAGE OF TRAFFIC.

LEGEND

■ WORK AREA
■ CONSTRUCTION SIGN


• = DRUM

80' INTERVALS ON TANGENTS 40' INTERVALS ON TAPERS

40' INTERVALS ON TAPERS

→ PORTABLE - CHANGEABLE MESSAGE SIGN

= FLASHING ARROW BOARD

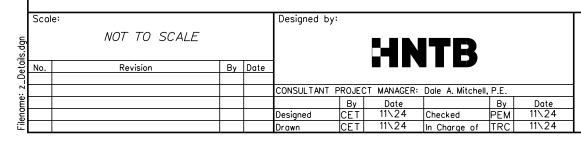

HNTB CORPORATION 82 Running Hill Road, Suite 201 South Portland, ME 04106 TEL (207) 774-5155 FAX (207) 228-0909




THE GOLD STAR MEMORIAL HIGHWAY


PORTLAND AREA PAVEMENT REHABILITATION NORTHBOUND MM 42.0 TO MM 49.3


TRAFFIC CONTROL MAINLINE CLOSURE (2 OF 2)


SHEET NUMBER: MOT-02


MTA PROJECT MANAGER: Joseph R. Leavitt, P.E.

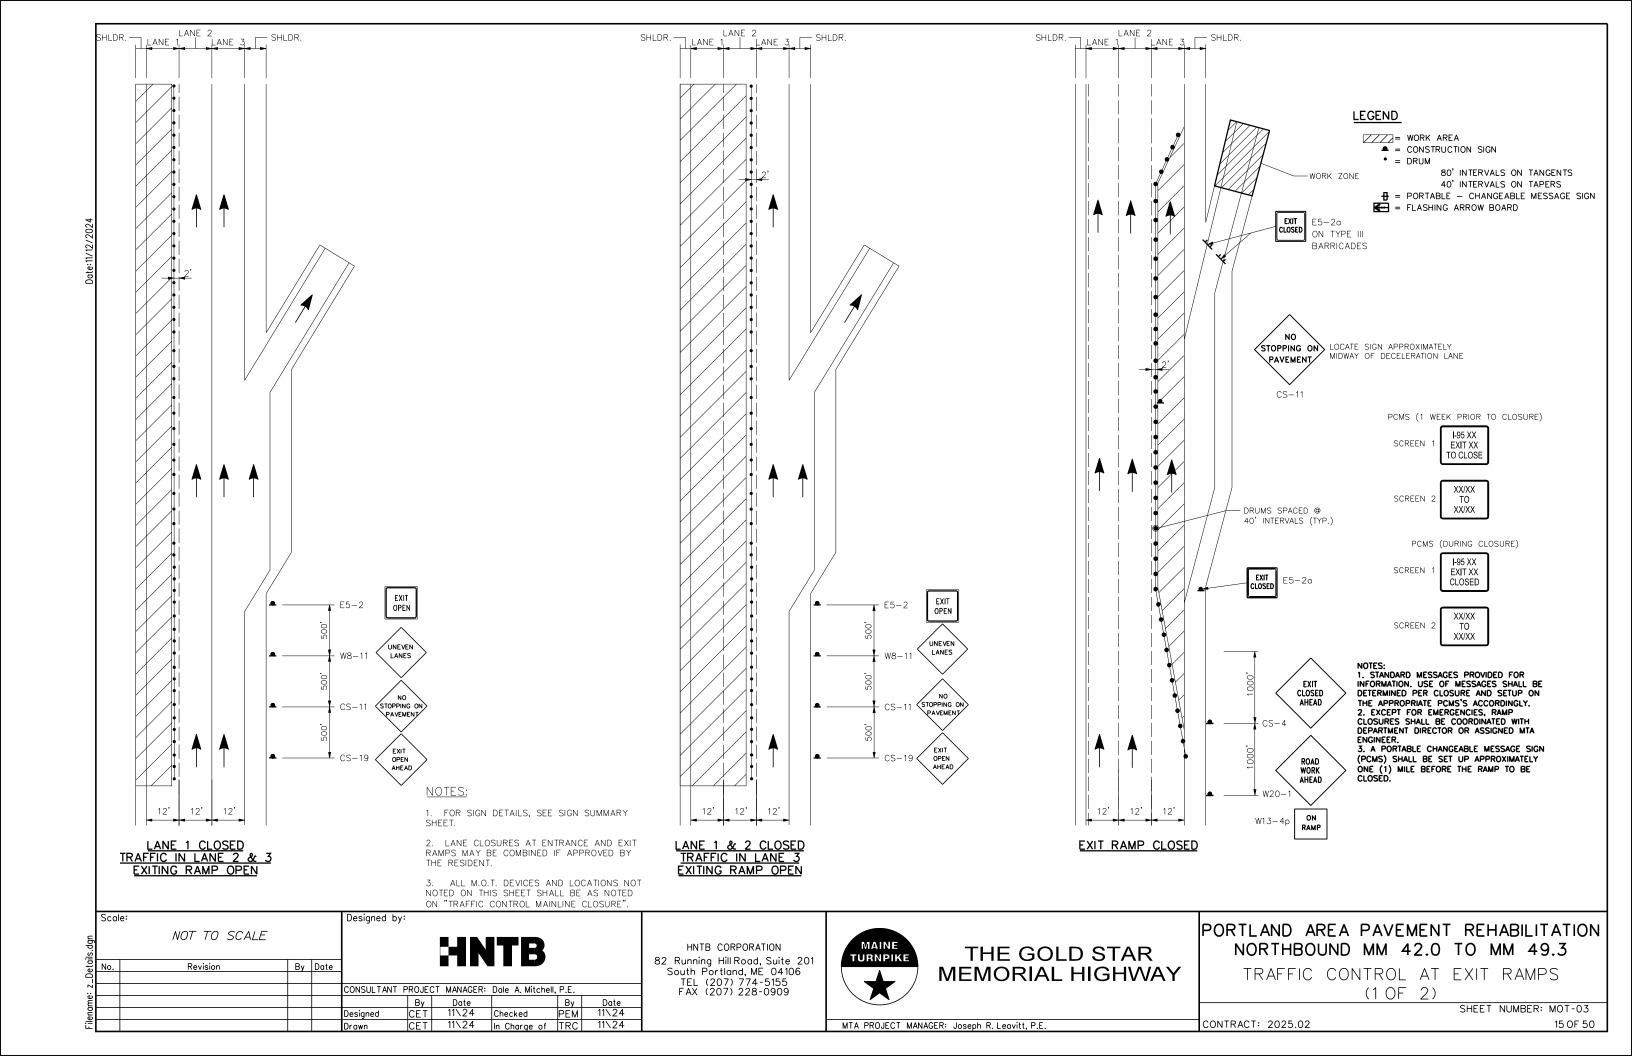

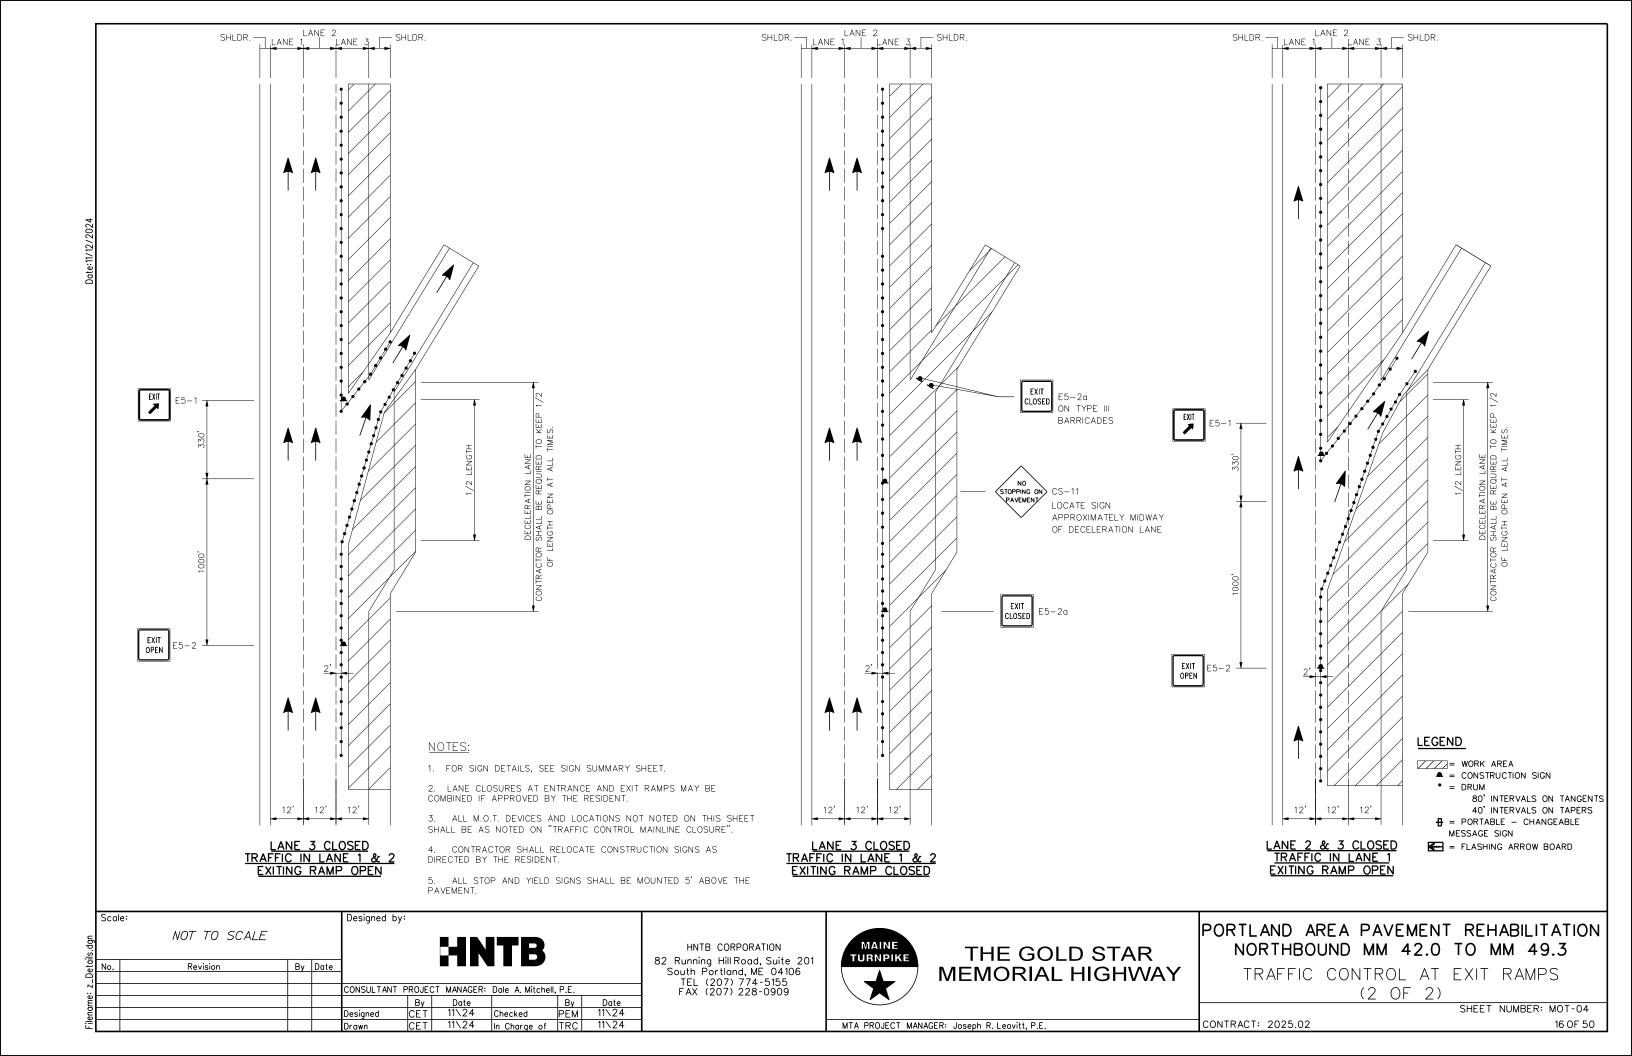

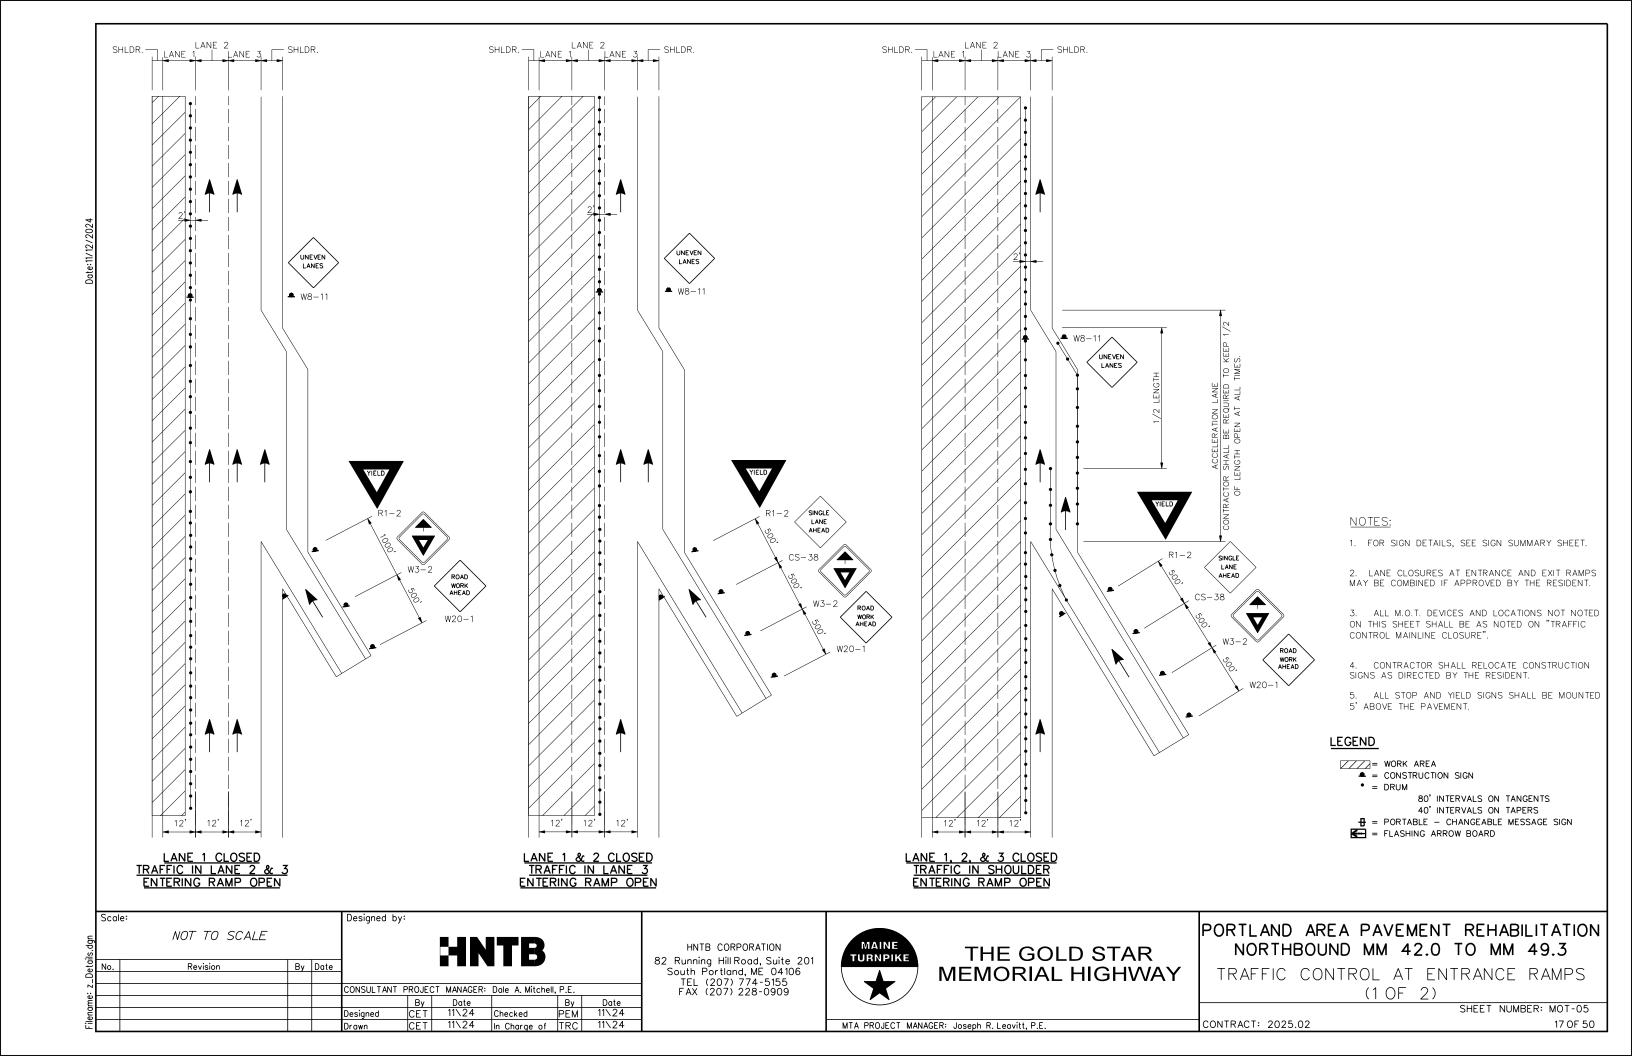

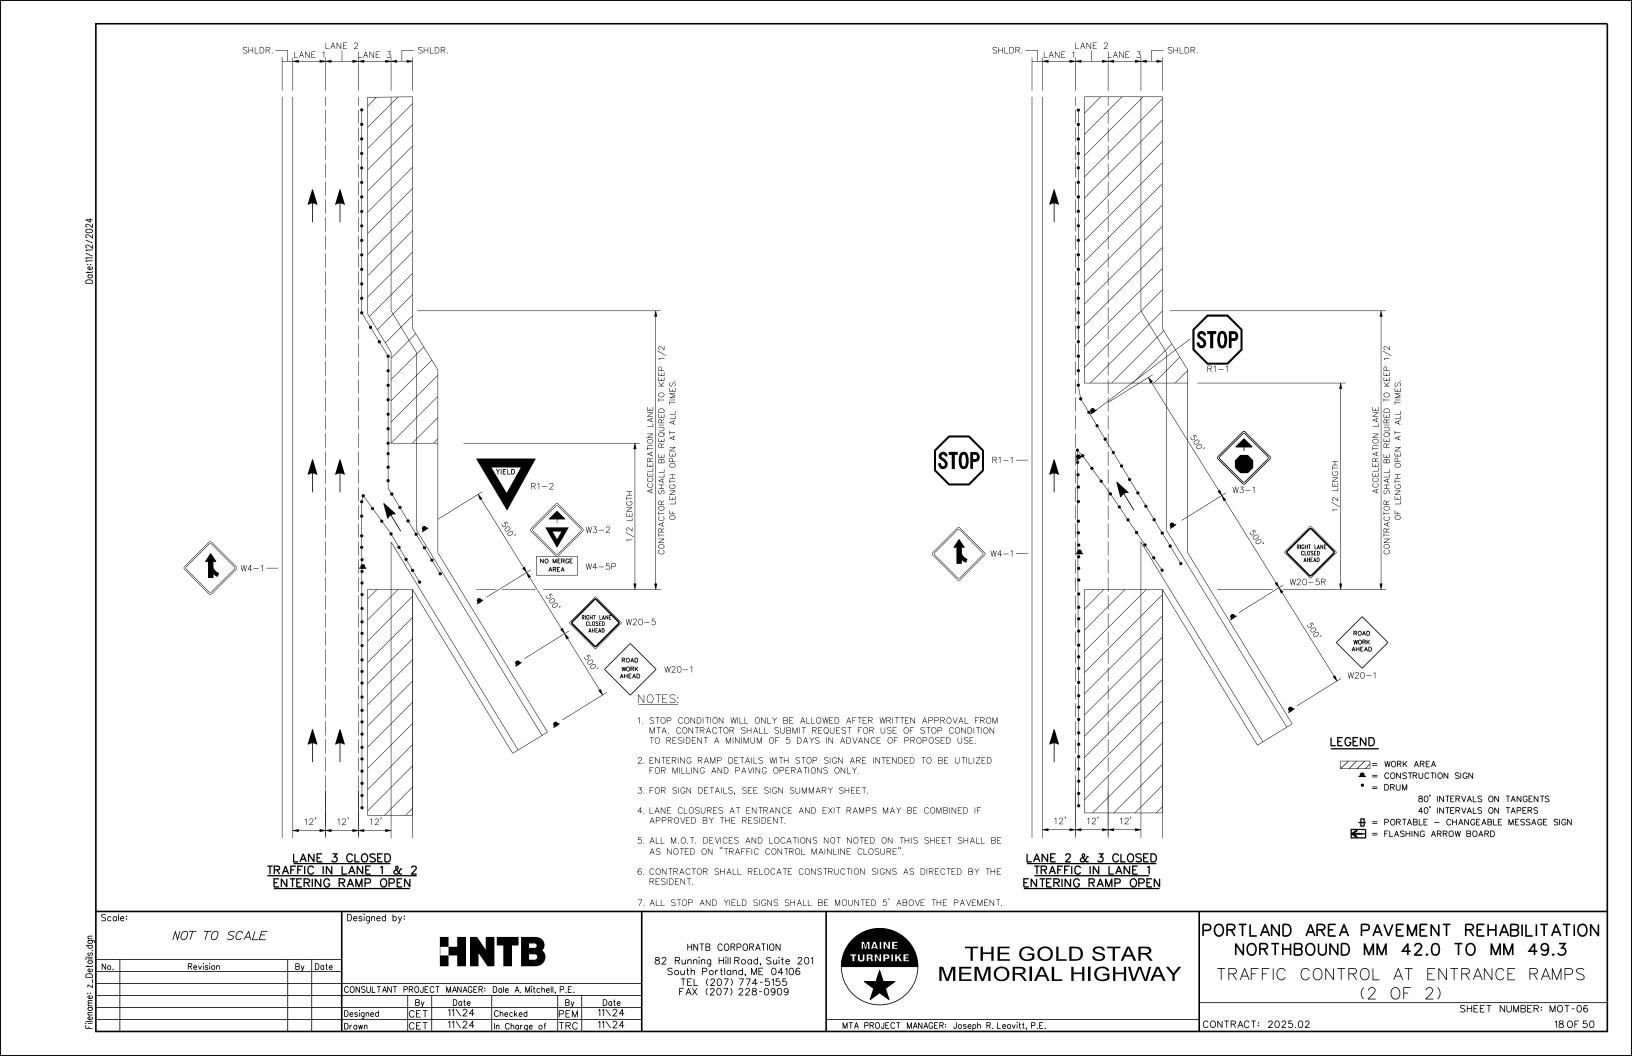

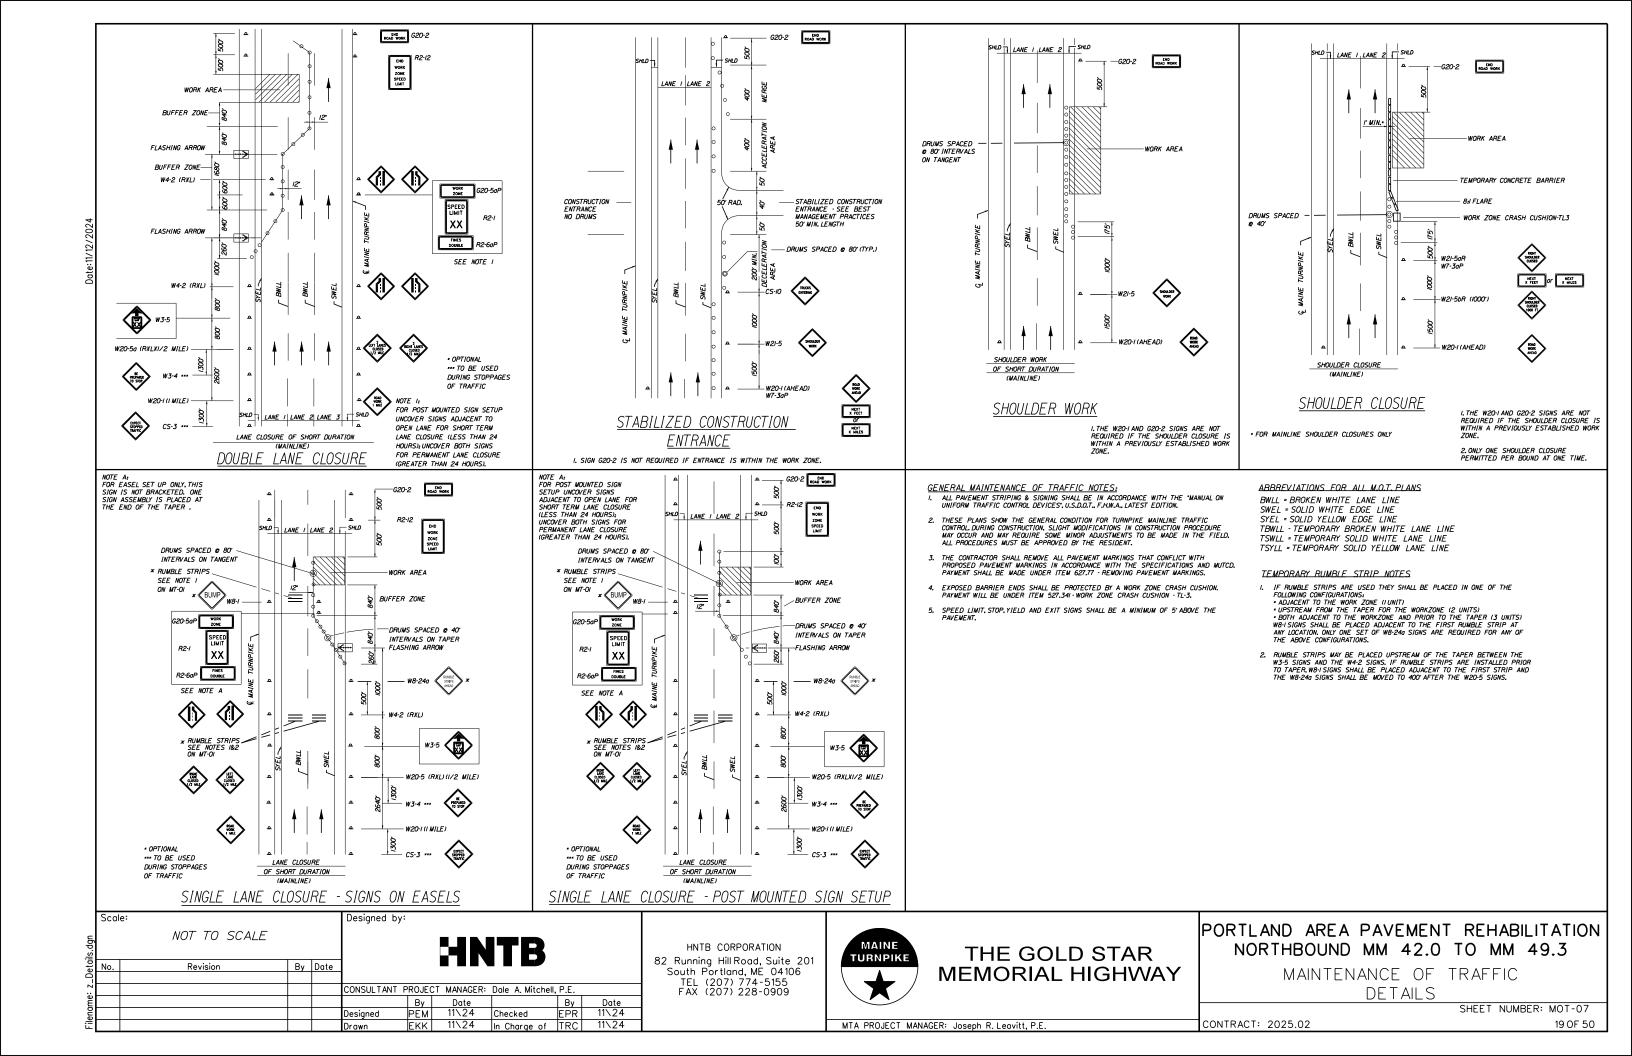

IDENTIFI-	SIZE O	F SIGN	TENT	TEXT	DIMENSIONS	(INCHES)	NUMBER OF	COL	OR	BORDER	AREA IN
CATION NUMBER	WIDTH	HEIGHT	TEXT	LETTER HEIGHT	VERTICAL SPACING	ARROW RTE, MKR.	SIGNS REQUIRED	BACK- GROUND	LEGEND BORDER	RADIUS	SQUARE FEET
CS-3	48*	48"	EXPECT STOPPED TRAFFIC	6" 6" 6"	4" 4"		2	ORANGE	BLACK		16.00 (32)
CS-4	48"	48"	EXIT CLOSED AHEAD	6" 6" 6"	4" 4"		6	ORANGE	BLACK		16.00 (96)
CS-11	48*	48"	NO STOPPING ON PAVEMENT	6" 6" 6"	4" 4"		4	ORANGE	BLACK		16.00 (64)
CS-19	48*	48*	EXIT OPEN AHEAD	6" 6" 6"	4" 4"		6	ORANGE	BLACK		16.00 (96)
CS-33	96 *	36 *	WATCH FOR TRUCKS ENTERING AND LEAVING WORK AREA	6" 6" 6"	4" 4"		2	ORANGE	BLACK		24.00 (48)
CS-38	48*	48"	SINGLE LANE AHEAD	6" 6" 6"	4" 4"		3	ORANGE	BLACK		16.00 (48)
E5-1	72*	60"	EXIT	CONFORM STANDA	DIMENSIONS 1 TO "2004 RD HIGHWAY 012 SUPPLEN	EDITION - SIGNS -	6	GREEN	WHITE		30.00 (180)
E5-2	60 *	48*	EXIT OPEN				6	ORANGE	BLACK		20.00 (120)
E5-2a	60"	48*	EXIT CLOSED				9	ORANGE	BLACK		20.00 (180)
G20-1	48"	24"	ROAD WORK NEXT 8 MILES				2	ORANGE	BLACK		8.00 (16)
G20-2	48"	24"	END ROAD WORK				2	ORANGE	BLACK		8.00 (16)

IDENTIFI – CATION NUMBER		OF SIGN HEIGHT	ТЕХТ	LE.	ITER		TICAL	ARI	ROW	NUMBER OF SIGNS REQUIRED		COL	LEG	END	BOR RAD	AREA IN SQUARE FEET
G20-5aP	48"	24*	WORK ZONE	СО	NFORN FANDA	DIMEN I TO ' RD HII)12 SL	'2004 GHWAY	SHAI EDITIO SIGN	N -	6		NGE	BOR BL	ACK		8.00 (48)
R1-1	48"	48"	STOP							6	-ST	FORM	TO "2 D HIG	HWAY	EDITION SIGNS	16.00 (96)
R1-2	60 * 6	60"	YIELD							6						12.50 (75)
R2-1	48"	60"	SPEED LIMIT 50							6						20.00 (120)
R2-6aP	48*	24"	FINES DOUBLE							6						8.00 (48)
R2-12	36"	54"	END WORK ZONE SPEED LIMIT							4						13.50 (54)
W1-4 (L)	48*	48*	(1	ORA	NGE	BL.	ACK		16,00 (16)
W1-4 (R)	48"	48"								1	ORA	NGE	BL	ACK		16.00 (16)
W1-4b(L)	48"	48"	(\$\)							1	ORA	NGE	BL	ACK		16.00 (16)
W1 – 4b(R)	48"	48"	())							1	ORA	NGE	BL	ACK		16.00 (16)

Scale: Designed by: NOT TO SCALE By Date Revision CONSULTANT PROJECT MANAGER: Dale A. Mitchell, P.E.
 By
 Date
 By
 Date

 CET
 11\24
 Checked
 PEM
 11\24

 CET
 11\24
 In Charge of
 TRC
 11\24
 Designed

HNTB CORPORATION 82 Running Hill Road, Suite 201 South Portland, ME 04106 TEL (207) 774-5155 FAX (207) 228-0909



THE GOLD STAR MEMORIAL HIGHWAY

PORTLAND AREA PAVEMENT REHABILITATION NORTHBOUND MM 42.0 TO MM 49.3

MAINTENANCE OF TRAFFIC

SIGN SUMMARY 1 OF 2
SHEET NUMBER: MOT-08 CONTRACT: 2024.02 20 OF 50

IDENTIFI-	SIZE O	F SIGN		Т	EXT	DIMENS	SIONS	(INCH	ES)	NUMBER OF	COL	OR	BORDER	AREA I
CATION NUMBER	WIDTH	HEIGHT	TEXT	LETT HEIGI			TICAL CING		ROW MKR.	SIGNS REQUIRED	BACK- GROUND	LEGEND BORDER	RADIUS	SQUARI FEET
W3-1	48"	48*		CON	TEXT FORM	DIMEN 1 TO " RD HIC 012 SU	ISIONS 2004 GHWAY	SHAL EDITIC SIGN	LL DN –	5	ORANGE	BLACK		16.00 (80)
₩3−2	48"	48"								3	ORANGE	BLACK		16.00 (48)
w3-4	48"	48*	BE PREPARED TO STOP							3	ORANGE	BLACK		16.00 (48)
w3-5	48*	48"	SPEED LIMIT 50							4	ORANGE	BLACK		16.00 (64)
W4-1	48*	48"								5	ORANGE	BLACK		16.00 (80)
W4-2 (L)	48"	48"								4	ORANGE	BLACK		16.00 (64)
W4-2 (R)	48"	48*								4	ORANGE	BLACK		16.00 (64)
W4-5P	24"	30*	NO MERGE AREA							3	ORANGE	BLACK		5.00 (15)
W8-11	48"	48"	UNEVEN							6	ORANGE	BLACK		16.00 (96)

IDENTIFI-	SIZE O	F SIGN		TEXT	DIMENSIONS	(INCHES)	NUMBER OF	COL	.OR	BORDER	AREA II	
CATION NUMBER	WIDTH	HEIGHT	TEXT	LETTER HEIGHT	VERTICAL SPACING	ARROW RTE, MKR,	SIGNS REQUIRED	BACK- GROUND	LEGEND BORDER	RADIUS	SQUARE FEET	
W8-15	48"	48"	GROOVED	CONFOR STANDA	DIMENSION M TO "2004 ARD HIGHWA 012 SUPPLE	EDITION - Y SIGNS -	8	ORANGE	BLACK		16.00 (128)	
W8-15P	24"	24*	000				8	ORANGE	BLACK		4,00 (32)	
W13-4P	36*	36 *	ON RAMP				2	ORANGE	BLACK		9.00 (18)	
W20-1	48"	48"	ROAD WORK AHEAD				5	ORANGE	BLACK		16,00 (80)	
W20-5(L)	48"	48"	LEFT LANE CLOSED AHEAD				4	ORANGE	BLACK		16,00 (64)	
w20-5(R)	48"	48*	RIGHT LANE CLOSED AHEAD				4	ORANGE	BLACK		16.00 (64)	
№ 20-5a(L)	48"	48"	LEFT TWO LANES CLOSED 1/2 MILE				4	ORANGE	BLACK		16.00 (64)	
W20-5a(R)	48"	48*	RIGHT TWO LANES CLOSED 1/2 MILE				4	ORANGE	BLACK		16.00 (64)	

	Scal	le:			Designed by	·:				
.summary.dgr		NOT TO SCALE					HN	ITR		
sign_	No.	Revision	Ву	Date						
Z_					CONSULTANT	PROJEC	T MANAGER:	Dale A. Mitchell	, P.E.	
me						Ву	Date		Ву	Date
Filename:					Designed	CET	11\24	Checked	РЕМ	11\24
Ξ̈́					Drawn	CET	11\24	In Charge of	TRC	11\24

HNTB CORPORATION 82 Running Hill Road, Suite 201 South Portland, ME 04106 TEL (207) 774-5155 FAX (207) 228-0909



THE GOLD STAR MEMORIAL HIGHWAY

PORTLAND AREA PAVEMENT REHABILITATION NORTHBOUND MM 42.0 TO MM 49.3

MAINTENANCE OF TRAFFIC

SIGN SUMMARY 2 OF 2
SHEET NUMBER: MOT-09 210F 50 CONTRACT: 2024.02

NOTE:
I. THE CONTRACTOR SHALL MEASURE THE EXISTING CROSS
SLOPES FOR LANE I, 2, 3, AND THE INSIDE AND OUTSIDE
SHOULDER EVERY 1/4 MILE AND REPORT TO THE
RESIDENT PRIOR TO MILLING, PAYMENT FOR THIS WORK SHALL BE CONSIDERED INCIDENTAL TO 403 PAY ITEMS. MATCH LINE STA. 2069·00 MATCH TO GENERAL PLAN O2 N33°24'45.79"E LANE LINES SHOWN FOR REFERENCE ONLY. SEE STRIPING DETAILS 1-3 FOR PROPOSED STRIPING INFORMATION. <u>LEGEND</u> 11/2" MILL AND FILL 11/2" MILL AND FILL AND 11/2" OVERLAY BUTT JOINT - MAINEDOT STD DETAIL 202(01) UNDERPASS PAVEMENT Scale: Designed by: PORTLAND AREA PAVEMENT REHABILITATION MAINE TURNPIKE NORTHBOUND MM 42.0 TO MM 49.3 HNTB CORPORATION THE GOLD STAR 82 Running Hill Road, Suite 201 South Portland, ME 04106 TEL (207) 774-5155 FAX (207) 228-0909 By Date Revision **MEMORIAL HIGHWAY**

MTA PROJECT MANAGER: Joseph R. Leavitt, P.E.


GENERAL PLAN (1 OF 29)

CONTRACT: 2025.02

SHEET NUMBER: GP-01

CONSULTANT PROJECT MANAGER: Dale A. Mitchell, P.E.

Ву

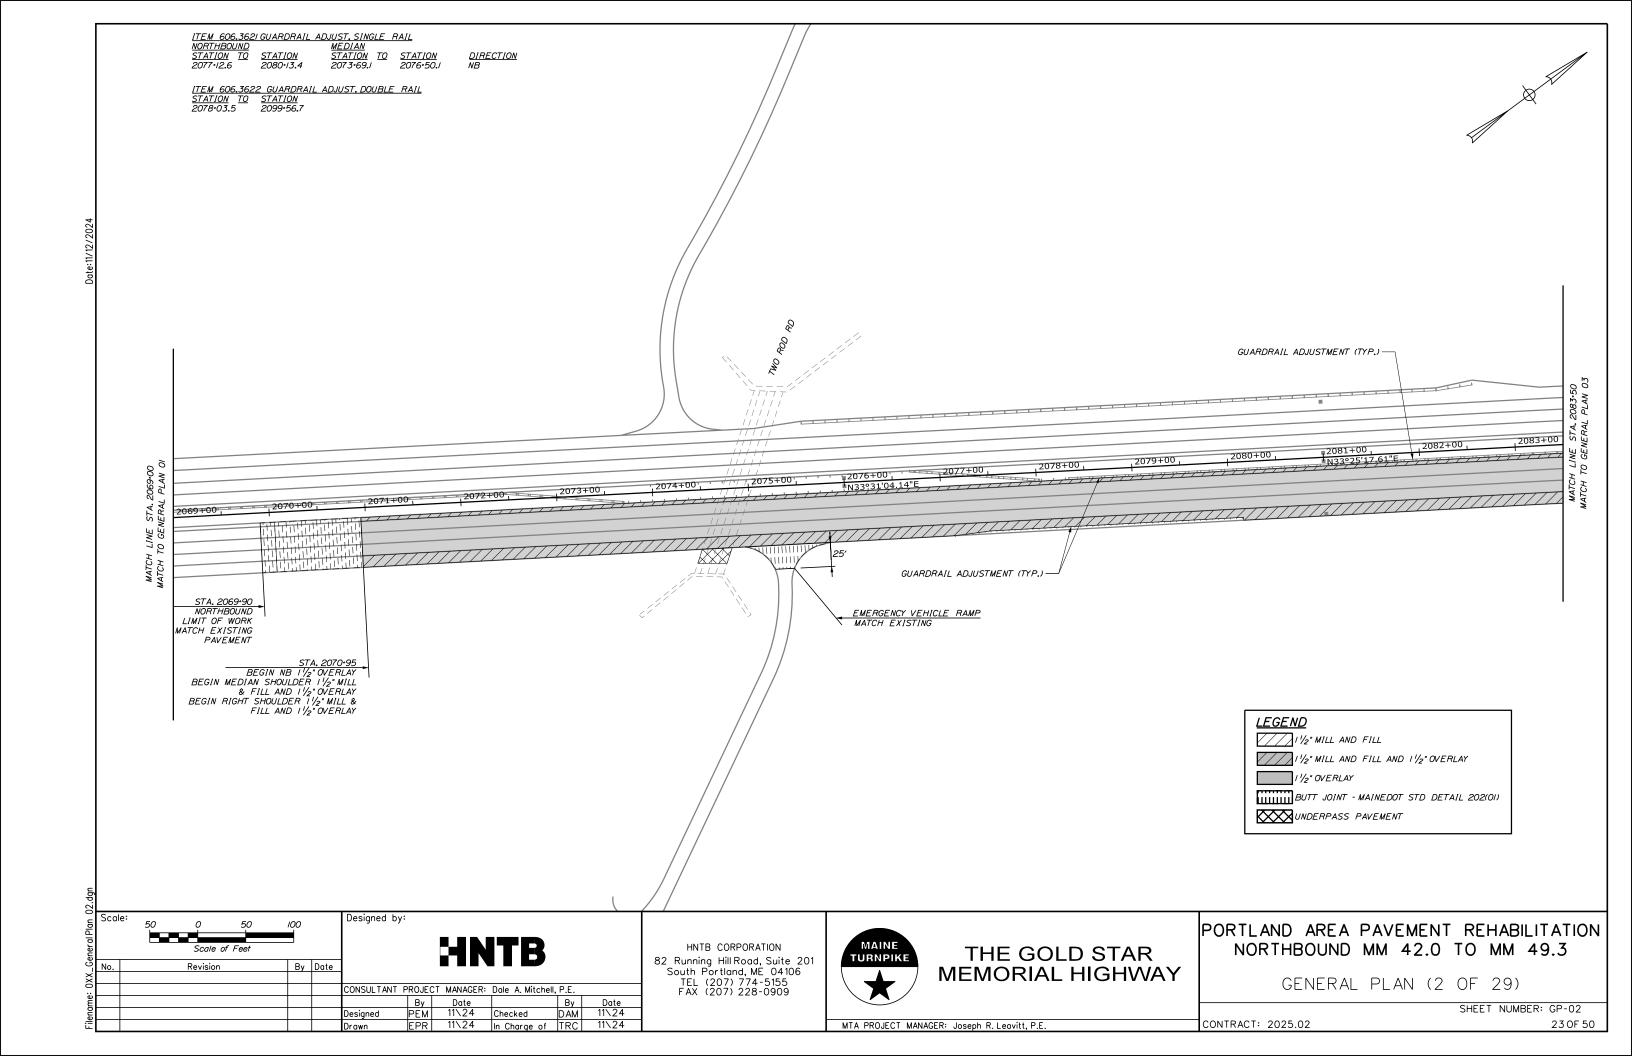



2085+00 2086+00 2087+00 2084+00 2090+00 ,2091+00, 2092+00 2094+00 2095+00 2096+00 2097+00 MIN. MILL WIDTH STA. II+47 LIMIT OF MILL AT SHOULDER GORE EXIT 42 NB OFF STA.15+75 LIMIT OF WORK STA.14.82 END RIGHT SHOULDER 11/2" MILL & FILL AND 11/2" OVERLAY END 11/2" RAMP OVERLAY MATCH EXISTING STA. 2091*84

BEGIN RIGHT SHOULDER 11/2"

MILL & FILL AND 11/2" OVERLAY <u>LEGEND</u> 11/2" MILL AND FILL 11/2" MILL AND FILL AND 11/2" OVERLAY I 1/2" OVERLAY BUTT JOINT - MAINEDOT STD DETAIL 202(01) UNDERPASS PAVEMENT Designed by: PORTLAND AREA PAVEMENT REHABILITATION MAINE TURNPIKE NORTHBOUND MM 42.0 TO MM 49.3 HNTB CORPORATION THE GOLD STAR 82 Running Hill Road, Suite 201 South Portland, ME 04106 TEL (207) 774-5155 FAX (207) 228-0909 By Date **MEMORIAL HIGHWAY** GENERAL PLAN (3 OF 29) CONSULTANT PROJECT MANAGER: Dale A. Mitchell, P.E. Ву SHEET NUMBER: GP-03
 11\24
 Checked
 DAM

 11\24
 In Charge of TRC
 MTA PROJECT MANAGER: Joseph R. Leavitt, P.E. CONTRACT: 2025.02

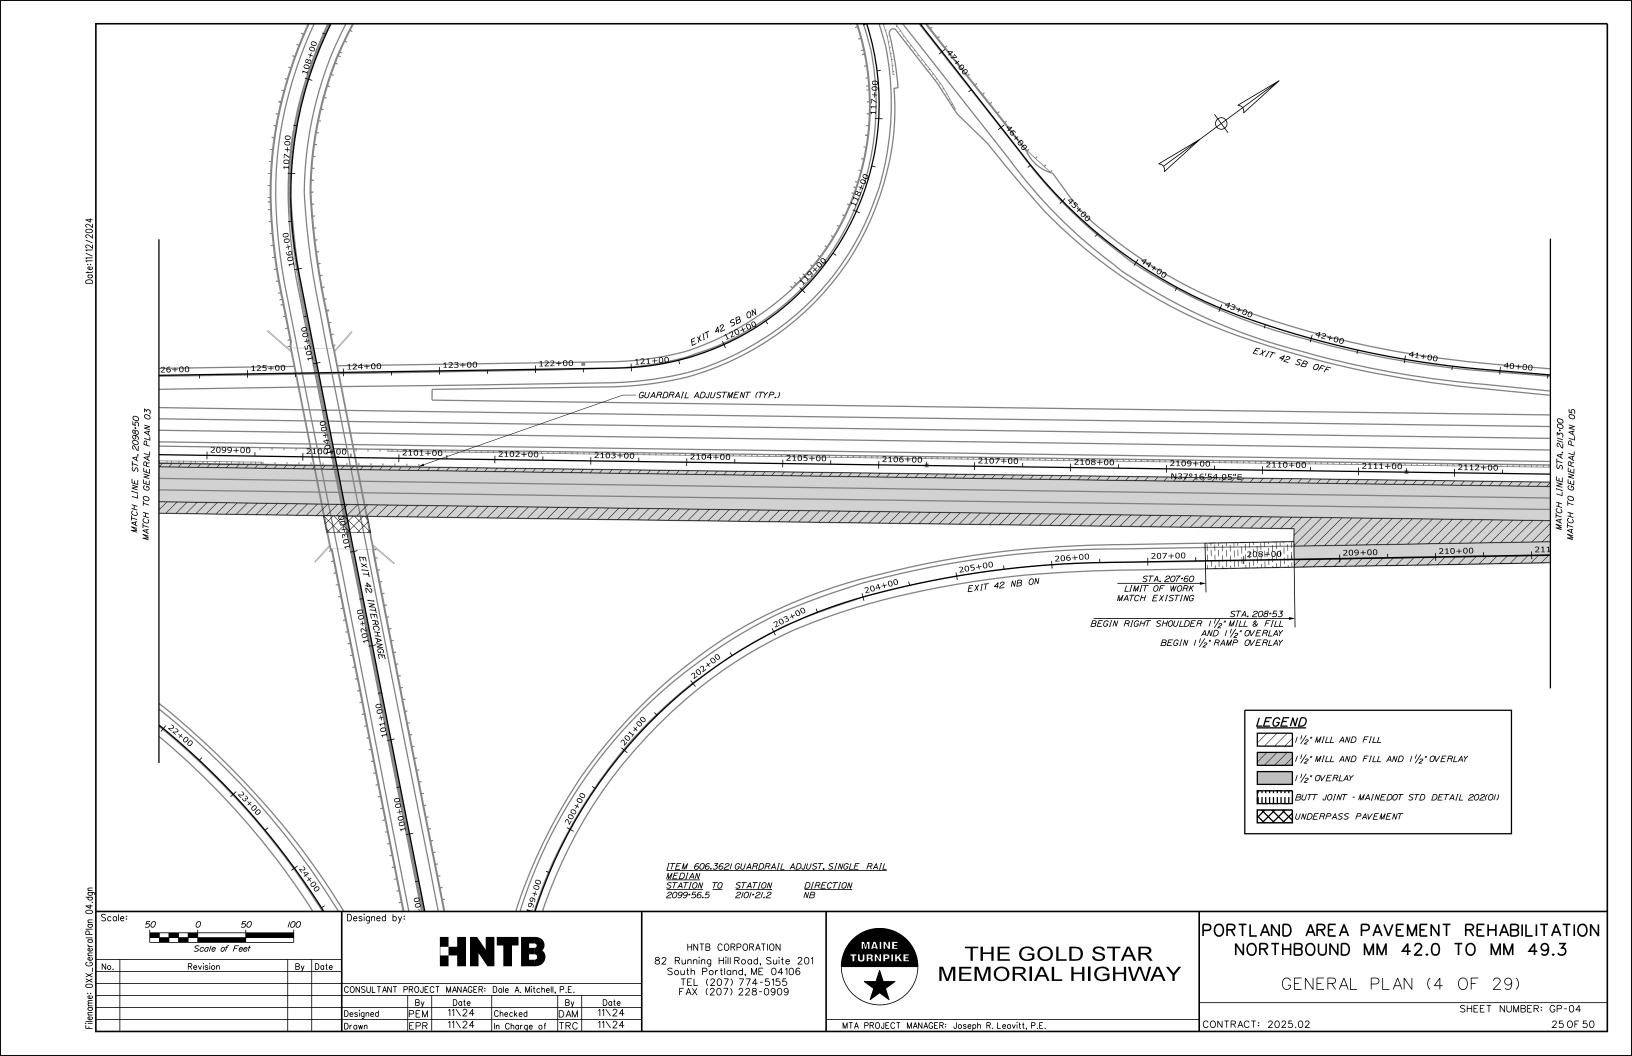

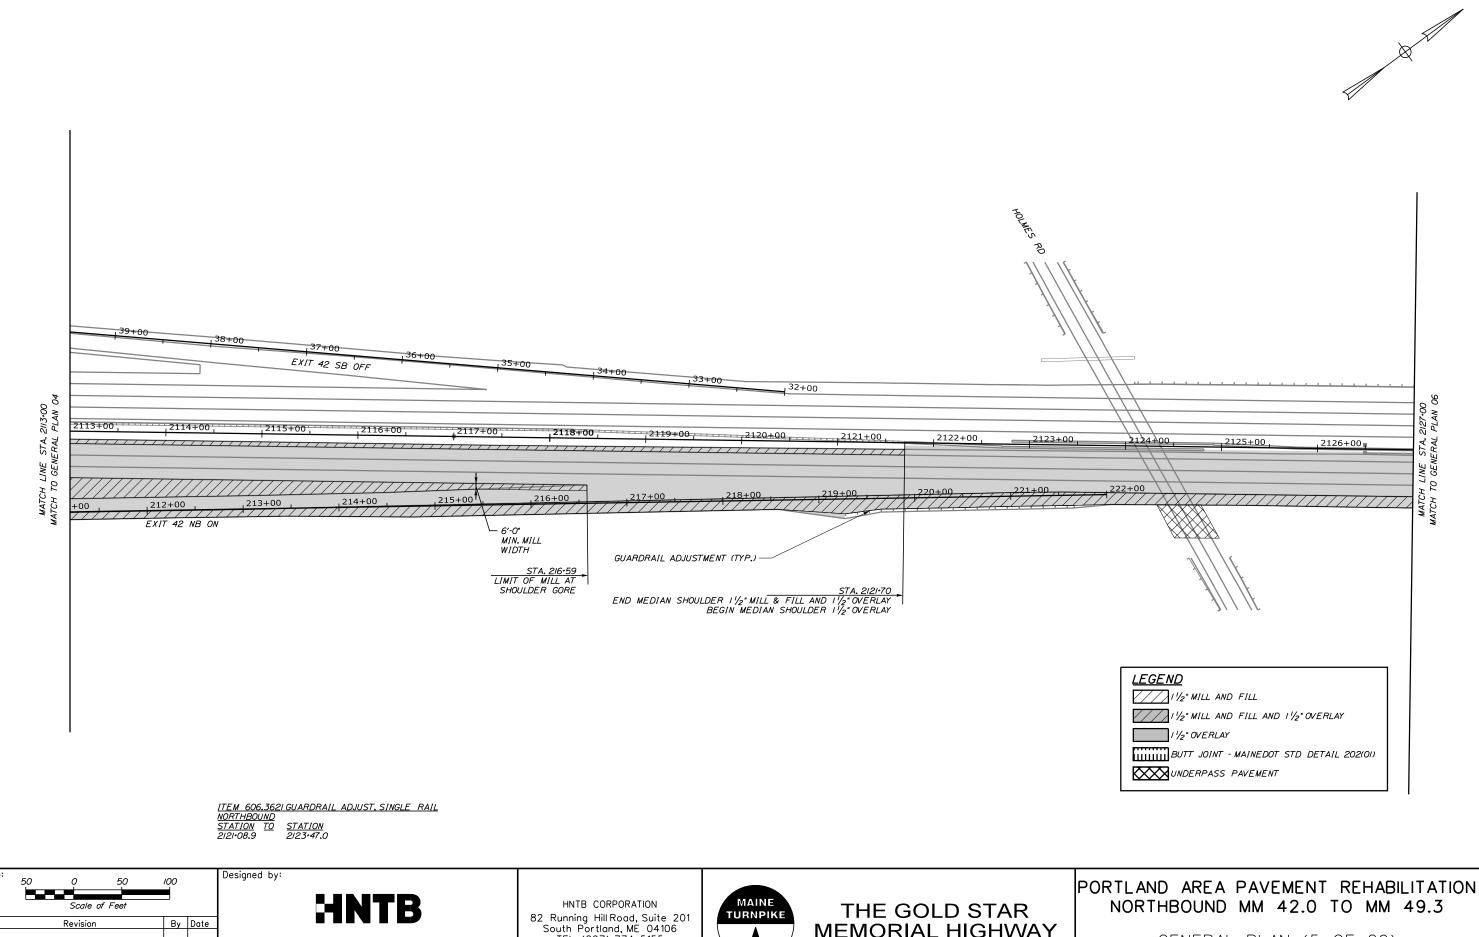

CONSULTANT PROJECT MANAGER: Dale A. Mitchell, P.E.
 Date
 By

 11\24
 Checked
 DAM


 11\24
 In Charge of TRC
 82 Running Hill Road, Suite 201 South Portland, ME 04106 TEL (207) 774-5155 FAX (207) 228-0909

MTA PROJECT MANAGER: Joseph R. Leavitt, P.E.

MEMORIAL HIGHWAY

GENERAL PLAN (5 OF 29)

SHEET NUMBER: GP-05 CONTRACT: 2025.02

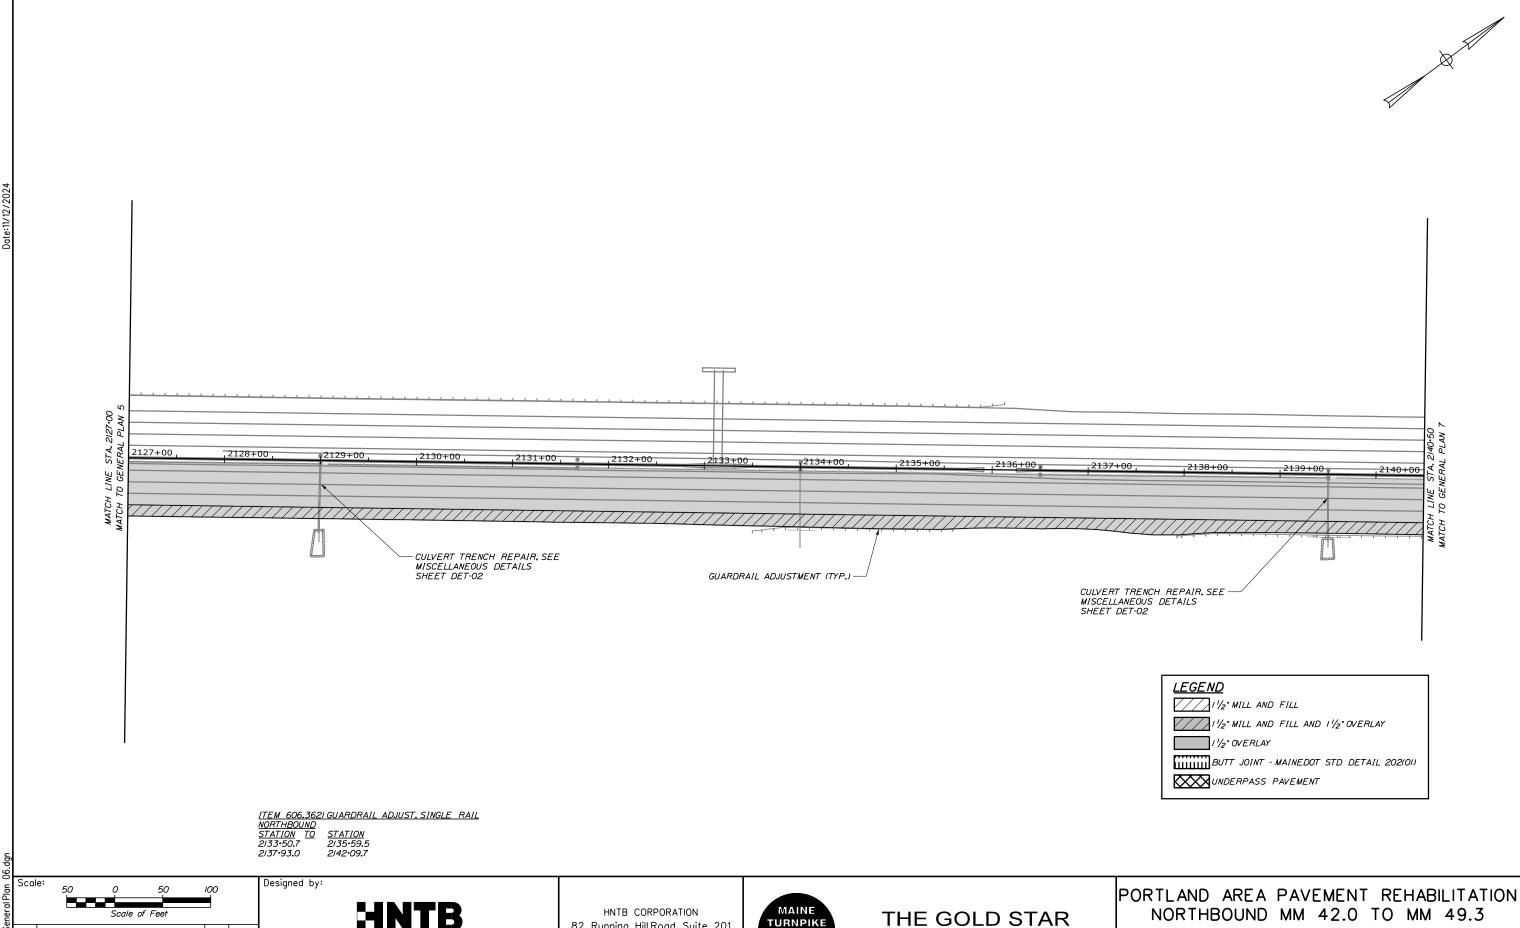

By Date Revision CONSULTANT PROJECT MANAGER: Dale A. Mitchell, P.E. Ву
 11\24
 Checked
 DAM

 11\24
 In Charge of TRC

82 Running Hill Road, Suite 201 South Portland, ME 04106 TEL (207) 774-5155 FAX (207) 228-0909


MAINE TURNPIKE

MEMORIAL HIGHWAY

GENERAL PLAN (6 OF 29)

SHEET NUMBER: GP-06

MTA PROJECT MANAGER: Joseph R. Leavitt, P.E.

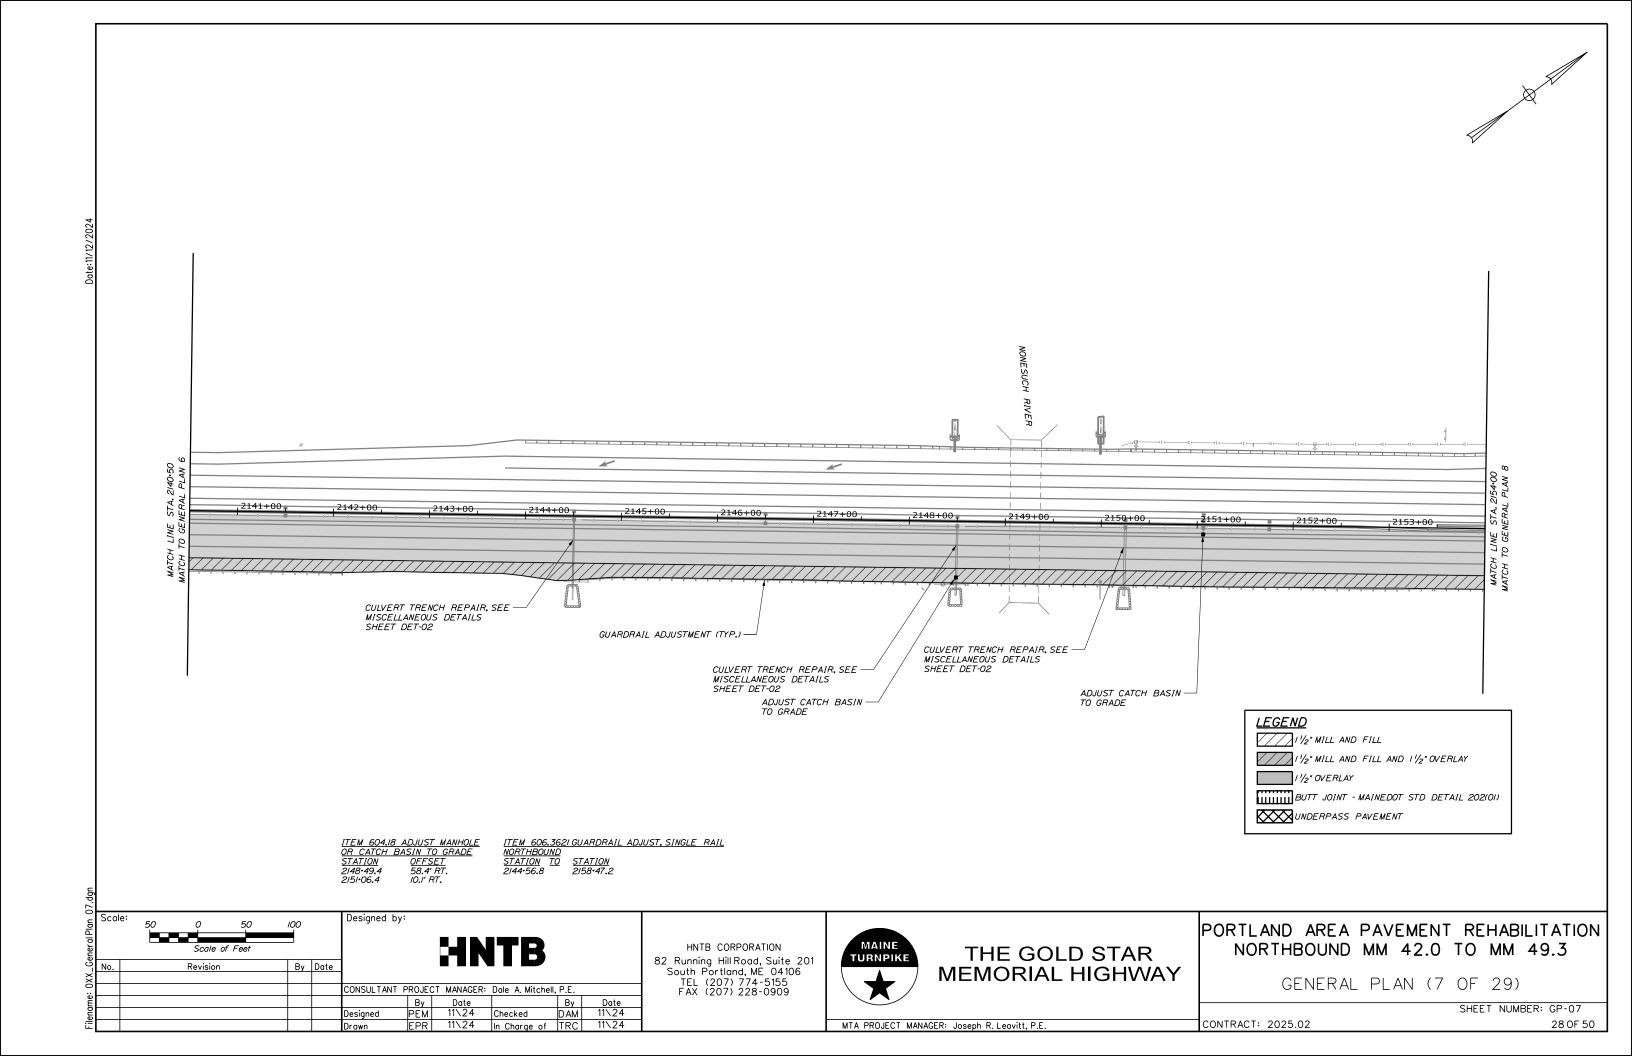

By Date Revision CONSULTANT PROJECT MANAGER: Dale A. Mitchell, P.E. Ву
 11\24
 Checked
 DAM

 11\24
 In Charge of TRC

82 Running Hill Road, Suite 201 South Portland, ME 04106 TEL (207) 774-5155 FAX (207) 228-0909




THE GOLD STAR **MEMORIAL HIGHWAY**


NORTHBOUND MM 42.0 TO MM 49.3


GENERAL PLAN (8 OF 29)

SHEET NUMBER: GP-08


MTA PROJECT MANAGER: Joseph R. Leavitt, P.E.

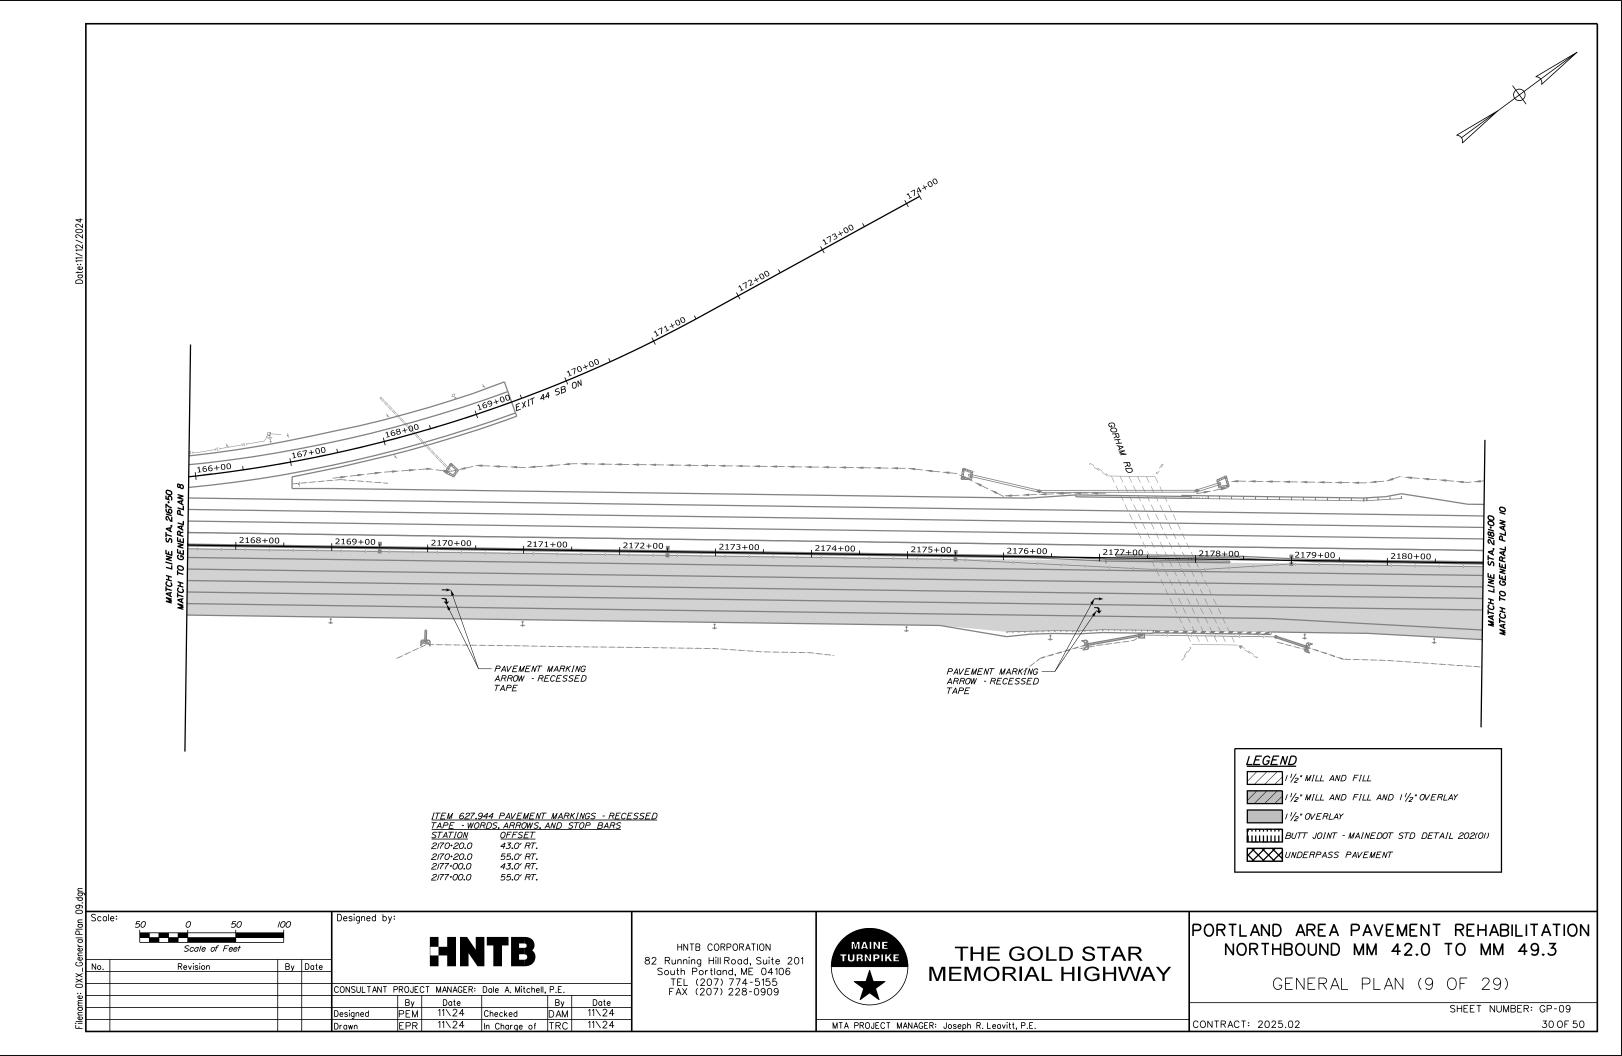

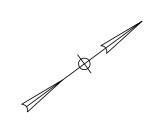

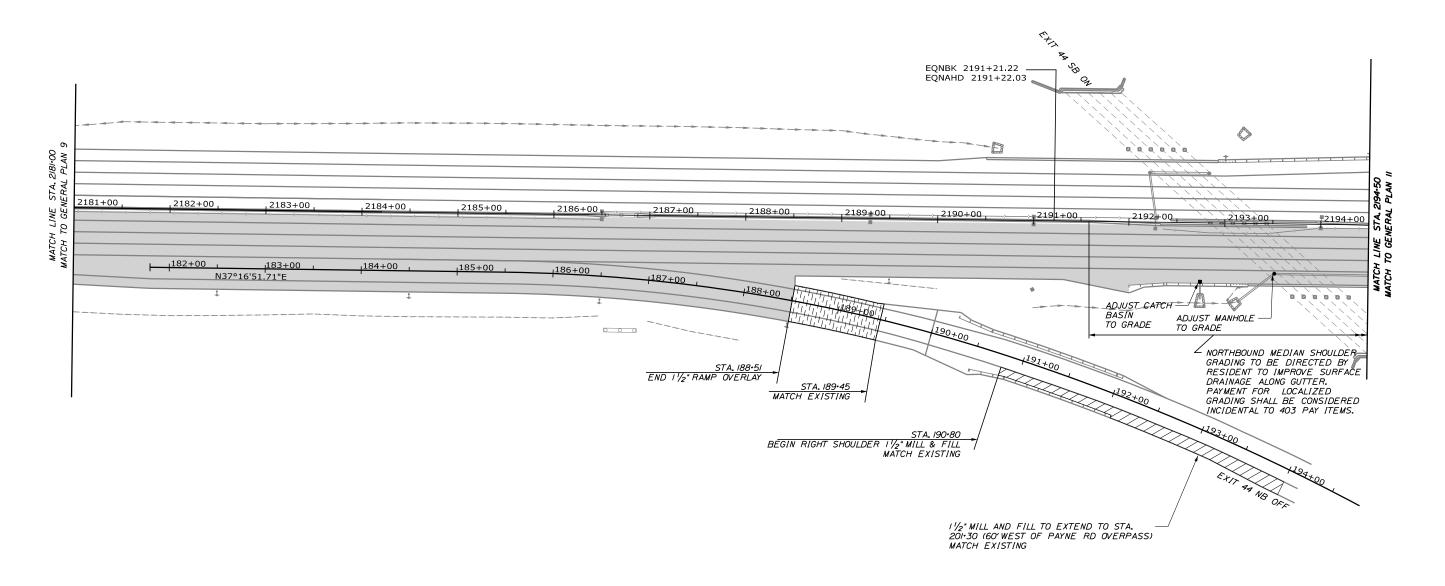

| ITEM 604.18 ADJUST MANHOLE | OR CATCH BASIN TO GRADE | STATION | OFFSET | 2192-74.8 | 61.5' RT. | 2193-52.2 | 52.1' RT.

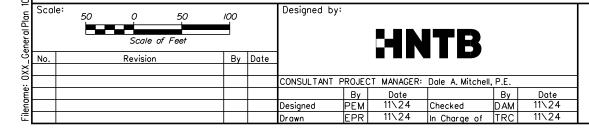

HNTB CORPORATION 82 Running Hill Road, Suite 201 South Portland, ME 04106 TEL (207) 774-5155 FAX (207) 228-0909





THE GOLD STAR **MEMORIAL HIGHWAY**


PORTLAND AREA PAVEMENT REHABILITATION NORTHBOUND MM 42.0 TO MM 49.3


GENERAL PLAN (10 OF 29)


SHEET NUMBER: GP-10 CONTRACT: 2025.02

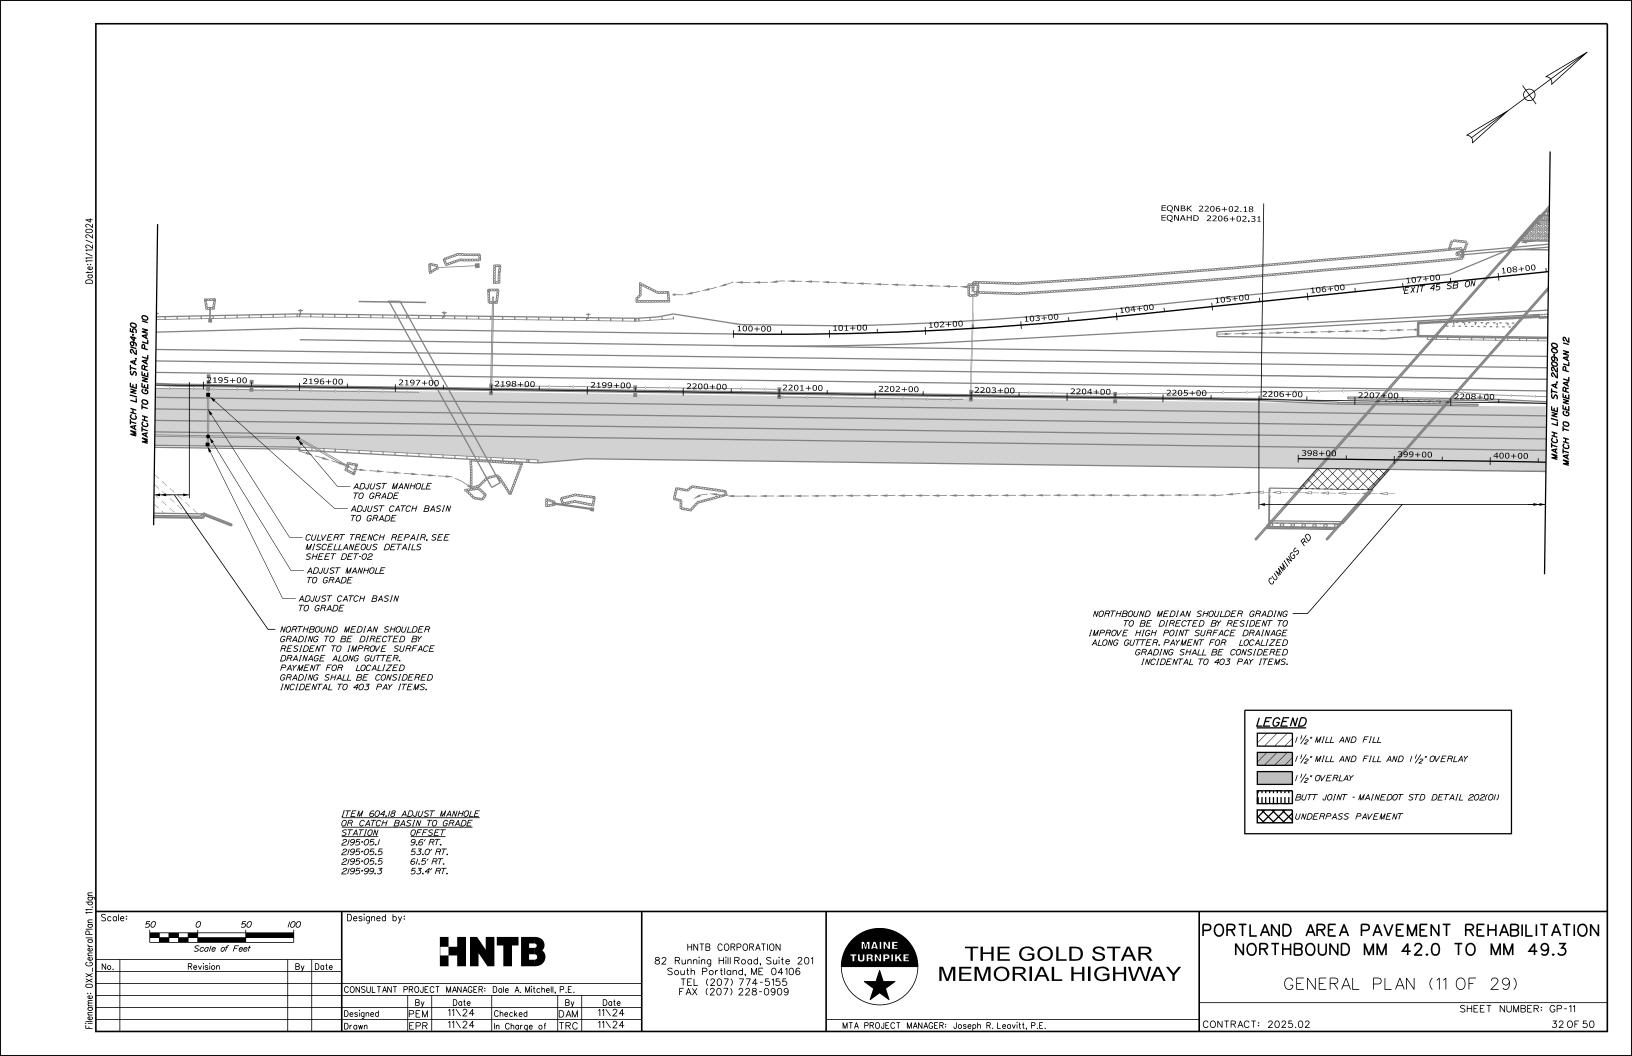

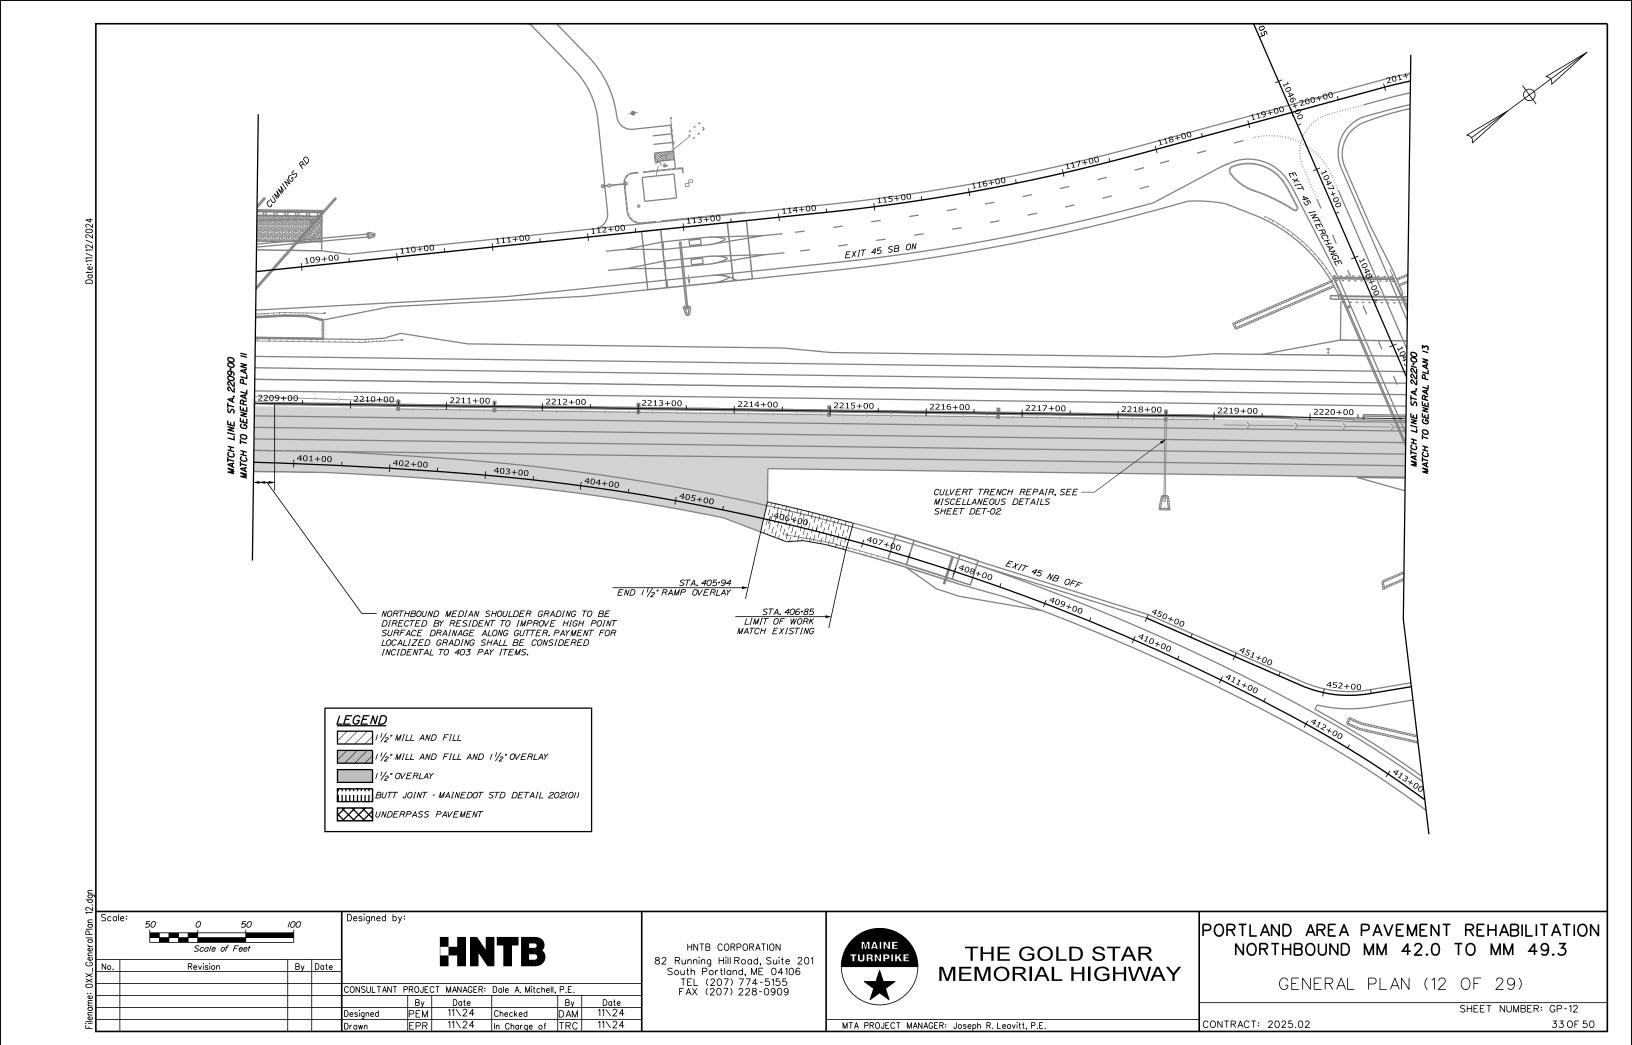

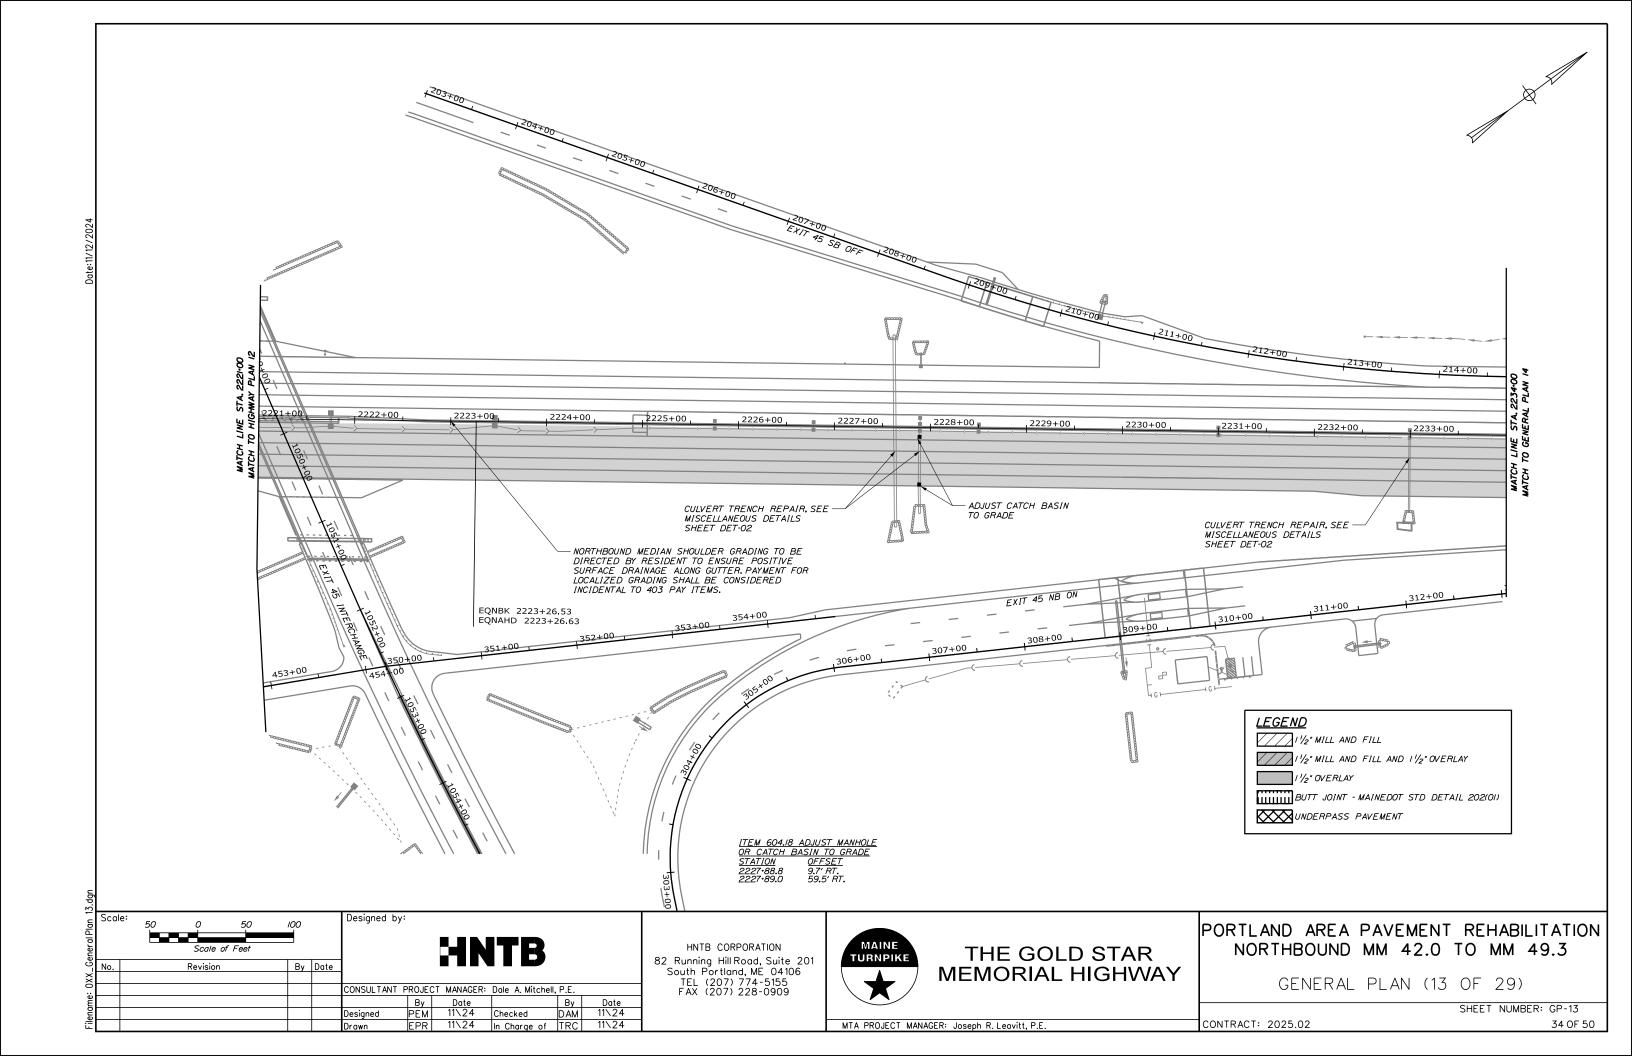

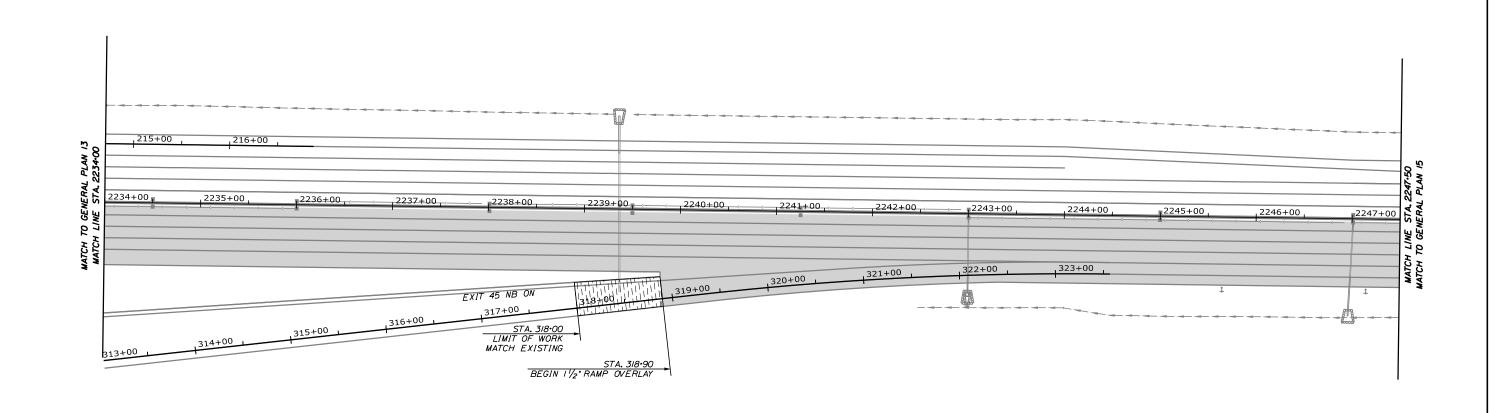

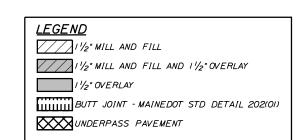

Scale:	50 0 50 Scale of Feet	100		Designed by:	•	HN	ITB		
No.	Revision	Ву	Date						
				CONSULTANT	PROJEC By T	T MANAGER:	Dale A. Mitchell	, P.E. TBv T	Date
				Designed	PEM	11\24	Checked	DAM	11\24
Ĭ				Drawn	EPR	11\24	In Charge of	TRC	11\24

HNTB CORPORATION 82 Running Hill Road, Suite 201 South Portland, ME 04106 TEL (207) 774-5155 FAX (207) 228-0909




MTA PROJECT MANAGER: Joseph R. Leavitt, P.E.

THE GOLD STAR MEMORIAL HIGHWAY

PORTLAND AREA PAVEMENT REHABILITATION NORTHBOUND MM 42.0 TO MM 49.3

GENERAL PLAN (14 OF 29)

SHEET NUMBER: GP-14
CONTRACT: 2025.02 35 0F 50

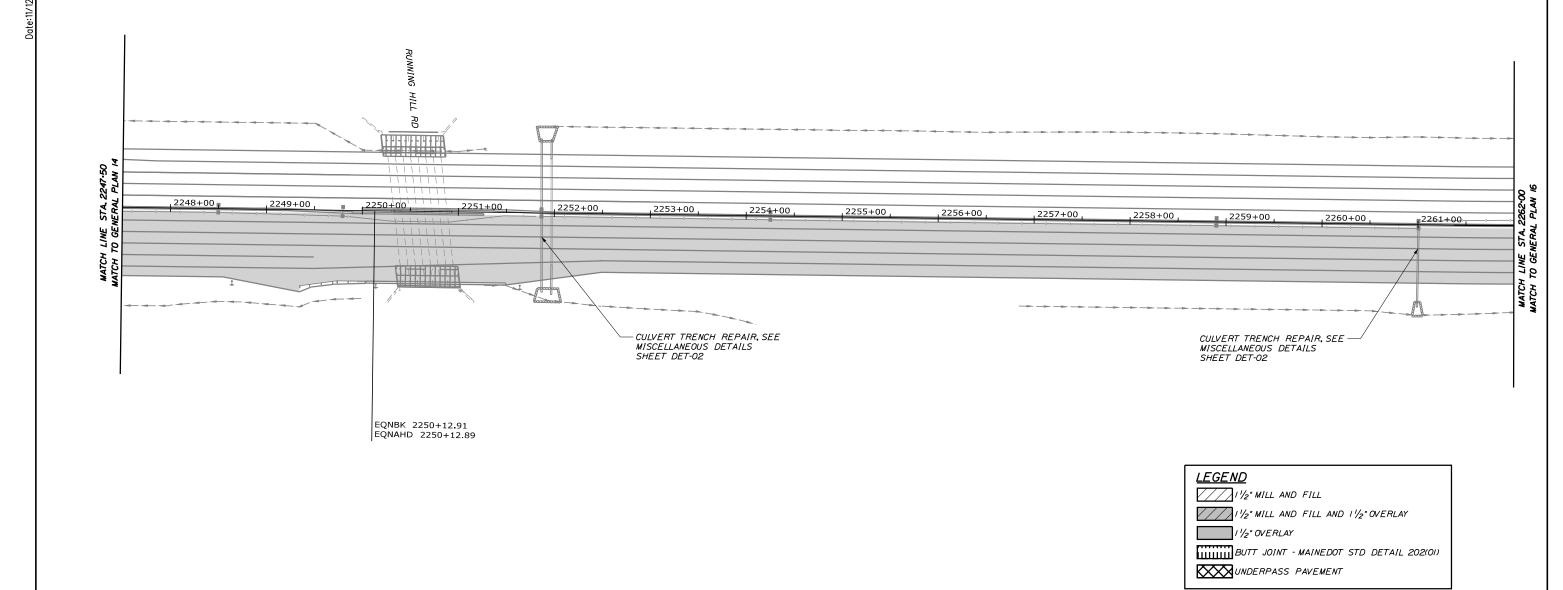

Scale.	50 0 Scale of F	50 100 Geet	Designed	by.	HN	ITB		
No.	Revision	Ву С	Date					
			CONSULTAN	IT PROJEC	T MANAGER:	Dale A. Mitchel	I, P.E.	
				Ву	Date		Ву	Date
			Designed	PEM	11\24	Checked	DAM	11\2
			Drawn	EPR	11\24	In Charge of	TRC	11\2

HNTB CORPORATION 82 Running Hill Road, Suite 201 South Portland, ME 04106 TEL (207) 774-5155 FAX (207) 228-0909



MTA PROJECT MANAGER: Joseph R. Leavitt, P.E.

THE GOLD STAR MEMORIAL HIGHWAY

PORTLAND AREA PAVEMENT REHABILITATION NORTHBOUND MM 42.0 TO MM 49.3

GENERAL PLAN (15 OF 29)

	SHEET NUMBER:	GP-15
CONTRACT: 2025.02		36 OF 50

 Date
 By

 11\24
 Checked
 DAM

 11\24
 In Charge of TRC


82 Running Hill Road, Suite 201 South Portland, ME 04106 TEL (207) 774-5155 FAX (207) 228-0909




SHEET NUMBER: GP-16

MTA PROJECT MANAGER: Joseph R. Leavitt, P.E.

CONTRACT: 2025.02

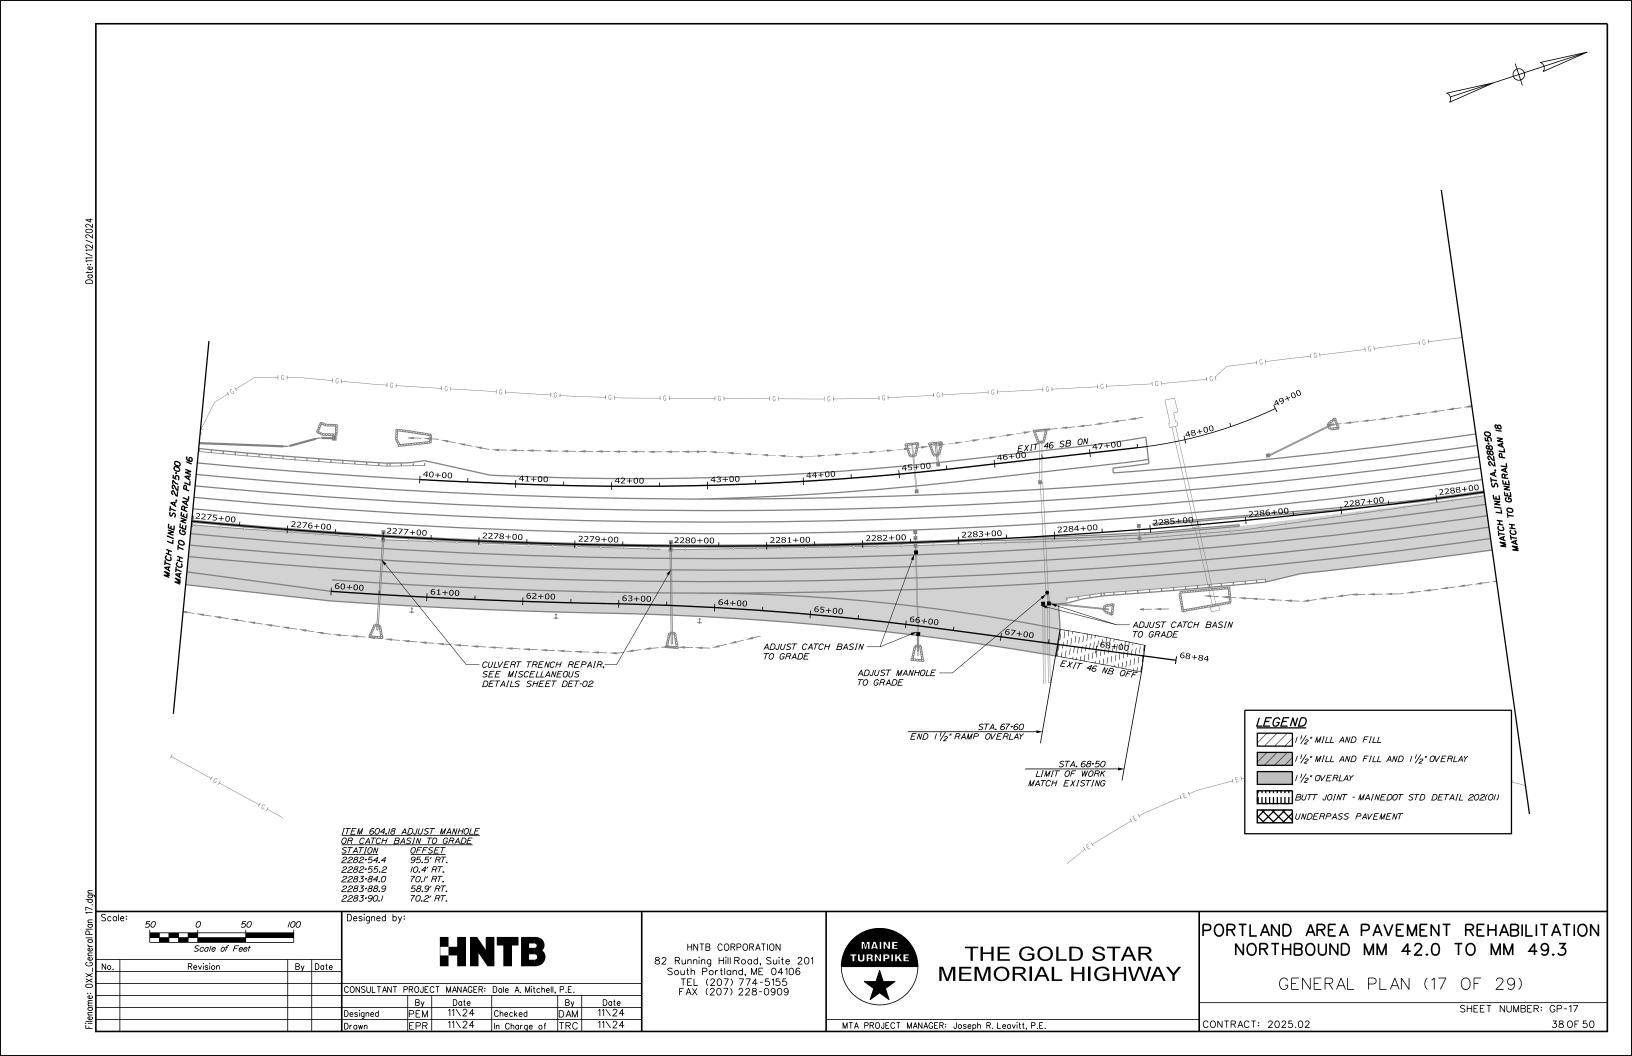



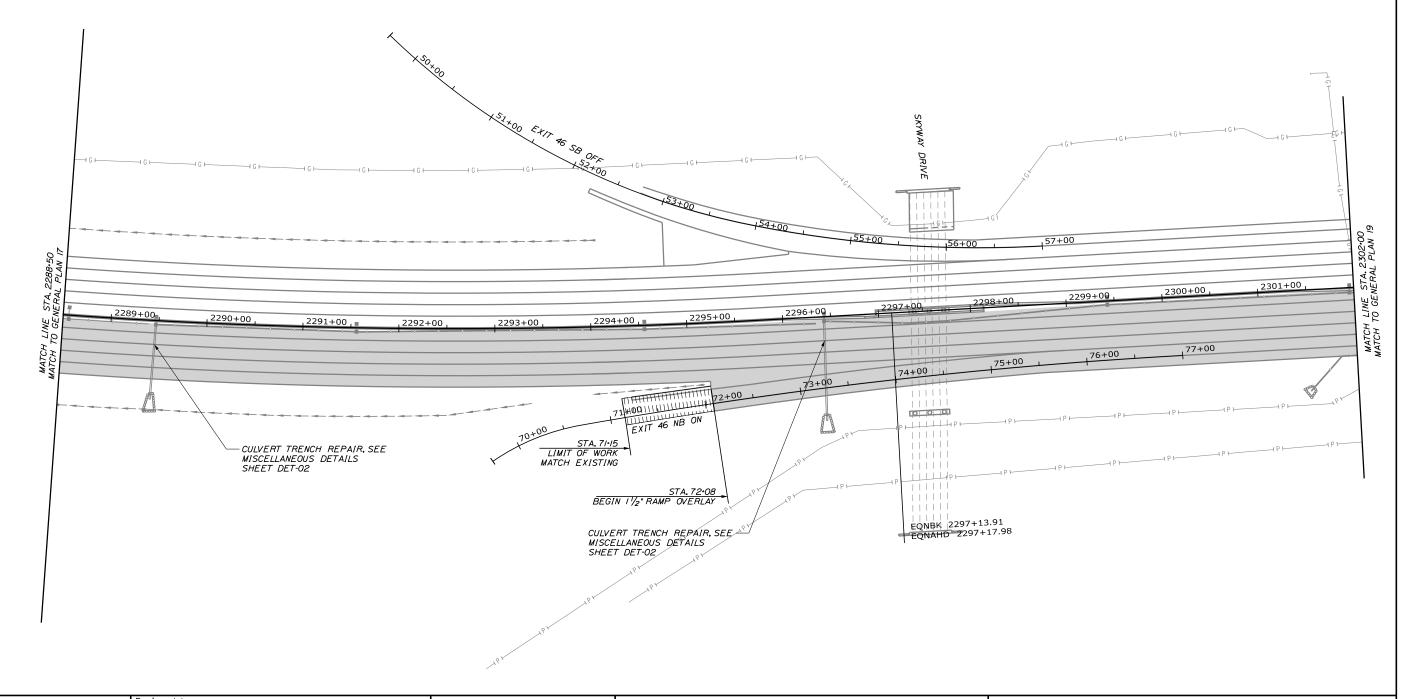

Designed by: Scale: By Date Revision CONSULTANT PROJECT MANAGER: Dale A. Mitchell, P.E.

11\24

Ву

Checked DAM
In Charge of TRC

HNTB CORPORATION 82 Running Hill Road, Suite 201 South Portland, ME 04106 TEL (207) 774-5155 FAX (207) 228-0909



MTA PROJECT MANAGER: Joseph R. Leavitt, P.E.


THE GOLD STAR **MEMORIAL HIGHWAY**

GENERAL PLAN (18 OF 29)


PORTLAND AREA PAVEMENT REHABILITATION

NORTHBOUND MM 42.0 TO MM 49.3

SHEET NUMBER: GP-18 CONTRACT: 2025.02

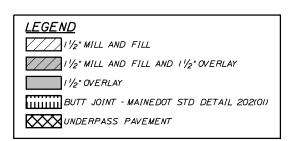



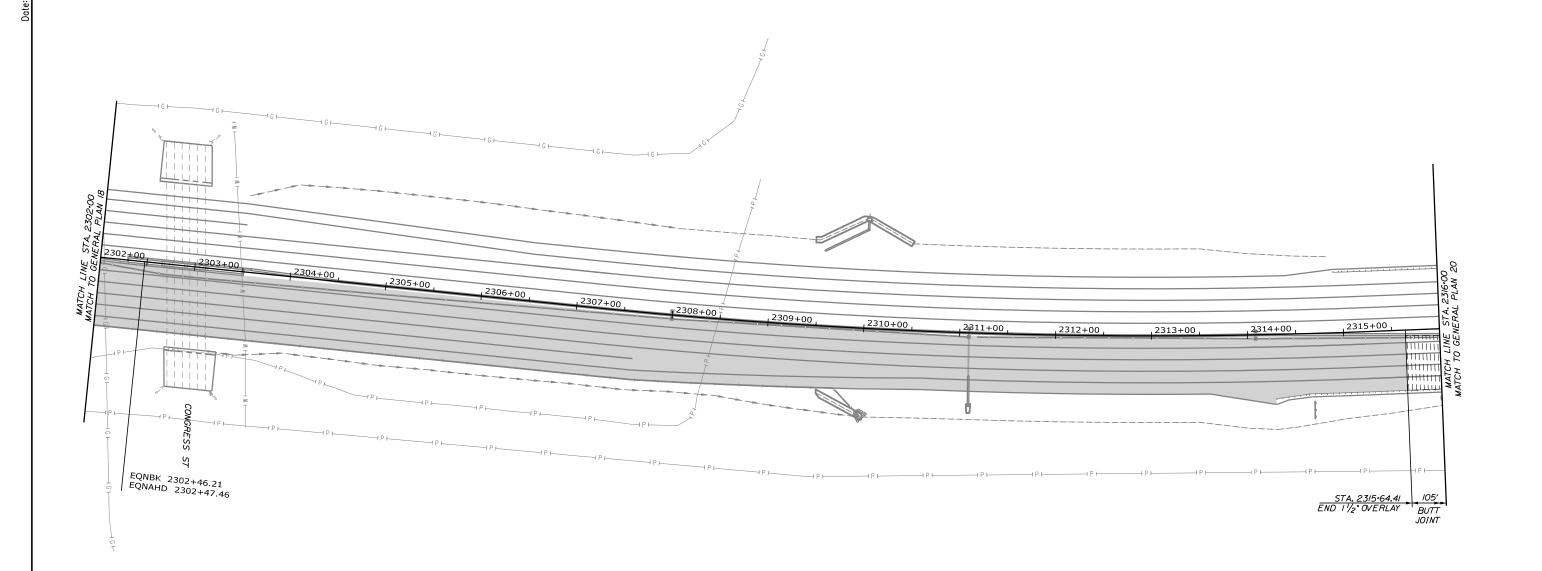

ame: 0XX_General Plan 19.dg

Revision

CONSULTANT PROJECT MANAGER: Dale A. Mitchell, P.E.

By Date By Date

Designed by:

By Date

HNTB CORPORATION 82 Running Hill Road, Suite 201 South Portland, ME 04106 TEL (207) 774-5155 FAX (207) 228-0909



MTA PROJECT MANAGER: Joseph R. Leavitt, P.E.

PORTLAND AREA PAVEMENT REHABILITATION NORTHBOUND MM 42.0 TO MM 49.3

GENERAL PLAN (19 OF 29)

SHEET NUMBER: GP-19
CONTRACT: 2025.02 40 OF 5

Designed by:

CONSULTANT PROJECT MANAGER: Dale A. Mitchell, P.E.

 11\24
 Checked
 DAM

 11\24
 In Charge of TRC

Ву

By Date




PORTLAND AREA PAVEMENT REHABILITATION

NORTHBOUND MM 42.0 TO MM 49.3

GENERAL PLAN (20 OF 29)

CONTRACT: 2025.02

SHEET NUMBER: GP-20

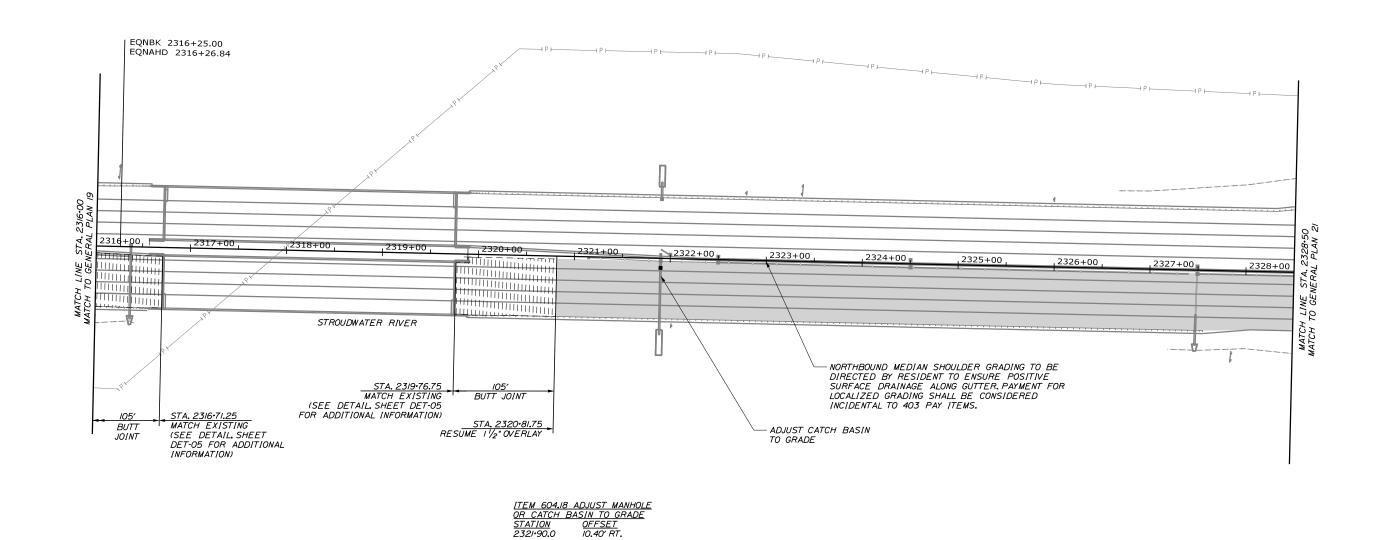

MAINE

TURNPIKE

MTA PROJECT MANAGER: Joseph R. Leavitt, P.E.

THE GOLD STAR

MEMORIAL HIGHWAY


HNTB CORPORATION

82 Running Hill Road, Suite 201 South Portland, ME 04106 TEL (207) 774-5155 FAX (207) 228-0909

ame: 0XX_General Plan 20.dgn

Scale:


Revision

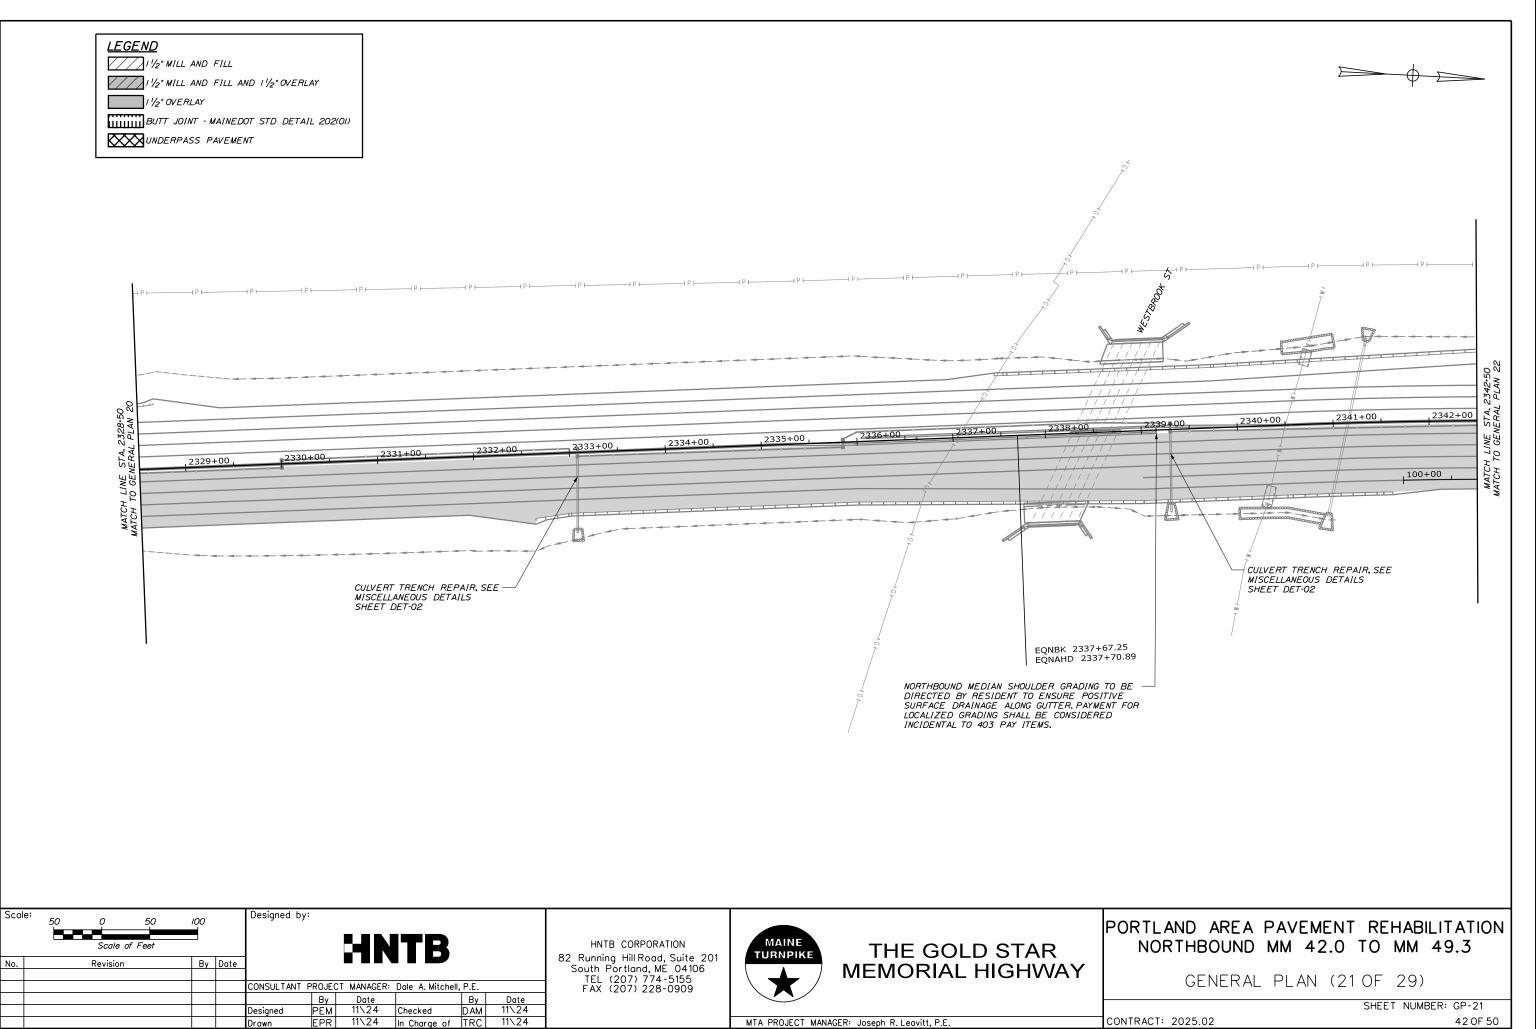


MTA PROJECT MANAGER: Joseph R. Leavitt, P.E.

CONTRACT: 2025.02

42 OF 50

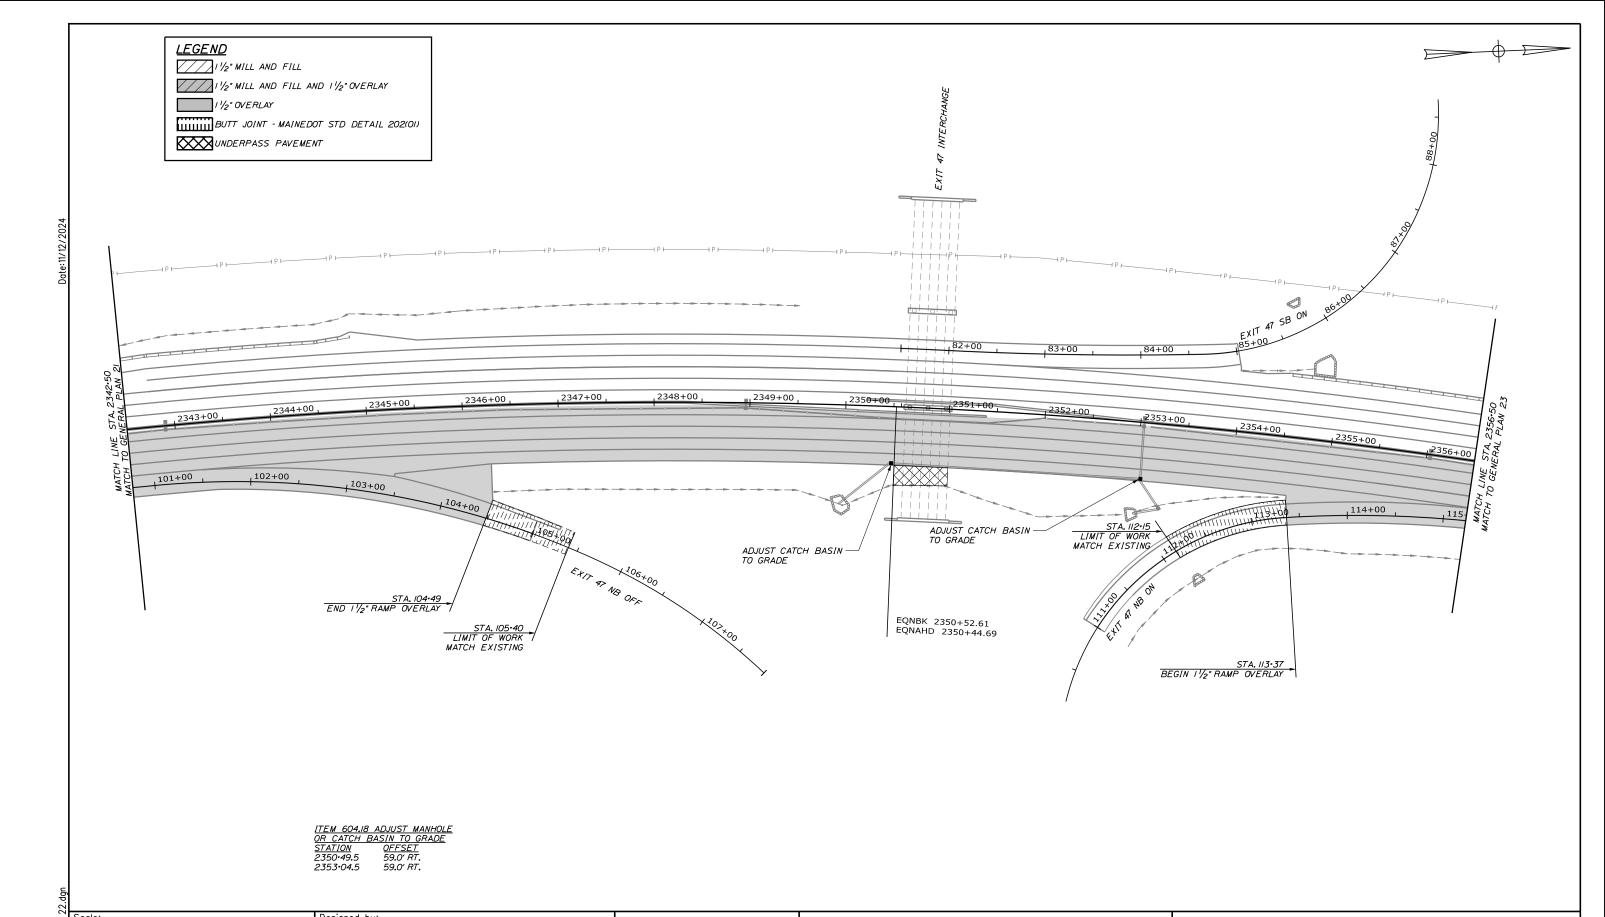

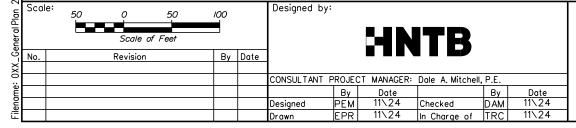

HNTB CORPORATION 82 Running Hill Road, Suite 201 South Portland, ME 04106 TEL (207) 774-5155 FAX (207) 228-0909



THE GOLD STAR **MEMORIAL HIGHWAY** NORTHBOUND MM 42.0 TO MM 49.3


GENERAL PLAN (22 OF 29)


PORTLAND AREA PAVEMENT REHABILITATION

SHEET NUMBER: GP-22


MTA PROJECT MANAGER: Joseph R. Leavitt, P.E.


CONTRACT: 2025.02

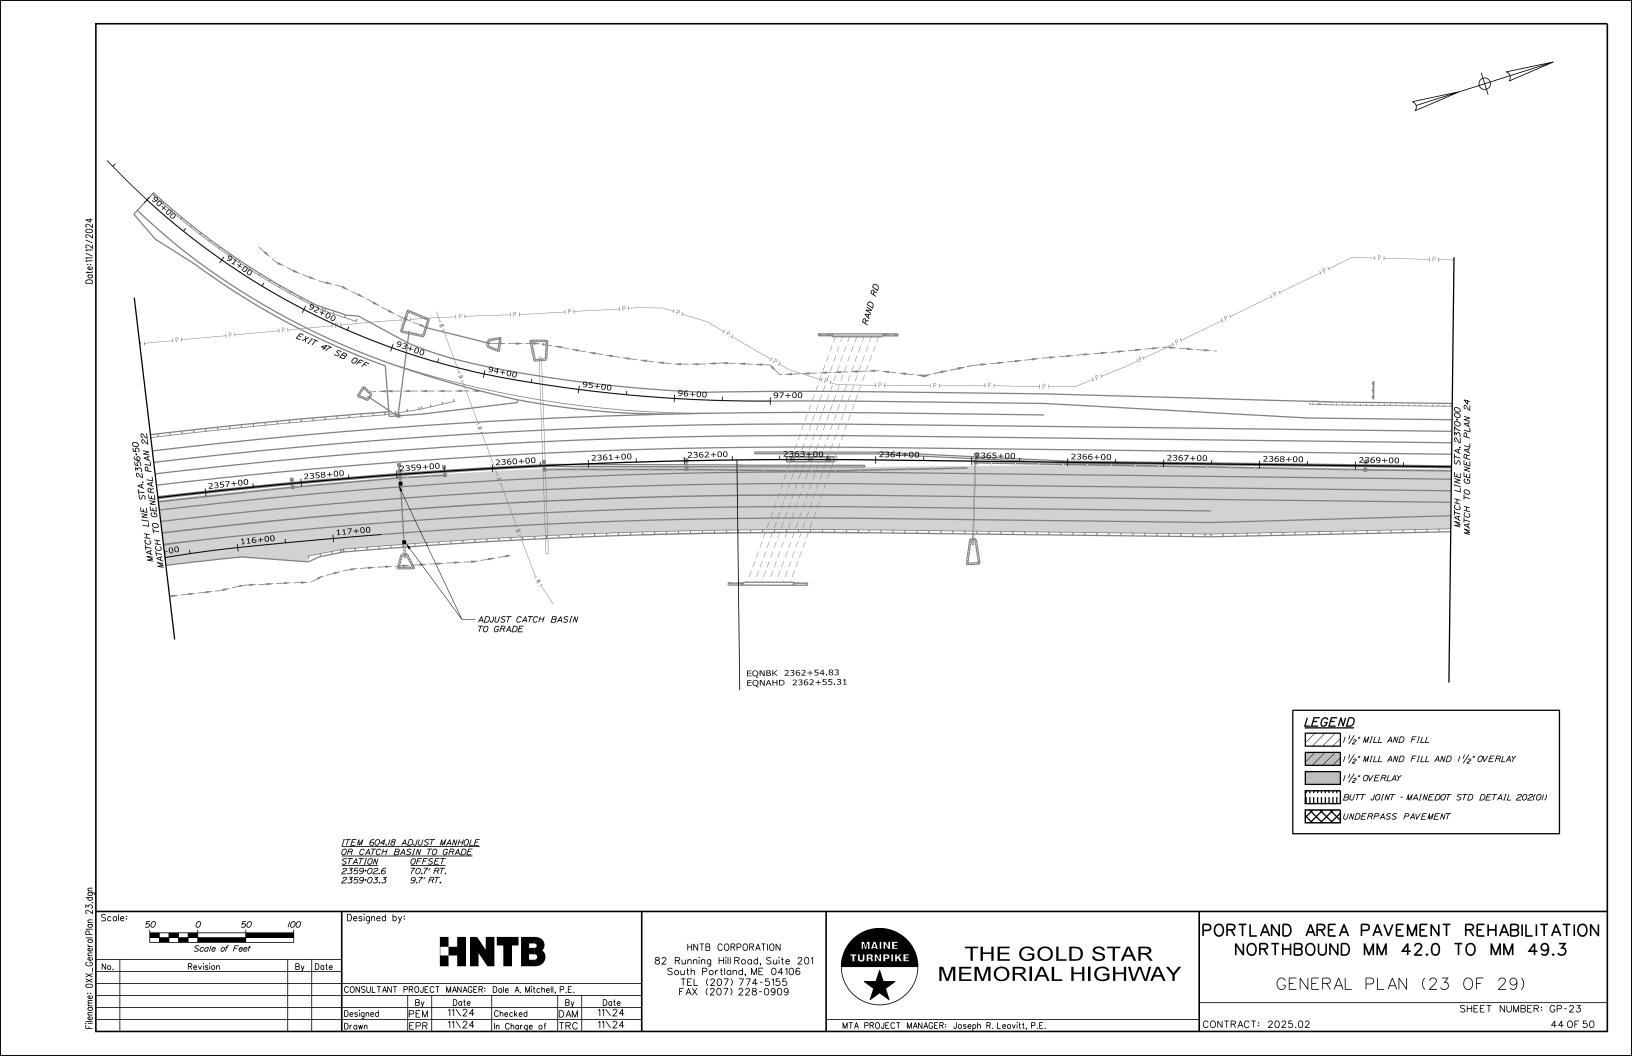

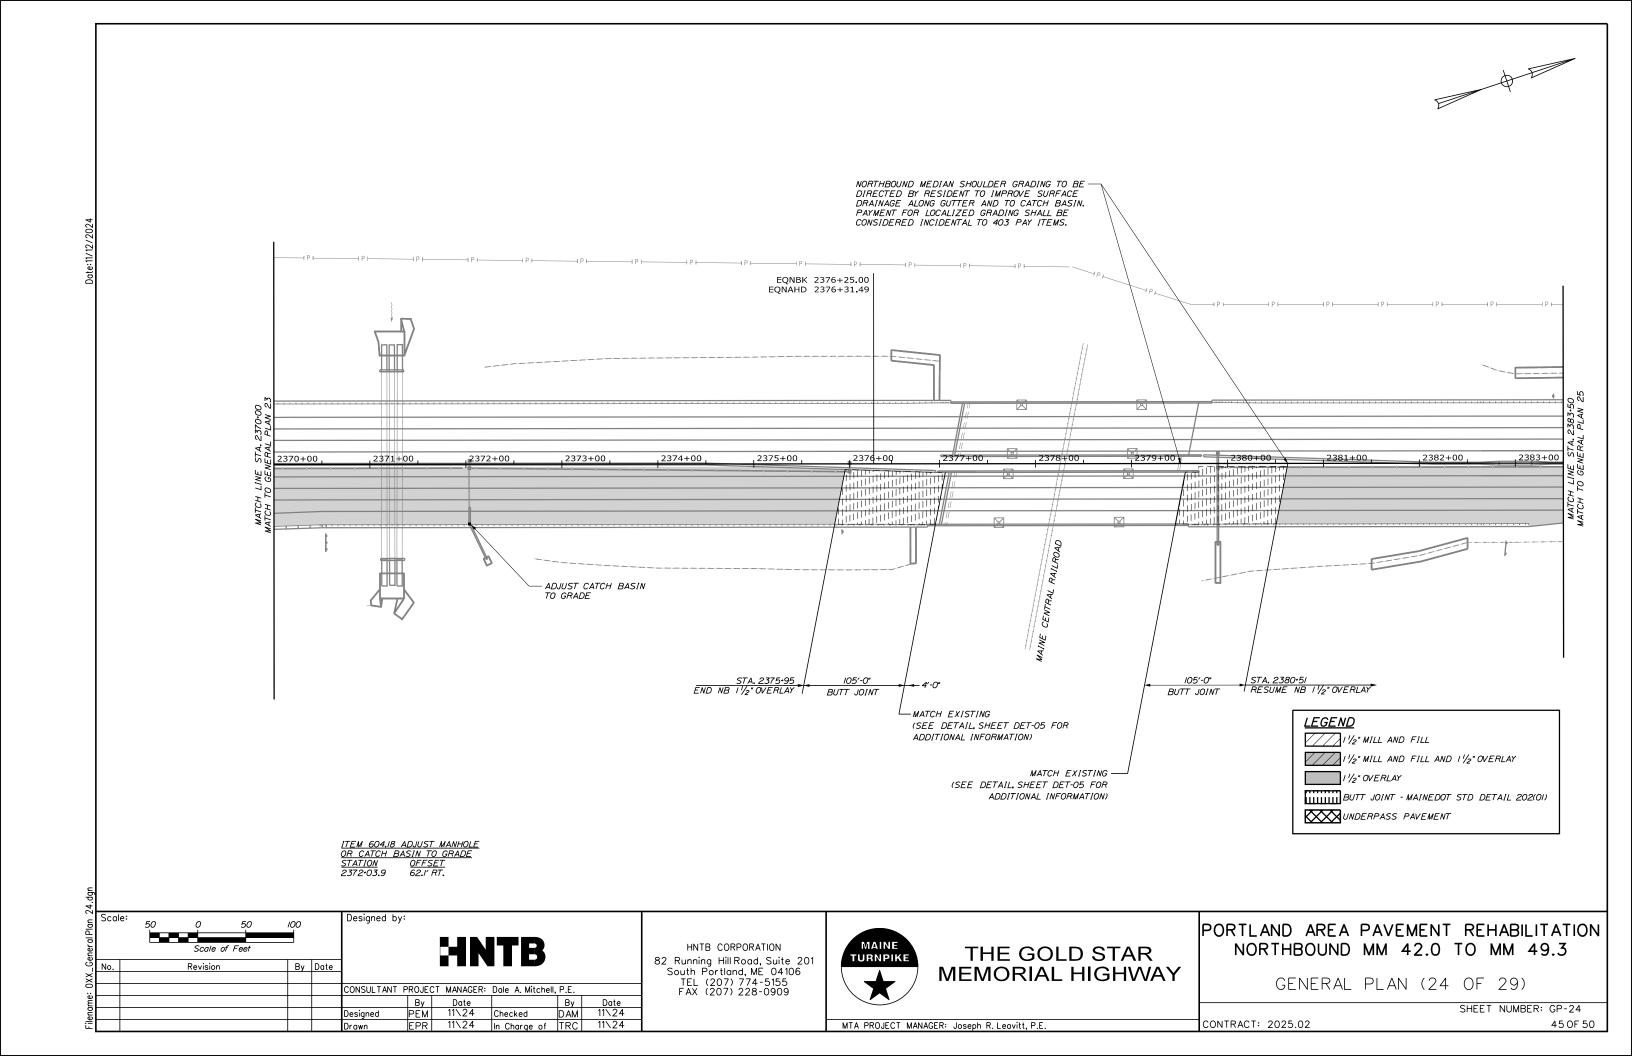



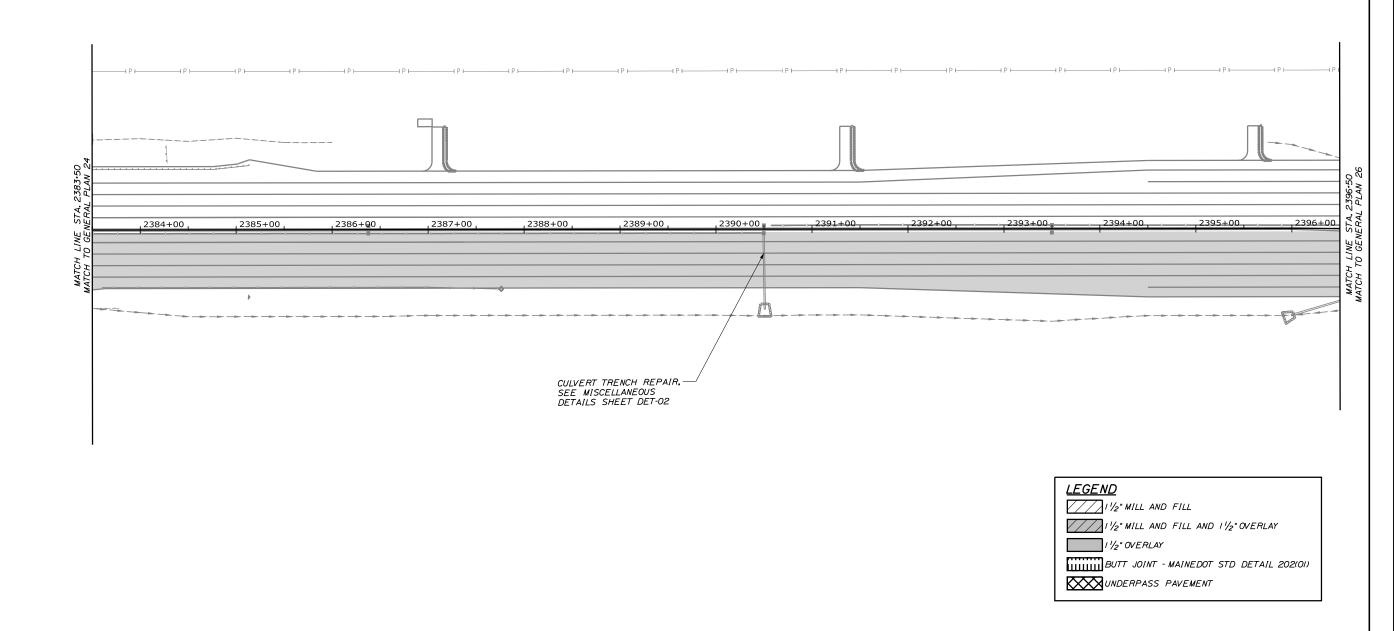

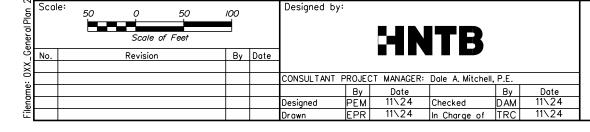

HNTB CORPORATION 82 Running Hill Road, Suite 201 South Portland, ME 04106 TEL (207) 774-5155 FAX (207) 228-0909





THE GOLD STAR MEMORIAL HIGHWAY

PORTLAND AREA PAVEMENT REHABILITATION NORTHBOUND MM 42.0 TO MM 49.3

GENERAL PLAN (25 OF 29)

SHEET NUMBER: GP-25 CONTRACT: 2025.02 46 0F 50

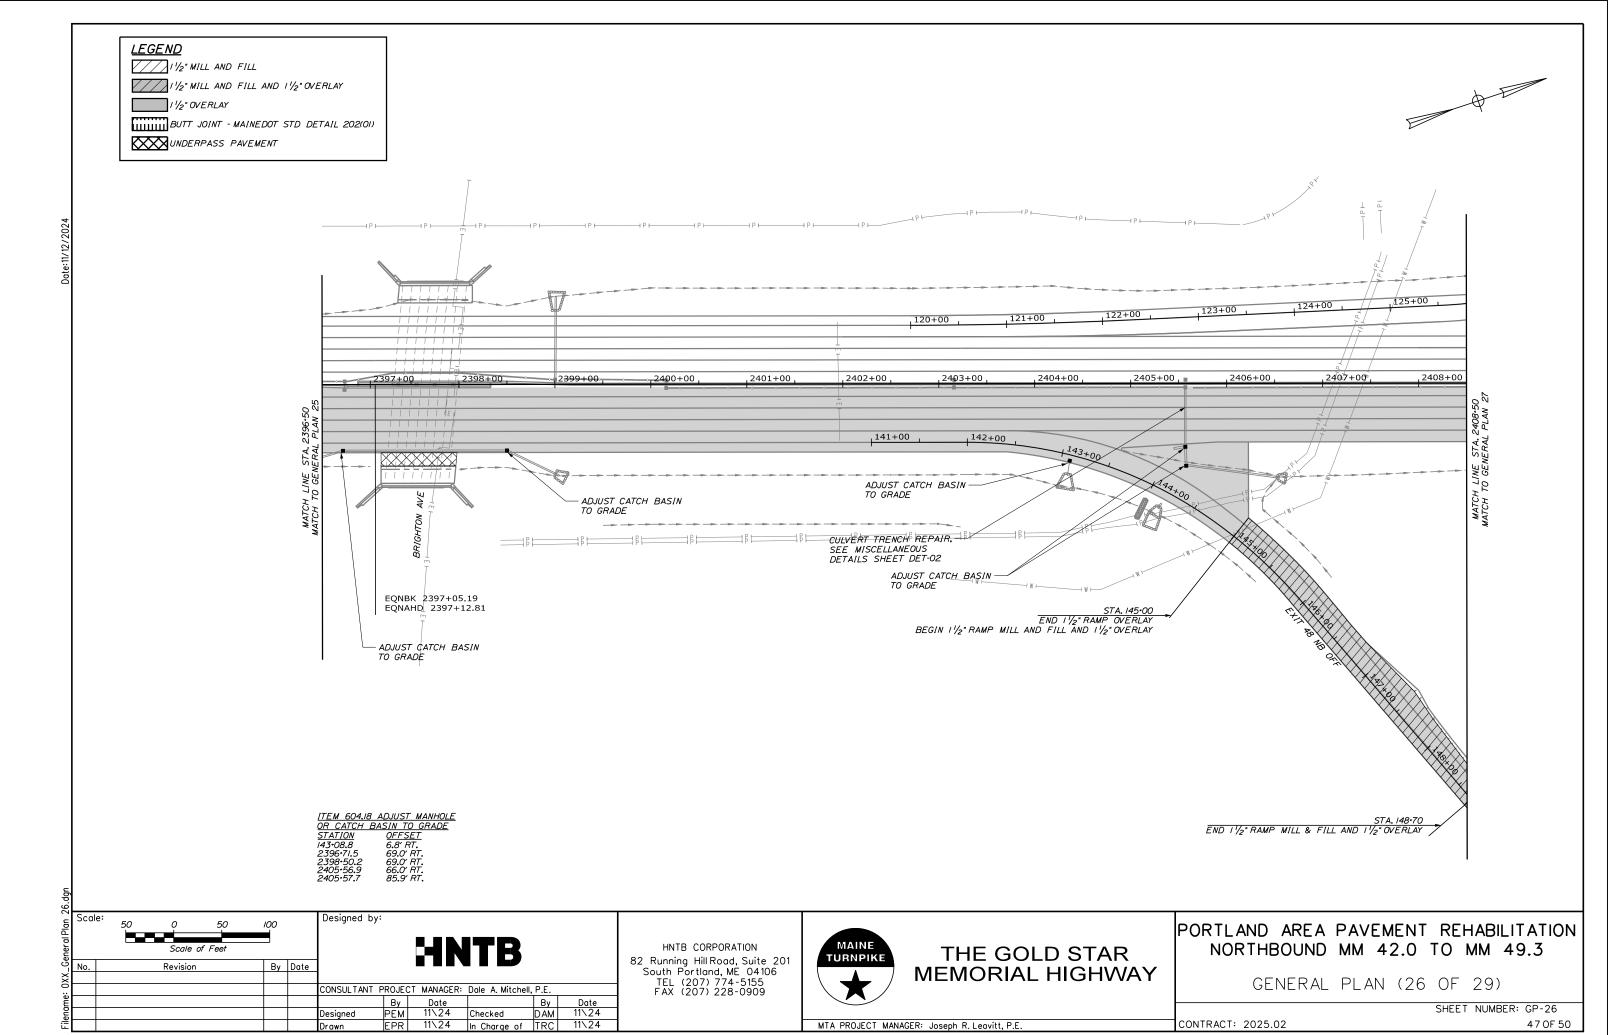

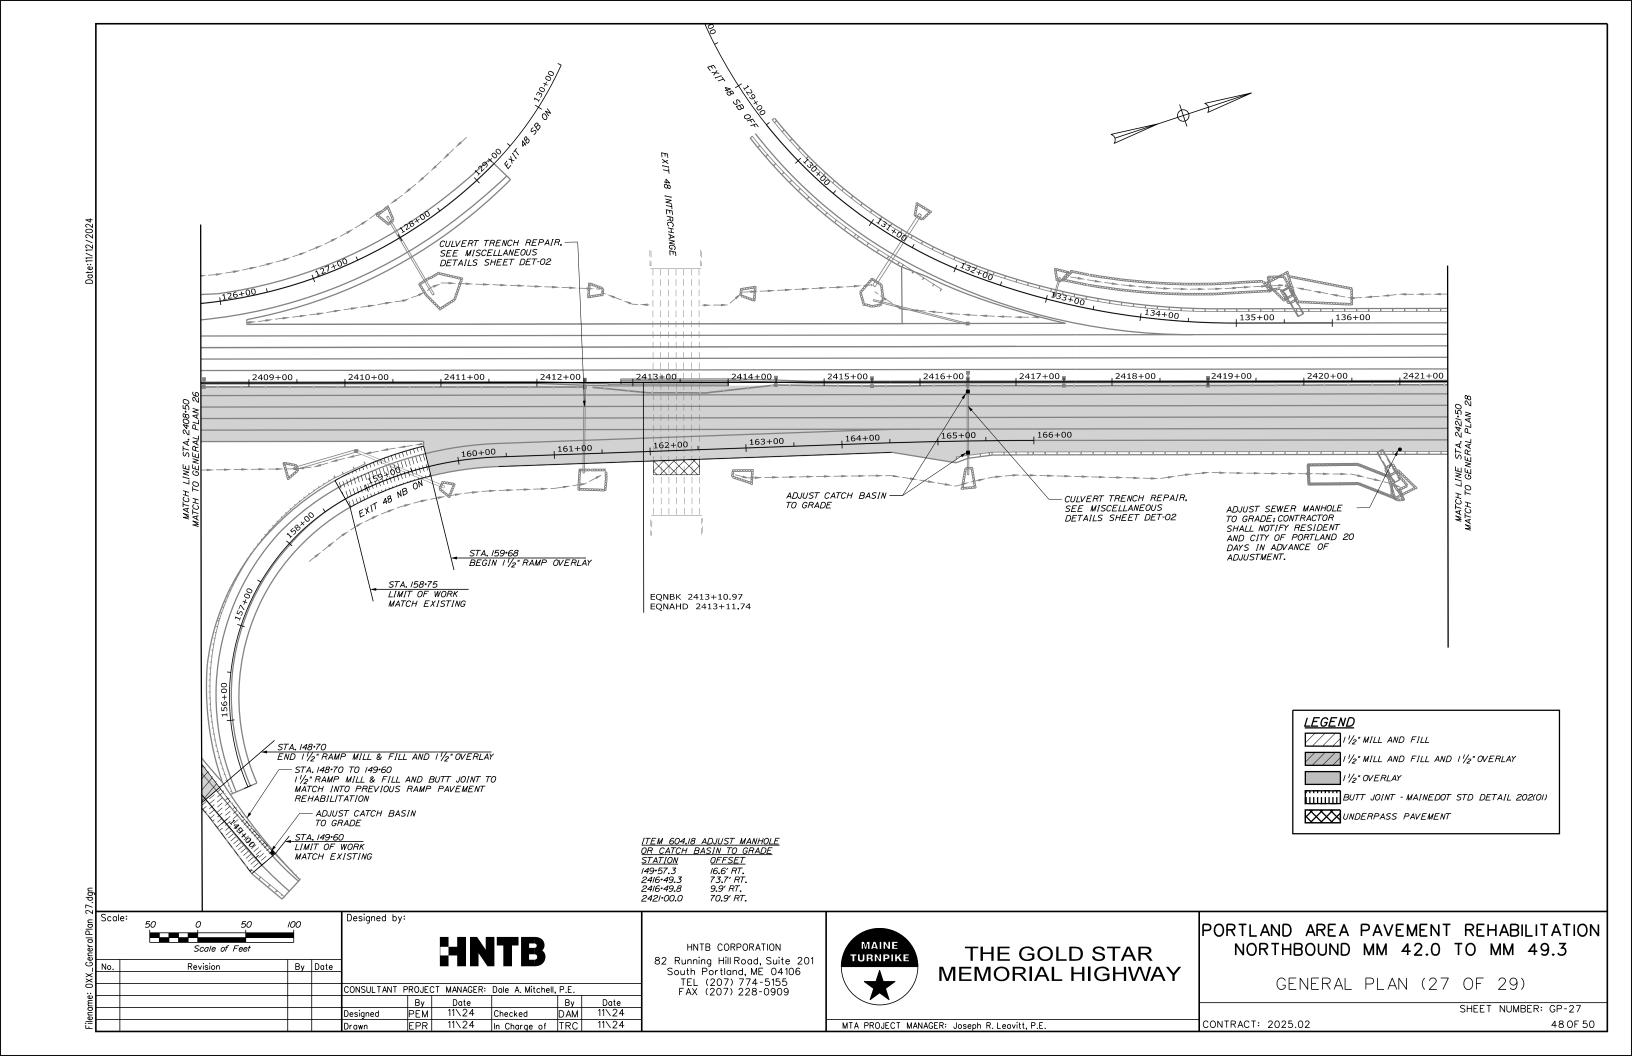


PORTLAND AREA PAVEMENT REHABILITATION

NORTHBOUND MM 42.0 TO MM 49.3

GENERAL PLAN (28 OF 29)

CONTRACT: 2025.02

SHEET NUMBER: GP-28

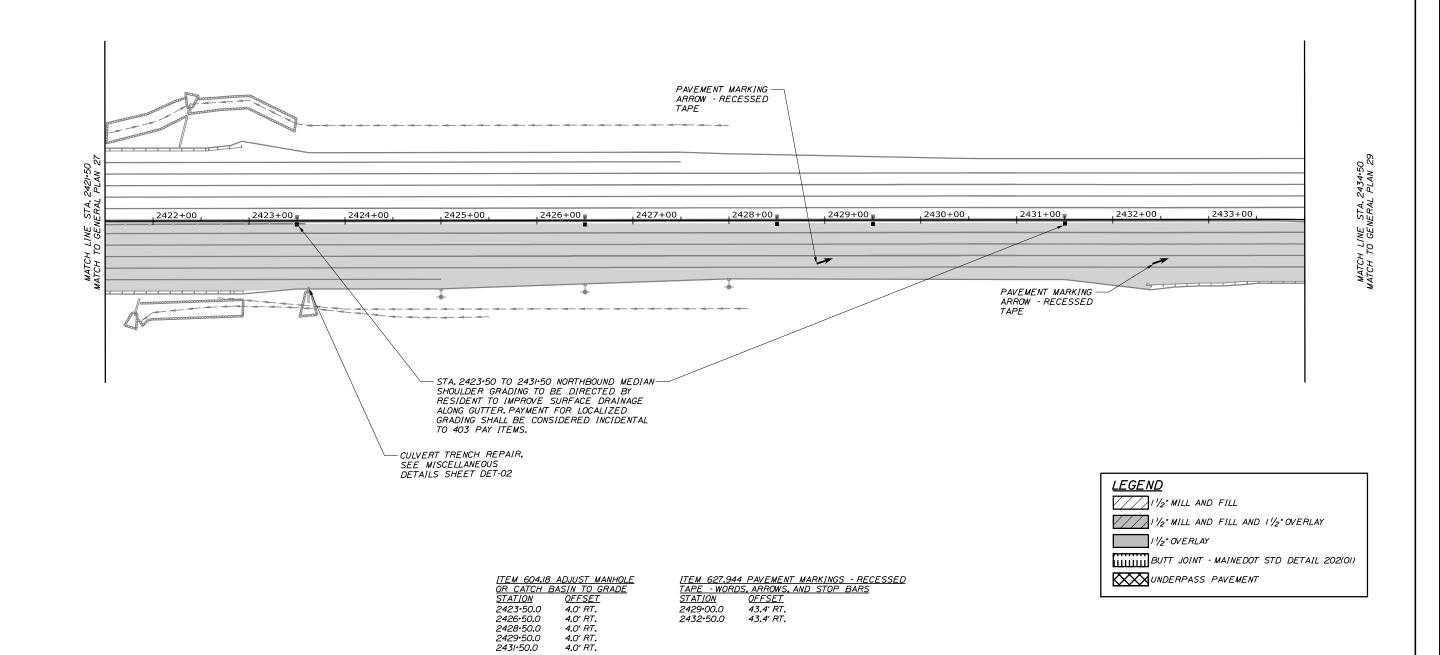

MAINE

TURNPIKE

MTA PROJECT MANAGER: Joseph R. Leavitt, P.E.

THE GOLD STAR

MEMORIAL HIGHWAY

HNTB CORPORATION

82 Running Hill Road, Suite 201 South Portland, ME 04106 TEL (207) 774-5155 FAX (207) 228-0909

name: OXX_General Plan 28.dg

Scale:

Scale of Feet


Revision

Designed by:

ONSULTANT PROJECT MANAGER: Dale A. Mitchell, P.E.

Ву

By Date

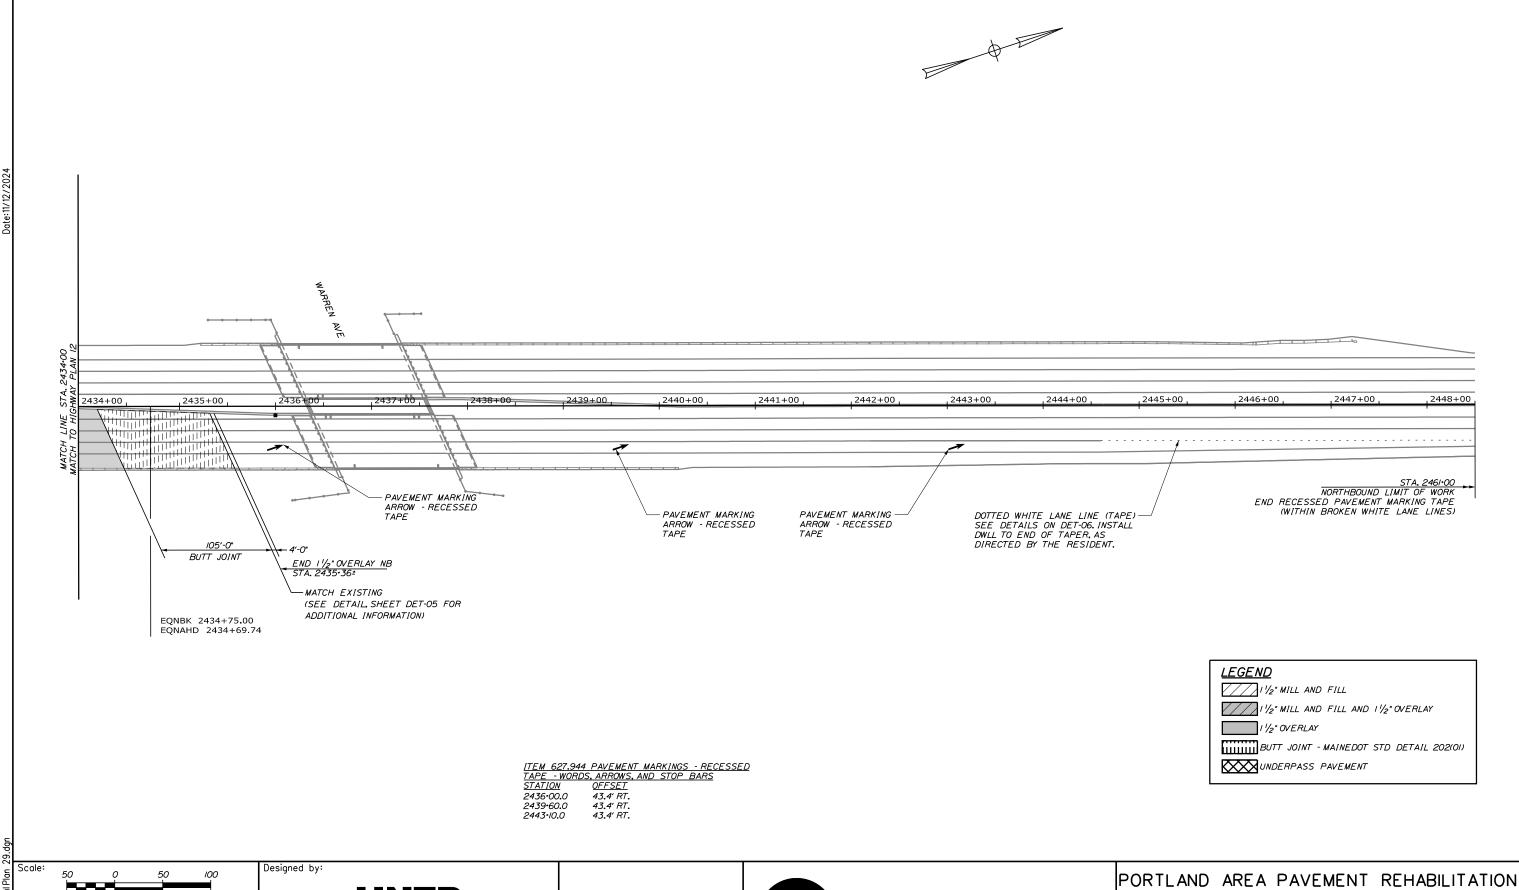

Scale of Feet By Date Revision CONSULTANT PROJECT MANAGER: Dale A. Mitchell, P.E. Ву DAM Designed 11\24 In Charge of TRC

HNTB CORPORATION 82 Running Hill Road, Suite 201 South Portland, ME 04106 TEL (207) 774-5155 FAX (207) 228-0909



THE GOLD STAR **MEMORIAL HIGHWAY**

NORTHBOUND MM 42.0 TO MM 49.3

GENERAL PLAN (29 OF 29)

SHEET NUMBER: GP-29

MTA PROJECT MANAGER: Joseph R. Leavitt, P.E.

CONTRACT: 2025.02