

KAREN S. DOYLE, MEMBER EX-OFFICIO

S. PETER MILLS, EXECUTIVE DIRECTOR

**CONTRACT 2018.14 KENNEBUNK AND GRAY MAINTENANCE GARAGE EXTENSIONS NEW HEATING SYSTEM CROSBY MAINTENANCE FACILITY** 

HNTB



**INDEX OF SHEETS** 

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DESCRIPTION

TITLE SHEET GENERAL NOTES

PLUMBING PLANS

MECHANICAL PLANS

SHEET NO.



**PORTLAND** ATLANTIC SCARBOROUGH BIDDEFORD KENNEBUNK WELLS OGUNQUIT SANFORD BERWICK\\

2 MAINTENANCE GARAGES

KENNEBUNK

SOUTH BERWICK PORTSMOUTH

**LOCATION MAP** 

ASCE 7 AMERICAN SOCIETY OF CIVIL ENGINEERS, MINIMUM DESIGN LOADS FOR BUILDINGS AND OTHER STRUCTURES, 2016

ACI 301 AMERICAN CONCRETE INSTITUTE SPECIFICATION FOR STRUCTURAL CONCRETE, 2016

AISC AMERICAN INSTITUTE OF STEEL CONSTRUCTION, 2017

ACI 318 AMERICAN CONCRETE INSTITUTE BUILDING CODE REQUIREMENTS FOR REINFORCED CONCRETE,

ASTM AMERICAN SOCIETY OF TESTING AND MATERIALS

NDS NATIONAL DESIGN SPECIFICATIONS FOR WOOD CONSTRUCTION BY NATIONAL FOREST PRODUCTS

EXISTING DIMENSIONS AND CONDITIONS ARE FOR REFERENCE ONLY. CONTRACTOR SHALL VERIFY ALL EXISTING CONSTRUCTION AND DIMENSIONS IN THE FIELD PRIOR TO CONSTRUCTION OR FABRICATION. ALL DISCREPANCIES SHALL BE REPORTED TO THE MAINE TURNPIKE AUTHORITY PRIOR TO COMMENCING WORK.

3. ALL MATERIALS STORED ON THE PROJECT SHALL BE PROTECTED FROM THE ELEMENTS BY BEING STORED INDOORS ABOVE GROUND LEVEL ON SUITABLE DUNNAGE.

ALL MATERIALS REQUIRED TO BE REMOVED AND REUSED SHALL BE MAINTAINED IN SERVICEABLE CONDITION, STORED IN A MOISTURE FREE ENVIRONMENT INDOORS, AND ABOVE THE GROUND LEVEL.

5. THE CONTRACTOR IS REQUIRED TO CALL DIG SAFE AT I-888-344-7233 AND DIG SMART AT 207-749-7231 AT LEAST 72 HOURS PRIOR TO START OF WORK.

6.THE CONTRACTOR SHALL NOTIFY THE RESIDENT 10 DAYS PRIOR TO CONSTRUCTION SO THE RESIDENT CAN ARRANGE FOR MAINE TURNPIKE UNDERGROUND UTILITY LOCATION. ALL PROPOSED SIGN LOCATIONS AND EXCAVATION LOCATIONS SHALL BE MARKED AT THE NOTIFICATION TIME, EXCAVATION WILL NOT BE PERMITTED UNTIL THE AUTHORITY HAS LOCATED AND MARKED ITS UNDERGROUND UTILITIES, OR NOTIFIED THE RESIDENT THERE ARE NO UNDERGROUND UTILITIES IN THE MARKED

7. THE AUTHORITY HAS PROGRAMMED TWO FIELD VISITS FOR MAINE TURNPIKE UTILITY COORDINATION ON THIS PROJECT. SHOULD THE CONTRACTOR NEED ADDITIONAL SIGN LOCATIONS AND/OR ADDITIONAL EXCAVATION LOCATIONS MARKED, OR SHOULD THE CONTRACTOR FAIL TO MAINTAIN THE AUTHORITY'S PREVIOUSLY ESTABLISHED DIG SAFE MARKS, THE AUTHORITY SHALL DEDUCT THE ADDED MARKING COSTS FROM THE CONTRACTOR'S PAYMENTS.

8. EXCAVATIONS ACCOMPLISHED AS PART OF THIS PROJECT SHALL BE PERFORMED IN ACCORDANCE WITH OSHA SUBPART P OF 29 CFR PART 1926.650-62 (CONSTRUCTION STANDARDS FOR EXCAVATIONS).

9. ALL DETAILS SHALL BE IN CONFORMANCE WITH MAINE DEPARTMENT OF TRANSPORTATION (MAINEDOT) STANDARD DETAILS HIGHWAY AND BRIDGES 2014 LATEST REVISIONS AND MAINEDOT BEST MANAGEMENT PRACTICES FOR EROSION AND SEDIMENT CONTROL LATEST REVISION UNLESS OTHERWISE INCLUDED IN THESE PLANS.

10. THERE ARE NO PERMANENT OR TEMPORARY EASEMENTS ASSOCIATED WITH THIS PROJECT. ALL WORK SHALL BE COMPLETED WITHIN THE EXISTING RIGHT OF WAY.

II.THE CONTRACTOR SHALL SUBMIT THE PROPOSED STAGING AREA(S)TO THE RESIDENT PRIOR TO STARTING WORK.

*12.COPIES OF THE AS-BUILT PLANS ARE NOT AVAILABLE.CONTRACTOR TO VERIFY ALL ASSUMED* DIMENSIONS.

13. CONTRACTOR SHALL PROVIDE AS-BUILT DRAWINGS AFTER CONSTRUCTION IS COMPLETED.

#### GENERAL SCOPE OF WORK:

I. CONSTRUCT A BUILDING EXTENSION OFF THE BACK OF THE BUILDING OF (2)8-BAY MAINTENANCE GARAGES AT THE KENNEBUNK MAINE TURNPIKE AUTHORITY MAINTENANCE YARD AND (1)8-BAY MAINTENANCE GARAGE AT THE GRAY MAINE TURNPIKE AUTHORITY MAINTENANCE YARD.

2. THE NEW BUILDING CONSTRUCTION SHALL INCLUDE: TEMPORARY SUPPORT, SLAB-ON-GRADE, STUD WALL, ROOF RAFTERS, SHEATHING, COLUMNS AND LVL HEADER.

3. REMOVE ALL EXISTING SIDING AND REPLACE WITH NEW PREFORMED METAL SIDING.

4. REMOVE ALL EXISTING ROOF SHINGLES AND REPLACE WITH NEW PREFORMED METAL ROOFING.

5. ADD LED LIGHTS IN EACH BAY OF GARAGE.

Revision

No.

6. REINSTALL ELECTRICAL CONDUITS AND ADD OUTLETS AS SHOWN ON THE PLANS.

7. ADD HVAC AT (2) KENNEBUNK GARAGES, (1) GRAY GARAGE AND (1) CROSBY GARAGE AS SHOWN IN THE

#### FOUNDATION NOTES:

I. ALL FILL USED TO SUPPORT SLABS-ON-GRADE SHALL BE WELL-GRADED I" CRUSHED GRAVEL.

2. STRUCTURAL SLABS SHALL BE CONSTRUCTED ON A MINIMUM 12"THICK LAYER OF STRUCTURAL FILL SOIL MEETING THE REQUIREMENTS IN THE CONTRACT SPECIFICATIONS

3. PRESUMED ALLOWABLE SOIL BEARING PRESSURE USED IN DESIGN = 2,000 PSF.
THE CONTRACTOR SHALL NOTIFY THE DEPARTMENT IF ANY UNSUITABLE SOILS ARE ENCOUNTERED PRIOR TO PLACING FOUNDATIONS 2 FT OF UNSUITABLE SOIL ASSUMED AT GRAY WILL NEED TO BE EXCAVATED AND REPLACED.

4. SLABS-ON-GRADE SHALL REACH THEIR FULL DESIGN STRENGTH PRIOR TO LOADING. THE CONTRACTOR SHALL PROVIDE TEMPORARY SHORING/BRACING AS NECESSARY TO PLACE STRUCTURAL FILL AND CONSTRUCT SLAB-ON-GRADE.

5. CARE SHALL BE TAKEN DURING EXCAVATION NOT TO DISRUPT EXISTING UTILITIES AND DRAINAGE. IF EXISTING UTILITIES ARE DAMAGED DURING EXCAVATION OR SLAB CONSTRUCTION, THE CONTRACTOR SHALL REPLACE OR REPAIR DAMAGED UTILITIES AT NO ADDITIONAL COST TO THE AUTHORITY.

6. CONTRACTOR SHALL BE RESPONSIBLE FOR THE SHORING AND BRACING OF EXISTING STRUCTURES DURING EXCAVATION, BACKFILLING AND CONSTRUCTION. CONTRACTOR SHALL SLOPE EXCAVATIONS TO ACHIEVE SOIL STABILITY.

### CONCRETE REINFORCING NOTES:

I. USE DEFORMED EPOXY COATED STEEL REINFORCING BARS, GRADE 60 IN CONFORMANCE WITH ASTM A775/ A 775M. REINFORCEMENT SHALL BE PLACED AND SUPPORTED PRIOR TO CONCRETE PLACEMENT, AND SHALL BE SECURED AGAINST DISPLACEMENT.

2. THE CONTRACTOR SHALL SUBMIT REINFORCING SHOP DRAWINGS TO THE MAINE TURNPIKE AUTHORITY FOR REVIEW AND ACCEPTANCE PRIOR TO COMMENCING FABRICATION, SHOP DRAWINGS SHALL SHOW REINFORCING STEEL PLACEMENT DETAILS AND SECTIONS.

3. MINIMUM CONCRETE COVER FOR REINFORCEMENT: CONCRETE CAST AGAINST AND PERMANENTLY EXPOSED TO EARTH CONCRETE EXPOSED TO EARTH OR WEATHER

CONCRETE NOT EXPOSED TO EARTH OR WEATHER IN SLABS AND WALLS CONCRETE NOT EXPOSED TO EARTH OR WEATHER IN CURBS

4. CONTINUOUS REINFORCEMENT SHALL BE TENSION LAP SPLICED PER LAP SLICE LENGTH TABLE, 11.N.O.

LAP SPLICE LEI	NGT	H 7	ABL	E			
BAR SIZE	#3	#4	#5	#6	#7	#8	#5
MIN LAP SPLICE (INCHES)	19	19	24	29	36	47	74

5. REINFORCEMENT HOOKS SHALL CONFORM TO STANDARD HOOKS ACCORDING TO ACI 318.

6. WELDING OF REINFORCING IS NOT PERMITTED, U.N.O.

### CONCRETE NOTES:

I. ALL CONCRETE WORK, INCLUDING MATERIAL SELECTION, ADMIXTURES, MIXING, AND PLACEMENT OF CONCRETE SHALL BE IN CONFORMANCE WITH APPLICABLE BUILDING CODES IN ADDITION, REFERENCE THE CAST-IN-PLACE CONCRETE SPECIFICATIONS.

2. CONTRACTOR SHALL NOT PLACE CONCRETE ON FROZEN GROUND OR IN WATER. ADEQUATE
EQUIPMENT SHALL BE PROVIDED FOR HEATING CONCRETE MATERIALS AND PROTECTING CONCRETE DURING NEAR-FREEZING, OR FREEZING WEATHER. REFERENCE SECTION 502.08 COLD WEATHER CONCRETE OF "STATE OF MAINE, DEPARTMENT OF TRANSPIRATION STANDARD SPECIFICATIONS, REVISION OF NOVEMBER 2014" FOR REQUIREMENTS FOR COLD WEATHER CURING

3. CONTRACTOR SHALL SUBMIT PROPOSED CONCRETE MIX DESIGN AND LABORATORY TESTS OF FABRICATED CYLINDERS VERIFYING CONCRETE STRENGTH OR PERFORMANCE HISTORY OF MIX TO THE MAINE TURNPIKE AUTHORITY FOR ACCEPTANCE PRIOR TO PLACEMENT OF CONCRETE CONCRETE USED. ON SITE SHALL BE FIELD TESTED BY THE MAINE TURNPIKE AUTHORITY. FIELD TESTING INFORMATION SHALL INDICATE SLUMP, AIR CONTENT, AND TEMPERATURE. COMPRESSION TEST 2 CYLINDERS AT 7 DAYS AND TWO AT 28 DAYS. HOLD AN ADDITIONAL CYLINDER FOR A 56 DAY BREAK IF NECESSARY. PROVIDE A SET OF FIVE CYLINDERS FOR EACH PLACEMENT AND PER 50 CUBIC YARDS OF CONCRETE PLACED. THE MAINE TURNPIKE AUTHORITY SHALL PROVIDE ALL CONCRETE TESTING.

4. CONCRETE DESIGN STRENGTH SHALL BE A MINIMUM OF 4,000 PSI.

5. THREADED RODS SHALL CONFORM TO ASTM FI554. THREADED RODS SHALL HAVE HEAVY HEX NUTS AND LOCK WASHERS. WET STICKING THREADED ROD SHALL NOT BE ACCEPTABLE.

6. CHAMFER ALL EXPOSED CONCRETE EDGES 3/4" UNLESS OTHERWISE NOTED.

#### WOOD NOTES:

I. ALL LUMBER SHALL BE VISUALLY GRADED AN STAMPED WITH GRADE DESIGNATION, SPECS AND ADDITIONAL INSPECTION INFORMATION, U.N.O.

2. CARE SHALL BE TAKEN TO PROTECT TIMBER FROM WEATHER AND DAMPNESS. DO NOT STACK IN SUCH A WAY AS TO CAUSE WARPING OR PREVENT ADEQUATE AIR CIRCULATION. WARPED TIMBER MAY BE REJECTED.

3. WOOD GRADES AND SPECIES:

A. SPRUCE-PINE-FIR NO.2 OR BETTER FOR TYPICAL LUMBER (STUDS, RAFTERS, ETC.) U.N.O. B. SOUTHERN YELLOW PINE FOR EXTERIOR EXPOSURE APPLICATIONS AND WHERE SHOWN ON

DRAWINGS AS PRESERVATIVE PRESSURE TREATED LUMBER (PT OR PPT). C. WHERE NOTED LVL ON DRAWINGS PROVIDE VERSA LAM 3100 BY BOISE CASCADE OR EQUIVALENT,

WHICH HAS THE FOLLOWING MINIMUM ALLOWABLE STRESSES: Fb = 3,100 PSI Fc = 2,510 PSI (PARALLEL TO GRAIN Fc = 750 PSI (PERPENDICULAR TO GRAIN)

Ft = 1,555 PPSI E = 2,000,000 PSI

4. STRUCTURAL LUMBER SHALL HAVE A MAXIMUM MOISTURE CONTENT OF 19%

5. PROVIDE PRESSURE TREATED LUMBER FOR ALL LUMBER IN CONTACT WITH CONCRETE.ALL CONNECTORS THAT ARE IN CONTACT WITH PRESSURE TREATED LUMBER SHALL BE HOT-DIP GALVANIZED, U.N.O.

6. NOMINAL SIZES ARE TYPICALLY REFERENCED ON THE DRAWINGS. PROVIDE ACTUAL SIZES AS SET FORTH BY U.S. DEPARTMENT OF COMMERCE VOLUNTARY PRODUCT STANDARD PS20-99.

7. ALL PLYWOOD SHALL BE APA RATED SHEATHING.

8. PROVIDE FULL DEPTH BLOCKING AT ENDS AND INTERIOR SUPPORTS OF ALL RAFTERS WHERE RAFTERS FRAME OVER SUPPORTS. PROVIDE FULL DEPTH SOLID BLOCKING FOR EACH 8'-0" SPAN FOR ALL RAFTERS.

9. ALL FASTENERS AND WASHERS SHALL BE HOT-DIPED GALVANIZED, U.N.O.

IO. ALIGN COLUMNS SUCH THAT COLUMNS BEAR CONTINUOUSLY TO FOUNDATION SUPPORT.

II. PROVIDE HORIZONTAL BLOCKING FOR ALL LOAD BEARING WALLS AT 4'-0" O.C. VERTICAL, MAXIMUM.

### ESTIMATED QUANTITIES

ITEM NO.	ITEM DESCRIPTION	UNIT	QTY
815.01	BUILDINGS - KENNEBUNK GARAGE #1 ADDITION	EΑ	/
8/5.02	BUILDINGS - KENNEBUNK GARAGE #2 ADDITION	EΑ	/
8/5.03	BUILDINGS - GRAY GARAGE ADDITION	EΑ	/
8/5.04	BUILDINGS - CROSBY GARAGE HVAC UPDATE	EΑ	/

#### LIST OF ABBREVIATIONS

ARUT. - ARUTMENT ADDL. - ADDITIONAL ALT. - ALTERNATE APPROX. - APPROXIMATELY BOT. - BOTTOM BRG. - BEARING CL. - CLEAR

OF TRANSPORTATION

**Q** - CENTERLINE CONC. - CONCRETE CONSTR. - CONSTRUCTION

DEMO. - DEMOLITION DIA. - DIAMETER EA. - EACH

EB - EASTBOUND E.F. - EACH FACE EL. - ELEVATION EQ. - EQUAL

EXIST. - EXISTING EXP. - EXPANSION F.F. - FAR FACE

JT. - JOINT MAX. - MAXIMUM MAINFOOT - MAINE DEPARTMENT MIN. - MINIMUM

MTA - MAINE TURNPIKE AUTHORITY NB - NORTHBOUND

N.F. - NEAR FACE N.T.S. - NOT TO SCALE PED. - PEDESTAL

PGL - PROFILE GRADE LINE P - PLATE

PROP. - PROPOSED P.S.I. - POUNDS per SQUARE INCH

RDWY. - ROADWAY SHLDR. - SHOULDER

SB - SOUTHBOUND SP. - SPACES STA. - STATION T.&B. - TOP & BOTTOM TPKE. - TURNPIKE

U.O.N. - UNLESS OTHERWISE NOTED

VERT. - VERTICAL WB - WESTBOUND W.P. - WORKING POINT

TYP. - TYPICAL

Scale Designed by: MAINE HNTB CORPORATION

> By Date CONSULTANT PROJECT MANAGER: BRUCE MUNGER, PE Bv Checked Designed 11\17 In Charge of RAI

340 County Road, Suite 6-C Westbrook, ME 04092 TEL (207) 774-5155 FAX (207) 228-0909



THE GOLD STAR MEMORIAL HIGHWAY MAINTENANCE GARAGE EXTENSIONS

GENERAL NOTES

SHEET NUMBER: S1


MTA PROJECT MANAGER: BRIAN TADDEO, PE

3 INCHES


2 INCHES

11/2 INCHES

11/2 INCHES

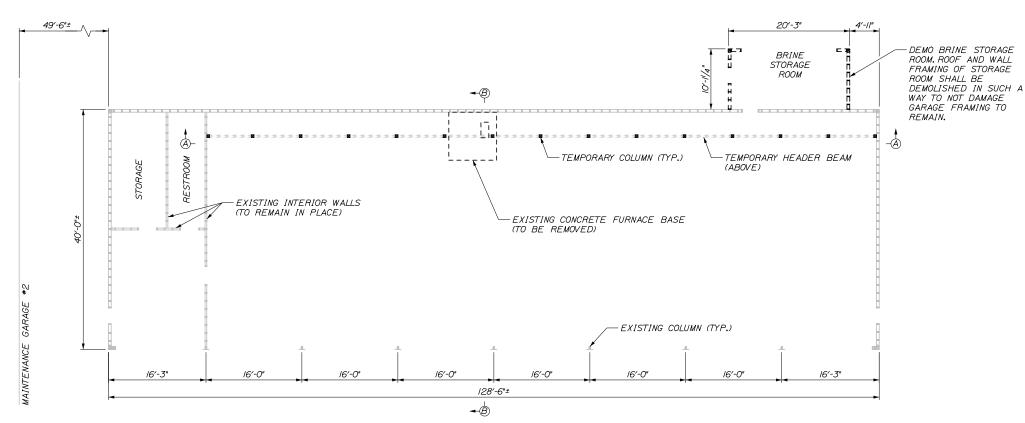

EXISTING FRAMING PLAN AND TEMPORARY SUPPORT PLAN VIEW SCALE: 1/8" = 1-'0"

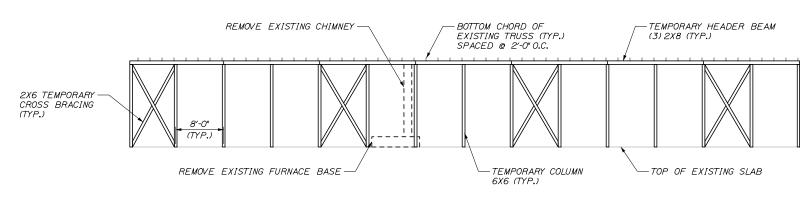

SECTION A-A

SECTION B-B SCALE: 1/8" = 1-'0" EXISITNG CHIMNEY NOT SHOWN FOR CLARITY

REMOVE ALL EXISTING KNEE

BRACE BELOW BOTTOM CHORD OF TRUSS THIS SIDE ONLY

(SPACED @ 8'-0" O.C. ON REAR

GENERAL PROCEDURE

WITH THE SPECIFICATIONS.

CONSTRUCTION AND ROOF PITCH.

9. REMOVE TEMPORARY SUPPORT.

2X6 STRUT BETWEEN TOP AND-BOTTOM CHORD OF TRUSS

WALL)

REMOVE EXISTING FURNACE BASE -

I. REMOVE SHEATHING ON WALLS AND BELOW TRUSS TO ALLOW ACCESS TO STRUCTURAL COMPONENTS. ALL SHEATHING TO BE REMOVED TO ACCESS THE WORK SHALL BE REMOVED CAREFULLY AS TO PREVENT DAMAGE TO THE SHEATHING. SHEATHING ON THE EXISTING WALLS TO REMAIN SHALL THEN BE STORED IN A SUITABLE LOCATION AND REINSTALLED USING WOOD SCREWS. ANY SHEATHING LOST

OR DAMAGED DURING STORAGE TO BE REINSTALLED SHALL BE REPLACED IN KIND WITH NEW MATERIAL AT NO ADDITIONAL COST TO THE AUTHORITY.

2. REMOVE EXISTING CHIMNEY, CONCRETE FURNACE BASE, FURNACE, AND DUCT WORK.

OFFSET TO STUDS ACCORDING TO THE DETAILS ON THE STRUCTURAL PLANS. REMOVE EXISTING KNEE BRACE TO THE BOTTOM OF THE TRUSS AT LOCATIONS SHOWN ON

THE STRUCTURAL PLANS. CEILING SHEATHING SHALL BE PATCHED AT REMOVED KNEE

4. INSTALL TEMPORARY HEADER BEAM TIGHTLY BENEATH EXISTING TRUSSES.
INSTALL TEMPORARY STRUTS BETWEEN BOTTOM AND TOP CHORDS OF THE EXISTING TRUSS AS SHOWN ON THE STRUCTURAL PLANS, ALL MODIFICATION WORK COMPLETED

WHILE THE TEMPORARY SUPPORT IS IN PLACE SHALL BE COMPLETED WITH ONLY STRUCTURAL DEAD LOAD ON THE ROOF. DO NOT PERFORM THIS WORK WHEN THE ROOF IS SUBJECT TO SNOW OR LIVE LOAD CONDITIONS.

6. LAYOUT AND PLACE NEW CONCRETE SLAB-ON-GRADE AND CURB TO MATCH EXISTING FLOOR. SLOPE NEW FLOOR TO MATCH EXISTING DRAINAGE.

8. CONSTRUCT NEW BACKWALL AND ROOF. TIE INTO AND MATCH EXISTING WALL

IO. REMOVE ALL EXISTING SHINGLES, INSPECT ROOF SHEATHING, REPLACE ANY ROTTED SHEATHING OR DAMAGED WATERPROOFING, INSTALL NEW PREFORMED METAL ROOFING ON EXISTING AND NEW ROOF. NEW UNDERLAYMENT SHALL BE INSTALLED AT

II. REMOVE ALL EXISTING SIDING, INSPECT WALL SHEATHING, REPLACE ANY ROTTED SHEATHING. REPLACEMENT OF ROTTED SHEATHING SHALL BE INCIDENTAL TO

12. INSTALL ELECTRICAL CONDUITS AND LED LIGHTS AT LOCATIONS SHOWN IN THE

13. INSTALL NEW FURNACE UNITS AND DUCT WORK AS SHOWN ON THE MECHANICAL

BUILDING PAY ITEM. INSTALL NEW PREFORMED METAL SIDING ON EXISTING AND NEW

ALL LOCATIONS IN ACCORDANCE WITH THE SPECIFICATIONS.

PLANS AND INSTALL DIRECT VENT OUT THE PROPOSED BACKWALL.

5. REMOVE EXISTING BACKWALL, CURB AND PORTION OF THE ROOF AS SHOWN IN THE STRUCTURAL PLANS TO CONSTRUCT GARAGE EXPANSION. PORTIONS OF THE BACK WALL, CURB, AND ROOF THAT ARE REMOVED SHALL BE DISPOSED OF IN ACCORDANCE

7. INSTALL NEW COLUMNS AND HEADER BEAMS ACCORDING TO THE DETAILS IN THE STRUCTURAL PLANS. PAINT NEW COLUMNS SAFETY ORANGE TO A HEIGHT OF 8' TO

3. LOCATE EXISTING STUDS IN BACK WALL AND INSTALL TEMPORARY COLUMNS

### NOTES:

I. SEE SHEET S8 FOR TEMPORARY COLUMN AND HEADER DETAILS.

Scale: Designed by: No. Revision By Date CONSULTANT PROJECT MANAGER: BRUCE MUNGER, PE Checked Designed 11\17 In Charge of RAL

HNTB CORPORATION 340 County Road, Suite 6-C Westbrook, ME 04092 TEL (207) 774-5155 FAX (207) 228-0909



THE GOLD STAR **MEMORIAL HIGHWAY** 

TEMPORARY SUPPORT DETAILS

(KENNEBUNK #1)

TEMPORARY

EXISTING

BACKWALL

COLUMN


HEADER BEAM


SHEET NUMBER: S2

MTA PROJECT MANAGER: BRIAN TADDEO, PE

CONTRACT:2018.14

MAINTENANCE GARAGE EXTENSIONS

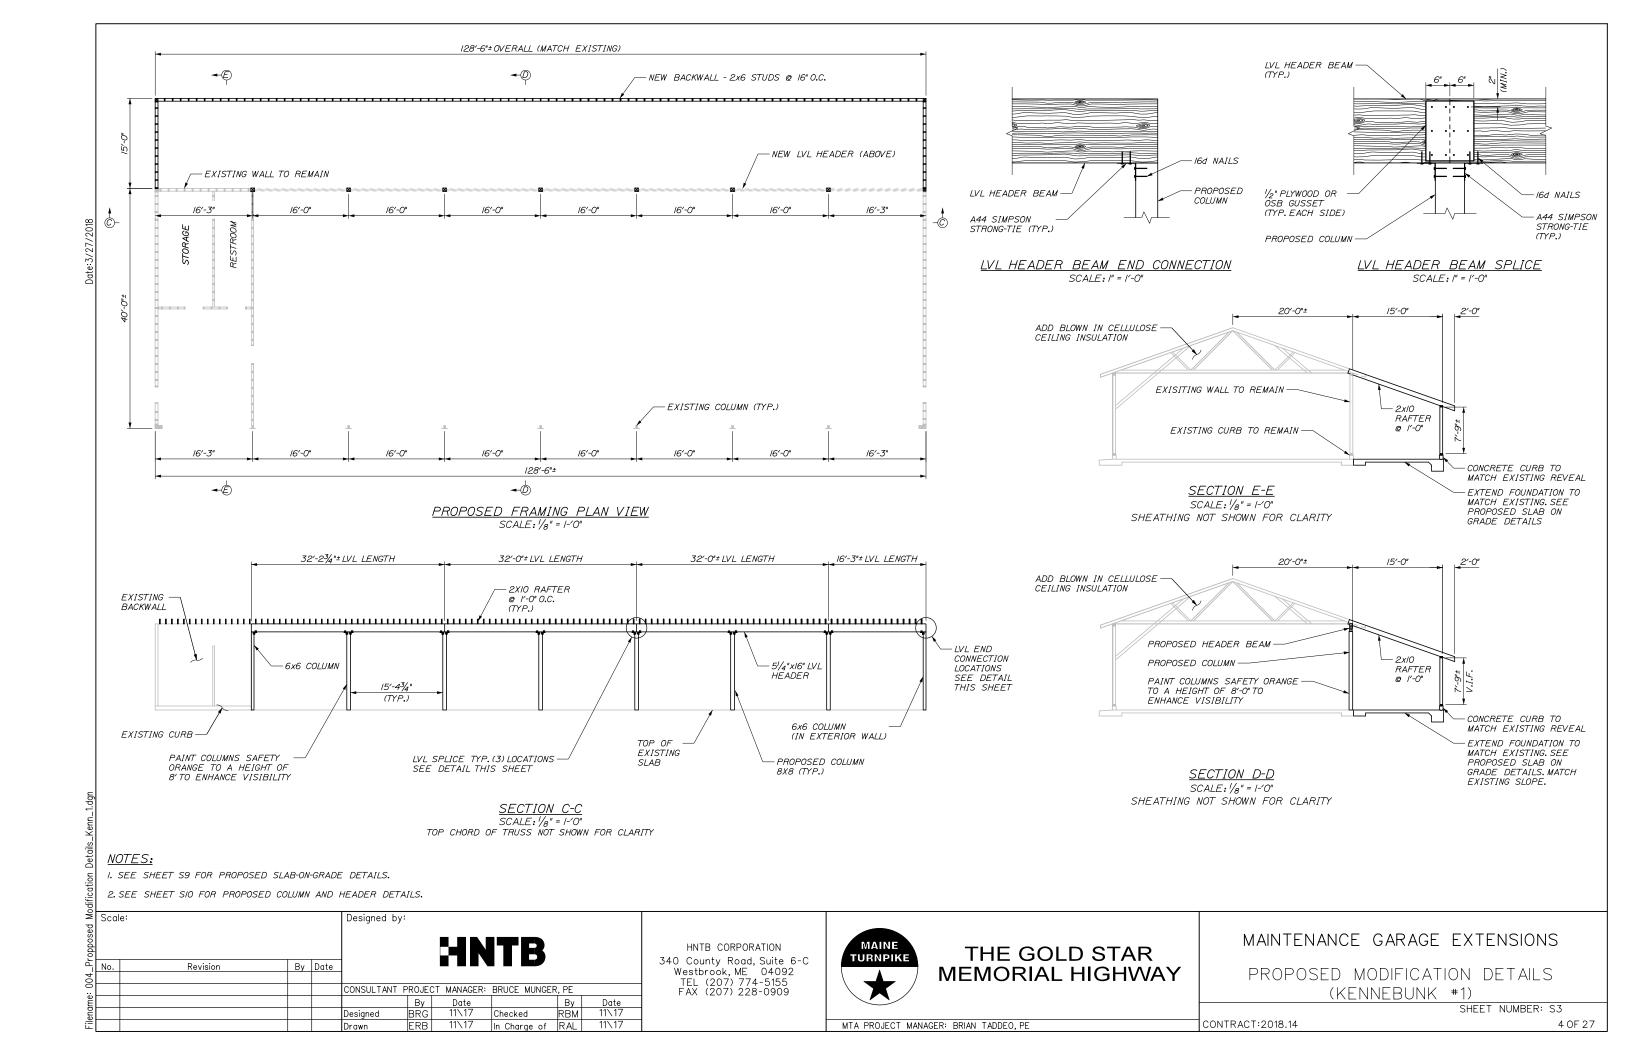

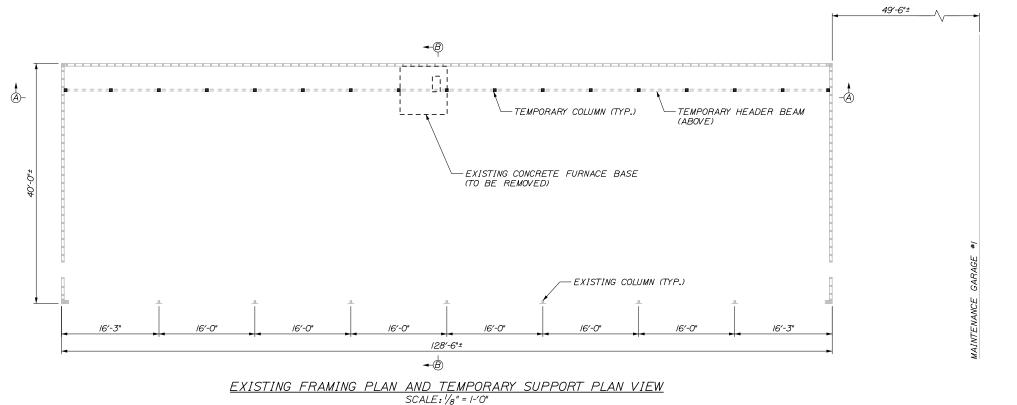

REMOVE EXISTING CHIMNEY BOTTOM CHORD OF TEMPORARY HEADER BEAM EXISTING TRUSS (TYP.) (3) 2X8 (TYP.) SPACED @ 2'-0' O.C. 2X6 TEMPORARY CROSS BRACING (TYP.) TEMPORARY COLUMN REMOVE EXISTING FURNACE BASE TOP OF EXISTING SLAB 6X6 (TYP.)

> SECTION A-A SCALE: 1/8" = 1-'0"

NOTES:

I. SEE SHEET S8 FOR TEMPORARY COLUMN AND HEADER DETAILS.

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### THE GOLD STAR **MEMORIAL HIGHWAY**

TEMPORARY SUPPORT DETAILS

(KENNEBUNK #2)

SHEET NUMBER: S4

MTA PROJECT MANAGER: BRIAN TADDEO, PE

I. REMOVE SHEATHING ON WALLS AND BELOW TRUSS TO ALLOW ACCESS TO STRUCTURAL COMPONENTS. ALL SHEATHING TO BE REMOVED TO ACCESS THE WORK SHALL BE REMOVED CAREFULLY AS TO PREVENT DAMAGE TO THE SHEATHING. SHEATHING ON THE EXISTING WALLS TO REMAIN SHALL THEN BE STORED IN A SUITABLE LOCATION AND REINSTALLED USING WOOD SCREWS. ANY SHEATHING LOST OR DAMAGED DURING STORAGE TO BE REINSTALLED SHALL BE REPLACED IN KIND WITH NEW MATERIAL AT NO ADDITIONAL COST TO THE AUTHORITY.

2. REMOVE EXISTING CHIMNEY, CONCRETE FURNACE BASE, FURNACE, AND DUCT WORK.

3. LOCATE EXISTING STUDS IN BACK WALL AND INSTALL TEMPORARY COLUMNS OFFSET TO STUDS ACCORDING TO THE DETAILS ON THE STRUCTURAL PLANS. REMOVE EXISTING KNEE BRACE TO THE BOTTOM OF THE TRUSS AT LOCATIONS SHOWN ON THE STRUCTURAL PLANS. CEILING SHEATHING SHALL BE PATCHED AT REMOVED KNEE

4. INSTALL TEMPORARY HEADER BEAM TIGHTLY BENEATH EXISTING TRUSSES.
INSTALL TEMPORARY STRUTS BETWEEN BOTTOM AND TOP CHORDS OF THE EXISTING TRUSS AS SHOWN ON THE STRUCTURAL PLANS, ALL MODIFICATION WORK COMPLETED WHILE THE TEMPORARY SUPPORT IS IN PLACE SHALL BE COMPLETED WITH ONLY STRUCTURAL DEAD LOAD ON THE ROOF. DO NOT PERFORM THIS WORK WHEN THE ROOF IS SUBJECT TO SNOW OR LIVE LOAD CONDITIONS.

5. REMOVE EXISTING BACKWALL, CURB AND PORTION OF THE ROOF AS SHOWN IN THE STRUCTURAL PLANS TO CONSTRUCT GARAGE EXPANSION. PORTIONS OF THE BACK WALL, CURB, AND ROOF THAT ARE REMOVED SHALL BE DISPOSED OF IN ACCORDANCE WITH THE SPECIFICATIONS.

6. LAYOUT AND PLACE NEW CONCRETE SLAB-ON-GRADE AND CURB TO MATCH EXISTING FLOOR. SLOPE NEW FLOOR TO MATCH EXISTING DRAINAGE.

7. INSTALL NEW COLUMNS AND HEADER BEAMS ACCORDING TO THE DETAILS IN THE STRUCTURAL PLANS. PAINT NEW COLUMNS SAFETY ORANGE TO A HEIGHT OF 8' TO

8. CONSTRUCT NEW BACKWALL AND ROOF. TIE INTO AND MATCH EXISTING WALL CONSTRUCTION AND ROOF PITCH.

9. REMOVE TEMPORARY SUPPORT.

2X6 STRUT BETWEEN TOP AND-

GENERAL PROCEDURE

IO. REMOVE ALL EXISTING SHINGLES, INSPECT ROOF SHEATHING, REPLACE ANY ROTTED SHEATHING OR DAMAGED WATERPROOFING, INSTALL NEW PREFORMED METAL ROOFING ON EXISTING AND NEW ROOF. NEW UNDERLAYMENT SHALL BE INSTALLED AT ALL LOCATIONS IN ACCORDANCE WITH THE SPECIFICATIONS.

II. REMOVE ALL EXISTING SIDING, INSPECT WALL SHEATHING, REPLACE ANY ROTTED SHEATHING. REPLACEMENT OF ROTTED SHEATHING SHALL BE INCIDENTAL TO BUILDING PAY ITEM. INSTALL NEW PREFORMED METAL SIDING ON EXISTING AND NEW

12. INSTALL ELECTRICAL CONDUITS AND LED LIGHTS AT LOCATIONS SHOWN IN THE

13. INSTALL NEW FURNACE UNITS AND DUCT WORK AS SHOWN ON THE MECHANICAL PLANS AND INSTALL DIRECT VENT OUT THE PROPOSED BACKWALL.


BOTTOM CHORD OF TRUSS TEMPORARY REMOVE ALL EXISTING KNEE HEADER BEAM BRACE BELOW BOTTOM CHORD OF TRUSS THIS SIDE ONLY EXISTING (SPACED @ 8'-0" O.C. ON REAR BACKWALL WALL) TEMPORARY COLUMN REMOVE EXISTING FURNACE BASE -


SECTION B-B

SCALE: 1/8" = 1-'0"


EXISITNG CHIMNEY NOT SHOWN FOR CLARITY

MAINTENANCE GARAGE EXTENSIONS

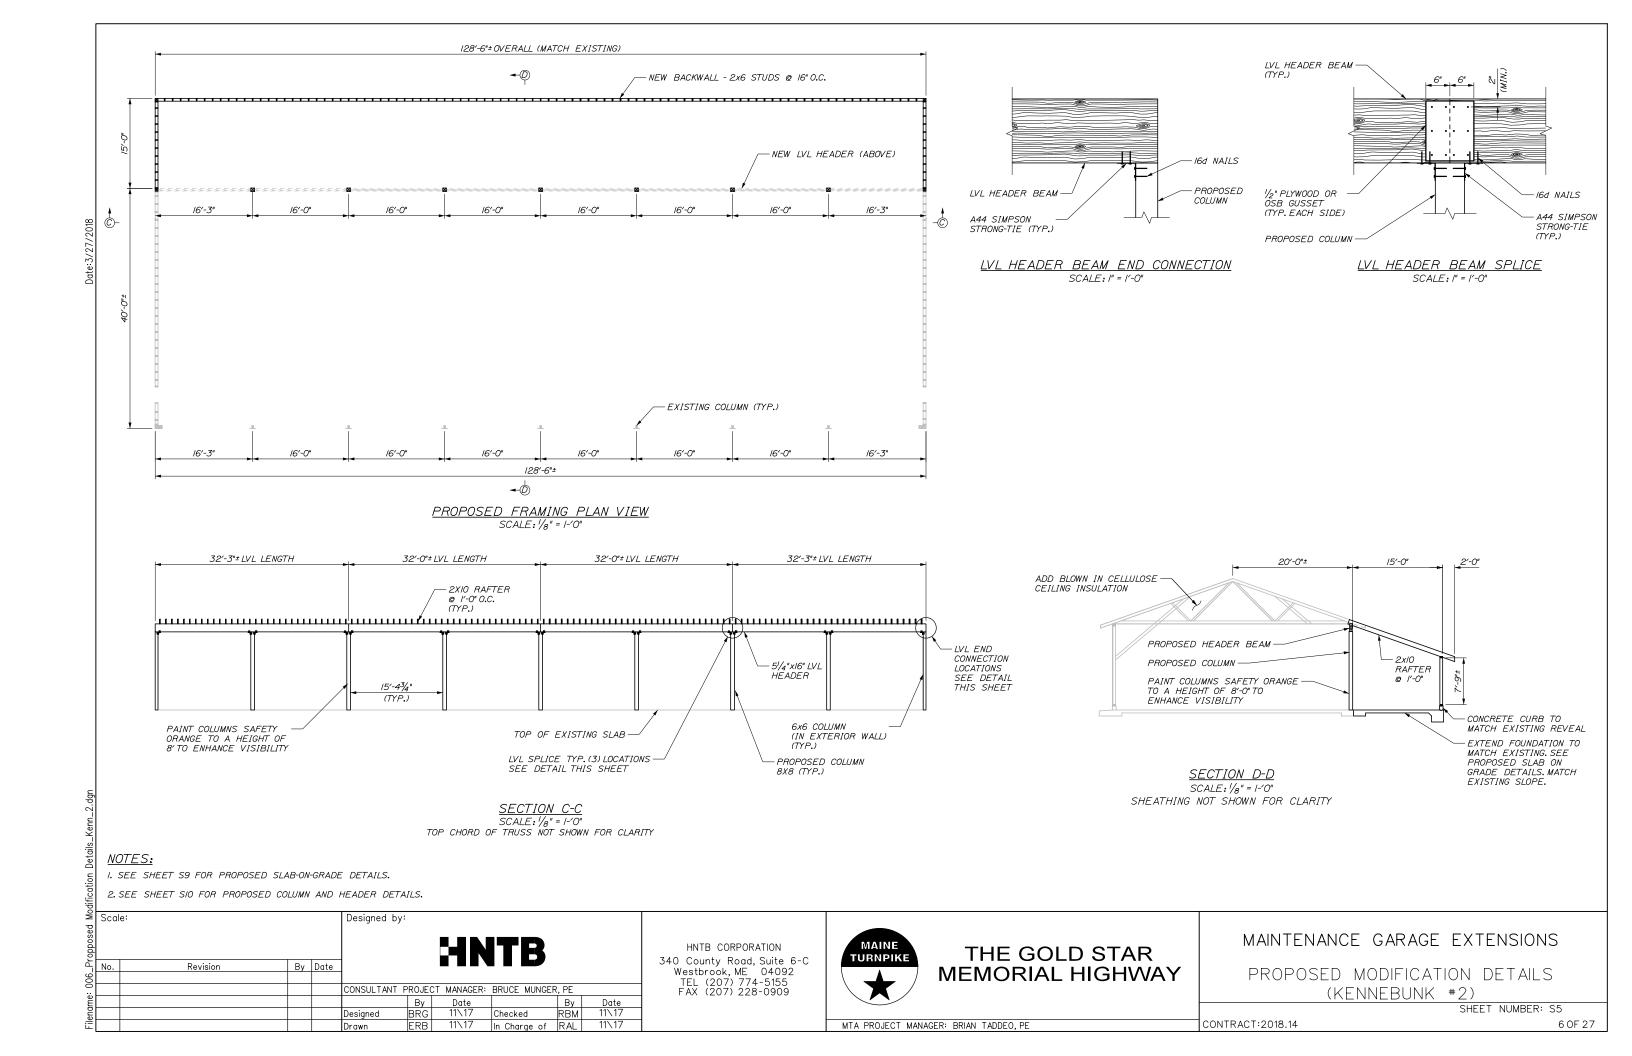

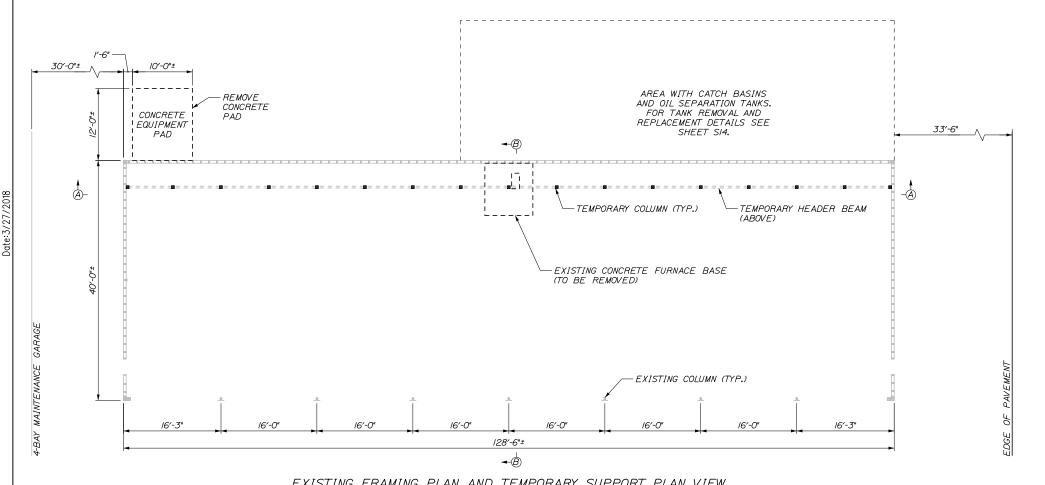

<u>EXISTING FRAMING PLAN AND TEMPORARY SUPPORT PLAN VIEW</u> SCALE: 1/8" = 1-'0"

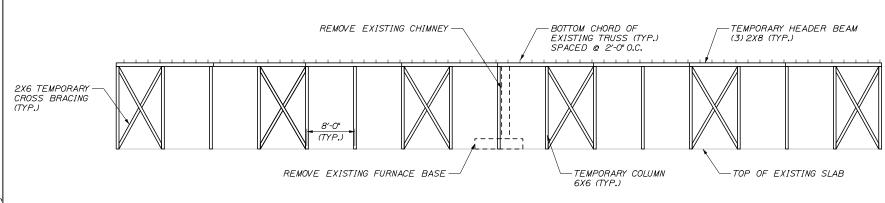

I. SEE SHEET S8 FOR TEMPORARY COLUMN AND HEADER DETAILS.

By Date

Revision

Designed by:

Designed

CONSULTANT PROJECT MANAGER: BRUCE MUNGER, PE

Checked

In Charge of RAL

Scale:

SECTION A-A

HNTB CORPORATION 340 County Road, Suite 6-C Westbrook, ME 04092 TEL (207) 774-5155 FAX (207) 228-0909

# MAINE **TURNPIKE**

### THE GOLD STAR **MEMORIAL HIGHWAY**

MAINTENANCE GARAGE EXTENSIONS

TEMPORARY SUPPORT DETAILS (GRAY)

CONTRACT:2018.14

SECTION B-B SCALE: 1/8" = 1-'0" EXISITNG CHIMNEY NOT SHOWN FOR CLARITY

GENERAL PROCEDURE

I. REMOVE SHEATHING ON WALLS AND BELOW TRUSS TO ALLOW ACCESS TO STRUCTURAL COMPONENTS. ALL SHEATHING TO BE REMOVED TO ACCESS THE WORK SHALL BE REMOVED CAREFULLY AS TO PREVENT DAMAGE TO THE SHEATHING. SHEATHING ON THE EXISTING WALLS TO REMAIN SHALL THEN BE STORED IN A SUITABLE LOCATION AND REINSTALLED USING WOOD SCREWS. ANY SHEATHING LOST OR DAMAGED DURING STORAGE TO BE REINSTALLED SHALL BE REPLACED IN KIND WITH NEW MATERIAL AT NO ADDITIONAL COST TO THE AUTHORITY.

2. REMOVE EXISTING CHIMNEY, CONCRETE FURNACE BASE, FURNACE, AND DUCT WORK.

3. LOCATE EXISTING STUDS IN BACK WALL AND INSTALL TEMPORARY COLUMNS OFFSET TO STUDS ACCORDING TO THE DETAILS ON THE STRUCTURAL PLANS. REMOVE EXISTING KNEE BRACE TO THE BOTTOM OF THE TRUSS AT LOCATIONS SHOWN ON THE STRUCTURAL PLANS. CEILING SHEATHING SHALL BE PATCHED AT REMOVED KNEE

4. INSTALL TEMPORARY HEADER BEAM TIGHTLY BENEATH EXISTING TRUSSES.
INSTALL TEMPORARY STRUTS BETWEEN BOTTOM AND TOP CHORDS OF THE EXISTING TRUSS AS SHOWN ON THE STRUCTURAL PLANS, ALL MODIFICATION WORK COMPLETED WHILE THE TEMPORARY SUPPORT IS IN PLACE SHALL BE COMPLETED WITH ONLY STRUCTURAL DEAD LOAD ON THE ROOF. DO NOT PERFORM THIS WORK WHEN THE ROOF IS SUBJECT TO SNOW OR LIVE LOAD CONDITIONS.

5. REMOVE EXISTING BACKWALL, CURB AND PORTION OF THE ROOF AS SHOWN IN THE STRUCTURAL PLANS TO CONSTRUCT GARAGE EXPANSION. PORTIONS OF THE BACK WALL, CURB, AND ROOF THAT ARE REMOVED SHALL BE DISPOSED OF IN ACCORDANCE WITH THE SPECIFICATIONS.

6. LAYOUT AND PLACE NEW CONCRETE SLAB-ON-GRADE AND CURB TO MATCH EXISTING FLOOR. SLOPE NEW FLOOR TO MATCH EXISTING DRAINAGE.

7. INSTALL NEW COLUMNS AND HEADER BEAMS ACCORDING TO THE DETAILS IN THE STRUCTURAL PLANS. PAINT NEW COLUMNS SAFETY ORANGE TO A HEIGHT OF 8' TO

8. CONSTRUCT NEW BACKWALL AND ROOF. TIE INTO AND MATCH EXISTING WALL CONSTRUCTION AND ROOF PITCH.

9. REMOVE TEMPORARY SUPPORT.

IO. REMOVE ALL EXISTING SHINGLES, INSPECT ROOF SHEATHING, REPLACE ANY ROTTED SHEATHING OR DAMAGED WATERPROOFING, INSTALL NEW PREFORMED METAL ROOFING ON EXISTING AND NEW ROOF. NEW UNDERLAYMENT SHALL BE INSTALLED AT ALL LOCATIONS IN ACCORDANCE WITH THE SPECIFICATIONS.


II. REMOVE ALL EXISTING SIDING, INSPECT WALL SHEATHING, REPLACE ANY ROTTED SHEATHING. REPLACEMENT OF ROTTED SHEATHING SHALL BE INCIDENTAL TO BUILDING PAY ITEM. INSTALL NEW PREFORMED METAL SIDING ON EXISTING AND NEW


12. INSTALL ELECTRICAL CONDUITS AND LED LIGHTS AT LOCATIONS SHOWN IN THE


13. INSTALL NEW FURNACE UNITS AND DUCT WORK AS SHOWN ON THE MECHANICAL PLANS AND INSTALL DIRECT VENT OUT THE PROPOSED BACKWALL.


2X6 STRUT BETWEEN TOP AND-BOTTOM CHORD OF TRUSS TEMPORARY REMOVE ALL EXISTING KNEE HEADER BEAM BRACE BELOW BOTTOM CHORD OF TRUSS THIS SIDE ONLY EXISTING (SPACED @ 8'-0" O.C. ON REAR BACKWALL WALL) COLUMN REMOVE EXISTING FURNACE BASE -


SHEET NUMBER: S6

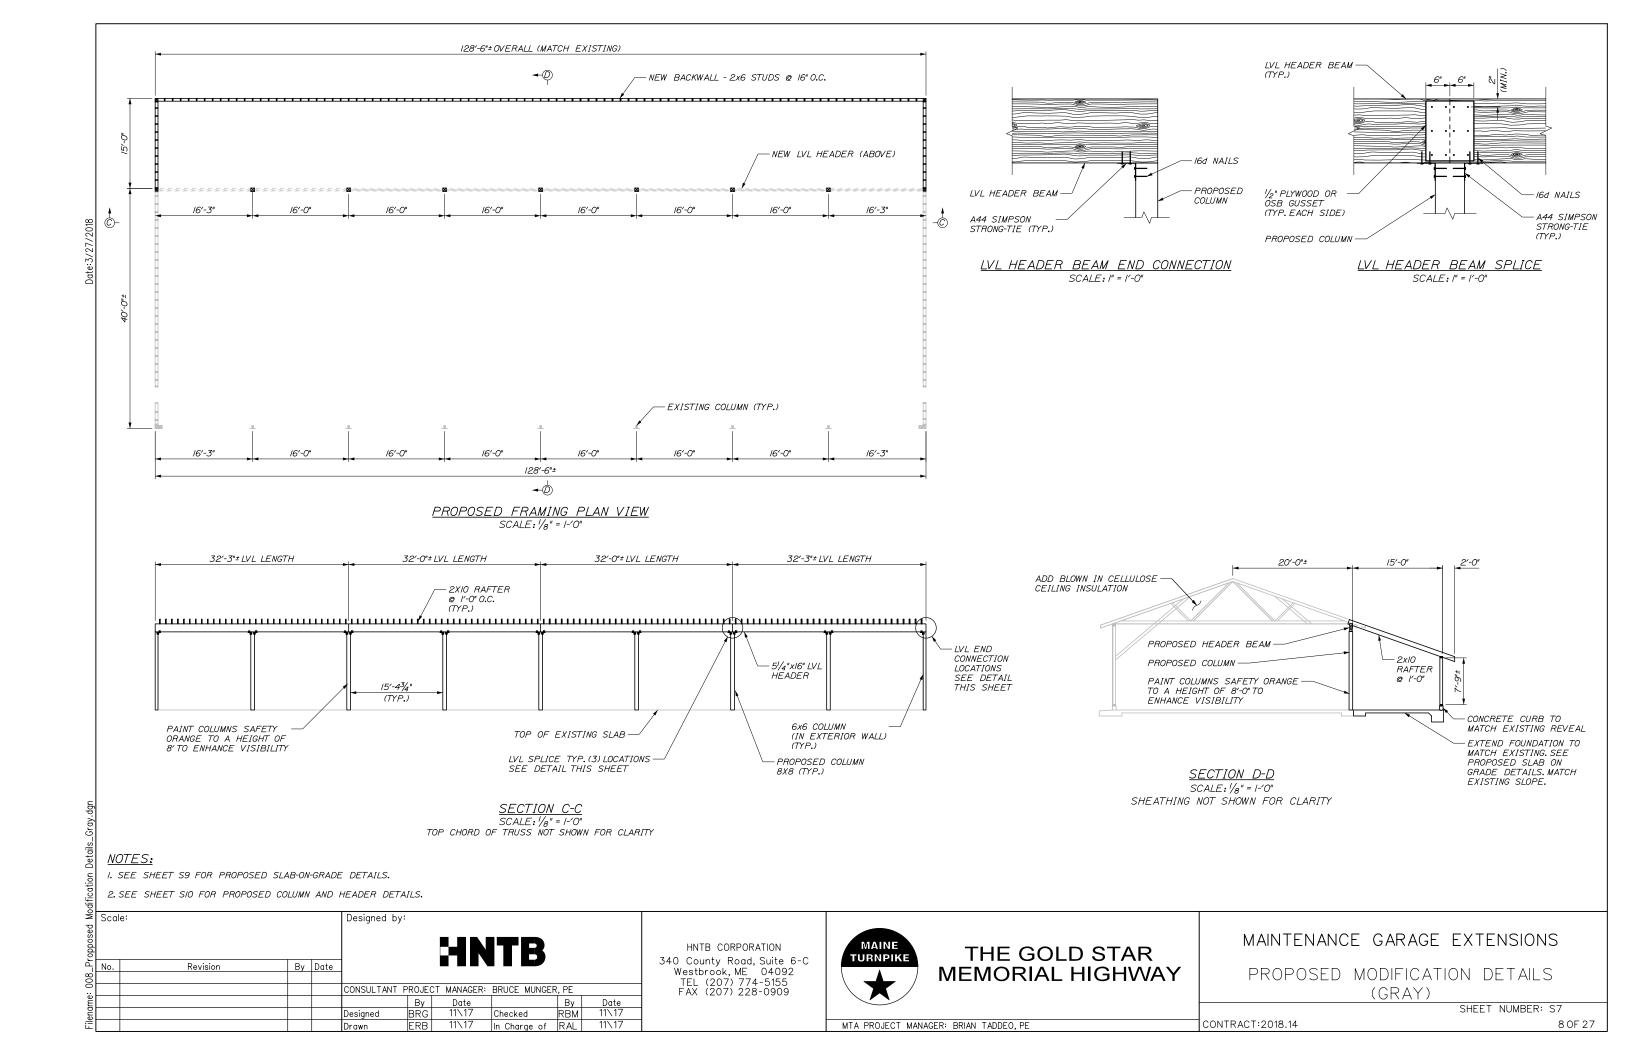

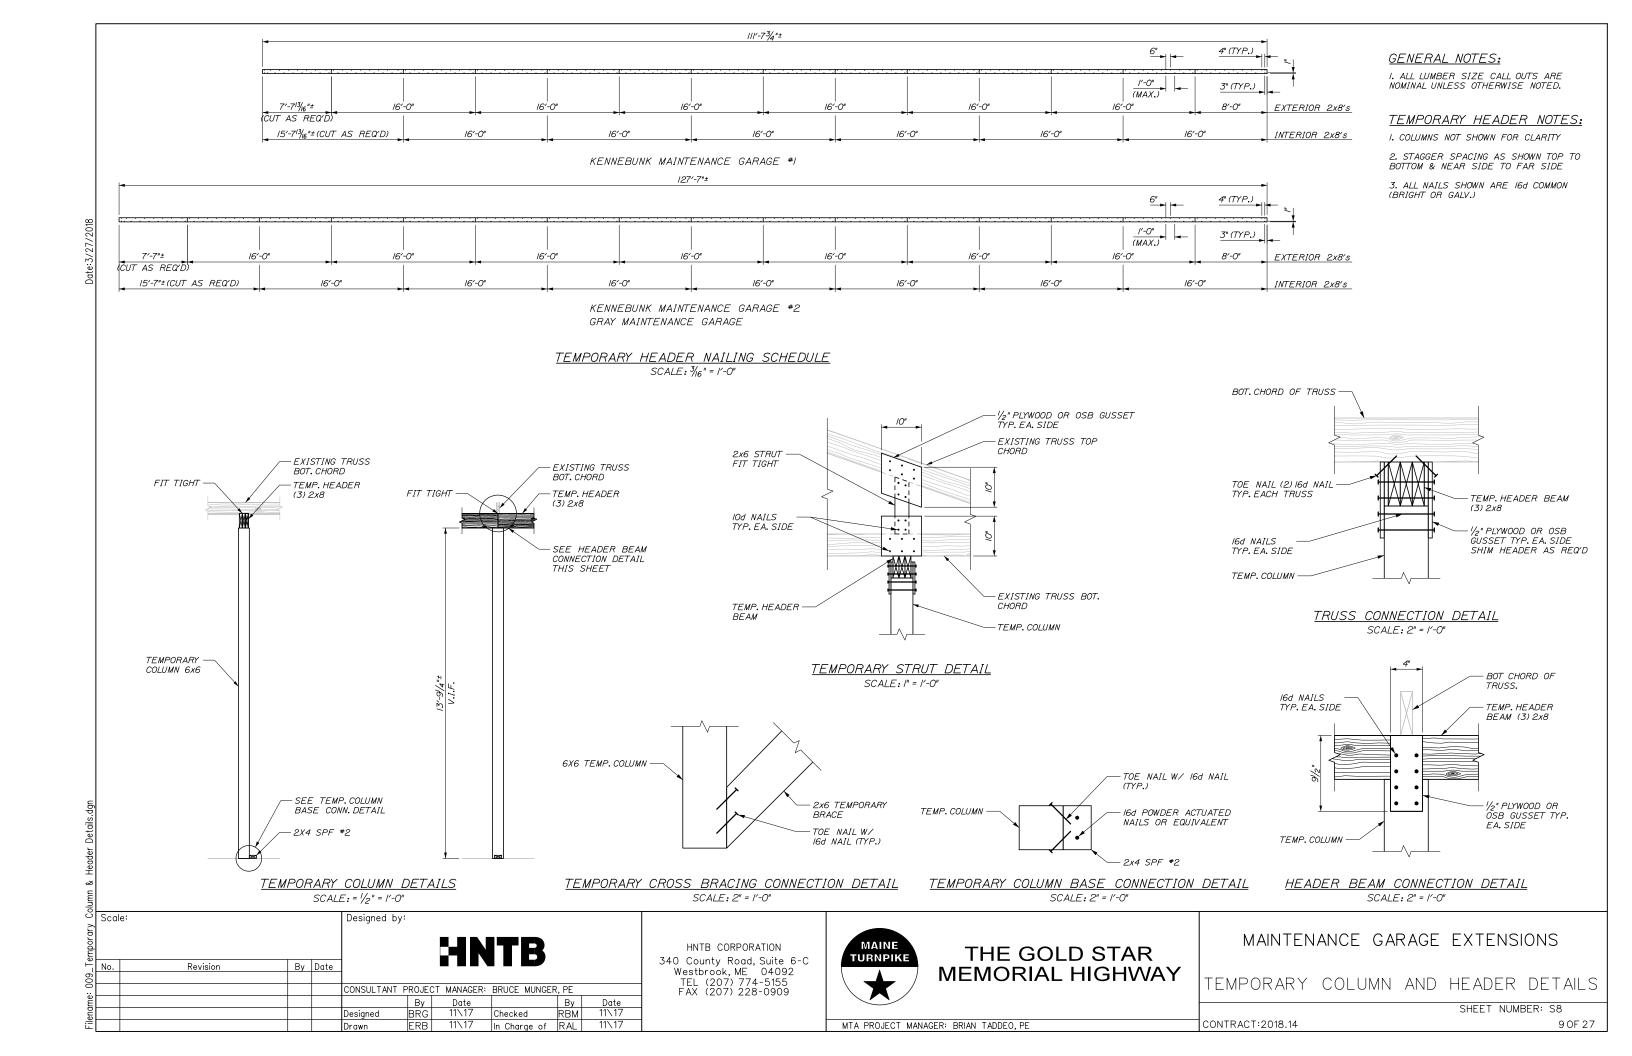


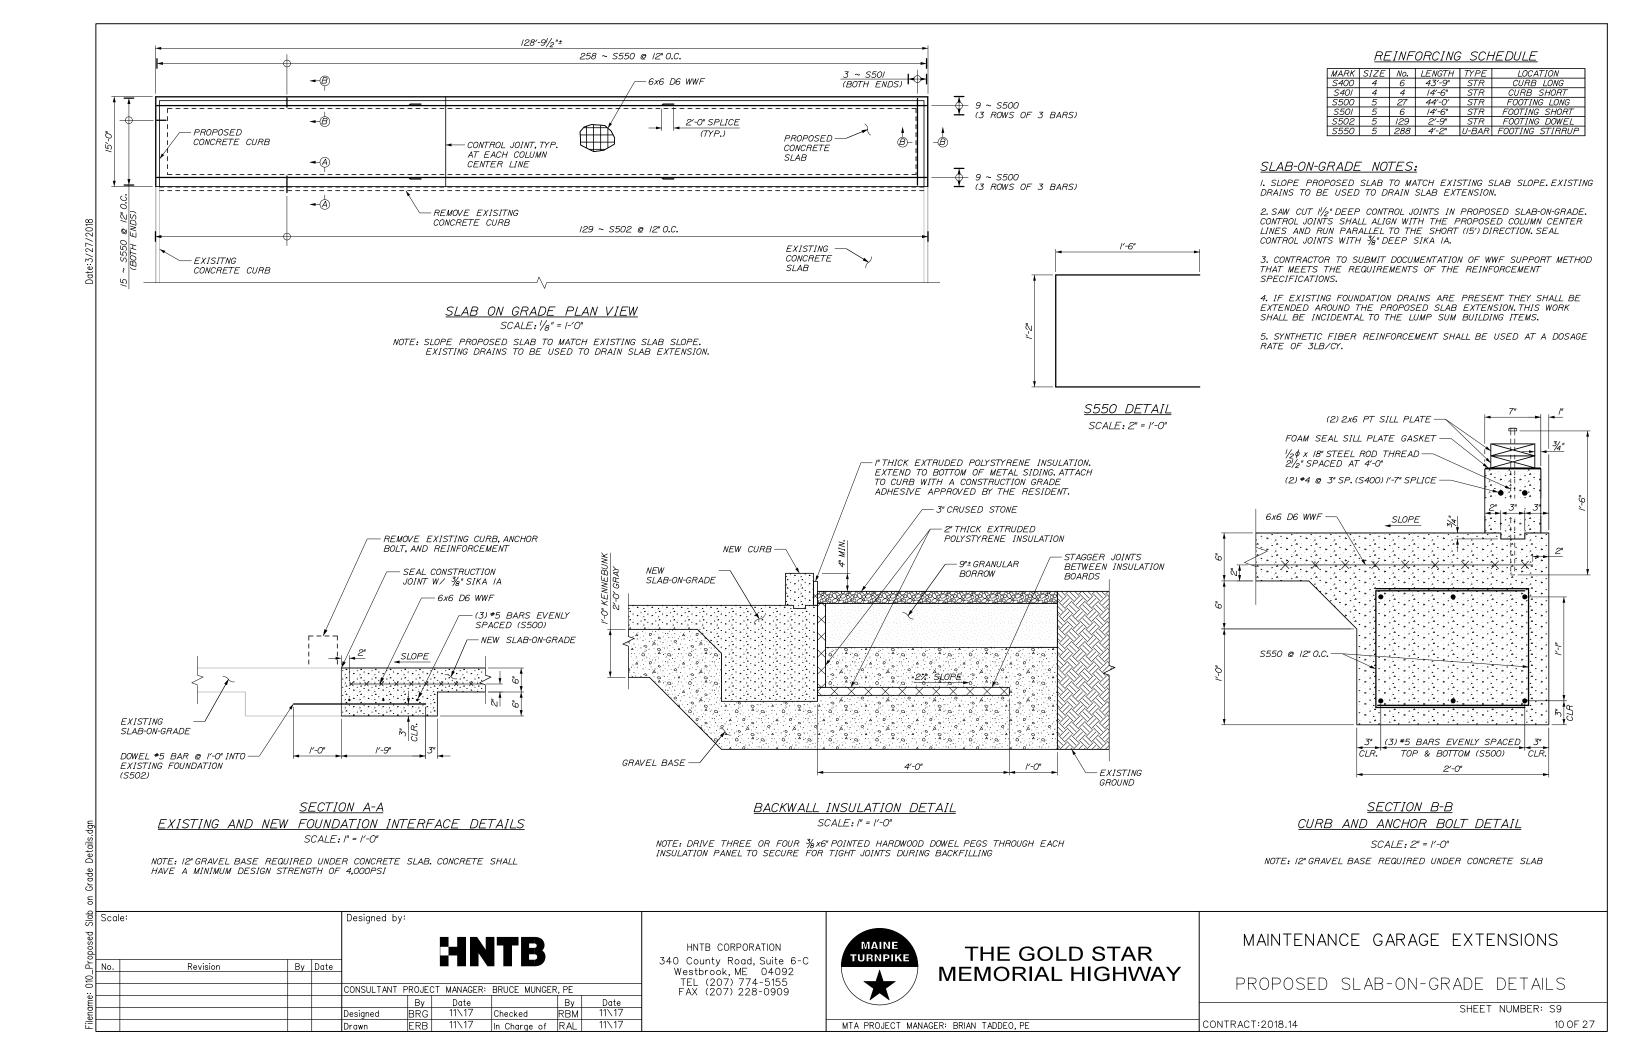

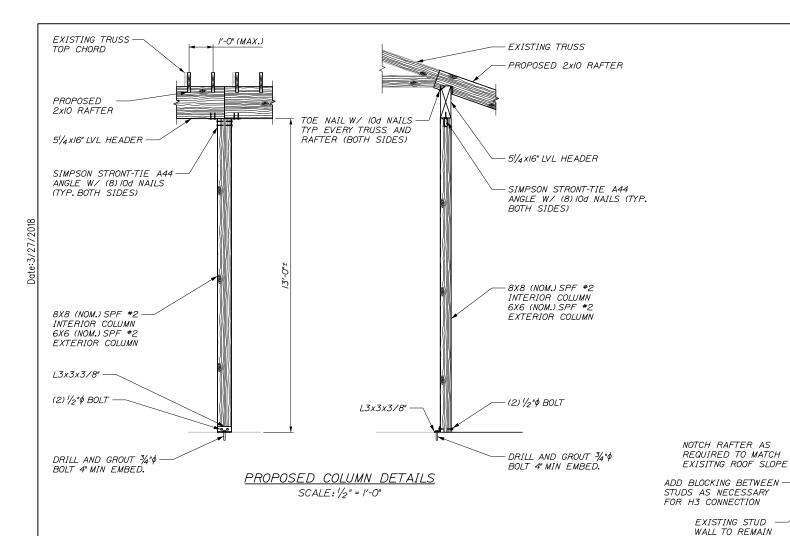

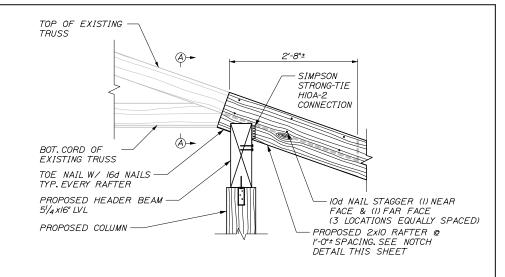


### PROPOSED RAFTER CONNECTION DETAIL AT TRUSS SCALE: |" = |'-0"

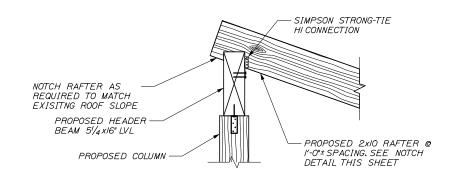

PROPOSED RAFTER CONNECTION AT EXISTING WALL SCALE: /" = /'-0"

PROPOSED RAFTER CONNECTION DETAIL BETWEEN TRUSSES SCALE: /" = /'-0"

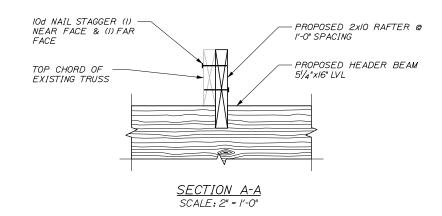

Scale: Designed by: By Date Revision CONSULTANT PROJECT MANAGER: BRUCE MUNGER, PE Ву Designed 11\17 In Charge of RAL

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MAINTENANCE GARAGE EXTENSIONS

PROPOSED COLUMN AND HEADER DETAILS

SHEET NUMBER: S10 CONTRACT:2018.14


MTA PROJECT MANAGER: BRIAN TADDEO, PE

SIMPSON STRONG-TIE


PROPOSED 2xIO RAFTER @ I'-O" + SPACING. SEE NOTCH

DETAIL THIS SHEET

H3 CONNECTION

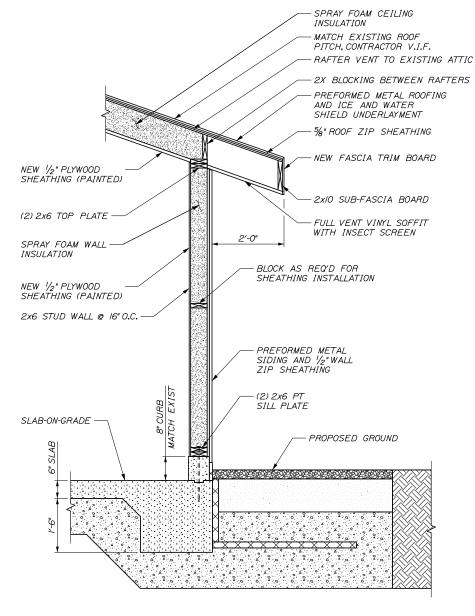

SECTION A-A BUILDING EXTENSION SCALE: 3/4" = 1'-0"

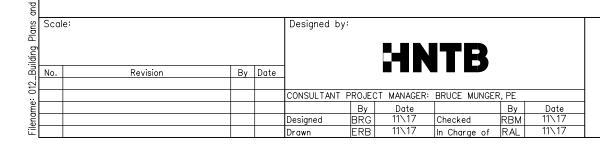


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THE GOLD STAR **MEMORIAL HIGHWAY**  MAINTENANCE GARAGE EXTENSIONS

BUILDING PLAN AND SECTION

SHEET NUMBER: S11 CONTRACT:2018.14



REAR ELEVATION SCALE: 3/16" = 1-'0"

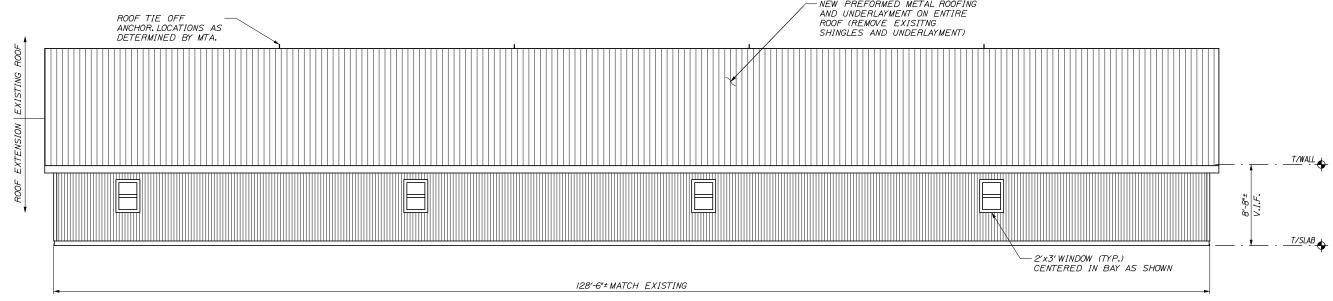Ş Scale: Designed by: By Date മി №. Revision CONSULTANT PROJECT MANAGER: BRUCE MUNGER, PE Checked RBM
In Charge of RAL Designed 11\17

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### THE GOLD STAR **MEMORIAL HIGHWAY**

MAINTENANCE GARAGE EXTENSIONS

BUILDING ELEVATIONS

SHEET NUMBER: S12 CONTRACT:2018.14

MTA PROJECT MANAGER: BRIAN TADDEO, PE

13 OF 27

- DOUBLE SILL PLATE


-WINDOW SILL PLATE

FRAMING TO MATCH EXISTING, CONTRACTOR

TOP OF CONCRETE CURB

- DOUBLE SILL PLATE

-(3) 2x8 HEADER

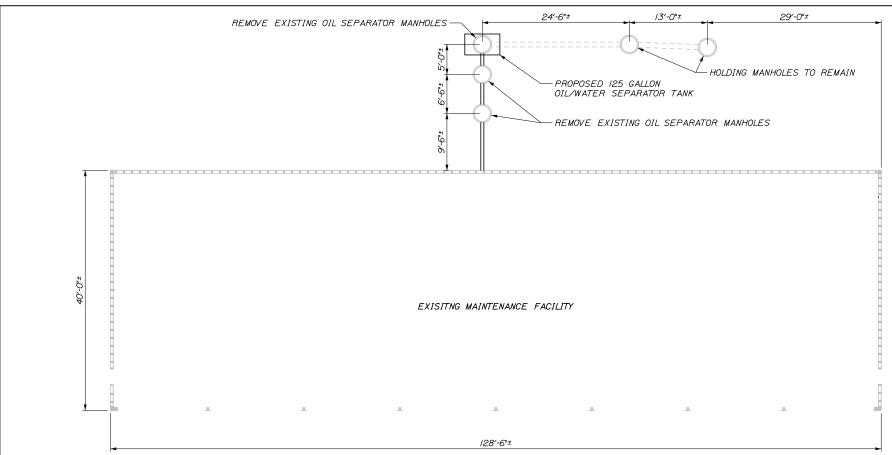

Checked RBM
In Charge of RAL

Ву



MTA PROJECT MANAGER: BRIAN TADDEO, PE

THE GOLD STAR **MEMORIAL HIGHWAY** 

OIL/WATER SEPARATOR TANK DETAILS (GRAY)

MAINTENANCE GARAGE EXTENSIONS

CONTRACT:2018.14

NOTES:

IN GRAY.

REPLACEMENT.

OIL/WATER SEPARATOR TANK.

I. THE WORK SHOWN ON THIS SHEET APPLIES TO THE 8-BAY MAINTENANCE GARAGE

6. PIPE INVERT ELEVATIONS SHALL BE INSTALLED SUCH THAT A CONSTANT SLOPE BE MAINTAINED TO ALLOW WATER TO FLOW THROUGH THE SYSTEM TO THE HOLDING TANKS.

3. REMOVE EXISTING OIL SEPARATOR TANKS AS SHOWN IN THE PLANS AND REPLACE WITH A 125 GALLON OIL/WATER SEPARATOR TANK. 4. CONTRACTOR SHALL VERIFY ALL DIMENSIONS PRIOR TO TANK REMOVAL AND

5. CONTRACTOR SHALL TIE INTO EXISTING BUILDING DRAINAGE WITH NEW

7. THIS WORK SHALL BE COMPLETED BEFORE FORMING THE PROPOSED SLAB-ON-GRADE OF THE BUILDING EXTENSION.

2. FOR MORE INFORMATION SEE CONTRACT SPECIFICATIONS.


SHEET NUMBER: S13 14 OF 27

OIL SEPARATOR TANK REPLACEMENT PLAN SCALE: 1/8" = 1-'0" Scale: Designed by: HNTB CORPORATION 340 County Road, Suite 6-C Westbrook, ME 04092 TEL (207) 774-5155 FAX (207) 228-0909 By Date Revision


CONSULTANT PROJECT MANAGER: BRUCE MUNGER, PE

11\17

Designed

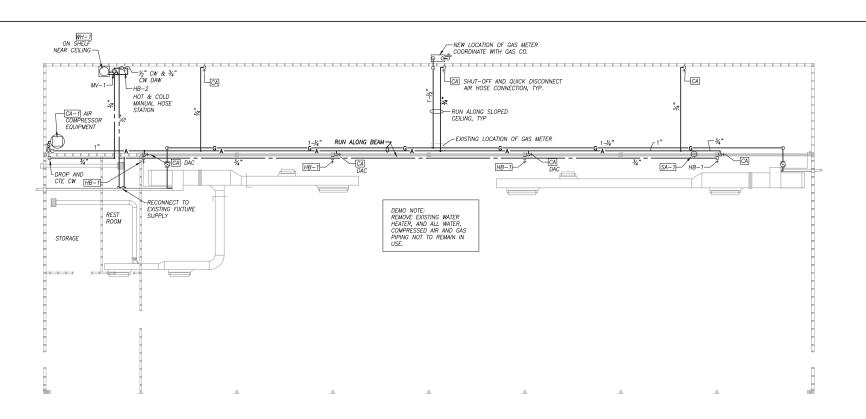

SCALE: 1/8" = 1-'0"

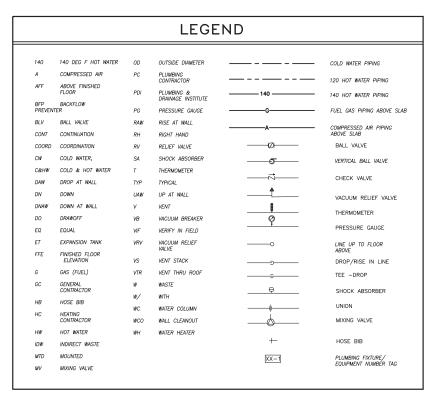

### GENERAL NOTES

- All work shall be in accordance with the Maine State (Uniform) Plumbing Code, local codes and ordinances, National Fire Code (NFPA), or these plans or specifications, whichever is more strict.
- All drawings are schematic only, and are intended to indicate the intent, extent, and general arrangement of work. They are not meant to show every fitting, change of direction or every situation. Verify locations in the field. Work indicated shall be furnished complete to perform the function intended.
- Carefully coordinate the space requirements and location of piping with the other trade contractors.
- This contractor shall make all final plumbing connections to equipment/
  extures provided by other contractors.
- $5. \quad \textit{No structural members shall be cut without approval of the Structural Engineer}.$
- All plumbing shall be supported from the building structure. Hangers longer han 12" will be seismically braced if required by the International Building Code.
- l. ANY pipe penetrations through a fire rated wall or floor shall have a UL rated ire stop system rated to match the rating of the wall assembly, as per the NFPA.
- 9. All above ground domestic water and any storm water piping shall be insulated
- 10. Run all water and drain piping on warm side of building insulation. No lines shall be run in exterior walls, unless directly indicated, and protected.
- 12. All Domestic water piping shall be type "K" or "L" copper, type "M" is

WATER SPEC. SCHEDULE									
TAG	ITEM	CW	HW	OUTLET	REMARKS				
ET-1	EXPANSION TANK	1/2"	-	-					
HB-1	HOSE BIB W/ VB	3/4"	-	¾" GHT					
HB-2	HOT AND COLD WATER MIXING STATION	3/4"	1/2"	¾" GHT					
MV-1	MIXING VALVE	1/2"	1/2"	1/2"					
SA-1	SHOCK ABSORBER	1/2 OR	3/4""	-	P.D.I. A				

\	VATER	HE	EAT	ER	,	SCHEDULE
TAG	ITEM	GAL	WATTS	VOLTS	РΗ	SPECIFICATION & REMARKS
WH-1	DOMESTIC HOT WATER	10	4500	240	1	A. O. SMITH EJC-10, ELEC. BY EC

ΑI	R COM	1PR	ES	SO	R	SCHEDULE
TAG	ITEM	GAL	HP	VOLTS	РН	SPECIFICATION & REMARKS
AC-1	AIR COMPRESSOR STATIONARY	80	7.5	240	1	INGERSOL RAND, VERTICAL TANK MOUNTED, MODEL 2475N7.5

	0' 2'	4' 6' 8'	16	' 2	4'
1/s" = 1'-	-0"				

Scale	e: -		Designed by	/:					
No.	Revision	Ву	Date						
				CONSULTANT	PROJE(	CT MANAGER:	KFM		
					Ву	Date		Ву	Date
				Designed	EJP	02/18	Checked	KFM	02/18
				Drawn	EJP	02/18	In Charge of	KFM	

HOT WATER STORAGE

TANK DIAGRAM
SCALE: NONE

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MTA PROJECT MANAGER: BRIAN TADDEO, PE

MAINTENANCE GARAGE EXTENSIONS


KENNEBUNK #1

PLUMBING PLAN, NOTES AND SCHEDULES


SHEET NUMBER:P1

CONTRACT: 2018.14

15 OF 27

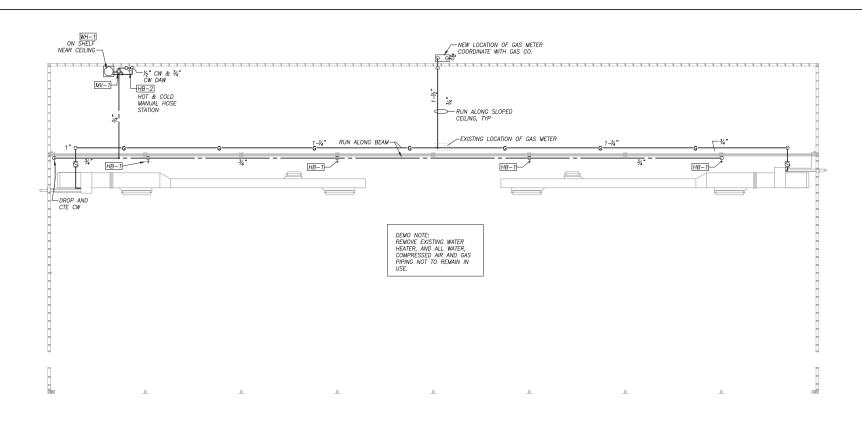


SCALE: 1/8" = 1-'0"

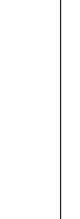

FROM CW

MV-1

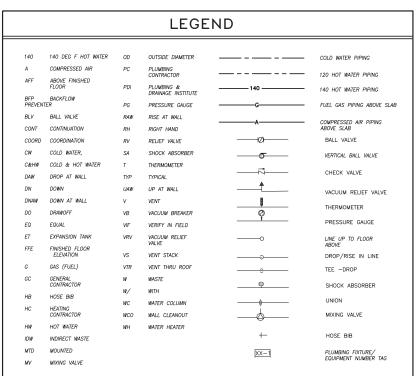

### GENERAL NOTES

- All drawings are schematic only, and are intended to indicate the intent, extent, and general arrangement of work. They are not meant to show every fitting, change of direction or every situation. Verify locations in the field. Work indicated shall be furnished complete to perform the function intended.
- Carefully coordinate the space requirements and location of piping with the er trade contractors.
- 4. This contractor shall make all final plumbing connections to equipment/fixtures provided by other contractors.
- 5. No structural members shall be cut without approval of the Structural Enginee

- 12. All Domestic water piping shall be type "K" or "L" copper, type "M" is

WATER SPEC. SCHEDULE									
TAG	ITEM	CW	HW	OUTLET	REMARKS				
ET-1	EXPANSION TANK	1/2"	-	-					
HB-1	HOSE BIB W/ VB	3/4"	-	3¼" GHT					
HB-2	HOT AND COLD WATER MIXING STATION	3/4"	1/2"	³¼" GHT					
MV-1	MIXING VALVE	1/2"	1/2"	1/2"					
SA-1	SHOCK ABSORBER	1/2 OF	3/4""	-	P.D.I. A				

٧	VATER	НЕ	EAT	ER	,	SCHEDULE
TAG	ITEM	GAL	WATTS	VOLTS	РΗ	SPECIFICATION & REMARKS
WH-1	DOMESTIC HOT WATER	10	4500	240	1	A. O. SMITH EJC-10, ELEC. BY EC

1	0'	2' 4'	6' 8'	16'	24'	32'
_	1-0"					

TANK DIAGRAM  SCALE: NONE	MV MIXING VALVE	<u> </u>	EQUIPMENT NUMBÉR TAG	0' 2' 4' 6' 8'	l6' 24'
- Scale, None				1/8" = 1'-O"   1   1   1   1   1   1   1   1   1	
Designed by:					

No.	Revision	Ву	Date						
				CONSULTANT P	ROJEC	CT MANAGER:	KFM		
					Ву	Date		Ву	Date
				Designed	EJP	02/18	Checked	KFM	02/18
				Drawn	EJP	02/18	In Charge of	KFM	

HOT WATER STORAGE

Scale:


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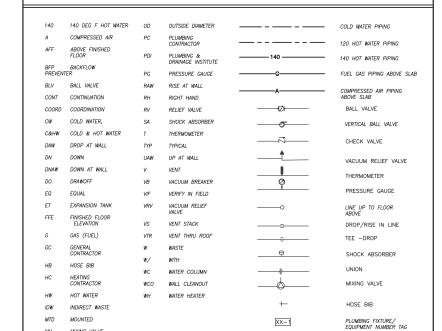
MAINTENANCE GARAGE EXTENSIONS KENNEBUNK #2 PLUMBING PLAN, NOTES AND SCHEDULES

SHEET NUMBER:P2

MTA PROJECT MANAGER: BRIAN TADDEO, PE



SCALE: 1/8" = 1-'0"

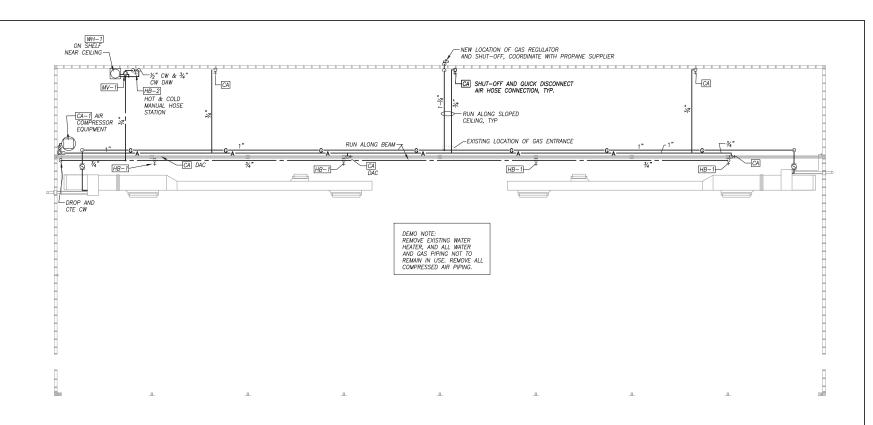

LEGEND

### GENERAL NOTES

- All work shall be in accordance with the Maine State (Uniform) Plumbing Code, local codes and ordinances, National Fire Code (NFPA), or these plans or specifications, whichever is more strict.
- 3. Carefully coordinate the space requirements and location of piping with the other trade contractors.
- 4. This contractor shall make all final plumbing connections to equipment/fixtures provided by other contractors.

- 9. All above ground domestic water and any storm water piping shall be insulated unless otherwise specified.
- 12. All Domestic water piping shall be type "K" or "L" copper, type "M" is

1	WATER SP	EC.	S	CHE	EDULE
TAG	ITEM	CW	HW	OUTLET	REMARKS
ET-1	EXPANSION TANK	1/2"	-	-	
HB-1	HOSE BIB W/ VB	3/4"	-	³¼" GHT	
HB-2	HOT AND COLD WATER MIXING STATION	3/4"	1/2"	¾" GHT	
MV-1	MIXING VALVE	1/2"	1/2"	1/2"	
SA-1	SHOCK ABSORBER	1/2 OF	3/4""	-	P.D.I. A

١ ١	WATER	HE	EAT	ER	•	SCHEDULE
TAG	ITEM	GAL	WATTS	VOLTS	РΗ	SPECIFICATION & REMARKS
WH-1	DOMESTIC HOT WATER	10	4500	240	1	A. O. SMITH EJC-10, ELEC. BY EC

ΑI	R COM	1PR	ES:	SO	R	SCHEDULE
TAG	ITEM	GAL	HP	VOLTS	РΗ	SPECIFICATION & REMARKS
AC-1	AIR COMPRESSOR STATIONARY	80	7.5	240	1	INGERSOL RAND, VERTICAL TANK MOUNTED, MODEL 2475N7.5



Scale	e:			Designed by:					
No.	Revision	Ву	Date	]					
				CONSULTANT P	ROJEC	CT MANAGER:	KFM		
					Ву	Date		Ву	Date
				Designed	EJP	02/18	Checked	KFM	02/18
				Drawn	EJP	02/18	In Charge of	KFM	

TO 120 °F HW SYSTEM —

HOT WATER STORAGE

TANK DIAGRAM

FROM CW

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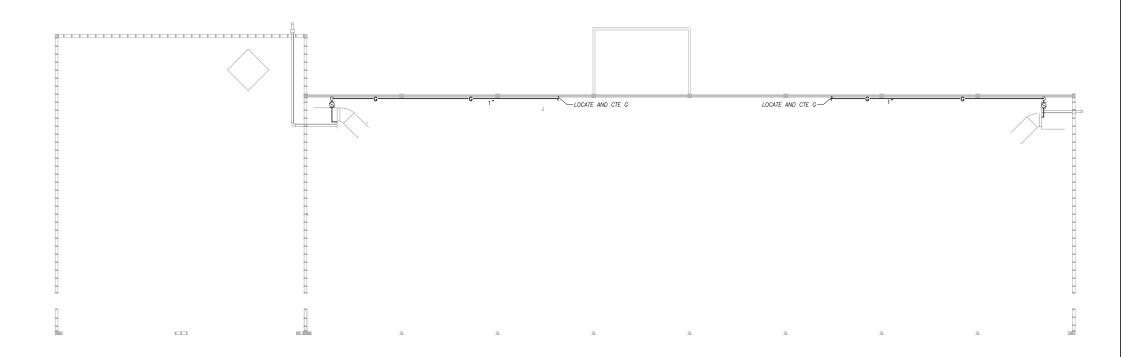
MIXING VALVE




MTA PROJECT MANAGER: BRIAN TADDEO, PE

MAINTENANCE GARAGE EXTENSIONS GRAY PLUMBING PLAN, NOTES AND SCHEDULES

SHEET NUMBER:P3



SCALE: 1/8" = 1-'0"

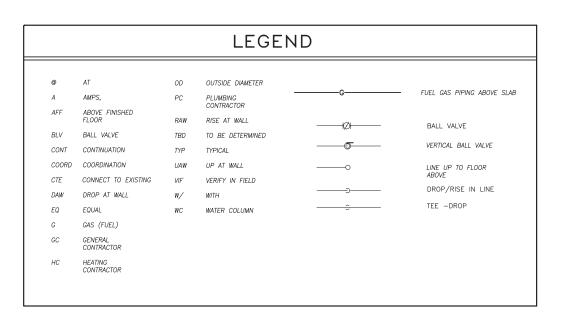

### GENERAL NOTES

- I. All work shall be in accordance with the Maine State (Uniform) Plumbing Code, local codes and ordinances, National Fire Code (NFPA), or these plans or specifications, whichever is more strict.
- 2. All drawlings are schematic only, and are intended to indicate the intent, extent, and general arrangement of work. They are not meant to show every filting, change of direction or every situation. Verify locations in the field. Work indicated shall be furnished complete to perform the function
- 3. Carefully coordinate the space requirements and location of piping with the other trade contractors. If coordination falls, conflicts will be decided in favor of the other contractors with this contractor relocating his piping and equipment at no expense to the Owner.
- 4. This contractor shall make all final plumbing connections to equipment/ fixtures provided by other contractors.
- 5. No structural members shall be cut without approval of the Architect.
- $6,\;$  All plumbing shall be supported from the building structure. Hangers longer than 12'' will be seismically braced if required by the International Building Code.
- 7. All piping shall be installed parallel to building lines and pitched to low points. Provide draw-offs at low points. Piping shall be run neatly grouped together when practical,

	0'	2' 4'	6' 8'	16'	24	3
\ <u>6</u> " =	I'-O" 📮			Mh		
					W	

Scale: Designed by: Revision CONSULTANT PROJECT MANAGER: KFM Date Checked


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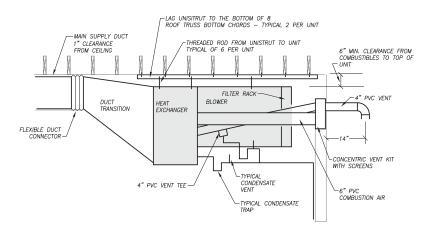


MTA PROJECT MANAGER: BRIAN TADDEO, PE


MAINTENANCE GARAGE EXTENSIONS CROSBY FARMS PLUMBING PLAN, NOTES AND SCHEDULES


SHEET NUMBER:P4




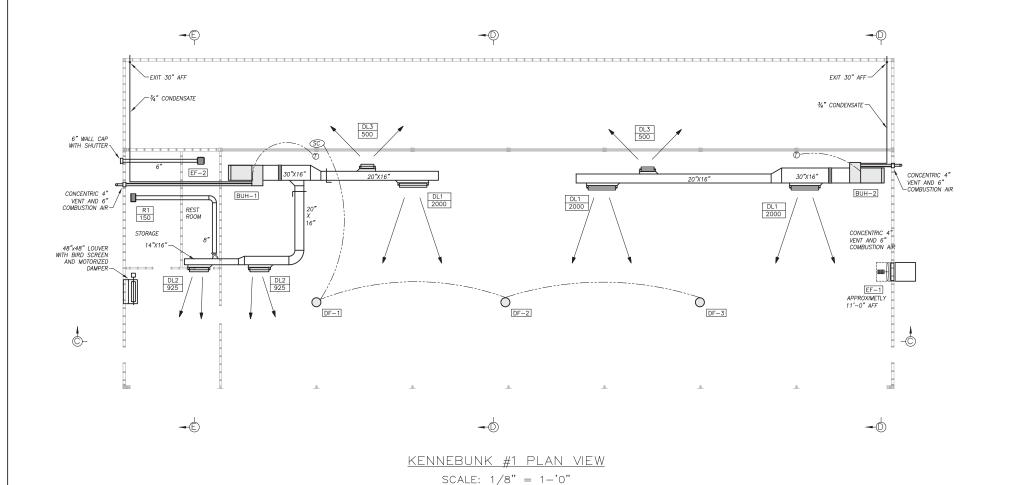

SECTION THROUGH BLOWER UNIT HEATER SCALE: 1/2" = 1-'0"

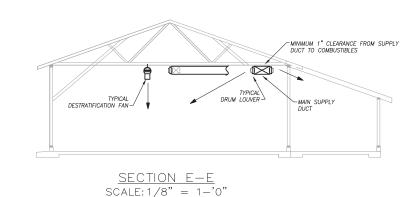

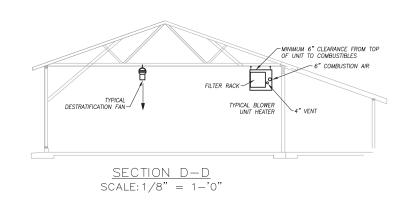

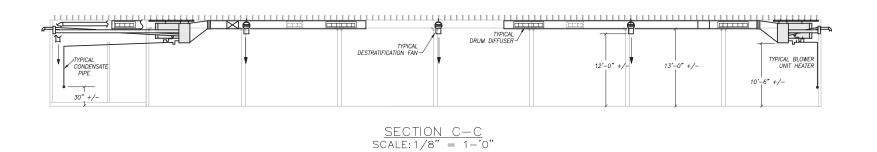



No. Revision By Date

CONSULTANT PROJECT MANAGER: KFM

By Date

By Date

By Date

Designed KFM 02/18 Checked KFM 02/18

Drawn KFM 02/18 In Charge of

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MTA PROJECT MANAGER: BRIAN TADDEO, PE

THE GOLD STAR MEMORIAL HIGHWAY MAINTENANCE GARAGE EXTENSIONS
KENNEBUNK #1
MECHANICAL PLAN VIEW

SHEET NUMBER: M1
CONTRACT: 2018.14 19 OF 2

### GENERAL NOTES

- All systems are to be to meet the following Codes and Standards.
   ASHRAE 90.1 2007 Energy Standard for Commercial Buildings.
   ASHRAE 60.1 2007 Standard for Indoor Air Quality in
- Commercial Buildings.

  1.3. 2009 IECC International Energy Conservation Code.

  1.4. NFPA National Fire Protection Association Standards.
- Do not cut any structural members without pre-approval of structural engineer.

### SHEETMETAL NOTES

- All ductwork to be fabricated and installed per SMACNA Low Pressure Ductwork Standards.
- Ductwork is shown diagrammatically and does not indicate all the offsets, rises and drops that will be required.
- All ductwork is within the Building Thermal Envelope and will not require insulation.

### VENTING, COMBUSTION AIR AND CONDENSATE NOTES


- Piping is shown diagrammatically and does not indicate all the offsets, rises and drops that will be required.
- 2. All condensate piping to be Schedule 40 PVC.
- 3. All venting and combustion air piping to be Schedule 40 PVC.
- All venting, combustion air and condensate piping to be installed per manufacturers recommendations and requirements for horizontal venting.


### CONTROL NOTES

- It will be the Mechanical Contractor's responsibility to provide and install all controls and all control wiring.
- 2. All control wiring that is run exposed shall be in electrical conduit provided and installed by the mechanical contractor (or his ATC subcontractor)..
- 3. Blower Unit Heaters (BUH) to have 24v heating only thermostats.
- Control for the Destratification Fans (DF) to be provided by the Mechanical Contractor including Potentiometer Speed Control, control wiring and conduit.

### **DEMOLITION NOTES**

- It will be the mechanical contractor's to remove from the jobsite all existing mechanical related items that will no longer be in
- 2. Items to be removed include (but are not limited to):
- 2. Items to be removed include (but are not limited to):
  2.1. Air Handler / Warm Air Furnace
  2.2. All ductwork, registers and grilles associated with the Air Handler / Warm air furnace.
  2.3. Furnace breeching from furnace to masonry chimney.
  2.4. Thermostats and related control wiring.
- 3. All removed items to be disposed of per EPA Standards.

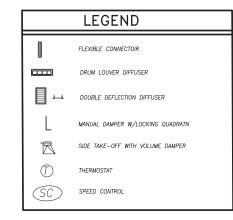

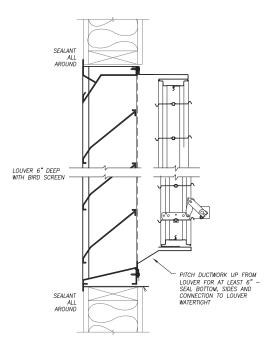


EXTERIOR LOUVER DETAIL NO SCALE


			DE	STRAT	ΓIFΙ	CA	ΓΙΟΝ	& EXHAUST FAN SCHEDULE	
TAG	DESIGN MANUFACTURER & MODEL	TYPE	CFM	POWER POWER	TRIC FLA	HP	WEIGHT	REMARKS	CONTROL
				TOWER	1 1 1	100			
DF-1	ARIUS AIR PEAR 45-EL	CEILING HUNG	0-1180	115/60/1	2.2		14 LBS	ECM MOTOR - GRAY COLOR	
DF-2	ARIUS AIR PEAR 45-EL	CEILING HUNG	0-1180	115/60/1	2.2		14 LBS	ECM MOTOR - GRAY COLOR	AIRIUS POT-1 POTENTIOMETER SPEED CONTROL FOR MULTIPLE
DF-3	ARIUS AIR PEAR 45-EL	CEILING HUNG	0-1180	115/60/1	2.2		14 LBS	ECM MOTOR - GRAY COLOR	EC MOTORS
DF-4	ARIUS AIR PEAR 45-EL	CEILING HUNG	0-1180	115/60/1	2.2		14 LBS	ECM MOTOR - GRAY COLOR	
EF-1	GREENHECK S2-30-610b10	SIDEWALL	8,600	115/60/1		1.0	150 LBS	WITH WALL COLLAR,115V MOTORIZED DAMPER, MOTOR SIDE GUARD AND EXTERIOR 45 DEG. WEATHER HOOD	WALL STARTER POWERING FAN AND LOUVER
EF-2	NUTONE QTXEN110	CEILING	110	115/60/1	0.4		10 LBS	MAXIMUM 0.7 SONE	POWERED BY LIGHT SWITCH

					BLO'	WER	BLOWER UNIT HEATER SCHEDULE												
TAG	DESIGN MANUFACTURER & MODEL	BTUH INPUT	BTUH OUTPUT	AFUE	FUEL	CFM	E.S.P.	MOTOR HP	POWER	WEIGHT	REMARKS								
BUH-1	MODINE EFFINTY BTC310	310,000	257,000	93 %	NAT. GAS	4,500	0.50"	2.0	230/60/1	395 LBS	CONDENSING TYPE - SEALED COMBUSTION WITH FACTORY BLOWER ENCLOSURE, FILTER RACK, CONCENTRIC								
BUH-2	MODINE EFFINTY BTC310	310,000	257,000	93 %	NAT. GAS	4,500	0.50"	2.0	230/60/1	395 LBS	HORIZONTAL VENT KIT, AND 24V CONTROL CIRCUIT								

				Alf	R TERMINAL SCHEDULE
TAG	DESIGN MANUFACTURER & MODEL	SIZE	MAX NC	MAX SP	REMARKS
DL1	PRICE HCD 12/48	48"X12"	30	.07	HIGH CAPACITY DRUM LOUVER DIFFUSER WITH VERTICAL VANES AND OPPOSED BLADE DAMPER
DL2	PRICE HCD 12/18	18"X12"	30	.07	HIGH CAPACITY DRUM LOUVER DIFFUSER WITH VERTICAL VANES AND OPPOSED BLADE DAMPER
DL3	PRICE HCD 6/24	24"X6"	30	.07	HIGH CAPACITY DRUM LOUVER DIFFUSER WITH VERTICAL VANES AND OPPOSED BLADE DAMPER
R1	PRICE 520S	14"X8"	20	.07	DOUBLE DEFLECTION SUPPLY GRILLE

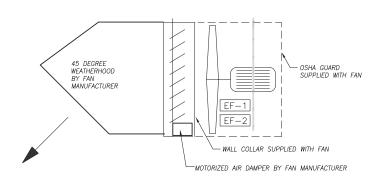

EXHAUST FAN DETAIL SECTION NO SCALE

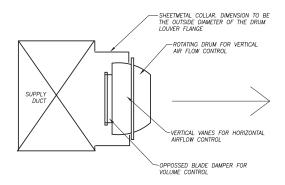

DRUM LOUVER DETAIL NO SCALE

## 1/8" = |'-O"

Scale:				Designed b	y:				
No.	Revision	By	Date						
				CONSULTANT	PROJEC	T MANAGER:	KFM	-	
					Ву	Date		Ву	Date
				Designed	KFM	02/18	Checked	KFM	02/18
				Drawn	KFM	02/18	In Charge of		


HNTB CORPORATION 340 County Road, Suite 6-C Westbrook, ME 04092 TEL (207) 774-5155 FAX (207) 228-0909




MAINTENANCE GARAGE EXTENSIONS KENNEBUNK #1 SCHEDULES, NOTES & DETAILS

SHEET NUMBER: M2


MTA PROJECT MANAGER: BRIAN TADDEO, PE CONTRACT: 2018.14

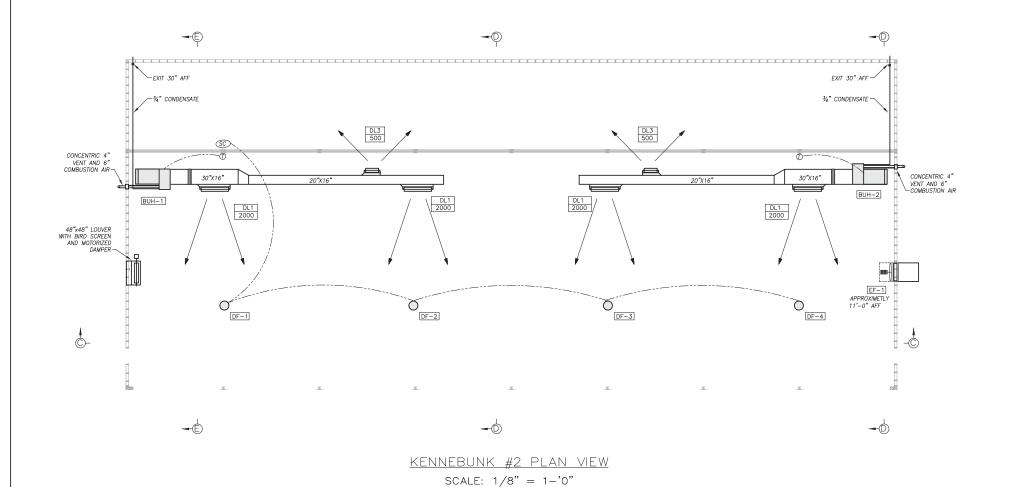

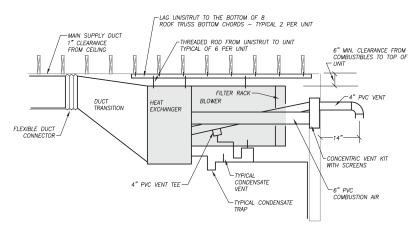



SECTION THROUGH BLOWER UNIT HEATER

SCALE: 1/2" = 1-'0"

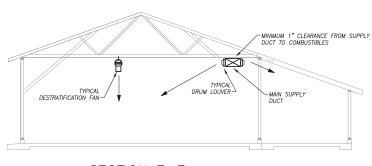

 $\frac{\text{SECTION } E-E}{\text{SCALE: } 1/8" = 1-0"}$ 

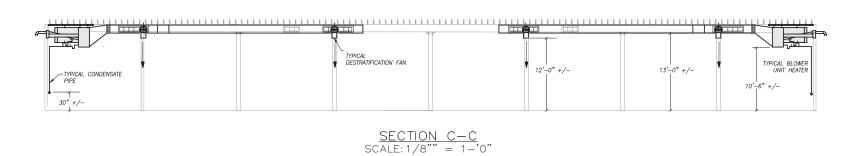

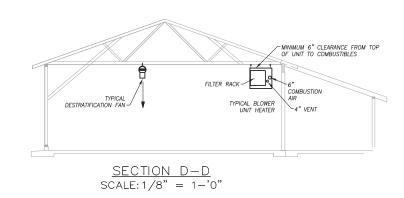

	0'	2'	4'	6'	8'	16'	24'	32'
1/-0								

No. Revision By Date

CONSULTANT PROJECT MANAGER: KFM

By Date

By Date

Designed KFM 02/18 Checked KFM 02/18

Drawn KFM 02/18 In Charge of

HNTB CORPORATION 340 County Road, Suite 6-C Westbrook, ME 04092 TEL (207) 774-5155 FAX (207) 228-0909



THE GOLD STAR MEMORIAL HIGHWAY MAINTENANCE GARAGE EXTENSIONS
KENNEBUNK #2
MECHANICAL PLAN VIEW

SHEET NUMBER: M3
CONTRACT: 2018.14 21 OF 2

### GENERAL NOTES

- 1. All systems are to be to meet the following Codes and Standards 1.1. ASHRAE 90.1 2007 Energy Standard for Commercial
- Buildings.
  1.2. ASHRAE 60.1 2007 Standard for Indoor Air Quality in
- Commercial Buildings.

  1.3. 2009 IECC International Energy Conservation Code.

  1.4. NFPA National Fire Protection Association Standards.
- 2. Do not cut any structural members without pre-approval of structural engineer.

### SHEETMETAL NOTES

- All ductwork to be fabricated and installed per SMACNA Low Pressure Ductwork Standards.
- Ductwork is shown diagrammatically and does not indicate all the offsets, rises and drops that will be required.
- 3. All ductwork is within the Building Thermal Envelope and will not

### VENTING, COMBUSTION AIR AND CONDENSATE NOTES

- Piping is shown diagrammatically and does not indicate all the offsets, rises and drops that will be required.
- 2. All condensate piping to be Schedule 40 PVC.
- 3. All venting and combustion air piping to be Schedule 40 PVC.
- All venting, combustion air and condensate piping to be installed per manufacturers recommendations and requirements for horizontal venting.


### CONTROL NOTES

- 1. It will be the Mechanical Contractor's responsibility to provide and install all controls and all control wiring.
- All control wiring that is run exposed shall be in electrical conduit provided and installed by the mechanical contractor (or his ATC subcontractor)..
- 3. Blower Unit Heaters (BUH) to have 24v heating only thermostats.
- 4. Control for the Destratification Fans (DF) to be provided by the Mechanical Contractor including Potentiometer Speed Control, control wiring and conduit.

### **DEMOLITION NOTES**

- It will be the mechanical contractor's to remove from the jobsite all existing mechanical related items that will no longer be in service.
- 2. Items to be removed include (but are not limited to):
- 2.1. Air Handler / Warm Air Furnace
  2.2. All ductwork, registers and grilles associated with the Air Handler / Warm air furnace.
- Furnace breeching from furnace to masonry chimney.
   Thermostats and related control wiring.
- 3. All removed items to be disposed of per EPA Standards.

### **LEGEND** FLEXIBLE CONNECTOIR DRUM LOUVER DIFFUSER J.....L DOUBLE DEFLECTION DIFFUSER MANUAL DAMPER W/LOCKING QUADRATN SIDE TAKE-OFF WITH VOLUME DAMPER 1 (SC) SPEED CONTROL

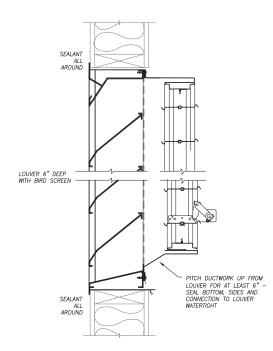

EXTERIOR LOUVER DETAIL NO SCALE

#### DESTRATIFICATION & EXHAUST FAN SCHEDULE DESIGN MANUFACTURER & MODEL WEIGHT CONTROL 115/60/1 2.2 ARILIS AIR PEAR 45-FL FCM MOTOR - GRAY COLOR 115/60/1 2.2 ARIUS AIR PEAR 45-EL CEILING HUNG 0-1180 14 LBS ECM MOTOR - GRAY COLOR IRIUS POT-1 POTENTIOMETER SPEED CONTROL FOR MULTIPLI

ECM MOTOR - GRAY COLOR


WITH WALL COLLAR,115V MOTORIZED DAMPER, MOTOR SIDE GUARD AND EXTERIOR 45 DEG. WEATHER HOOD

					BLO'	WER	U١	1IT	HEATI	ER SO	CHEDULE
TAG	DESIGN MANUFACTURER & MODEL	BTUH INPUT	BTUH OUTPUT	AFUE	FUEL	CFM	E.S.P.	MOTOR HP	POWER	WEIGHT	REMARKS
BUH-1	MODINE EFFINTY BTC310	310,000	257,000	93 %	NAT. GAS	4,500	0.50"	2.0	230/60/1	395 LBS	CONDENSING TYPE - SEALED COMBUSTION WITH FACTORY BLOWER ENCLOSURE, FILTER RACK, CONCENTRIC
BUH-2	MODINE EFFINTY BTC310	310,000	257,000	93 %	NAT. GAS	4,500	0.50"	2.0	230/60/1	395 LBS	HORIZONTAL VENT KIT, AND 24V CONTROL CIRCUIT

				Alf	R TERMINAL SCHEDULE
TAG	DESIGN MANUFACTURER & MODEL	SIZE	MAX NC	MAX SP	REMARKS
DL1	PRICE HCD 12/48	48"X12"	30	.07	HIGH CAPACITY DRUM LOUVER DIFFUSER WITH VERTICAL VANES AND OPPOSED BLADE DAMPER
DL3	PRICE HCD 16/24	24"X6"	30	.07	HIGH CAPACITY DRUM LOUVER DIFFUSER WITH VERTICAL VANES AND OPPOSED BLADE DAMPER

14 LBS

150 LBS

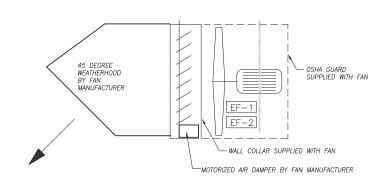

KENNEBUNK #2

115/60/1 2.2

115/60/1

CEILING HUNG 0-1180


SIDEWALL

8,600

ARIUS AIR PEAR 45-EL

GREENHECK S2-30-610b10

EXHAUST FAN DETAIL SECTION NO SCALE

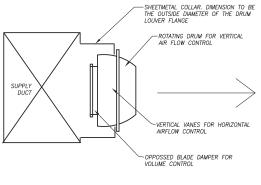

WALL STARTER POWERING FAN AND LOUVER

DRUM LOUVER DETAIL NO SCALE

CONTRACT: 2018.14




Scale: De				Designed b	y:				
No.	Revision	Ву	Date				<b>ITB</b>		
110.	IVENISION	L Dy	Date						
				CONSULTANT	PROJEC	CT MANAGER:	KFM		
					Ву	Date		Ву	Date
				Designed	KFM	02/18	Checked	KFM	02/18
				Drawn	KFM	02/18	In Charge of		


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THE GOLD STAR **MEMORIAL HIGHWAY**  MAINTENANCE GARAGE EXTENSIONS KENNEBUNK #2 SCHEDULES, NOTES & DETAILS


SHEET NUMBER: M4




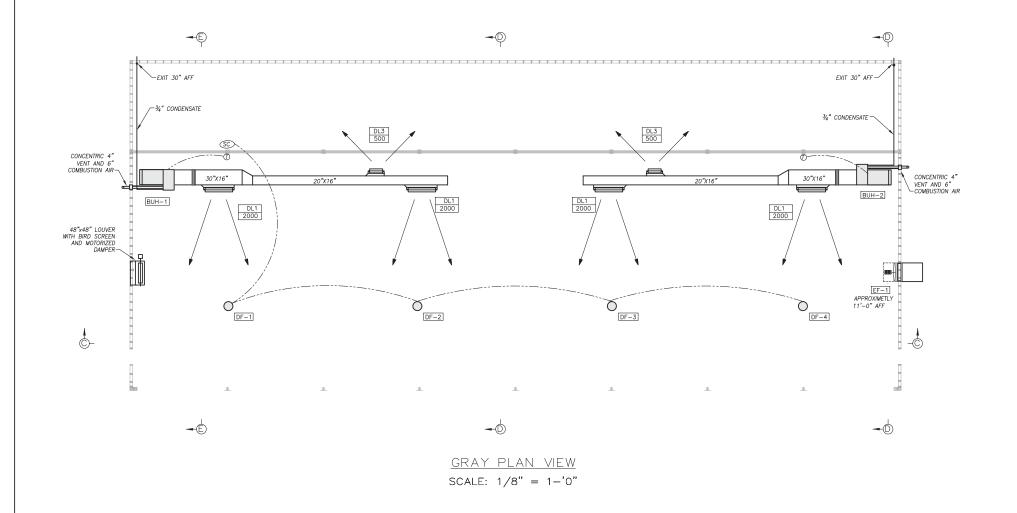


SECTION THROUGH BLOWER UNIT HEATER

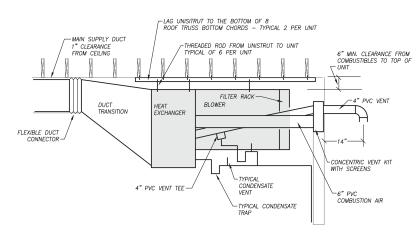SCALE: 1/2" = 1-'0"

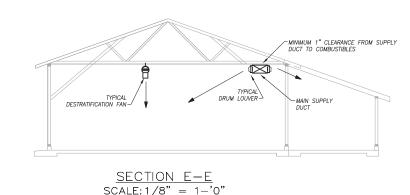

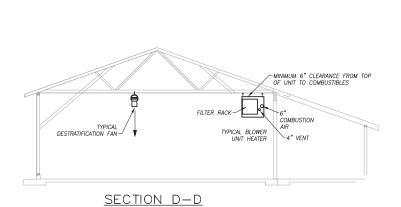

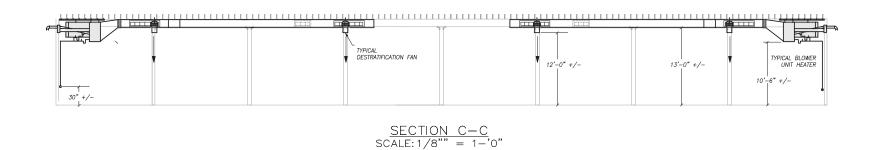



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MTA PROJECT MANAGER: BRIAN TADDEO, PE

STAR
IGHWAY

MAINTENANCE GARAGE EXTENSIONS
GRAY

SCALE: 1/8" = 1-'0"

MECHANICAL PLAN VIEW

SHEET NUMBER: M5
CONTRACT: 2018.14 23 OF 27

### GENERAL NOTES

- 1. All systems are to be to meet the following Codes and Standards. 1.1. ASHRAE 90.1 2007 Energy Standard for Commercial
- Buildings.
  1.2. ASHRAE 60.1 2007 Standard for Indoor Air Quality in
- 1.2. ASTRING UNIT 2007
  Commercial Buildings.
  1.3. 2009 IECC International Energy Conservation Code.
  1.4. NFPA National Fire Protection Association Standards.
- 2. Do not cut any structural members without pre-approval of

### SHEETMETAL NOTES

- 1. All ductwork to be fabricated and installed per SMACNA Low Pressure Ductwork Standards.
- Ductwork is shown diagrammatically and does not indicate all the offsets, rises and drops that will be required.
- 3. All ductwork is within the Building Thermal Envelope and will not

### VENTING, COMBUSTION AIR AND CONDENSATE NOTES

- Piping is shown diagrammatically and does not indicate all the offsets, rises and drops that will be required.
- 2. All condensate piping to be Schedule 40 PVC.
- 3. All venting and combustion air piping to be Schedule 40 PVC.
- All venting, combustion air and condensate piping to be installed per manufacturers recommendations and requirements for horizontal venting.

### CONTROL NOTES


- 1. It will be the Mechanical Contractor's responsibility to provide and install all controls and all control wiring.
- All control wiring that is run exposed shall be in electrical conduit provided and installed by the mechanical contractor (or his ATC subcontractor)..
- 3. Blower Unit Heaters (BUH) to have 24v heating only thermostats.
- 4. Control for the Destratification Fans (DF) to be provided by the Mechanical Contractor including Potentiometer Speed Control, control wiring and conduit.

### **DEMOLITION NOTES**

- It will be the mechanical contractor's to remove from the jobsite all existing mechanical related items that will no longer be in
- 2. Items to be removed include (but are not limited to):
  2.1. Air Handler / Warm Air Furnace
  2.2. All ductwork, registers and grilles associated with the Air Handler / Warm air furnace.
  2.3. Furnace breeching from furnace to masonry chimney.
  2.4. Thermostats and related control wiring.
- 3. All removed items to be disposed of per EPA Standards.

### **LEGEND** FLEXIBLE CONNECTOIR DRUM LOUVER DIFFUSER J.....L DOUBLE DEFLECTION DIFFUSER MANUAL DAMPER W/LOCKING QUADRATN SIDE TAKE-OFF WITH VOLUME DAMPER $\bigcirc$ THERMOSTAT

SPEED CONTROL

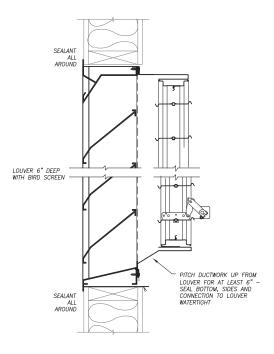


EXTERIOR LOUVER DETAIL NO SCALE

## GRAY


			DE	STRA	ΓIFΙ	CA	ΓΙΟΝ	& EXHAUST FAN SCHEDULE				
TAG	DESIGN MANUFACTURER & MODEL	TYPE	CFM	POWER	CTRIC FLA	HP	WEIGHT	REMARKS	CONTROL			
DF-1	ARIUS AIR PEAR 45-EL	CEILING HUNG	0-1180	115/60/1	2.2	Ħ	14 LBS	ECM MOTOR — GRAY COLOR				
DF-2	ARIUS AIR PEAR 45-EL	CEILING HUNG	0-1180	115/60/1	2.2		14 LBS	ECM MOTOR - GRAY COLOR	AIRIUS POT-1 POTENTIOMETER SPEED CONTROL FOR MULTIPI			
DF-3	ARIUS AIR PEAR 45-EL	CEILING HUNG	0-1180	115/60/1	2.2		14 LBS	ECM MOTOR - GRAY COLOR	EC MOTORS			
DF-4	ARIUS AIR PEAR 45-EL	CEILING HUNG	0-1180	115/60/1	2.2		14 LBS	ECM MOTOR - GRAY COLOR				
EF-1	GREENHECK S2-30-610b10	SIDEWALL	8,600	115/60/1		1.0	150 LBS	WITH WALL COLLAR,115V MOTORIZED DAMPER, MOTOR SIDE GUARD AND EXTERIOR 45 DEG. WEATHER HOOD	WALL STARTER POWERING FAN AND LOUVER			

		BLOWER UNIT HEATER SCHEDULE									
TAG	DESIGN MANUFACTURER & MODEL	BTUH INPUT	BTUH OUTPUT	AFUE	FUEL	CFM	E.S.P.	MOTOR HP	POWER	WEIGHT	REMARKS
BUH-1	MODINE EFFINTY BTC310	310,000	257,000	93 %	LP GAS	4,500	0.50"	2.0	230/60/1	395 LBS	CONDENSING TYPE - SEALED COMBUSTION WITH FACTORY BLOWER ENCLOSURE, FILTER RACK, CONCENTRIC
BUH-2	MODINE EFFINTY BTC310	310,000	257,000	93 %	LP GAS	4,500	0.50"	2.0	230/60/1	395 LBS	HORIZONTAL VENT KIT, AND 24V CONTROL CIRCUIT

				Alf	R TERMINAL SCHEDULE
TAG	DESIGN MANUFACTURER & MODEL	SIZE	MAX NC	MAX SP	REMARKS
DL1	PRICE HCD 12/48	48"X12"	30	.07	HIGH CAPACITY DRUM LOUVER DIFFUSER WITH VERTICAL VANES AND OPPOSED BLADE DAMPER
DL3	PRICE HCD 16/24	24"X6"	30	.07	HIGH CAPACITY DRUM LOUVER DIFFUSER WITH VERTICAL VANES AND OPPOSED BLADE DAMPER

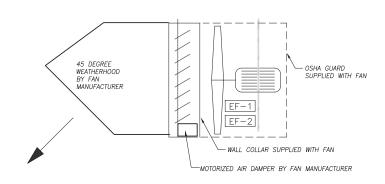

EXHAUST FAN DETAIL SECTION NO SCALE

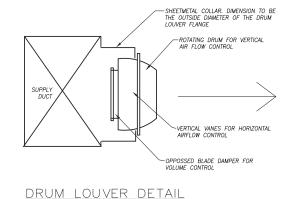

NO SCALE



Scale: Designed by: By Date Revision CONSULTANT PROJECT MANAGER: KFM Date Checked KFM 02/18


HNTB CORPORATION 340 County Road, Suite 6-C Westbrook, ME 04092 TEL (207) 774-5155 FAX (207) 228-0909




MAINTENANCE GARAGE EXTENSIONS GRAY SCHEDULES, NOTES & DETAILS

CONTRACT: 2018.14


SHEET NUMBER: M6

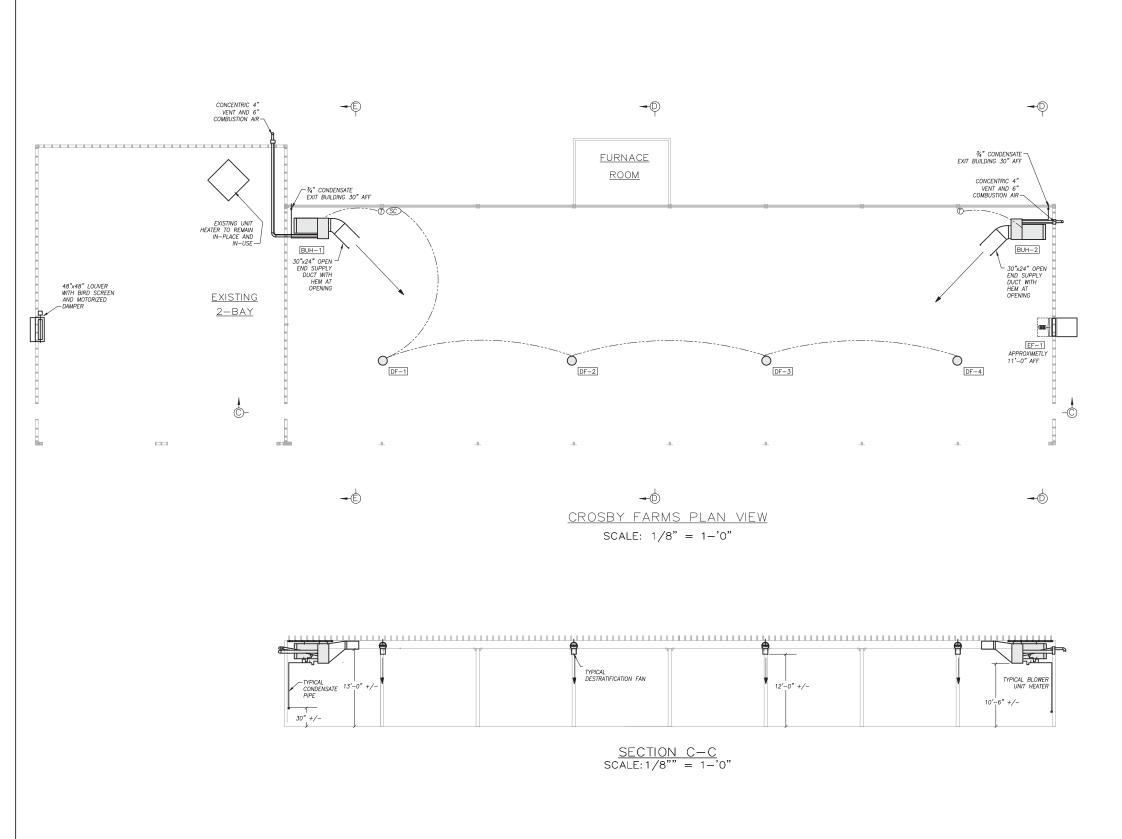

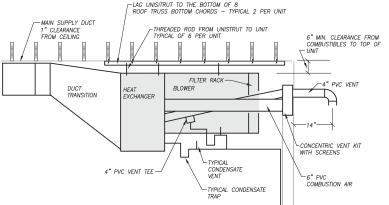


SECTION THROUGH BLOWER UNIT HEATER

SCALE: 1/2" = 1-'0"

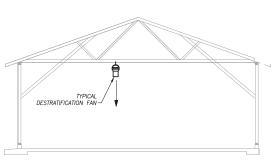

 $\frac{\text{SECTION }E-E}{\text{SCALE: }1/8" = 1-0"}$ 

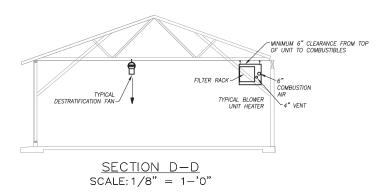



No. Revision By Date

CONSULTANT PROJECT MANAGER: KFM

By Date

By Date

Designed KFM 02/18 Checked KFM 02/18

Drawn KFM 02/18 In Charge of

HNTB CORPORATION 340 County Road, Suite 6-C Westbrook, ME 04092 TEL (207) 774-5155 FAX (207) 228-0909



THE GOLD STAR MEMORIAL HIGHWAY MAINTENANCE GARAGE EXTENSIONS
CROSBY FARMS
MECHANICAL PLAN VIEW

SHEET NUMBER: M7
CONTRACT: 2018.14 25 OF 2

### GENERAL NOTES

- All systems are to be to meet the following Codes and Standards.

  1. ASHRAE 90.1 2007 Energy Standard for Commercial
- Buildings.
  1.2. ASHRAE 60.1 2007 Standard for Indoor Air Quality in
- Commercial Buildings.

  1.3. 2009 IECC International Energy Conservation Code.

  1.4. NFPA National Fire Protection Association Standards.
- Do not cut any structural members without pre-approval of structural engineer.

### SHEETMETAL NOTES

- All ductwork to be fabricated and installed per SMACNA Low Pressure Ductwork Standards.
- Ductwork is shown diagrammatically and does not indicate all the offsets, rises and drops that will be required.
- 3. All ductwork is within the Building Thermal Envelope and will not

### VENTING, COMBUSTION AIR AND CONDENSATE NOTES

- Piping is shown diagrammatically and does not indicate all the offsets, rises and drops that will be required.
- 2. All condensate piping to be Schedule 40 PVC.
- 3. All venting and combustion air piping to be Schedule 40 PVC.
- All venting, combustion air and condensate piping to be installed per manufacturers recommendations and requirements for horizontal venting.

### CONTROL NOTES

- It will be the Mechanical Contractor's responsibility to provide and install all controls and all control wiring.
- All control wiring that is run exposed shall be in electrical conduit provided and installed by the mechanical contractor (or his ATC subcontractor)..
- 3. Blower Unit Heaters (BUH) to have 24v heating only thermostats.
- 4. Control for the Destratification Fans (DF) to be provided by the Mechanical Contractor including Potentiometer Speed Control, control wiring and conduit.


### **DEMOLITION NOTES**


- 1. It will be the mechanical contractor's to remove from the jobsite all existing mechanical related items that will no longer be in service.
- 2. Items to be removed include (but are not limited to):

- 3. All removed items to be disposed of per EPA Standards.

# 2. Items to be removed include Gult are not limited to): 2.1. Air Handler / Warm Air Furnace 2.2. All ductwork, registers and grilles associated with the Air Handler / Warm air furnace. 2.3. Furnace breeching from furnace to masonry chimney. 2.4. Thermostats and related control wiring.


### CROSBY FARMS

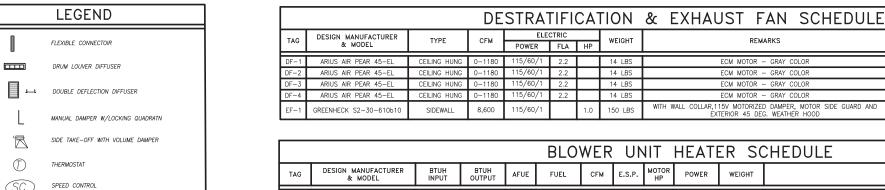

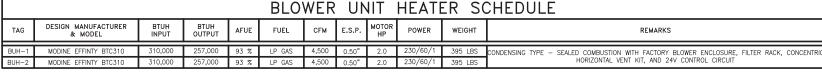


REMARKS

ECM MOTOR - GRAY COLOR

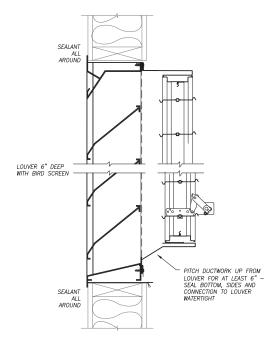

EXTERIOR LOUVER DETAIL NO SCALE

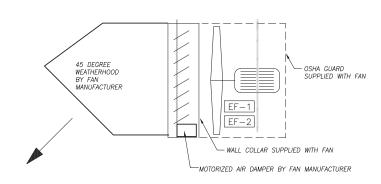

EXHAUST FAN DETAIL SECTION



Scale:		Designed b	y:						
No.	Revision	By	Date	1					
				CONSULTANT	PROJEC	CT MANAGER:	KFM		
					Ву	Date		Ву	Date
				Designed	KFM	02/18	Checked	KFM	02/18
				Drawn	IZEM	02/18	In Charge of		

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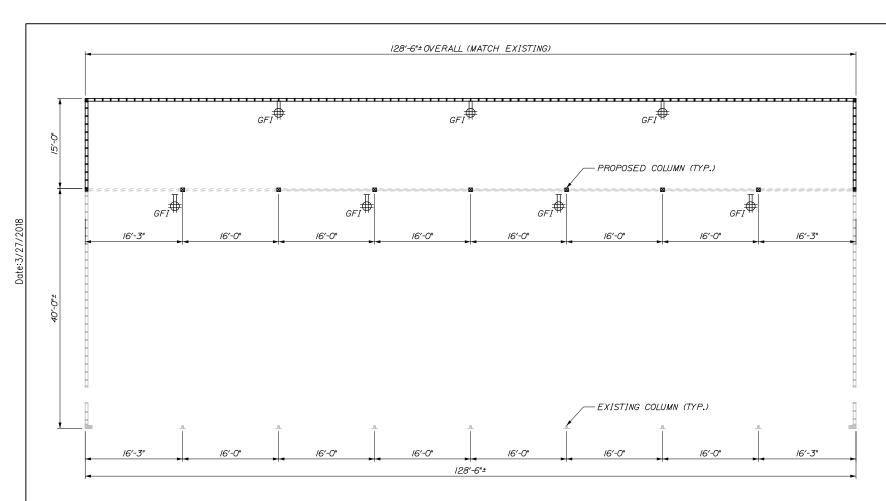
MAINTENANCE GARAGE EXTENSIONS CROSBY FARMS SCHEDULES, NOTES & DETAILS

SHEET NUMBER: M8 CONTRACT: 2018.14

CONTROL

IRIUS POT-1 POTENTIOMETER SPEED CONTROL FOR MULTIP

WALL STARTER POWERING FAN AND LOUVER



PROPOSED ELECTRICAL PLAN VIEW

SCALE: N.T.S.

### ELECTRICAL SYMBOLS:

NOT TO SCALE

<u>SYMBOL</u> <u>DESCRIPTION</u>

GE I

125V, 20A, QUAD GROUND FAULT RECEPTACLE

### **ELECTRICAL NOTES:**

I. ALL PROPOSED CONDUIT IN EXTENDED SECTION OF GARAGE SHALL BE SURFACE MOUNTED AND MATCH EXISTING FEEDER CONDUIT.

2. ALL RECEPTACLE BOXES SHALL BE SURFACE MOUNTED.

3. ONE EXTERIOR MOUNTED QUAD RECEPTACLE SHALL BE MOUNTED ON THE OUTSIDE OF EACH OF THE THREE 8-BAY GARAGES IN GRAY AND KENNEBUNK. THE RECEPTACLES WILL BE LOCATED BY A MTA MAINTENANCE REPRESENTATIVE.

4. ALL NEEDED ELECTRICAL WORK SHALL BE INCIDENTAL TO THE LUMP SUM BUILDING ITEM.

5. TWO (2) ADDITIONAL RECEPTACLES SHALL BE INSTALLED ON THE EXTERIOR OF EACH BUILDING. RECEPTACLES WILL BE FIELD LOCATED BY THE RESIDENT.

Scale:

| Designed by: | | Consultant Project Manager: Bruce Munger, PE | By Date | By

HNTB CORPORATION 340 County Road, Suite 6-C Westbrook, ME 04092 TEL (207) 774-5155 FAX (207) 228-0909



MAINTENANCE GARAGE EXTENSIONS

ELECTRICAL PLANS

SHEET NUMBER: E1

CONTRACT:2018.14

27 OF 27