LOCATION MAP

APPROVED:

MAINE TURNPIKE AUTHORITY



THE GOLD STAR **MEMORIAL HIGHWAY**

MAINE TURNPIKE AUTHORITY

DANIEL E. WATHEN, CHAIR MICHAEL J. CIANCHETTE, VICE CHAIR JANE L. LINCOLN, MEMBER ANDREW MCLEAN, MEMBER BETTYANN W. SHEATS, MEMBER
THOMAS J. ZUKE, MEMBER
BRUCE A. VAN NOTE, MEMBER EX-OFFICIO

S. PETER MILLS, EXECUTIVE DIRECTOR

CONTRACT 2024.01 PAVEMENT REHABILITATION EXITS 1, 2 & 3 MM 1.3 TO MM 6.8

> **BRIDGE REPAIRS** SPRUCE CREEK **MM 2.2**

BROADCAST SEALANT YORK RIVER BRIDGE MM 5.2



INDEX OF SHEETS SHEET NO. **DESCRIPTION** TITLE SHEET **ESTIMATED QUANTITIES GENERAL NOTES** TYPICAL SECTIONS MAINTENANCE OF TRAFFIC - GENERAL NOTES MAINTENANCE OF TRAFFIC - DETAILS MAINTENANCE OF TRAFFIC - ADVANCED PROJECT SIGNING MAINTENANCE OF TRAFFIC - RAMP CLOSURE PLANS MAINTENANCE OF TRAFFIC - SIGN SUMMARYS DRAINAGE DETAILS BERM DROPOFF CORRECTION AND MEDIAN RESTORATION DETAILS DRAINAGE PATH FOR MILLING DETAILS STRIPING DETAILS **GUARDRAIL DETAILS** RUMBLE STRIP DETAILS **GENERAL PLANS** I-95 OVER SPRUCE CREEK BRIDGE REPAIRS

10/31/23

SHEETS A1 - A34

11/1/23

ITEM	UNIT	PAVING	BRIDGE			1
		ATTIO	REPAIR	GUARDRAIL	DRAINAGE	TOTA
REMOVING EXISTING MANHOLE OR CATCH BASIN	EA				1	1
REMOVING PAVEMENT SURFACE	SY	78,900				78,90
REMOVING PAVEMENT SURFACE - BRIDGE DECK	SY		600			600
REMOVING PAVEMENT SURFACE - MAINLINE	SY	316,000				316,00
REMOVING PAVEMENT SURFACE - DRAINAGE PATHS	SF	150				150
RUMBLE STRIPS	EA	96,000				96,000
COMMON EXCAVATION	CY	6			10	16
MEDIAN RESTORATION	LF	10,400				10,400
HOT MIX ASPHALT, 12.5 mm (POLYMER/LATEX MODIFIED)	TON	36,700	58			36,75
HOT MIX ASPHALT, 12.5 mm (POLYMER/LATEX MODIFIED) - RAMPS	TON	1450				1450
HOT MIX ASPHALT, 9.5 mm, SHIMMING	TON	1100				1100
HOT MIX ASPHALT, 12.5 mm (BASE AND INTERMEDIATE BASE COURSE)	TON	3				3
BITUMINOUS TACK COAT NTSS - IHM TRACKLESS - APPLIED	GAL	24,600	24			24,62
SAWING BITUMINOUS PAVEMENT		300				300
ASPHALT RUBBER FIBER CRACK SEALER	LB	40,000				40,000
ASPHALT RUBBER MASTIC CRACK SEALER - APPLIED	LB	10,000				10,000
PAVEMENT CRACK REPAIR	LF	1950				1950
BITUMINOUS CONCRETE WATERWAY, TYPE I	EA	.550			4	1330
BITUMINOUS CONCRETE WATERWAY, TYPE II	EA				2	2
BERM DROPOFF CORRECTION - GRINDINGS	TON	900			_	900
BERM CORRECTION	LF	9000				9000
BERM CORRECTION - OUTSIDE	LF	8500				8500
	1.0					
REPLACE BRIDGE DRAIN (TYPE AI)	LS		4			4
INSTALL OR REPLACE BRIDGE DRAIN (TYPE B)	LS		6			6
PIGMENTED PROTECTIVE COATING FOR CONCRETE SURFACES	SY		350			350
CLEAR PROTECTIVE COATING FOR CONCRETE SURFACES	SY		130			130
BROADCAST SEALANT FOR CONCRETE SURFACES	SY		9100			9100
ABUTMENT REPAIRS	SF		110			110
REPAIRING GRANITE CURB JOINT AND BEDDING MORTAR	LF		35			35
EPOXY INJECTION CRACK REPAIR	LF		20			20
REPAIR OF OVERHEAD SURFACES <8 INCHES	SF		40			40
ELASTOMERIC CONCRETE	CF		10			10
ASPHALTIC PLUG JOINT (SPRUCE CREEK NB)	<u>LF</u>		125			125
ASPHALTIC PLUG JOINT (SPRUCE CREEK SB)	LF		125			125
EXPANSION DEVICE - SILICONE COATED AND PRE-COMPRESSED SEAL			50			50
BEARING REMOVAL AND INSTALLATION	EA		4			4
STEEL BEARINGS, FIXED, SLIDING PLATE	EA		2			2
STEEL BEARINGS, EXPANSION, SLIDING PLATE	EA		2			2
JACKING EXISTING SUPERSTRUCTURE (SPRUCE CREEK)	LS					
TEMPORARY CONCRETE BARRIER, TYPE I - SUPPLIED BY THE AUTHORITY	LS		,			,
WORK ZONE CRASH CUSHIONS - TL-3	UN		2			2
12 INCH REINFORCED CONCRETE PIPE - CLASS III	<u>LF</u>				16	16
12 INCH CULVERT PIPE OPTION III	LF				8	8
15 INCH CULVERT PIPE OPTION III	LF				16	16
18 INCH REINFORCED CONCRETE PIPE - CLASS III	LF				16	16
CONCRETE COLLAR	EA				3	3
CLEANING EXISTING CATCH BASIN AND MANHOLE	EA				60	60
REBUILD CATCH BASIN TO GRADE - TYPE II	EA				21	21
CATCH BASIN TYPE F5	EA				1	1
31" W-BEAM GUARDRAIL - MID-WAY SPLICE (7' STEEL POSTS, 8" OFFSET BLOCKS, SINGLE FACED)	LF			850		850
31" W-BEAM GUARDRAIL - MID-WAY SPLICE FLARED TERMINAL	EA			4		4
31" W-BEAM GUARDRAIL - MID-WAY SPLICE (7' STEEL POSTS, 8" OFFSET BLOCKS, DOUBLE FACED)	LF			990		990
31" W-BEAM GUARDRAIL - MID-WAY SPLICE TERMINAL END - ANCHORED END	EA			32		32
BRIDGE TRANSITION TYPE III	EA		1	_		1
GUARDRAIL BEAM			•	IOO		100
						640
3/" W-BE, 3/" W-BE, 3/" W-BE, BRIDGE GUARDR,	AM GUARDRAIL - MID-WAY SPLICE FLARED TERMINAL AM GUARDRAIL - MID-WAY SPLICE (7' STEEL POSTS, 8" OFFSET BLOCKS, DOUBLE FACED) AM GUARDRAIL - MID-WAY SPLICE TERMINAL END - ANCHORED END TRANSITION TYPE III	AM GUARDRAIL - MID-WAY SPLICE FLARED TERMINAL AM GUARDRAIL - MID-WAY SPLICE (7' STEEL POSTS, 8" OFFSET BLOCKS, DOUBLE FACED) LF AM GUARDRAIL - MID-WAY SPLICE TERMINAL END - ANCHORED END EA TRANSITION TYPE III EA LF	AM GUARDRAIL - MID-WAY SPLICE FLARED TERMINAL AM GUARDRAIL - MID-WAY SPLICE (7' STEEL POSTS, 8" OFFSET BLOCKS, DOUBLE FACED) AM GUARDRAIL - MID-WAY SPLICE TERMINAL END - ANCHORED END EA TRANSITION TYPE III AIL BEAM LF	AM GUARDRAIL - MID-WAY SPLICE FLARED TERMINAL AM GUARDRAIL - MID-WAY SPLICE (7' STEEL POSTS, 8" OFFSET BLOCKS, DOUBLE FACED) AM GUARDRAIL - MID-WAY SPLICE TERMINAL END - ANCHORED END TRANSITION TYPE III AIL BEAM LF	AM GUARDRAIL - MID-WAY SPLICE FLARED TERMINAL AM GUARDRAIL - MID-WAY SPLICE (7' STEEL POSTS, 8" OFFSET BLOCKS, DOUBLE FACED) AM GUARDRAIL - MID-WAY SPLICE TERMINAL END - ANCHORED END EA TRANSITION TYPE III AIL BEAM III 100	AM GUARDRAIL - MID-WAY SPLICE FLARED TERMINAL AM GUARDRAIL - MID-WAY SPLICE (7' STEEL POSTS, 8" OFFSET BLOCKS, DOUBLE FACED) AM GUARDRAIL - MID-WAY SPLICE TERMINAL END - ANCHORED END TRANSITION TYPE III AIL BEAM EA 4 990 EA I 100

	ESTIMATED QUANTITIES		1	221225			
ITEM NO.	ITEM	UNIT	PAVING	BRIDGE REPAIR	GUARDRAIL	DRAINAGE	TOTA
606.356	UNDERDRAIN DELINEATOR POST	EA			40	7	47
606 . 3621	GUARDRAIL ADJUST, SINGLE RAIL	LF			15,700		15,700
506 . 3622	GUARDRAIL ADJUST, DOUBLE RAIL	LF			11,400		11,400
506 . 471	SINGLE OFFSET BLOCK - W BEAM	EA			40		40
606.48	SINGLE GALVANIZED STEEL POST	EA			10		10
606.701	ASYMMETRIC THRIE BEAM TRANSITION	EA			5		5
609.40	RESET CURB TYPE 5	LF	70				70
610.08	PLAIN RIPRAP	CY				25	25
613.319	EROSION CONTROL BLANKET	SY	12,100				12,10
618.14	SEEDING METHOD NUMBER 2	UNIT	210				210
619.1201	MULCH - PLAN QUANTITY	UNIT	210				210
619.1202	TEMPORARY MULCH	LS	1				
620.58	EROSION CONTROL GEOTEXTILE	SY	-			71	71
627.73	TEMPORORY 6 INCH PAVEMENT MARKING TAPE		31,100				31,100
627 . 731	TEMPORORY 6 INCH BLACK PAVEMENT MARKING TAPE	LF	1150				1150
627 . 78	TEMPORARY PAVEMENT MARKING LINE, WHITE OR YELLOW	LF	275,000				275,00
627 . 812	TEMPORARY RAISED PAVEMENT MARKERS	EA	13,900				13,90
627 . 94	PAVEMENT MARKING TAPE	LF	3700				3700
627 . 941	PAVEMENT MARKING TAPE - DOTTED WHITE LANE LINE, 6-INCH WIDTH	LF	1600				1600
<i>629.05</i>	HAND LABOR, STRAIGHT TIME	HR	40				40
631 . 10	AIR COMPRESSOR (INCLUDING OPERATOR)	HR	70	40			40
631 . 11	AIR TOOL (INCLUDING OPERATOR)	HR		40			40
631 . 11 631 . 12	ALL PURPOSE EXCAVATOR (INCLUDING OPERATOR)	HR	40	70			40
		HR	20				20
631.133	SKID STEER (INCLUDING OPERATOR)						
631.171	TRUCK - SMALL (INCLUDING OPERATOR)	HR	40				40
631.172	TRUCK - LARGE (INCLUDING OPERATOR)	HR	20				20
631.22	FRONT END LOADER (INCLUDING OPERATOR)	HR	20				20
631.32	CULVERT CLEANER (INCLUDING OPERATOR)	HR	40				40
631.36	FOREMAN	HR	40				40
645,1099	REMOVE AND DISPOSE SIGN	EA	12				12
652.30	FLASHING ARROW	EA	7				7
652.312	TYPE III BARRICADES	EA	16				16
652.33	DRUM	EA	480				480
652.34	CONE	EA	425				425
<i>652.35</i>	CONSTRUCTION SIGNS	SF	5400				5 4 00
652.361	MAINTENANCE OF TRAFFIC CONTROL DEVICES	LS	0.84	0.10	0.05	0.01	1
652.38	FLAGGERS	HR	80				80
652 . 41	PORTABLE-CHANGEABLE MESSAGE SIGN	EA	9				9
652 . 4502	TRUCK MOUNTED ATTENUATOR	EA	3				3
652 . 4503	TRUCK MOUNTED ATTENUATOR	WEEK	26				26
652.47	SEQUENTIAL FLASHING WARNING LIGHTS	EA	270				270
656.50	BALED HAY, IN-PLACE	EA	50				50
656.60	TEMPORARY BERMS	LF	300				300
656.62	TEMPORARY SLOPE DRAINS	LF	30				30
656.632	30" TEMPORARY SILT FENCE	LF	100		100		200
656.751	TEMPORARY SOIL EROSION AND WATER POLLUTION CONTROL - SPRUCE CREEK	LS		1			1
659.10	MOBILIZATION	LS	0.84	0.10	0.05	0.01	1

ilename: ...\OO\HIGHWAY\MSTA_Estimat

No. Revision By Date

CONSULTANT PROJECT MANAGER: JOSEPH HOWE, P.E.

By Date

Designed by:

STANTEC CONSULTING SERVICES INC.

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THE GOLD STAR MEMORIAL HIGHWAY

PAVEMENT REHABILITATION
EXITS 1, 2 & 3 AND MM 1.3 TO MM 6.8

ESTIMATED QUANTITIES

SHEET NUMBER: EQ-01

MTA PROJECT MANAGER: RYAN BARNES, PE, CPESC

CONTRACT:2024.01 2 OF 40

- I. ALL WORK SHALL CONFORM TO THE 2014 MAINE DEPARTMENT OF TRANSPORTATION STANDARD SPECIFICATIONS FOR HIGHWAY AND BRIDGES, EXCEPT AS MODIFIED BY THE MAINE TURNPIKE AUTHORITY'S SUPPLEMENTAL SPECIFICATIONS AND SPECIAL PROVISIONS.
- 2. ALL DETAILS SHALL BE IN CONFORMANCE WITH MAINE DEPARTMENT OF TRANSPORTATION (MAINEDOT) STANDARD DETAILS HIGHWAYS AND BRIDGES, LATEST REVISION AND MAINEDOT BEST MANAGEMENT PRACTICES FOR EROSION AND SEDIMENT CONTROL LATEST REVISION UNLESS OTHERWISE INCLUDED IN THESE PLANS OR PROJECT SPECIFICATIONS.
- 3. ALL EXISTING ROADWAYS USED IN ACCESSING THE SITE SHALL REMAIN CLEAN IN ACCORDANCE WITH THE 2014 MAINEDOT STANDARD SPECIFICATIONS.
- 4. THE CONTRACTOR SHALL SUBMIT THE PROPOSED STAGING AREA(S) TO THE RESIDENT FOR APPROVAL PRIOR TO STARTING WORK.
- 5. BASELINES SHOWN ARE APPROXIMATE AND ARE FOR REFERENCE ONLY.
- 6. PAVE TO WITHIN LINCH OF FACE OF GUARDRAIL.
- 7. THE MAINE TURNPIKE AUTHORITY WILL FINAL STRIPE THE PROJECT.
- 8. THE CONTRACTOR IS RESPONSIBLE FOR LAYOUT OF THE FINAL PAVEMENT MARKINGS.
- 9. THE CONTRACTOR SHALL VERIFY EXISTING CROSS SLOPES OF EACH LANE AND SHOULDER AT LEAST EVERY 1/2 MILE AND PROVIDE CROSS SLOPE DATA TO THE RESIDENT AT LEAST 14 DAYS PROIR TO BEGINNING MILLING OF EACH ROADWAY.

EARTHWORK NOTES:

- I. EXCAVATIONS ACCOMPLISHED AS PART OF THIS PROJECT SHALL BE CONSTRUCTED IN ACCORDANCE WITH OSHA SUBPART P OF 29 CFR PART 1926.650-652 (CONSTRUCTION STANDARDS FOR EXCAVATION).
- 2. WASTE MATERIALS SHALL BE DISPOSED OF OFF THE PROJECT SITE, IN ACCORDANCE WITH CHAPTER 404, DEPARTMENT OF ENVIRONMENTAL PROTECTION SOLID WASTE MANAGEMENT RULES.

DRAINAGE NOTES:

- NO EXISTING DRAINAGE SHALL BE ABANDONED REMOVED OR PLUGGED WITHOUT APPROVAL OF THE RESIDENT.
- 2. EXISTING CATCH BASINS TO REMAIN SHALL BE CLEANED AS DIRECTED BY THE RESIDENT. PAYMENT WILL BE MADE UNDER ITEM 604,182 CLEANING EXISTING CATCH BASIN AND MANHOLE. EXISTING CULVERTS TO REMAIN SHALL BE CLEANED AS DIRECTED BY THE RESIDENT UNDER ITEM 631.32 CULVERT CLEANER (INCLUDING OPERATORS).
- 3. ONE GREEN DELINEATOR POST SHALL BE INSTALLED AT ALL UNDERDRAIN AND STORM DRAIN OUTLETS.
- 4. REMOVAL OF EXISTING DRAINAGE PIPES, AS NOTED ON THE PLANS. SHALL BE CONSIDERED INCIDENTAL TO ITEM 203.20 COMMON EXCAVATION.
- 5. ANY NECESSARY CUTTING OF EXISTING CATCH BASINS TO TAKE A PROPOSED PIPE WILL NOT BE PAID FOR SEPARATELY AND SHALL BE CONSIDERED INCIDENTAL TO THE PROPOSED CULVERT ITEMS.

UTILITY NOTES:

NOT TO SCALE

Revision


By Date

Designed

- EXISTING UTILITIES ON THESE PLANS WERE COMPILED FROM EXISTING PLANS AND VARIOUS OTHER SOURCES. LOCATIONS ARE NOT GUARANTEED TO BE ACCURATE NOR IS IT GUARANTEED THAT ALL UTILITIES ARE SHOWN, NO SEPARATE OR ADDITIONAL COMPENSATION WILL BE ALLOWED TO THE CONTRACTOR DUE TO ANY VARIANCE BETWEEN THE DATA SHOWN ON THE PLANS AND THE ACTUAL FIELD CONDITIONS ENCOUNTERED, THE CONTRACTOR IS REQUIRED TO CALL DIG SAFE AT 1-888-344-7233 AT LEAST 72 HOURS PRIOR TO THE START OF WORK, ALL PROPOSED SIGN AND EXCAVATION LOCATIONS SHALL BE MARKED AT THE NOTIFICATION TIME. THE RESIDENT ENGINEER SHALL BE PROVIDED AN ELECTRONIC COPY OF ALL DIG SAFE TICKETS WITHIN 24 HOURS OF THEIR RELEASE FOR PROJECT NOTIFICATIONS AND 3RD PARTY UTILITY LOCATOR COORDINATION.
- 2. THE CONTRACTOR SHALL NOTIFY ALL NON-MEMBERS THROUGH WWW.OKTODIG.COM OR AS OTHERWISE REQUIRED BY THE MAINE PUBLIC UTILITIES COMMISSION. ALL PROPOSED SIGN AND EXCAVATION LOCATIONS SHALL BE MARKED AT THE NOTIFICATION TIME. THE RESIDENT ENGINEER SHALL BE PROVIDED AN ELECTRONIC COPY OF ALL NON-MEMBER NOTIFICATIONS WITHIN 24 HOURS OF THEIR RELEASE
- 3. THE CONTRACTOR SHALL NOTIFY THE RESIDENT 10 CALENDAR DAYS PRIOR TO SUBMITTING ANY UTILITY LOCATE REQUESTS AS NOTED ABOVE SO THAT THE RESIDENT CAN ARRANGE FOR MAINE TURNPIKE UNDERGROUND UTILITY LOCATION. ALL PROPOSED SIGN AND EXCAVATION LOCATIONS SHALL BE MARKED AT THE NOTIFICATION TIME. NO EXCAVATION SHALL BE PERMITTED UNTIL THE AUTHORITY HAS LOCATED AND MARKED ITS UNDERGROUND UTILITIES.
- 4. FOLLOWING THE COMPLETION OF THE INITIAL UTILITY LOCATE THE CONTRACTOR WILL GPS LOCATE ALL UTILITIES WITHIN THE PROJECT LIMITS AND PROVIDE A COPY OF THE DIG SAFE RECORDS TO THE AUTHORITY. THE CONTRACTOR, ACTING AS THE AUTHORITY'S THIRD-PARTY LOCATOR, SHALL BE RESPONSIBLE FOR REMARKING ALL MAINE TURNPIKE FACILITIES WHEN A DIG SAFE UTILITY IS CALLED FOR THE PROJECT. THIS WORK SHALL BE CONSIDERED INCIDENTAL TO THE CONTRACT.

EROSION CONTROL NOTES:

- I. NEWLY DISTURBED EARTH SHALL BE MULCHED PRIOR TO A RAIN EVENT. THIS WORK SHALL BE PAID FOR UNDER ITEM 619,1202 TEMPORARY MULCH.
- 2. ALL TEMPORARY AND PERMANENT EROSION CONTROL DEVICES SHALL BE INSTALLED IN ACCORDANCE WITH THE MAINE DEPARTMENT OF TRANSPORTATION BEST MANAGEMENT PRACTICES.
- 3. EROSION CONTROL BLANKET, ITEM 613.319, SHALL BE INSTALLED IN ALL DITCHES AND SLOPES GREATER THAN 3:1 FROM TOP TO TOE OF SLOPE, LOAM AND SEED SHALL BE PLACED PRIOR TO THE INSTALLATION OF THE EROSION CONTROL BLANKET.
- 4. TEMPORARY STABILIZATION WITH MULCH OR OTHER NON-ERODABLE COVER IS REQUIRED ON ALL EXPOSED SOILS THAT WILL NOT BE WORKED FOR MORE THAN 7 DAYS, AREAS WITHIN 75 FEET OF A WETLAND OR WATERBODY SHALL BE STABILIZED WITHIN 48 HOURS OF THE INITIAL DISTURBANCE OF THE SOIL OR PRIOR TO ANY STORM EVENT, WHICHEVER COMES FIRST, THE CONTRACTOR IS RESPONSIBLE FOR APPLYING TEMPORARY MULCH AS NECESSARY, IN ACCORDANCE WITH THE LATEST EDITION OF THE BMP'S, TO MINIMIZE SOIL EROSION PRIOR TO THE APPLICATION OF THE FINAL SLOPE TREATMENT.
- 5. STABILIZED CONSTRUCTION ENTRANCES MUST BE USED AND MAINTAINED.NO TRACKING OF SOIL ON THE MAINE TURNPIKE OR LOCAL ROADS WILL BE ALLOWED.
- 6. A DOUBLE ROW OF SILT FENCE PROTECTION SHALL BE INSTALLED AT ALL STREAM LOCATIONS AND OPEN WATER WETLANDS.
- 7. UNLESS OTHERWISE NOTED; SEEDING METHOD NO. 2 SHALL BE UTILIZED ON ALL AREAS.
- ADDITIONAL MEASURES MAY BE PROPOSED BY THE CONTRACTOR DUE TO SITE OR WEATHER CONDITIONS. THE RESIDENT MAY DIRECT THE CONTRACTOR TO IMPLEMENT ADDITIONAL MEASURES, ANY ADDITIONAL MEASURES APPROVED BY THE RESIDENT WILL BE MEASURED FOR PAYMENT.

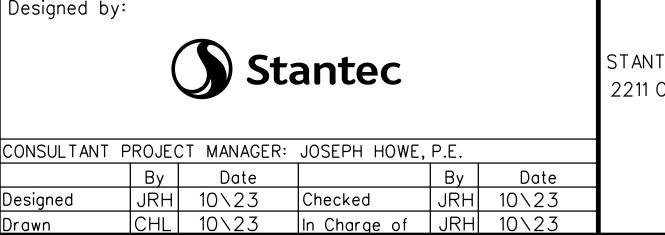

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THE GOLD STAR MEMORIAL HIGHWAY


PAVEMENT REHABILITATION EXITS 1, 2 & 3 AND MM 1.3 TO MM 6.8


GENERAL NOTES

SHEET NUMBER: GN-01

MTA PROJECT MANAGER: RYAN BARNES, PE. CPESC

CONTRACT:2024.01 3 OF 40

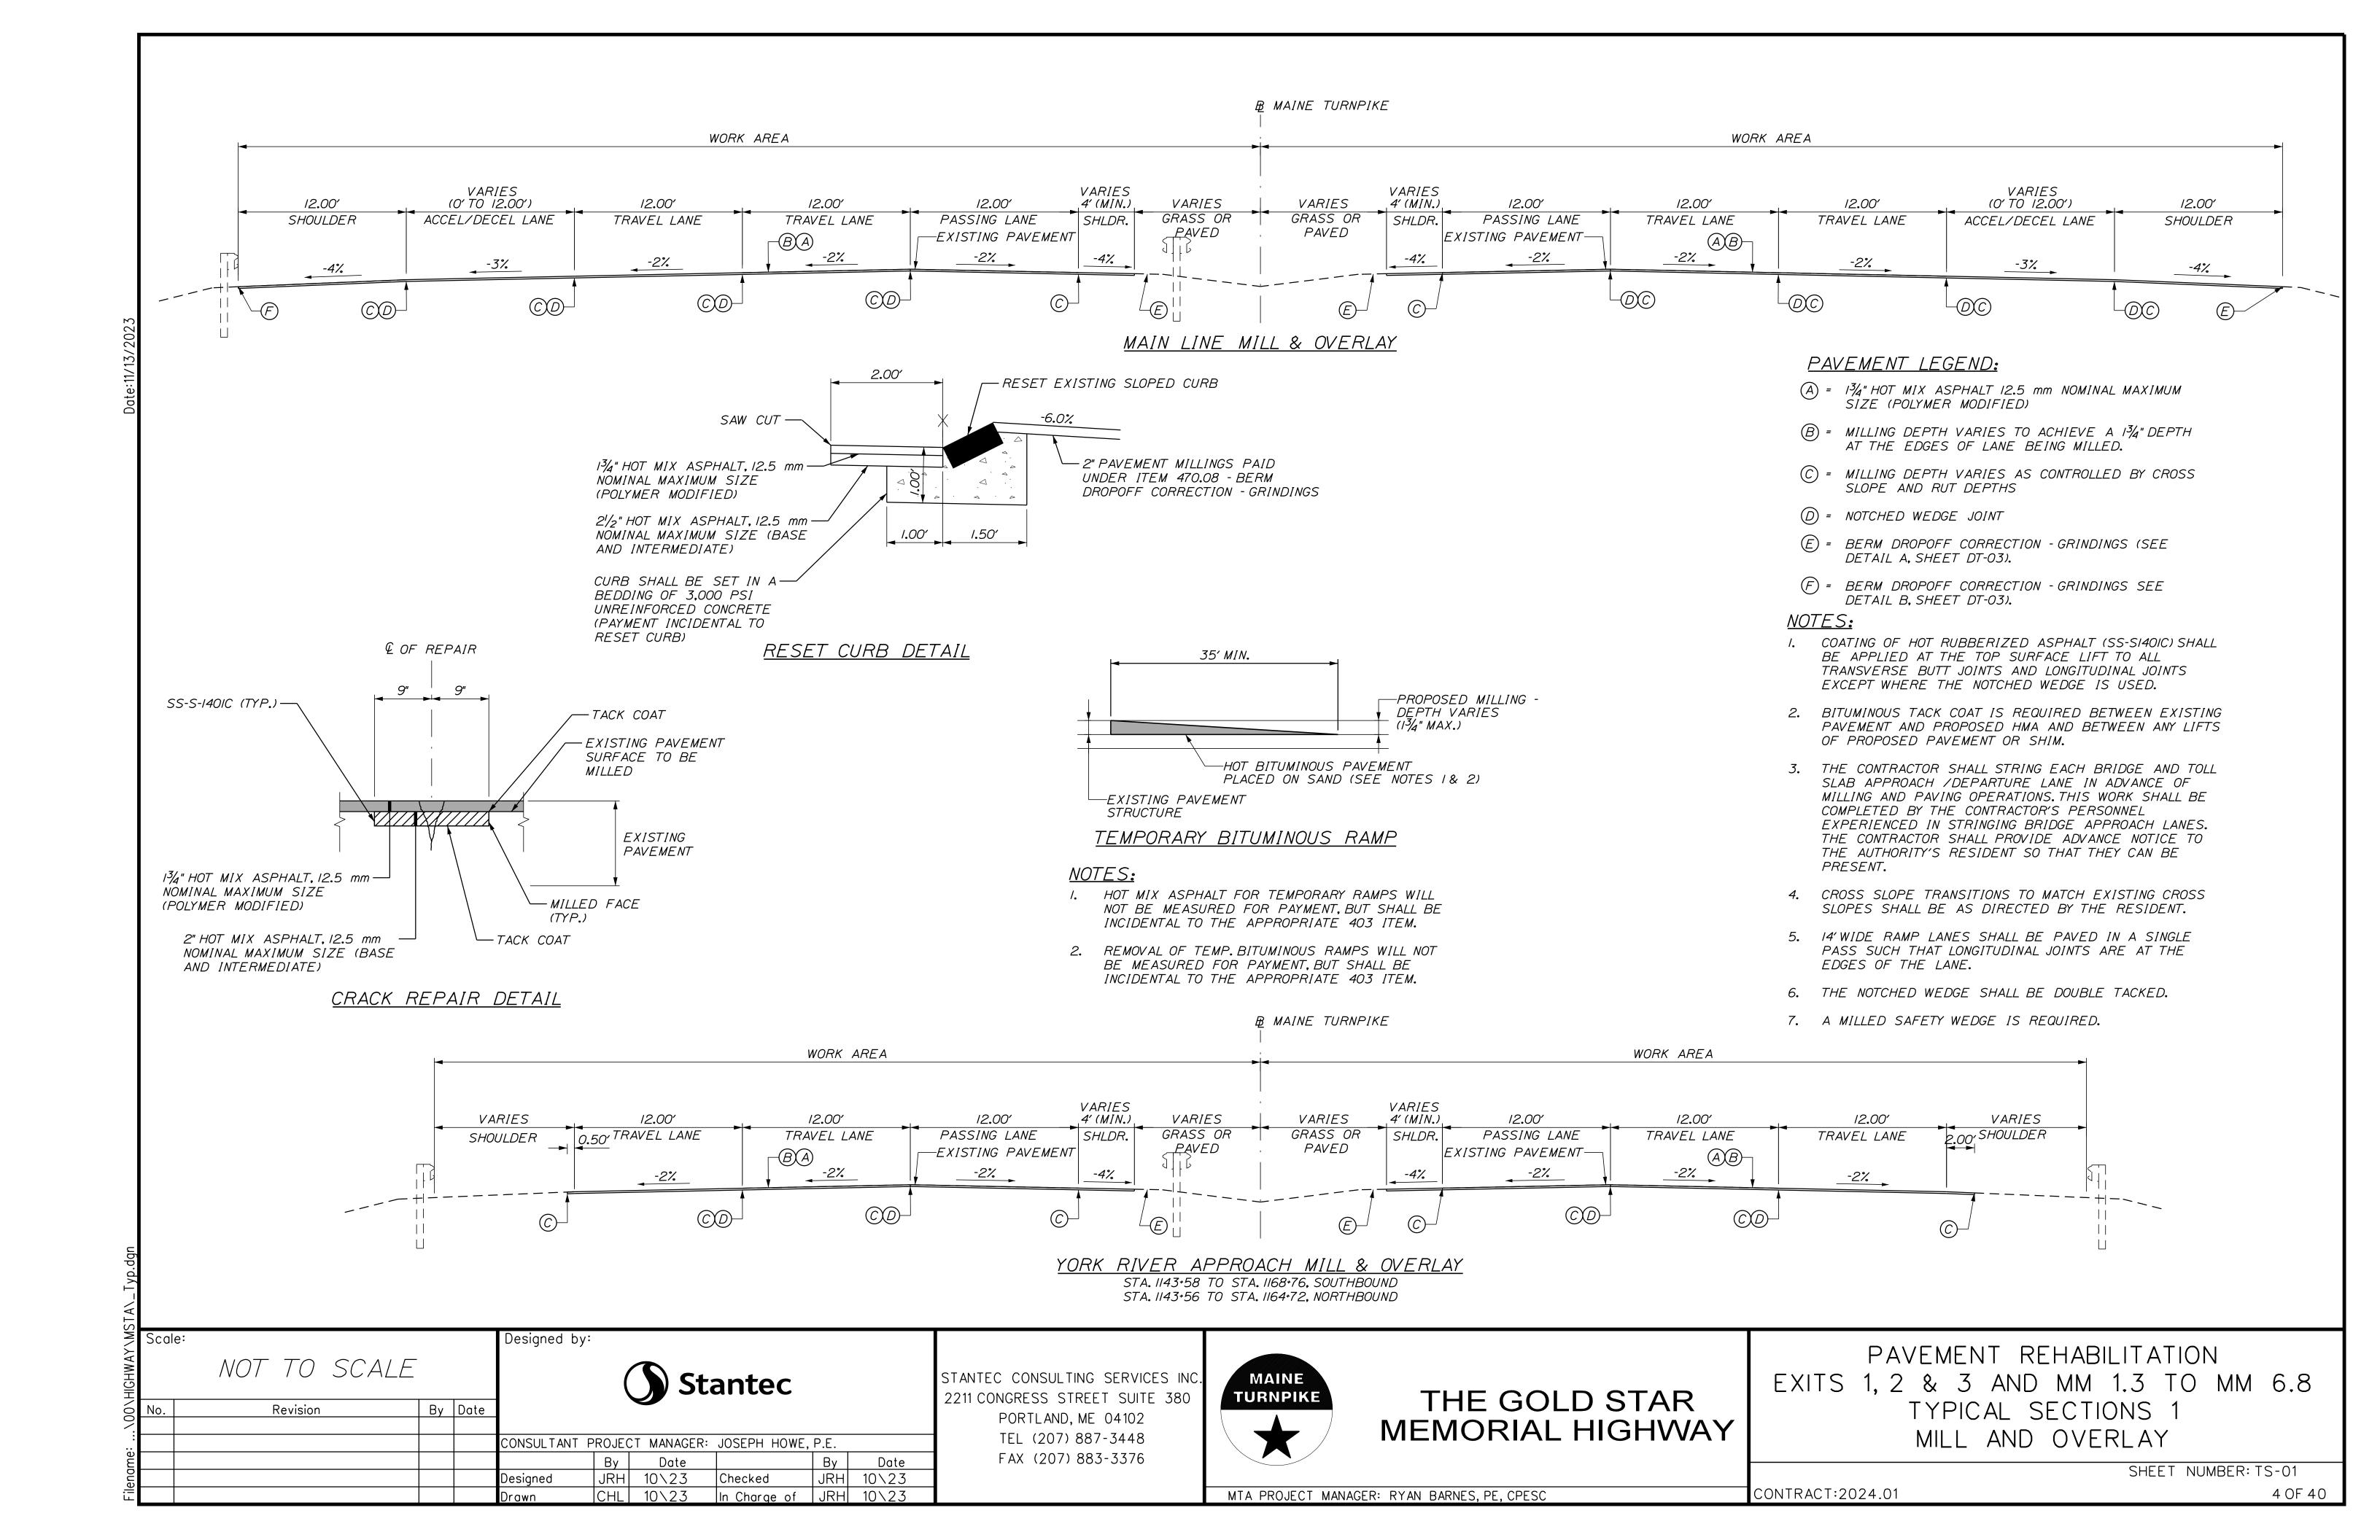

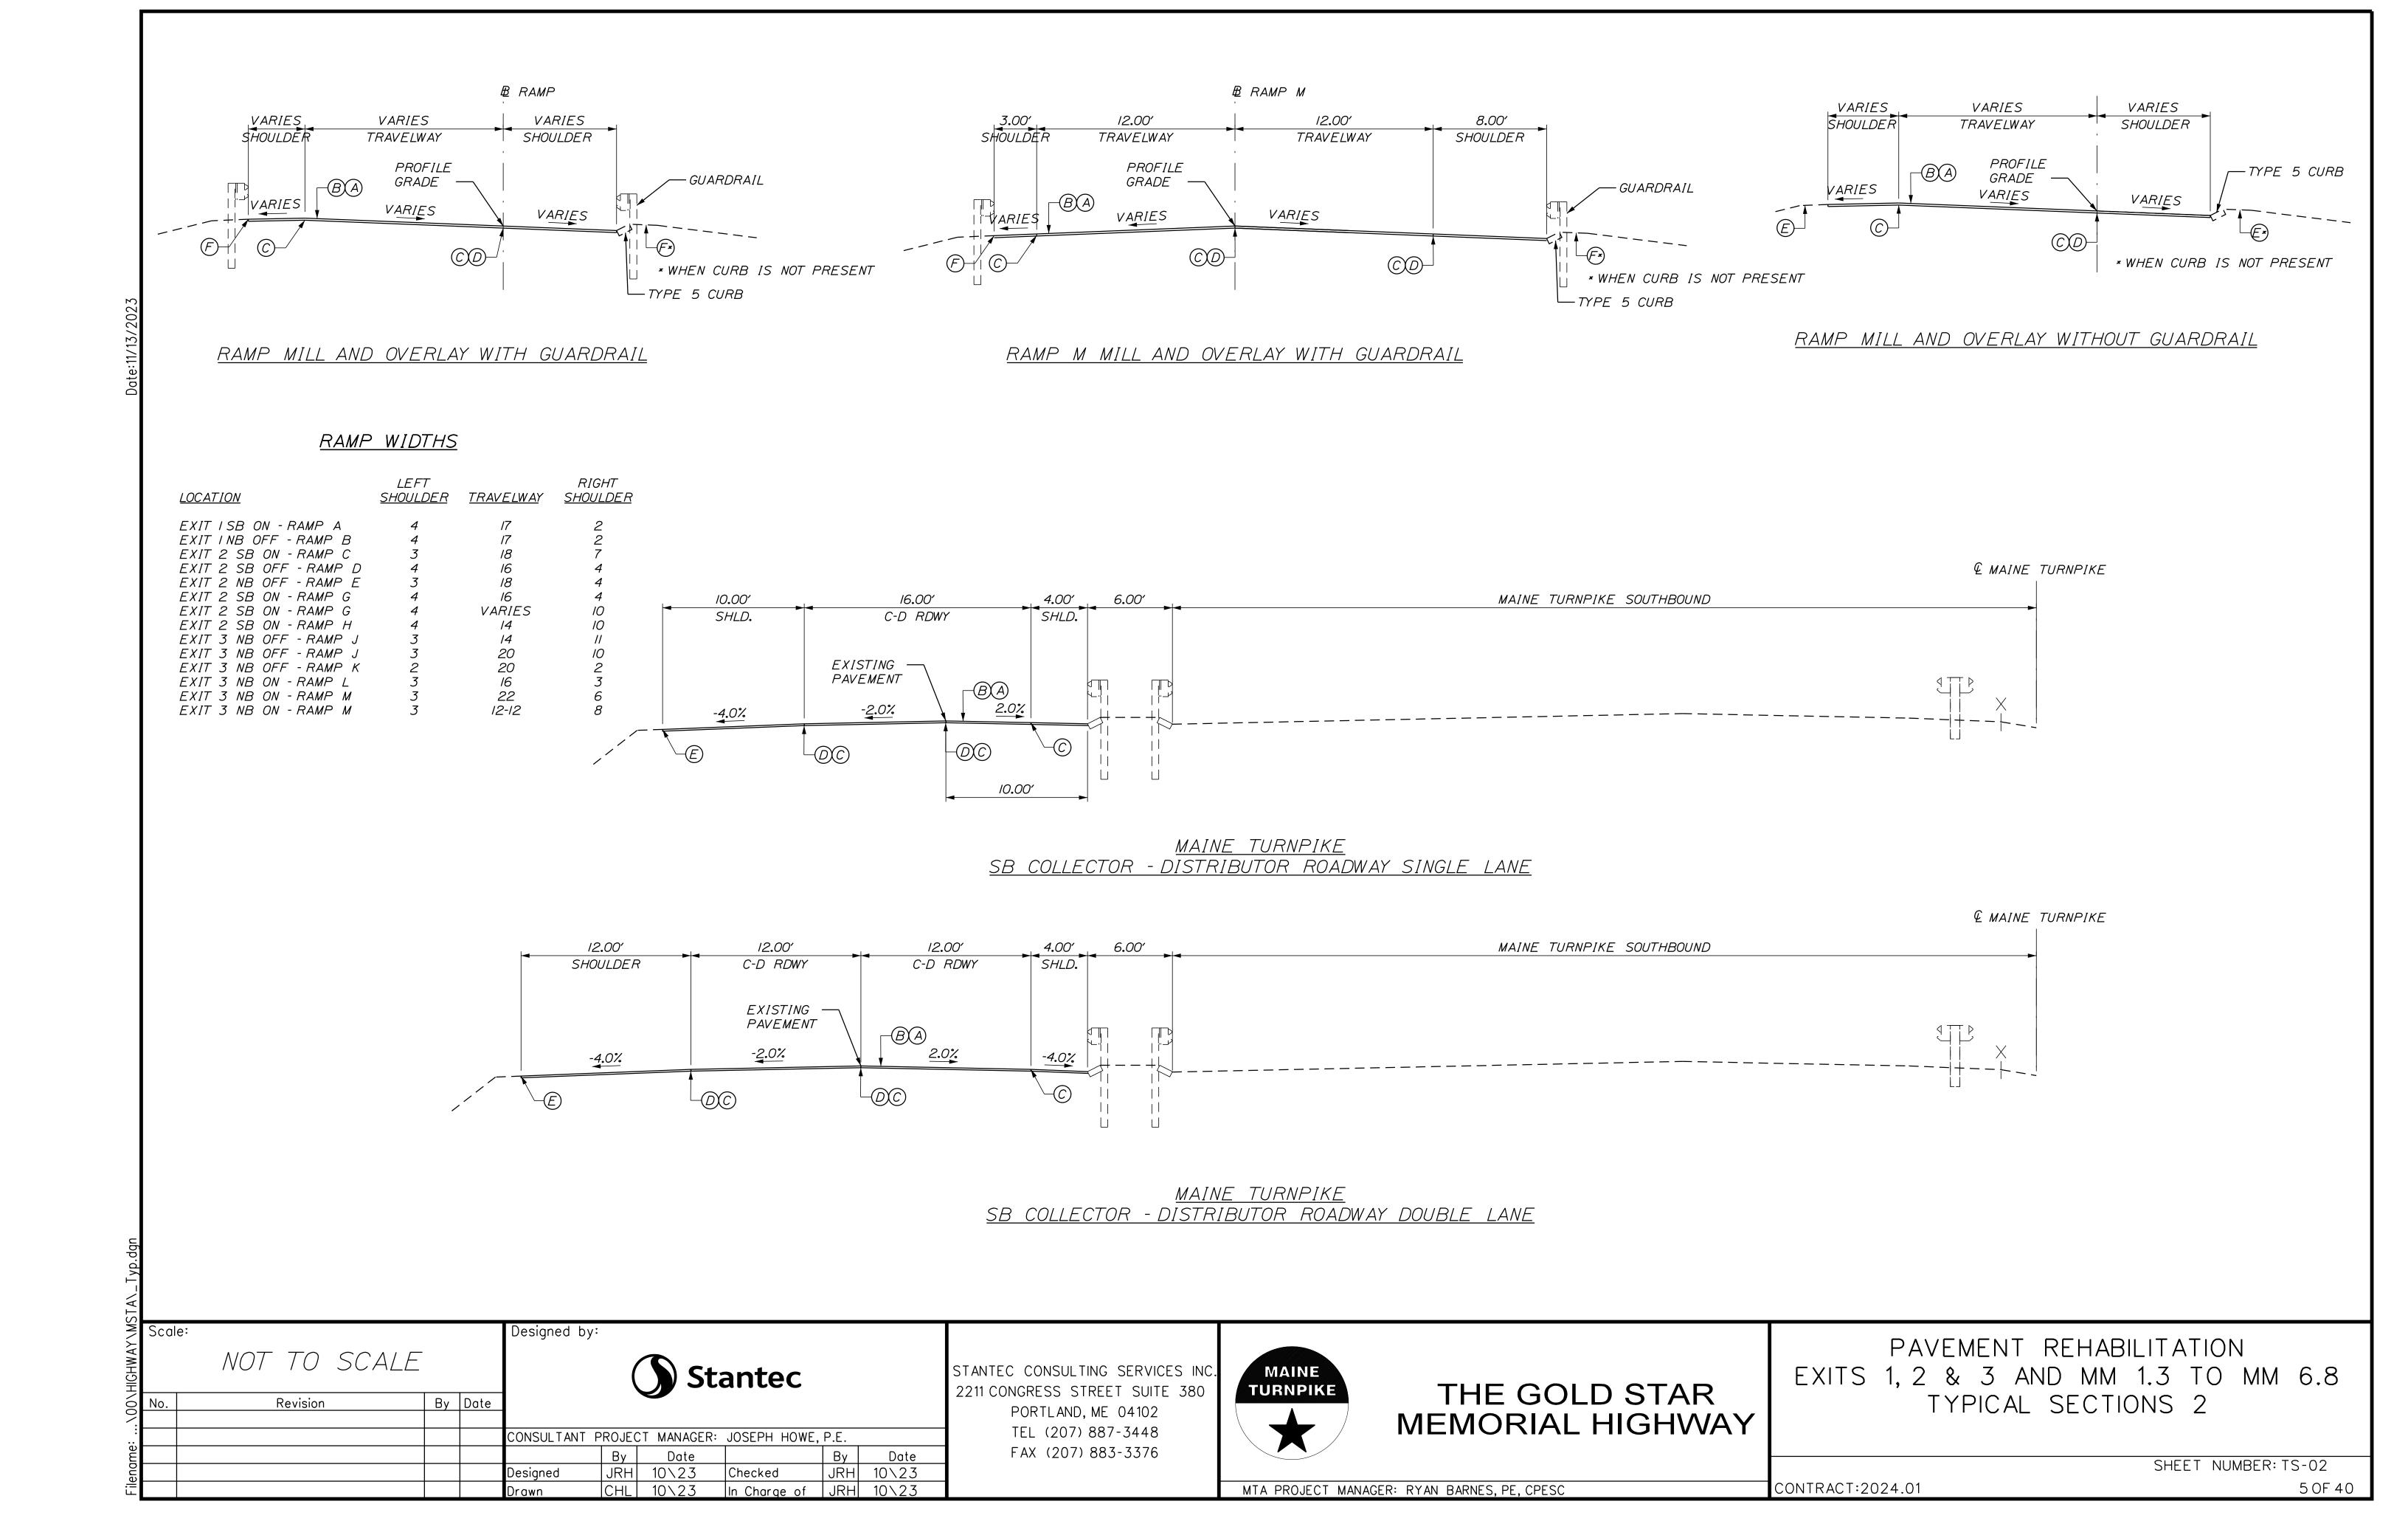

GENERAL MAINTENANCE OF TRAFFIC NOTES:

- I. ALL PAVEMENT STRIPING & SIGNING SHALL BE IN ACCORDANCE WITH THE "MANUAL ON UNIFORM TRAFFIC CONTROL DEVICES", U.S.D.O.T., F.H.W.A., LATEST EDITION. NOTE THERE IS A 2009 EDITION OF MUTCD.
- 2. THESE PLANS SHOW THE GENERAL CONDITION FOR TURNPIKE MAINLINE TRAFFIC CONTROL. DURING CONSTRUCTION, SLIGHT MODIFICATIONS IN CONSTRUCTION PROCEDURE MAY OCCUR AND MAY REQUIRE SOME MINOR ADJUSTMENTS TO BE MADE IN THE FIELD, ALL PROCEDURES MUST BE APPROVED BY THE RESIDENT.
- 3. TEMPORARY PAVEMENT MARKINGS ON MILLED SURFACES, SHIM, AND BASE PAVEMENT SHALL BE PAINTED, PAYMENT FOR MARKINGS SHALL BE PAID UNDER ITEM 627.78 - TEMPORARY PAVEMENT MARKING LINE, WHITE OR YELLOW,
- 4. TEMPORARY PAVEMENT MARKINGS ON SURFACE SHALL BE TEMPORARY 6 INCH PAVEMENT MARKING TAPE (ITEM 627.73) OR TEMPORARY RAISED PAVEMENT MARKERS (ITEM 627.812) AS SHOWN ON STRIPING DETAILS.
- 5. EXPOSED BARRIER ENDS SHALL BE PROTECTED BY A WORK ZONE CRASH CUSHION, PAYMENT WILL BE UNDER ITEM 527.341 - WORK ZONE CRASH CUSHION - TL-3.
- 6. ALL TEMPORARY BARRIER SHALL BE SET WITH A MINIMUM 8:1TAPER.THE 8:1TAPER BARRIER LENGTH IS DEPENDENT ON THE LOCATION OF THE BARRIER RELATIVE TO THE MAINE TURNPIKE SHOULDERS OR LANES.
- 7. REMOVAL OF TEMPORARY PAVEMENT MARKINGS ON FINAL PAVEMENT SURFACE SHALL BE DONE IN SUCH A MANNER TO REMOVE AS LITTLE PAVEMENT AS POSSIBLE.
- 8. TRUCK MOUNTED ATTENUATOR SHALL NOT BE LOCATED WITHIN THE BUFFER ZONE.
- 9. SIGN SPACING AS NOTED IN THE DETAILS MAY BE ADJUSTED FOR SITE CONDITIONS AND TO ALLOW FOR USING SINGLE SIGN LOCATIONS FOR DIFFERENT DETAILS AS APPROPRIATE.
- IO. ADDITIONAL MOT DETAILS SPECIFIC TO EXITS 1,2,& 3 ARE PROVIDED IN APPENDIX A OF THE SPECIAL PROVISIONS.
- II. MAINTENANCE OF TRAFFIC PLANS FOR SPRUCE CREEK BRIDGE WORK ARE SHOWN IN THE SPRUCE CREEK PLANS. SIGNS FOR SPRUCE CREEK ARE INCLUDED IN THE SIGN SUMMARY SHEETS.
- 12. CONES MAY BE USED ON TANGENTS THROUGH WORK ZONES. DRUMS SHALL BE USED ON ALL TAPERS AND TANGENTS BETWEEN ADJACENT LANE CLOSURES IN DOUBLE LANE CLOSURE APPLICATIONS.

MOT SIGN NOTES:

- I. THESE PLANS SHOW THE GENERAL LAYOUT OF CONSTRUCTION ZONE SIGNING; ALL LOCATIONS REQUIRING SIGNS MAY NOT BE SHOWN, ADDITIONAL MOT NOT SHOWN ON THE PLANS AND LAYOUT OF SIGNS MUST BE SUBMITTED TO AND APPROVED BY THE RESIDENT.
- 2. ALL PROPOSED CONSTRUCTION SIGNS ON MAINLINE WILL BE PLACED ON BOTH SIDES OF THE ROAD UNLESS OTHERWISE SHOWN ON THE PLANS.
- 3. NO SIGNS ON EASELS SHALL BE PLACED ON 4 FT. SHOULDERS WITH GUARDRAIL. SIGNS REQUIRED AT THESE LOCATIONS SHALL BE PLACED ON TALLER EASELS ON THE MEDIAN SIDE OF THE GUARDRAIL.
- 4. ALL TEMPORARY LANE CLOSURE SIGNS ARE TO BE MOUNTED ON EASELS.
- 5. ERECT CS-3 AND W3-4 SIGNS IMMEDIATELY PRIOR TO SCHEDULED STOPPAGES FOR EQUIPMENT MOVES AND REMOVE THE CS-3 AND W3-4 SIGNS IMMEDIATELY AFTER THE SCHEDULED STOPPAGES ARE COMPLETE.
- 6. ALL MOT SIGN LOCATIONS ARE APPROXIMATE AND SHALL BE CONFIRMED BY THE RESIDENT.
- 7. EXISTING SIGNS THAT CONFLICT WITH CONSTRUCTION WORK ZONE SIGNS SHALL BE COVERED.
- 8. SPEED LIMIT, STOP, EXIT AND YIELD SIGNS SHALL BE A MINIMUM OF 5' ABOVE THE PAVEMENT TO THE BOTTOM OF
- 9. PROJECT APPROACH SIGNING THAT EXTENDS ONTO THE PISCATAQUA RIVER BRIDGE SHALL NOT HAVE ANY SIGNS PLACED IN THE MEDIAN OF THE BRIDGE.

TEMPORARY RUMBLE STRIP NOTES:

- I. IF TEMPORARY RUMBLE STRIPS ARE USED THEY SHALL BE PLACED IN ONE OF THE FOLLOWING CONFIGURATIONS:
- * ADJACENT TO THE WORK ZONE (IUNIT)
- * UPSTREAM FROM THE TAPER FOR THE WORKZONE (2 UNITS)
- * BOTH ADJACENT TO THE WORKZONE AND PRIOR TO THE TAPER (3 UNITS)
- 2. W8-I SIGNS SHALL BE PLACED ADJACENT TO THE FIRST RUMBLE STRIP AT ANY LOCATION. ONLY ONE SET OF W8-24a SIGNS ARE REQUIRED FOR ANY OF THE ABOVE CONFIGURATIONS.
- 3. RUMBLE STRIPS MAY BE PLACED UPSTREAM OF THE TAPER BETWEEN THE W3-5 SIGNS AND THE W4-2 SIGNS, IF RUMBLE STRIPS ARE INSTALLED PRIOR TO TAPER. W8-I SIGNS SHALL BE PLACED ADJACENT TO THE FIRST STRIP AND THE W8-24a SIGNS SHALL BE MOVED TO 400' AFTER THE W20-5 SIGNS.

RAMP CLOSURE NOTES:

- I. THE CONTRACTOR SHALL NOTIFY THE RESIDENT 14 DAYS PRIOR TO RAMP CLOSURES SO THAT THE RESIDENT CAN COORDINATE THE CLOSURE WITH MTA.
- 2. ALL PCMS MESSAGES SHALL BE CONFIRMED BY THE RESIDENT.
- MULTIPLE RAMP CLOSURES MAY UTILIZE PCMS IN THE SAME LOCATION. THE CONTRACTOR SHOULD REVIEW RAMP CLOSURE PLANS TO COORDINATE PCMS LOCATIONS.
- 4. OFF RAMP CLOSURES ALSO REQUIRE THE USE OF THE OFF RAMP CLOSURE DETAIL.

ABBREVIATIONS FOR ALL M.O.T. PLANS:

BWLL = BROKEN WHITE LANE LINE

SWEL = SOLID WHITE EDGE LINE SYEL = SOLID YELLOW EDGE LINE

TBWLL = TEMPORARY BROKEN WHITE LANE LINE

TDWEL = TEMPORARY DOTTED WHITE EDGE LINE

TSWEL = TEMPORARY SOLID WHITE EDGE LINE

TSWLL = TEMPORARY SOLID WHITE LANE LINE

TSYCL = TEMPORARY SOLID YELLOW CENTER LINE TSYEL = TEMPORARY SOLID YELLOW EDGE LINE

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ם ו						Ву	Date		Ву	Date
					Designed	JŔH	10\23	Checked	JRH	10\23
: [Drawn	CHL	10\23	In Charge of	JRH	10\23



PORTLAND, ME 04102

TEL (207) 887-3448

FAX (207) 883-3376

THE GOLD STAR MEMORIAL HIGHWAY


PAVEMENT REHABILITATION EXITS 1, 2 & 3 AND MM 1.3 TO MM 6.8 MAINTENANCE OF TRAFFIC GENERAL NOTES

CONTRACT:2024.01


SHEET NUMBER: GN-02

MTA PROJECT MANAGER: RYAN BARNES, PE, CPESC


6 OF 40

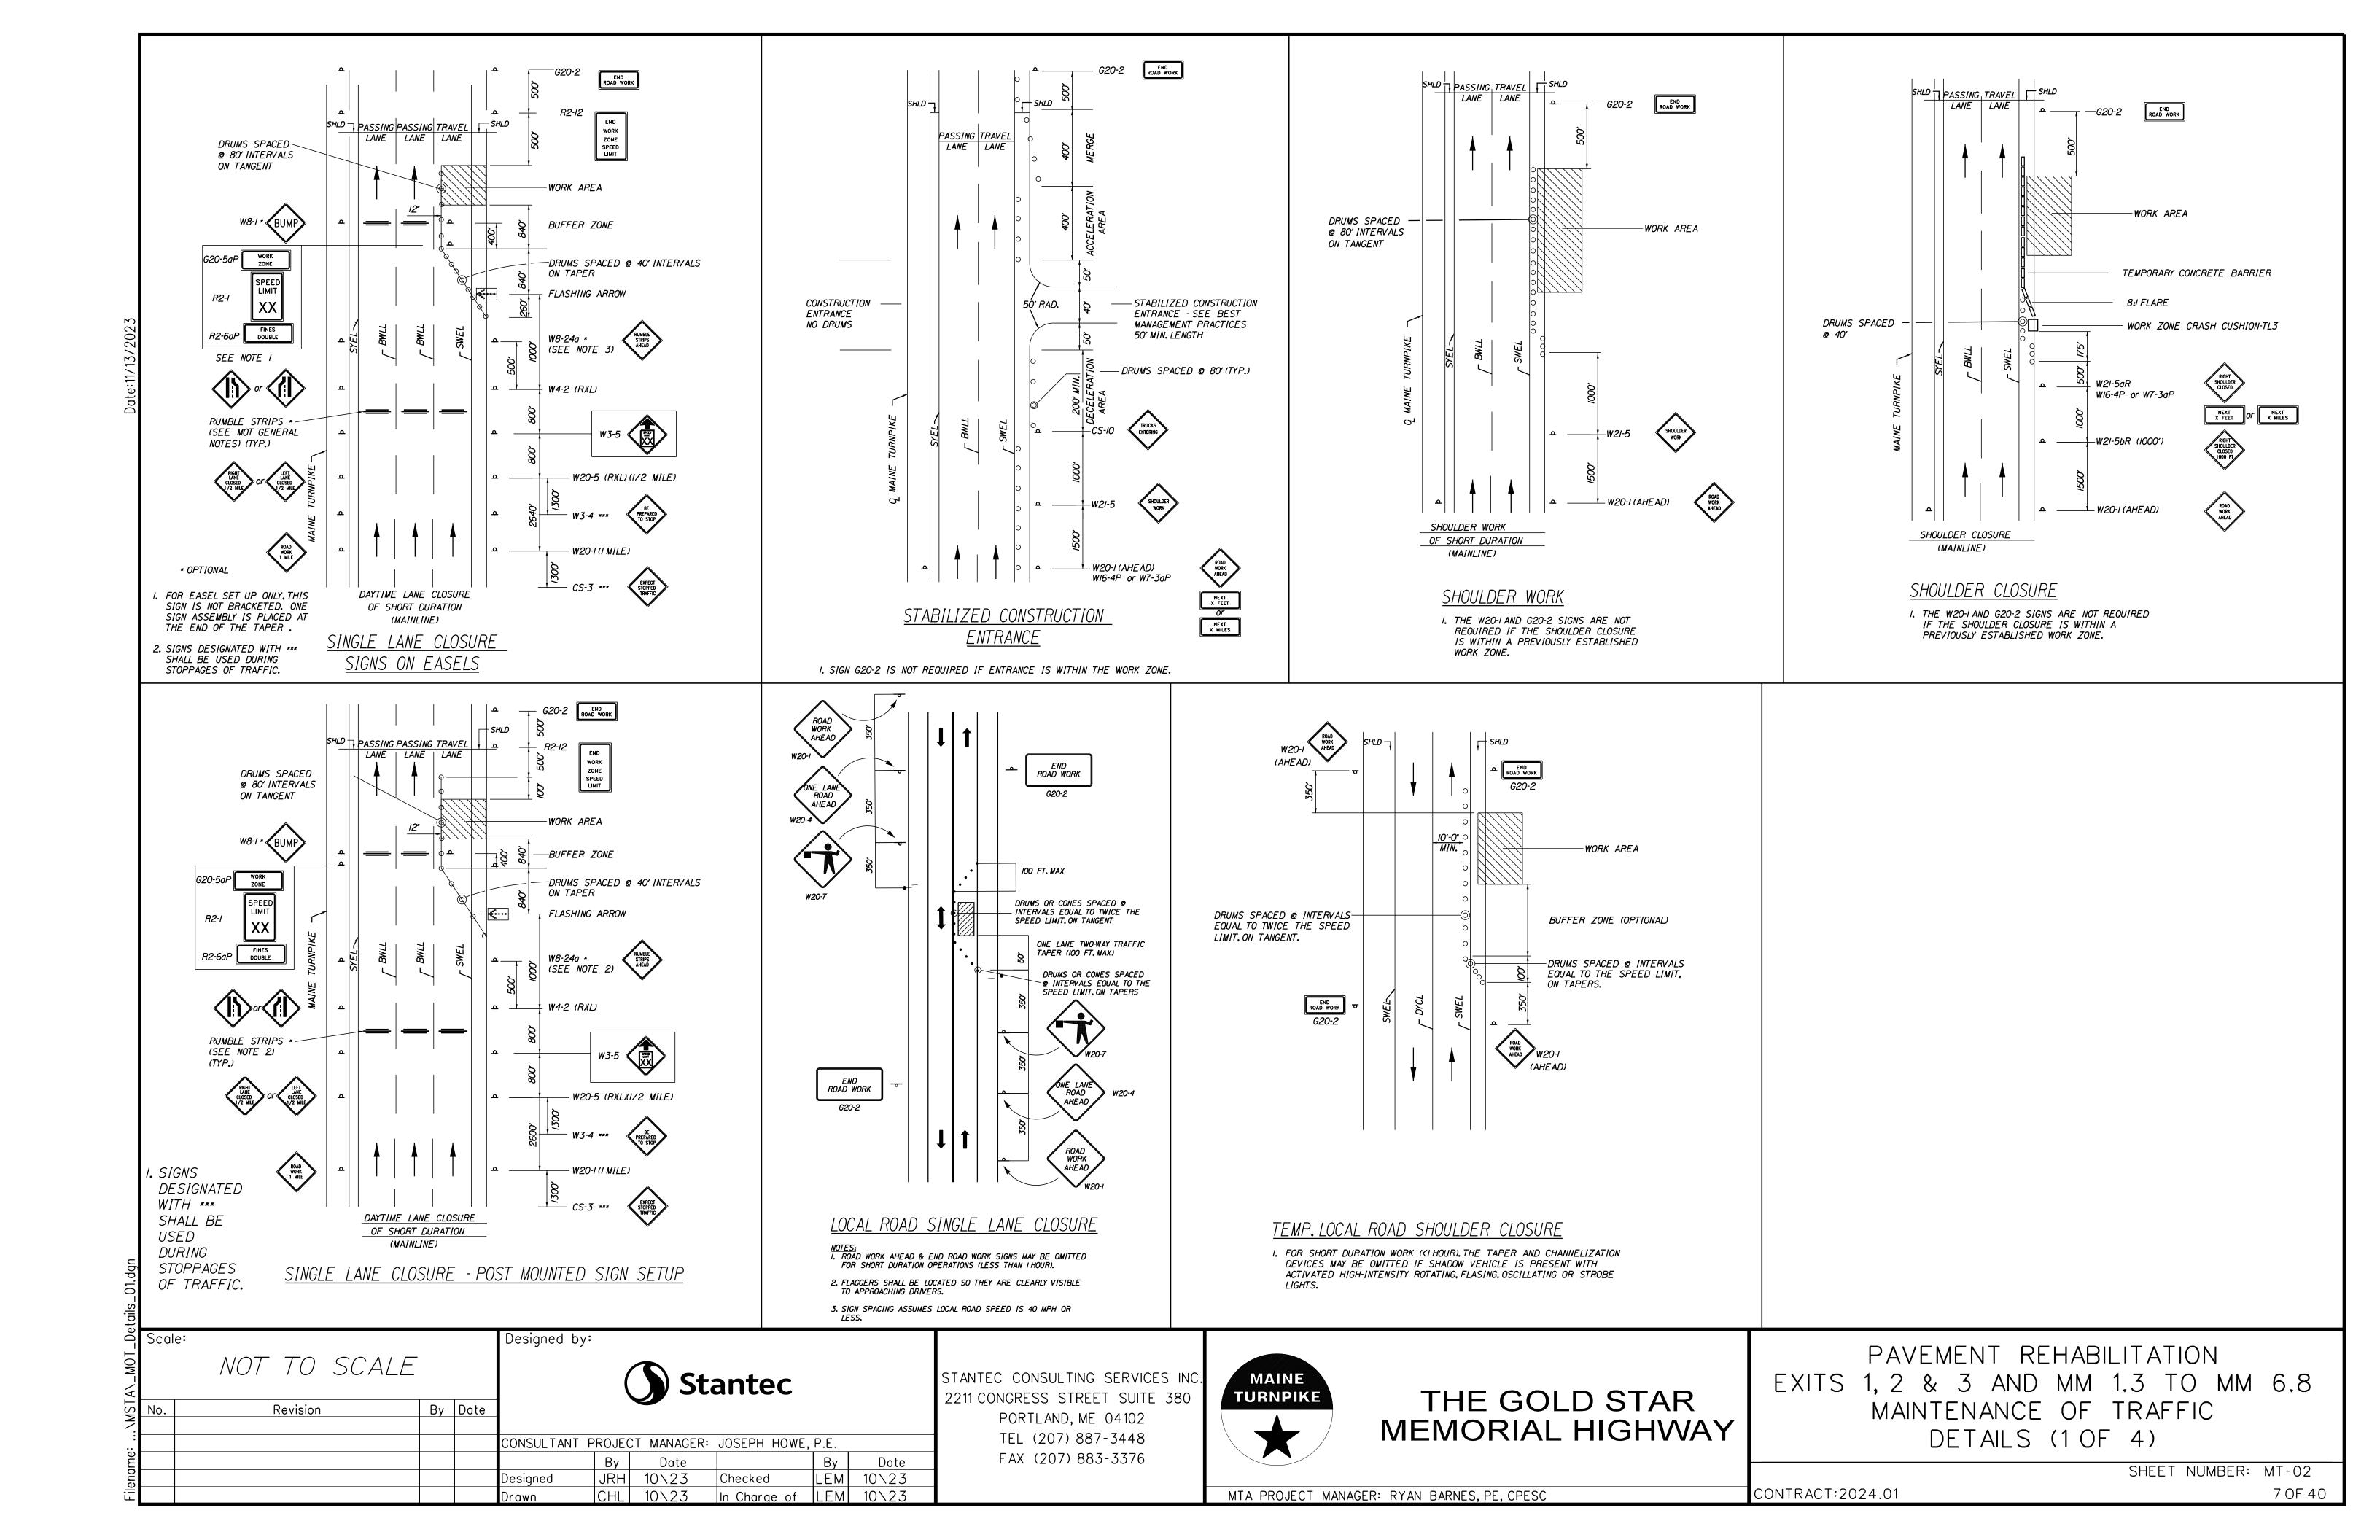

- I. FOR SIGN DETAILS, SEE SIGN SUMMARY SHEETS.
- 2. ALL TEMPORARY LANE CLOSURE SIGNS ARE TO BE MOUNTED ON EASELS.
- 3. STANDARD SINGLE LANE CLOSURES FOR LANES I AND 2 SHALL BE USED FOR DRAINAGE WORK, GUARDRAIL WORK, MEDIAN WORK, EQUIPMENT MOVES, BERM DROP OFF CORRECTION WORK, PAINTING OF SOLID WHITE LANE LINES, AND ALL OTHER WORK NOT REQUIRING ENCROACHMENT INTO THE ADJACENT LANE.
- 4. SEE SHEET MT-02 FOR STANDARD SINGLE LANE CLOSURE DETAILS.
- 5. ERECT CS-3 AND W3-4 SIGNS IMMEDIATELY PRIOR TO SCHEDULED STOPPAGES FOR EQUIPMENT MOVES AND REMOVE THE CS-I AND W3-4 SIGNS IMMEDIATELY AFTER THE SCHEDULED STOPPAGES ARE COMPLETE.
- 6. FOR DOUBLE LANE CLOSURES FOR MILLING AND PAVING OPERATIONS, SEE DOUBLE LANE CLOSURE DETAIL, SHEET MT-05 FOR CLOSURE OF FIRST

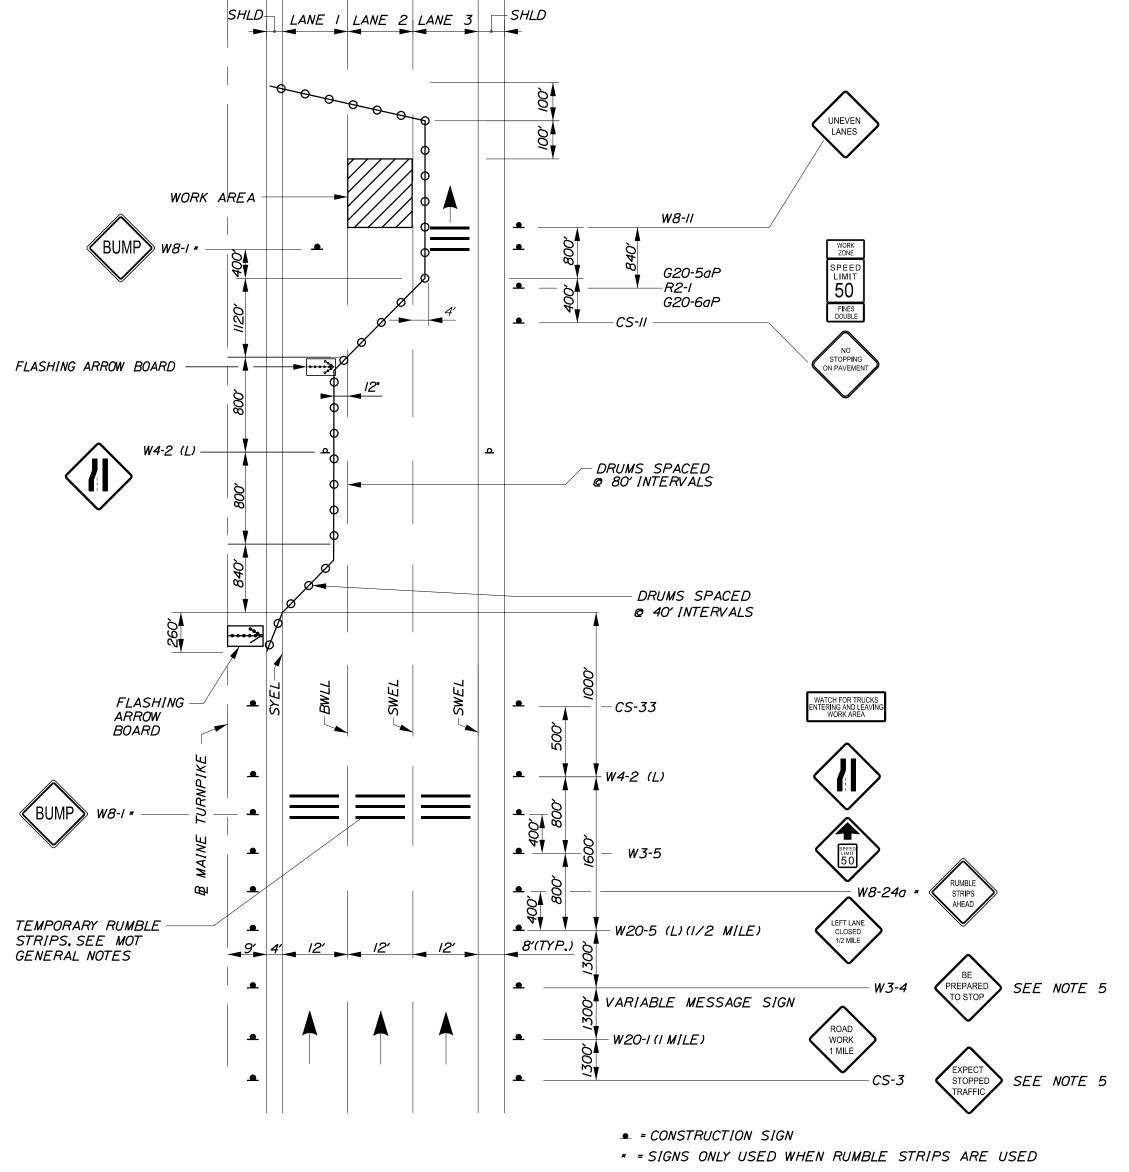

LANE CLOSURE FOR MILLING AND PAVING OPERATIONS AND PAVEMENT MARKINGS LANE 2

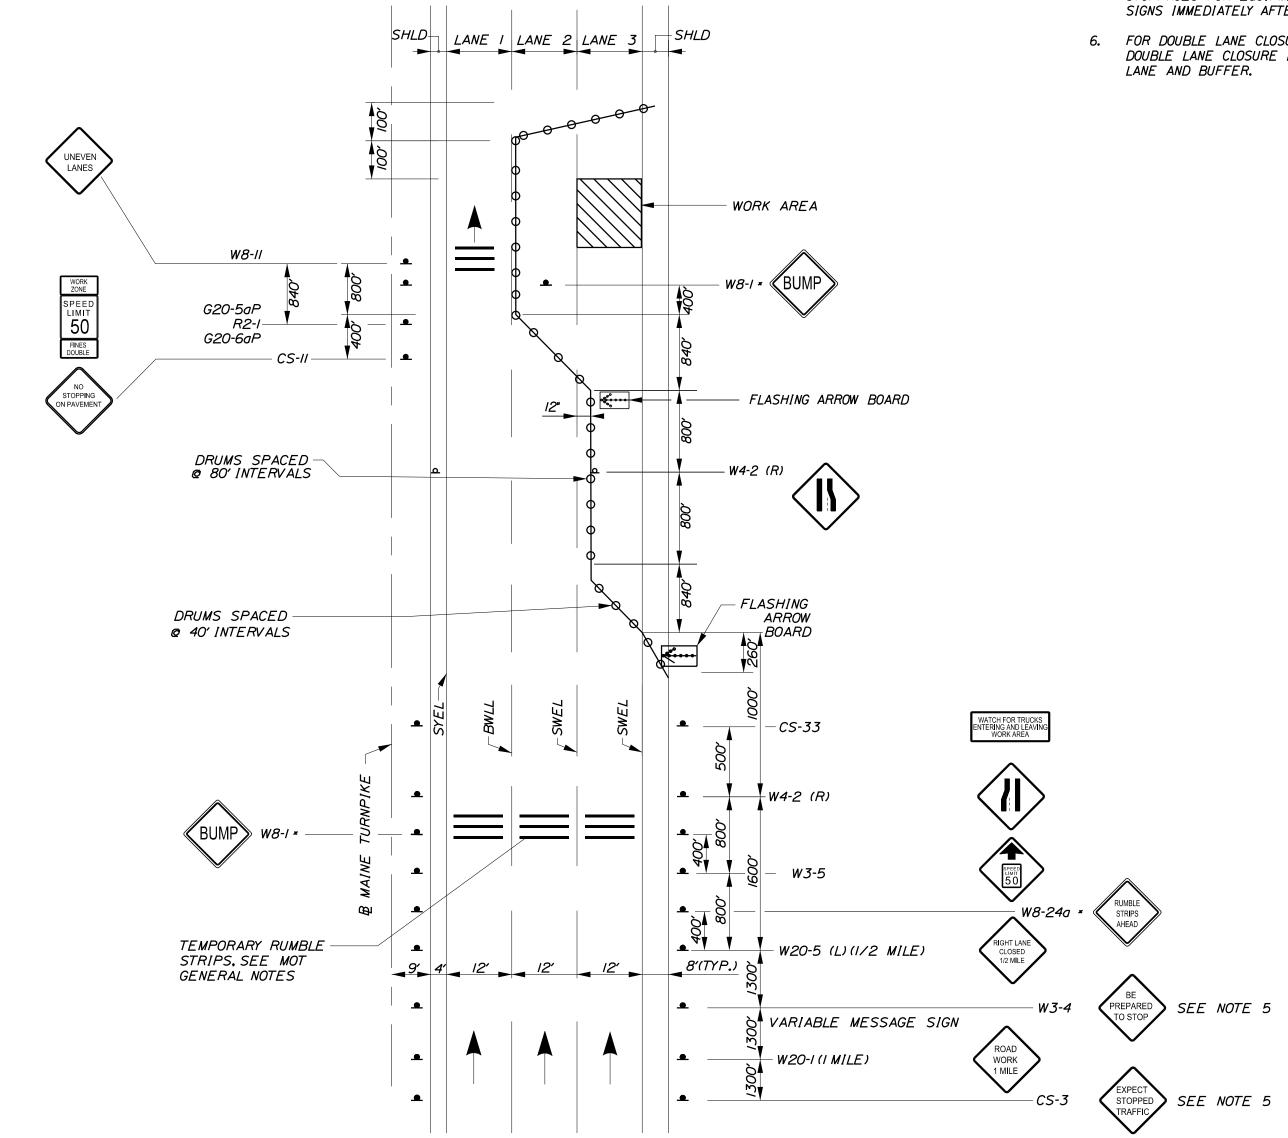

■ = CONSTRUCTION SIGN * = SIGNS ONLY USED WHEN RUMBLE STRIPS ARE USED

LANE CLOSURE FOR MILLING AND PAVING OPERATIONS AND PAVEMENT MARKINGS LANE 3

(LANE | SIMILAR/OPPOSITE)

Scale:				Designed b	y:				
	NOT TO SCAL	E			(St St	tantec		
No.	Revision	Ву	Date	-	•				
				CONSULTANT	PROJEC	CT MANAGER	∷ JOSEPH HOWE,	, P.E.	
					Ву	Date		Ву	Date
				Designed	JŔH	10\23	Checked	LEM	10\23
				Drawn	CHL	10\23	In Charge of	LEM	10\23

TANTEC CONSULTING SERVICES INC. 211 CONGRESS STREET SUITE 380 PORTLAND, ME 04102 TEL (207) 887-3448 FAX (207) 883-3376




THE GOLD STAR MEMORIAL HIGHWAY

PAVEMENT REHABILITATION EXITS 1, 2 & 3 AND MM 1.3 TO MM 6.8 MAINTENANCE OF TRAFFIC DETAILS (2 OF 4)

SHEET NUMBER: MT-03

MTA PROJECT MANAGER: RYAN BARNES, PE, CPESC


CONTRACT:2024.01 8 OF 40

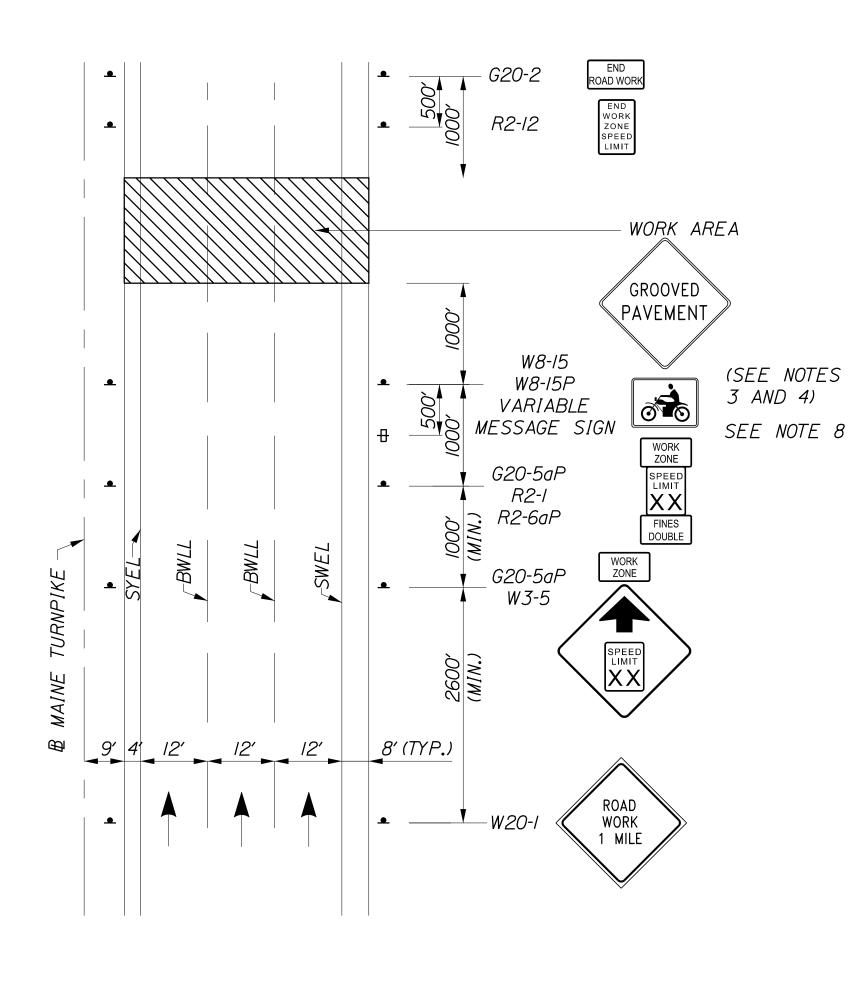


ADVANCED PROJECT SIGNING

NOTES:

- I. FOR SIGN DETAILS, SEE SIGN SUMMARY SHEETS.
- 2. UNCOVER W8-15 & W8-15P SIGNS WHEN PAVEMENT IS MILLED OR AS DIRECTED BY THE RESIDENT.
- 3. PROVIDE W8-15 AND W8-15P AT ALL MILLED LOCATIONS.
- 4. DUE TO SEQUENCING OF WORK AREAS, APPROACH SIGNING MAY NEED TO BE ADJUSTED AS WORK PROGRESSES.
- 5. TRAFFIC CONTROL SIGNS NOT IN USE SHALL BE COVERED AS DIRECTED BY THE RESIDENT.
- 6. ALL SIGNS TO BE MOUNTED ON EASELS UNLESS OTHERWISE
- 7. RAMP CLOSURES ALSO REQUIRE THE USE OF THE CORRESPONDING RAMP CLOSURE PLAN.

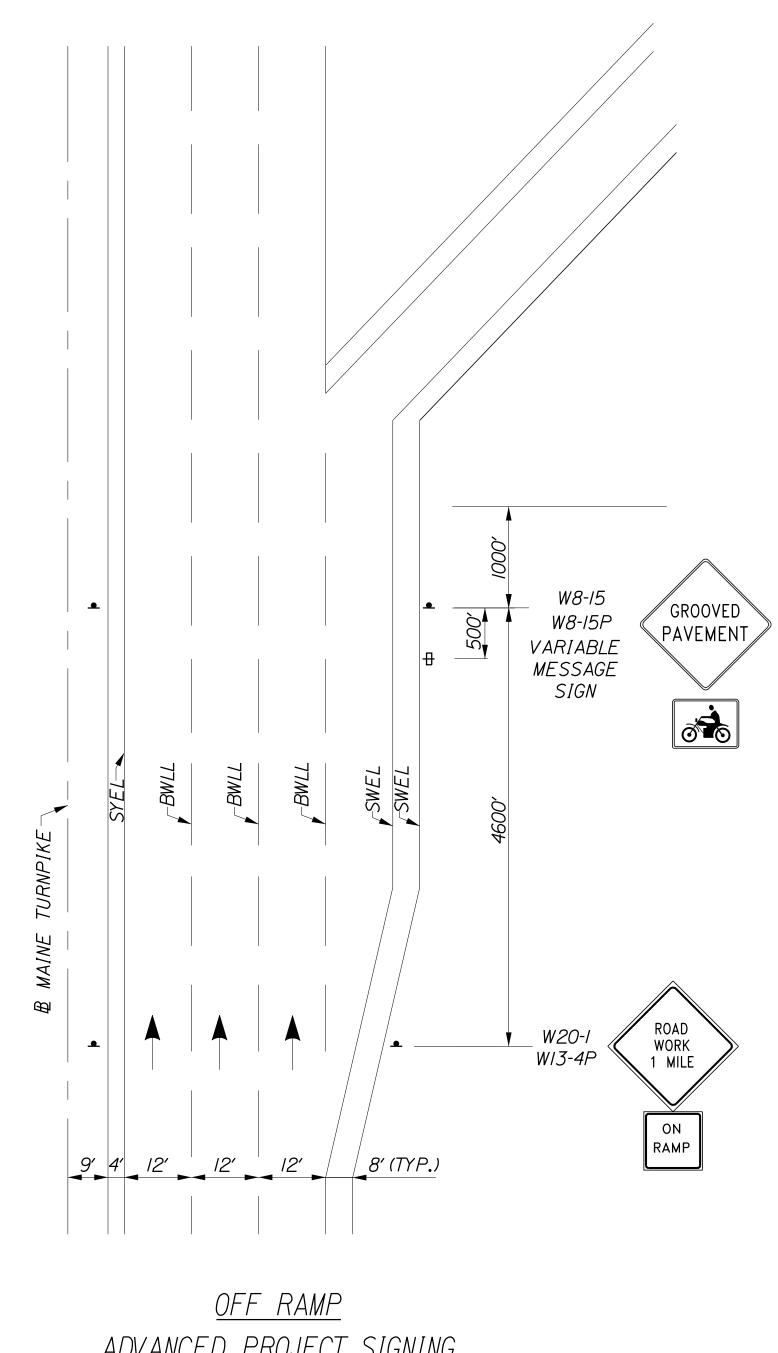

ADVANCED PROJECT SIGNING

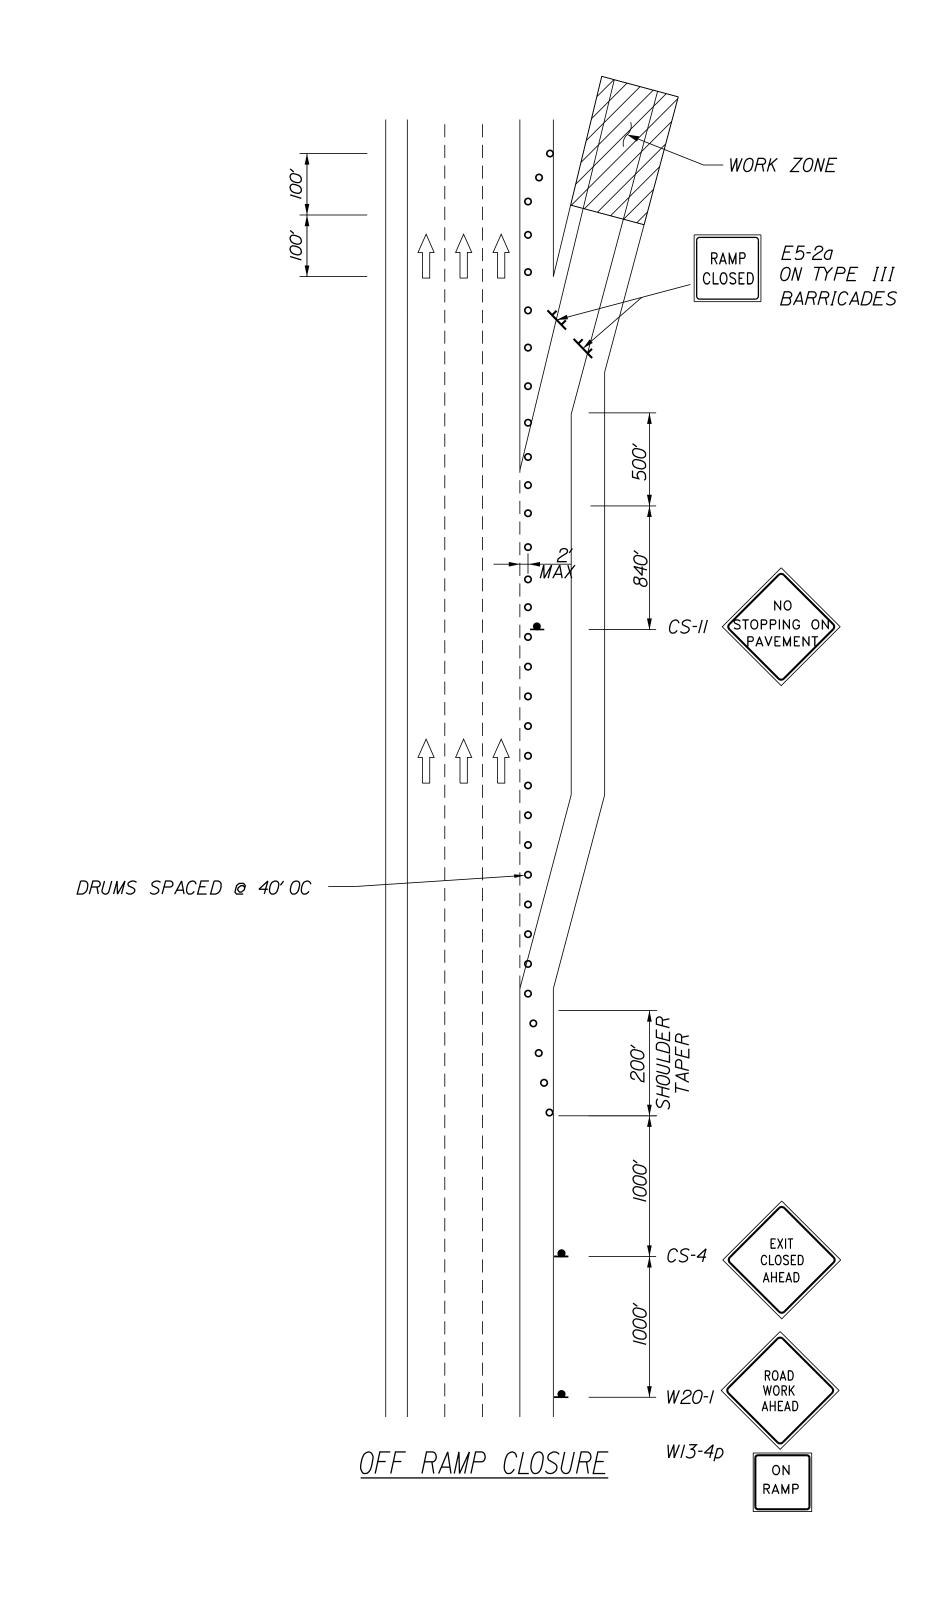

Designed by: Scale: NOT TO SCALE **Stantec** By Date Revision CONSULTANT PROJECT MANAGER: JOSEPH HOWE, P.E. Date By Date LEM 10\23 JRH 10\23 Checked Designed In Charge of LEM 10\23 CHL 10\23


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THE GOLD STAR MEMORIAL HIGHWAY

PAVEMENT REHABILITATION EXITS 1, 2 & 3 AND MM 1.3 TO MM 6.8 MAINTENANCE OF TRAFFIC DETAILS (3 OF 4)

SHEET NUMBER: MT-04 CONTRACT:2024.01 9 OF 40



Designed by: NOT TO SCALE **Stantec** By Date Revision CONSULTANT PROJECT MANAGER: JOSEPH HOWE, P.E. By Date Date JRH 10\23 LEM 10\23 Checked Designed In Charge of LEM 10\23 10\23

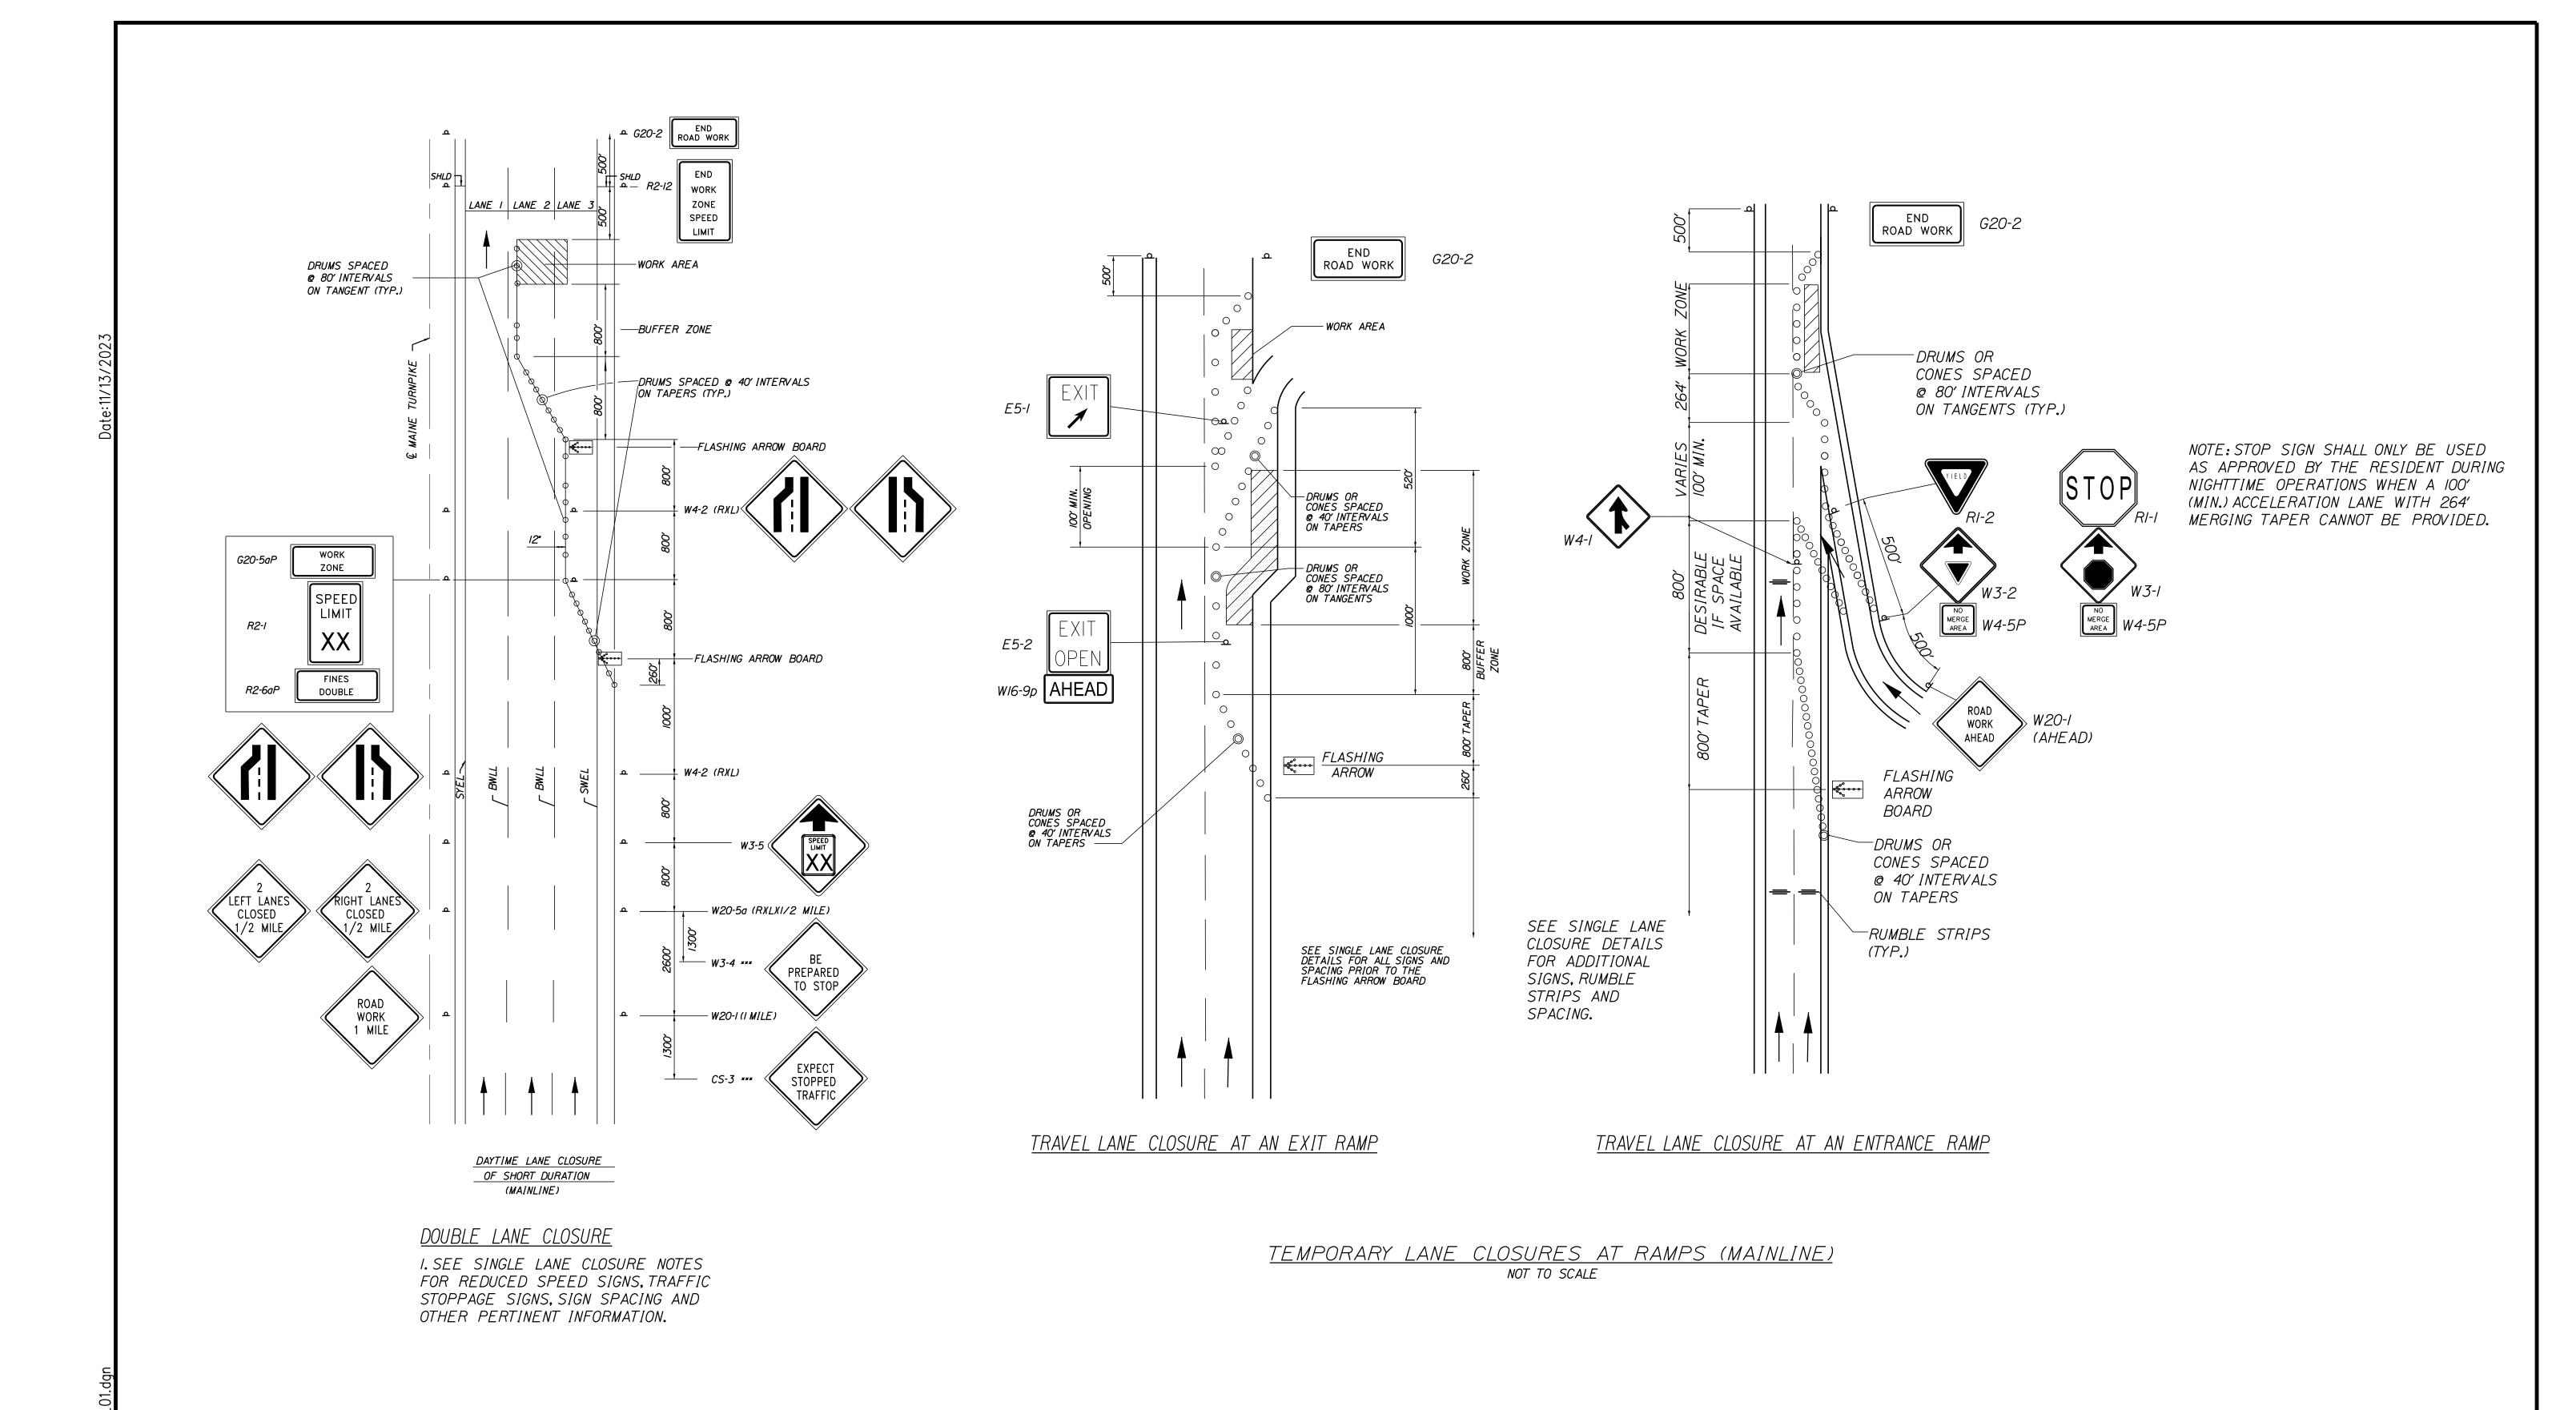
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THE GOLD STAR MEMORIAL HIGHWAY

PAVEMENT REHABILITATION EXITS 1, 2 & 3 AND MM 1.3 TO MM 6.8 MAINTENANCE OF TRAFFIC DETAILS (4 OF 4)

SHEET NUMBER: MT-05 CONTRACT:2024.01 10 OF 40



<u>LEGEND</u> **-** SIGN A

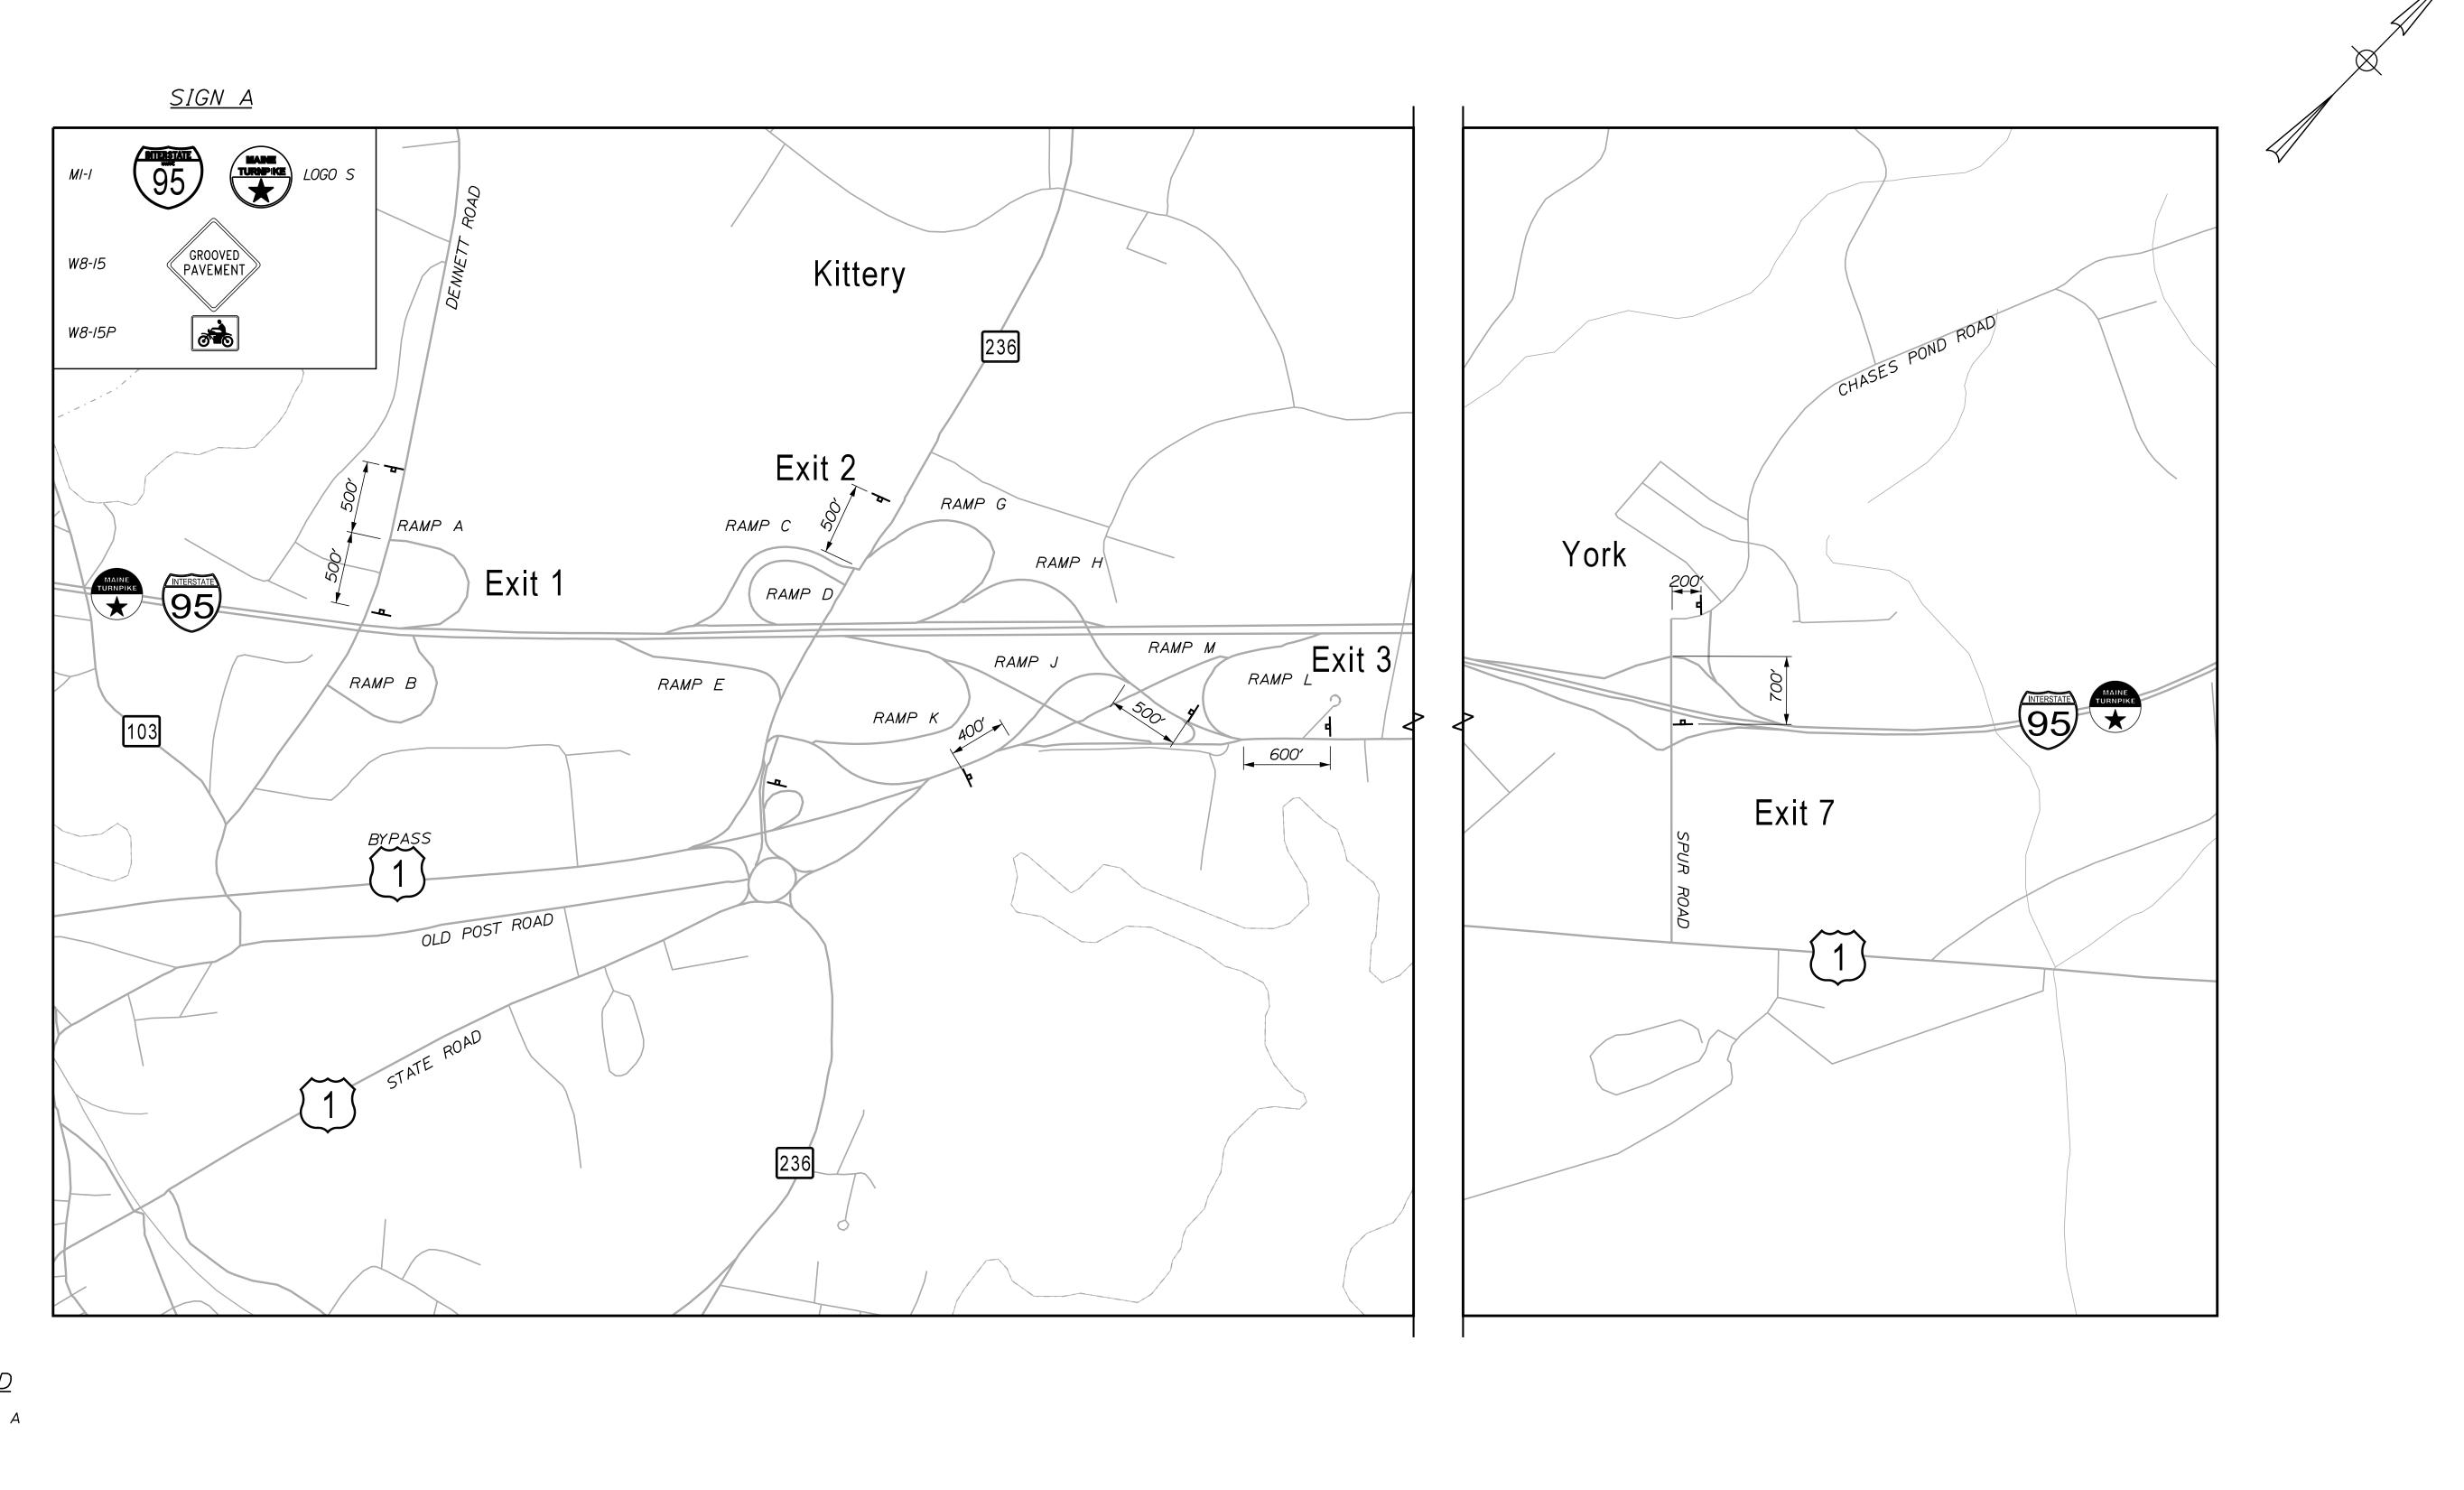T_Advanced		e: 600	O Scale (600 of Feet	1200		Designed by:	(St St	antec			STA 221
_MO	No.		Revision	า	Ву	Date							221
:							CONSULTANT I	PROJEC	CT MANAGER	: JOSEPH HOWE,	P.E.		1
Filename								Ву	Date		Ву	Date	
ena							Designed	JRH	10\23	Checked	PLP	10\23	
Fj							Drawn	CHL	10\23	In Charge of	LEM	10\23	

TANTEC CONSULTING SERVICES INC. 211 CONGRESS STREET SUITE 380 PORTLAND, ME 04102 TEL (207) 887-3448 FAX (207) 883-3376





THE GOLD STAR MEMORIAL HIGHWAY


PAVEMENT REHABILITATION EXITS 1, 2 & 3 AND MM 1.3 TO MM 6.8 MAINTENANCE OF TRAFFIC ADVANCED PROJECT SIGNING


CONTRACT:2024.01


SHEET NUMBER: MOT-9 11 OF 40

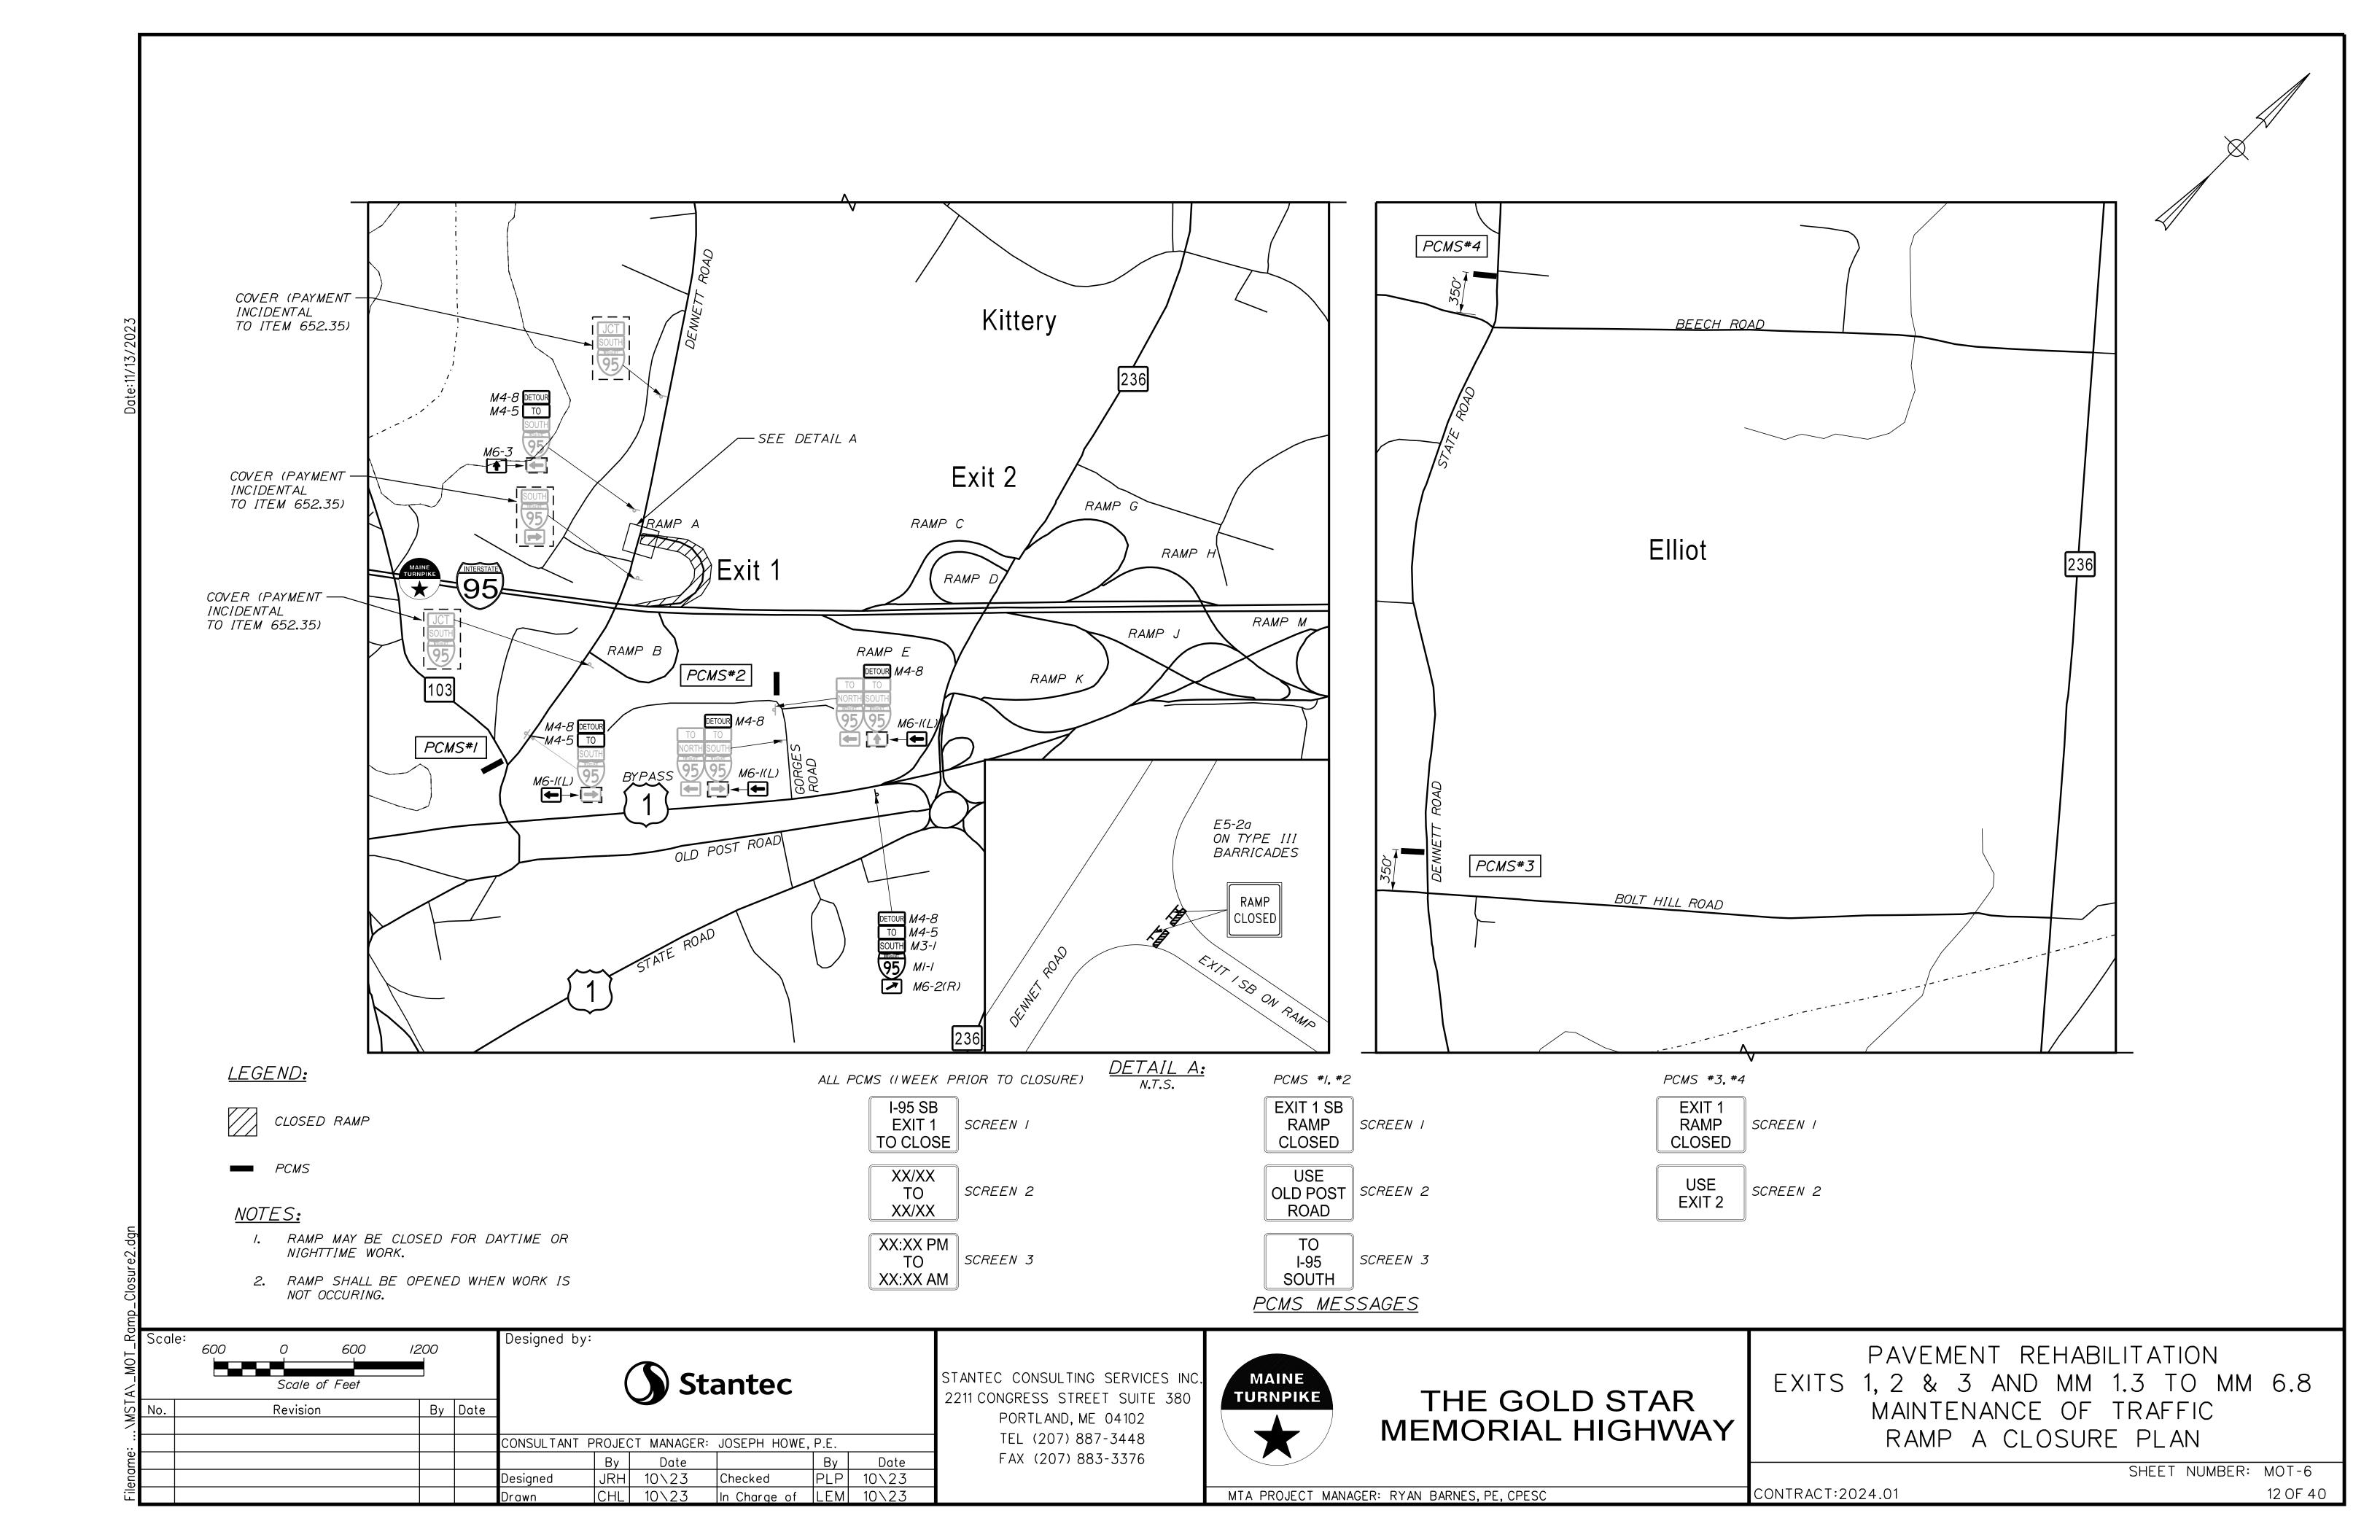


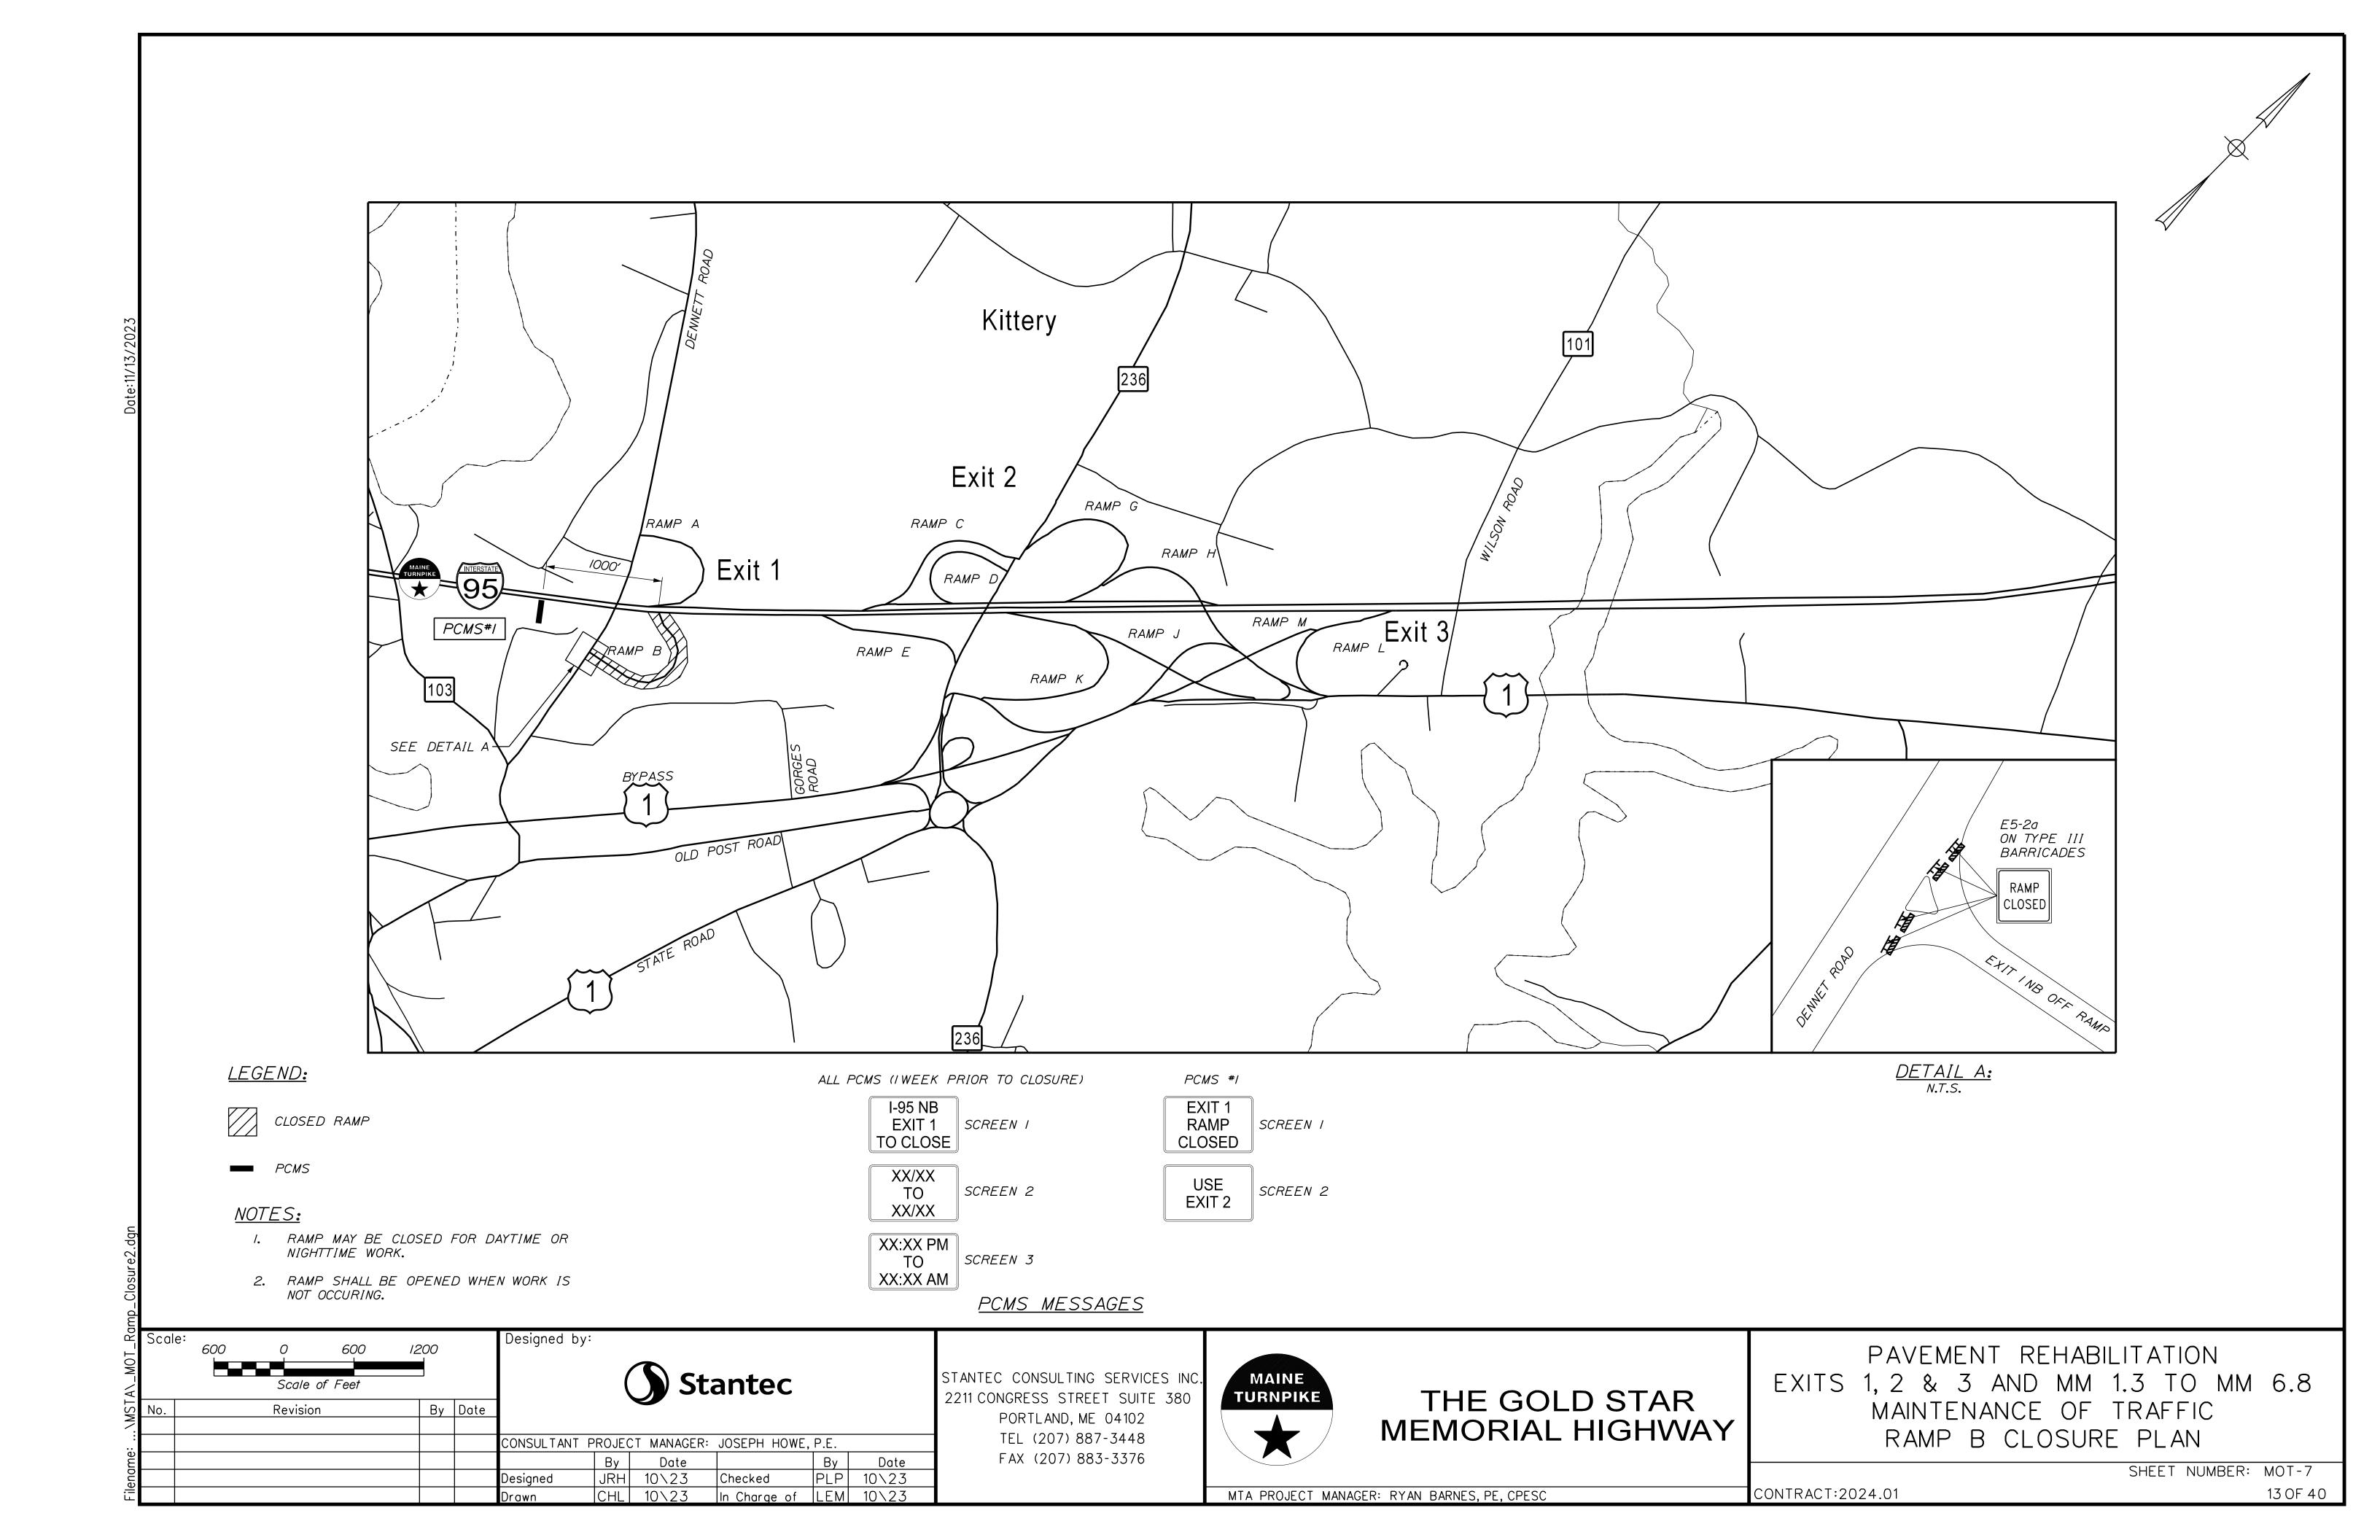


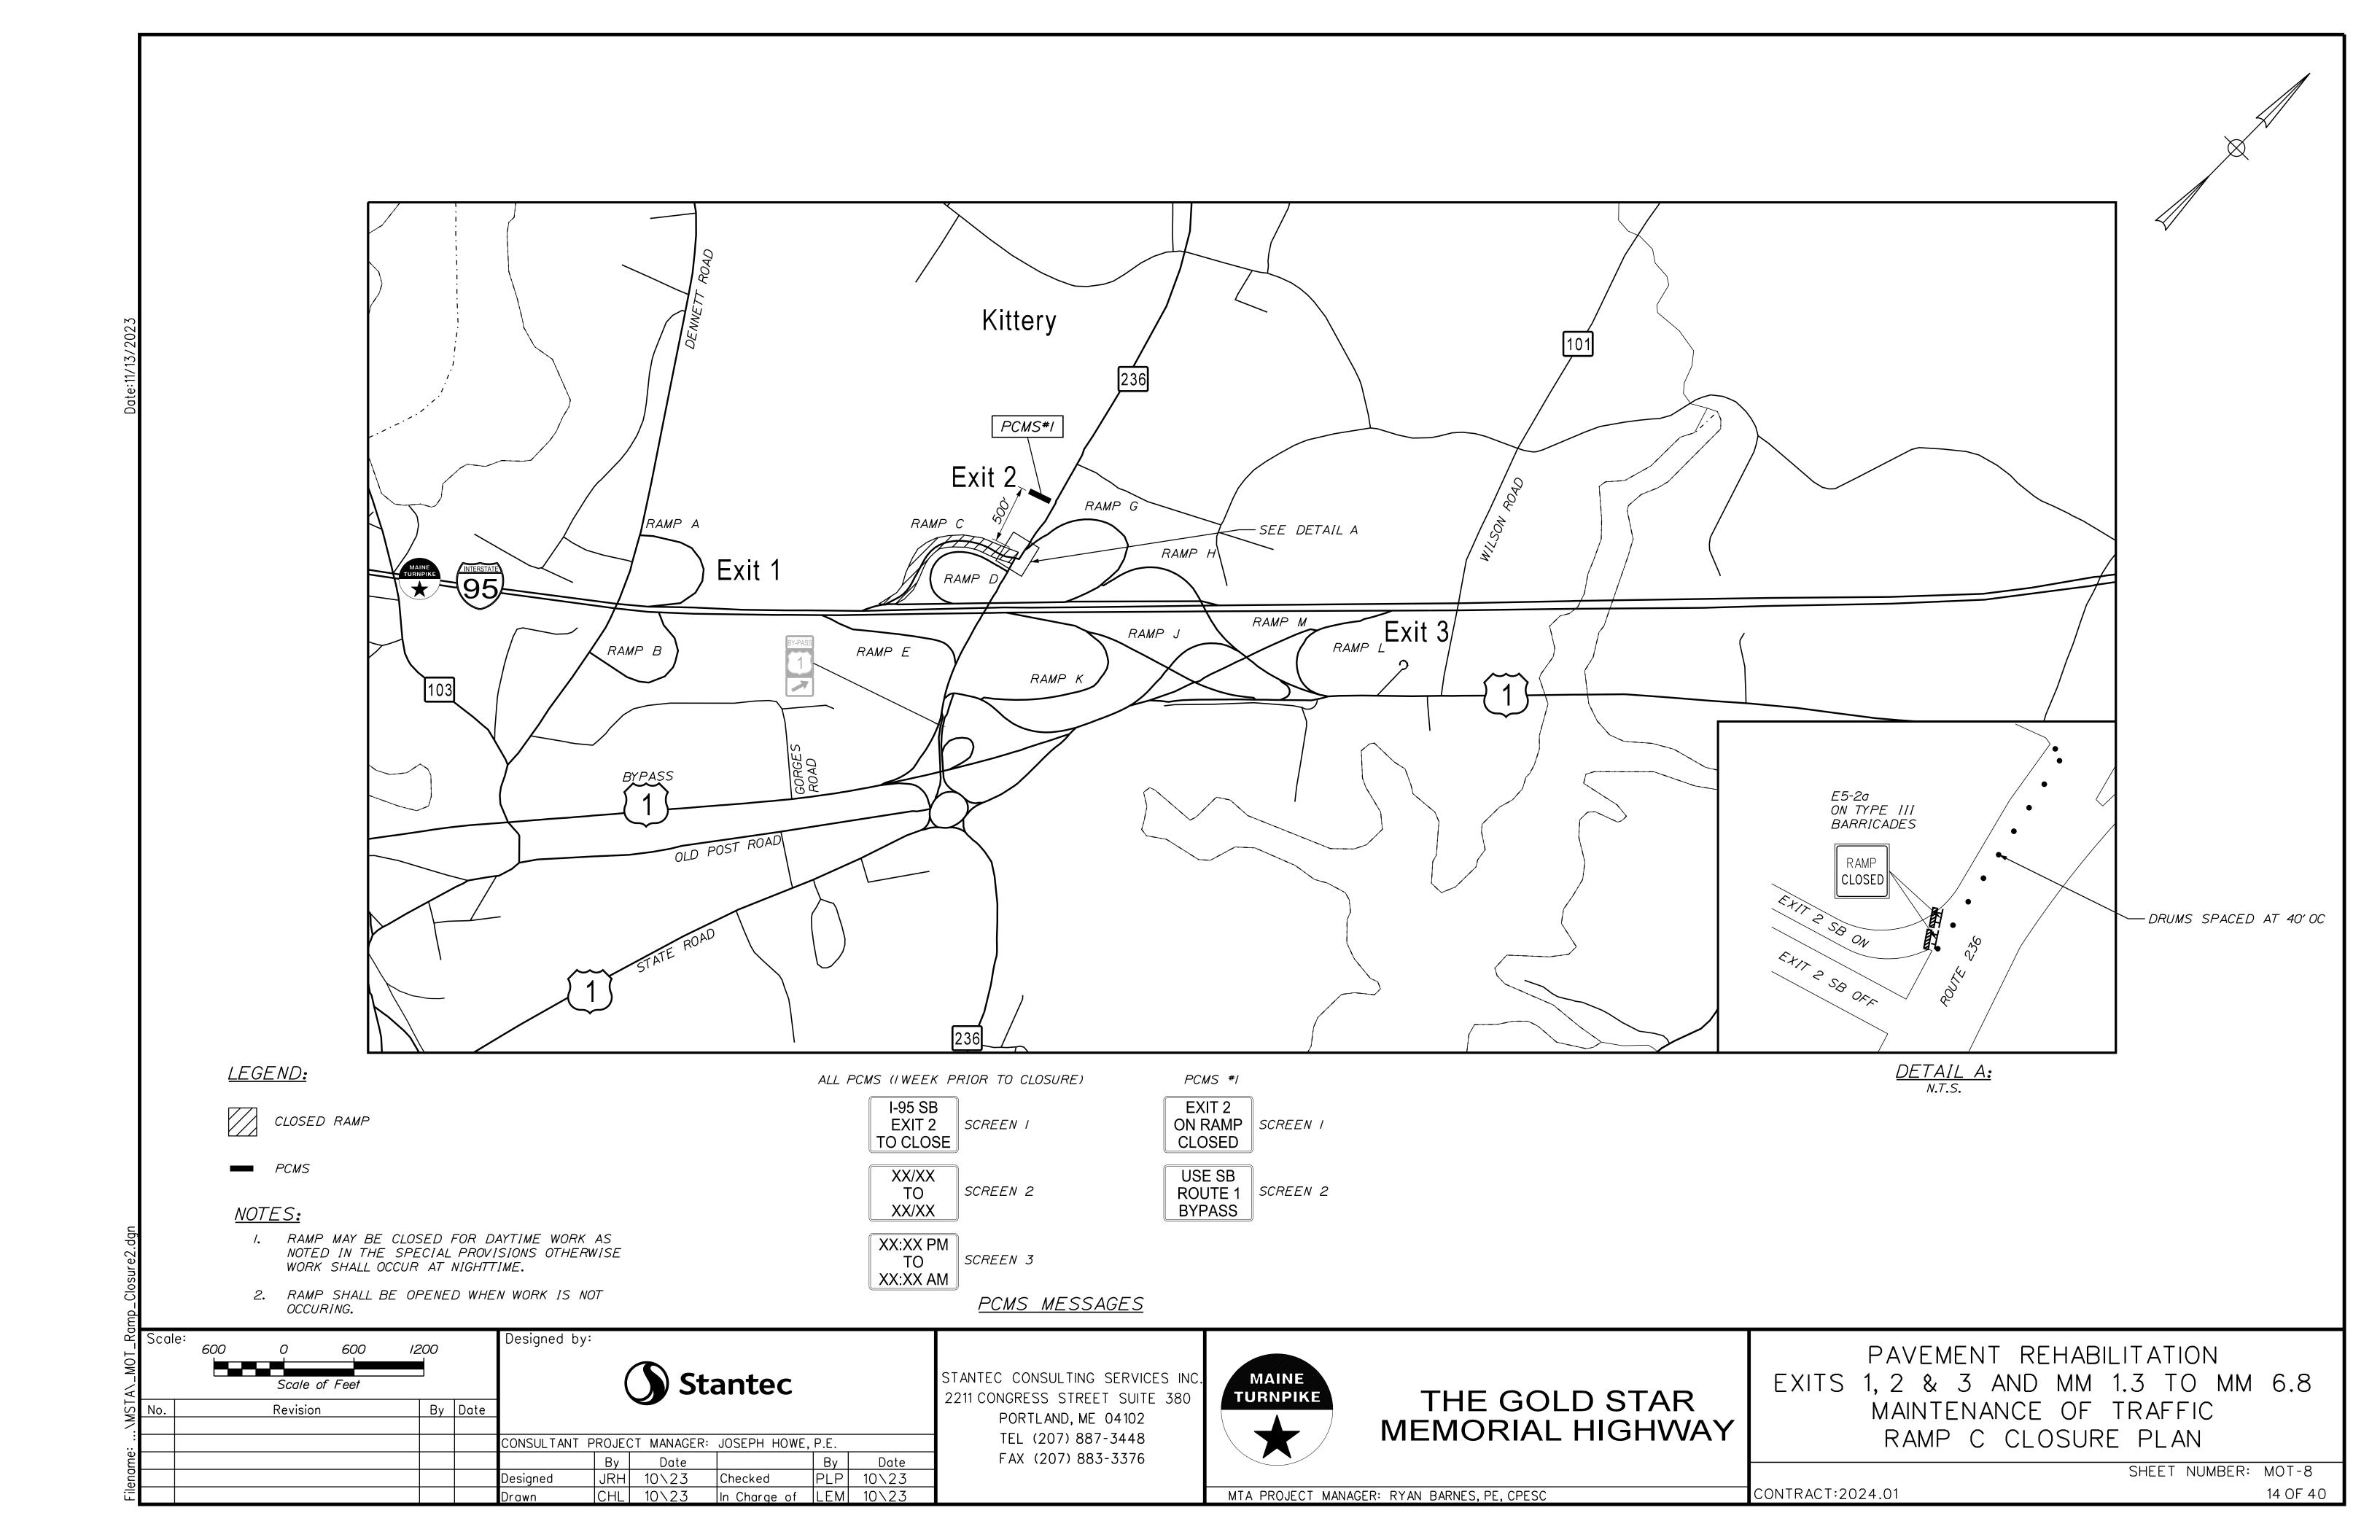


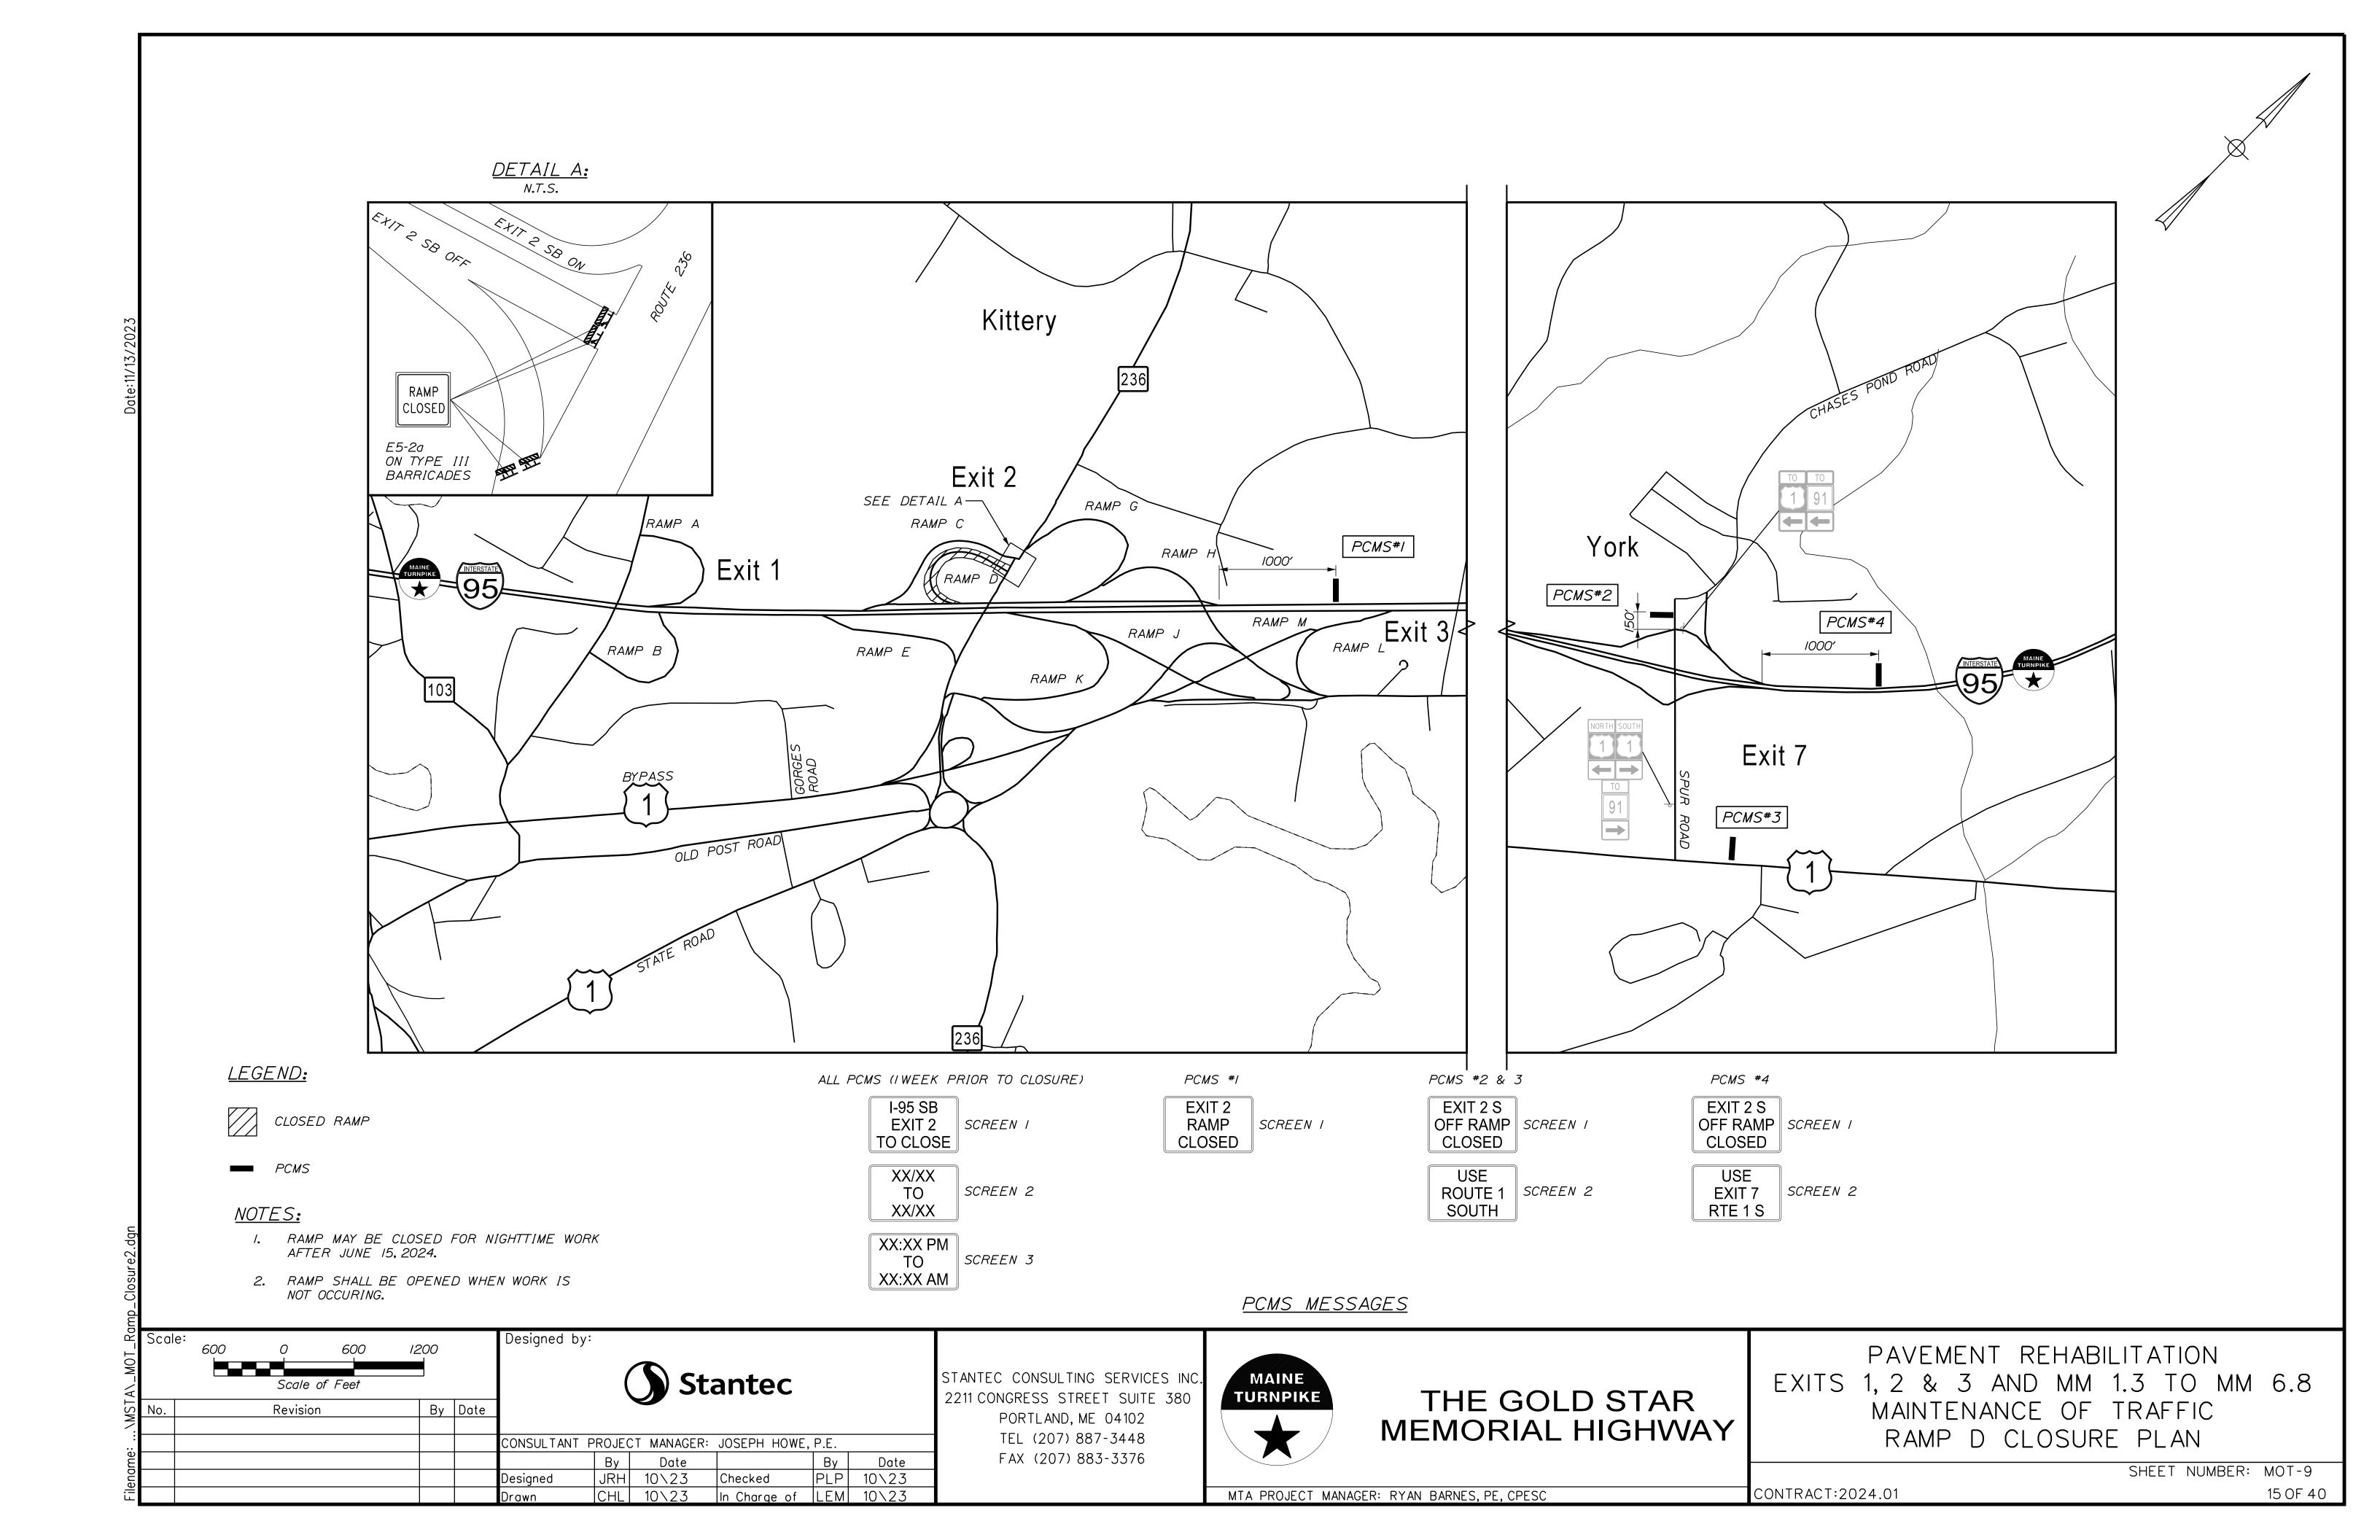

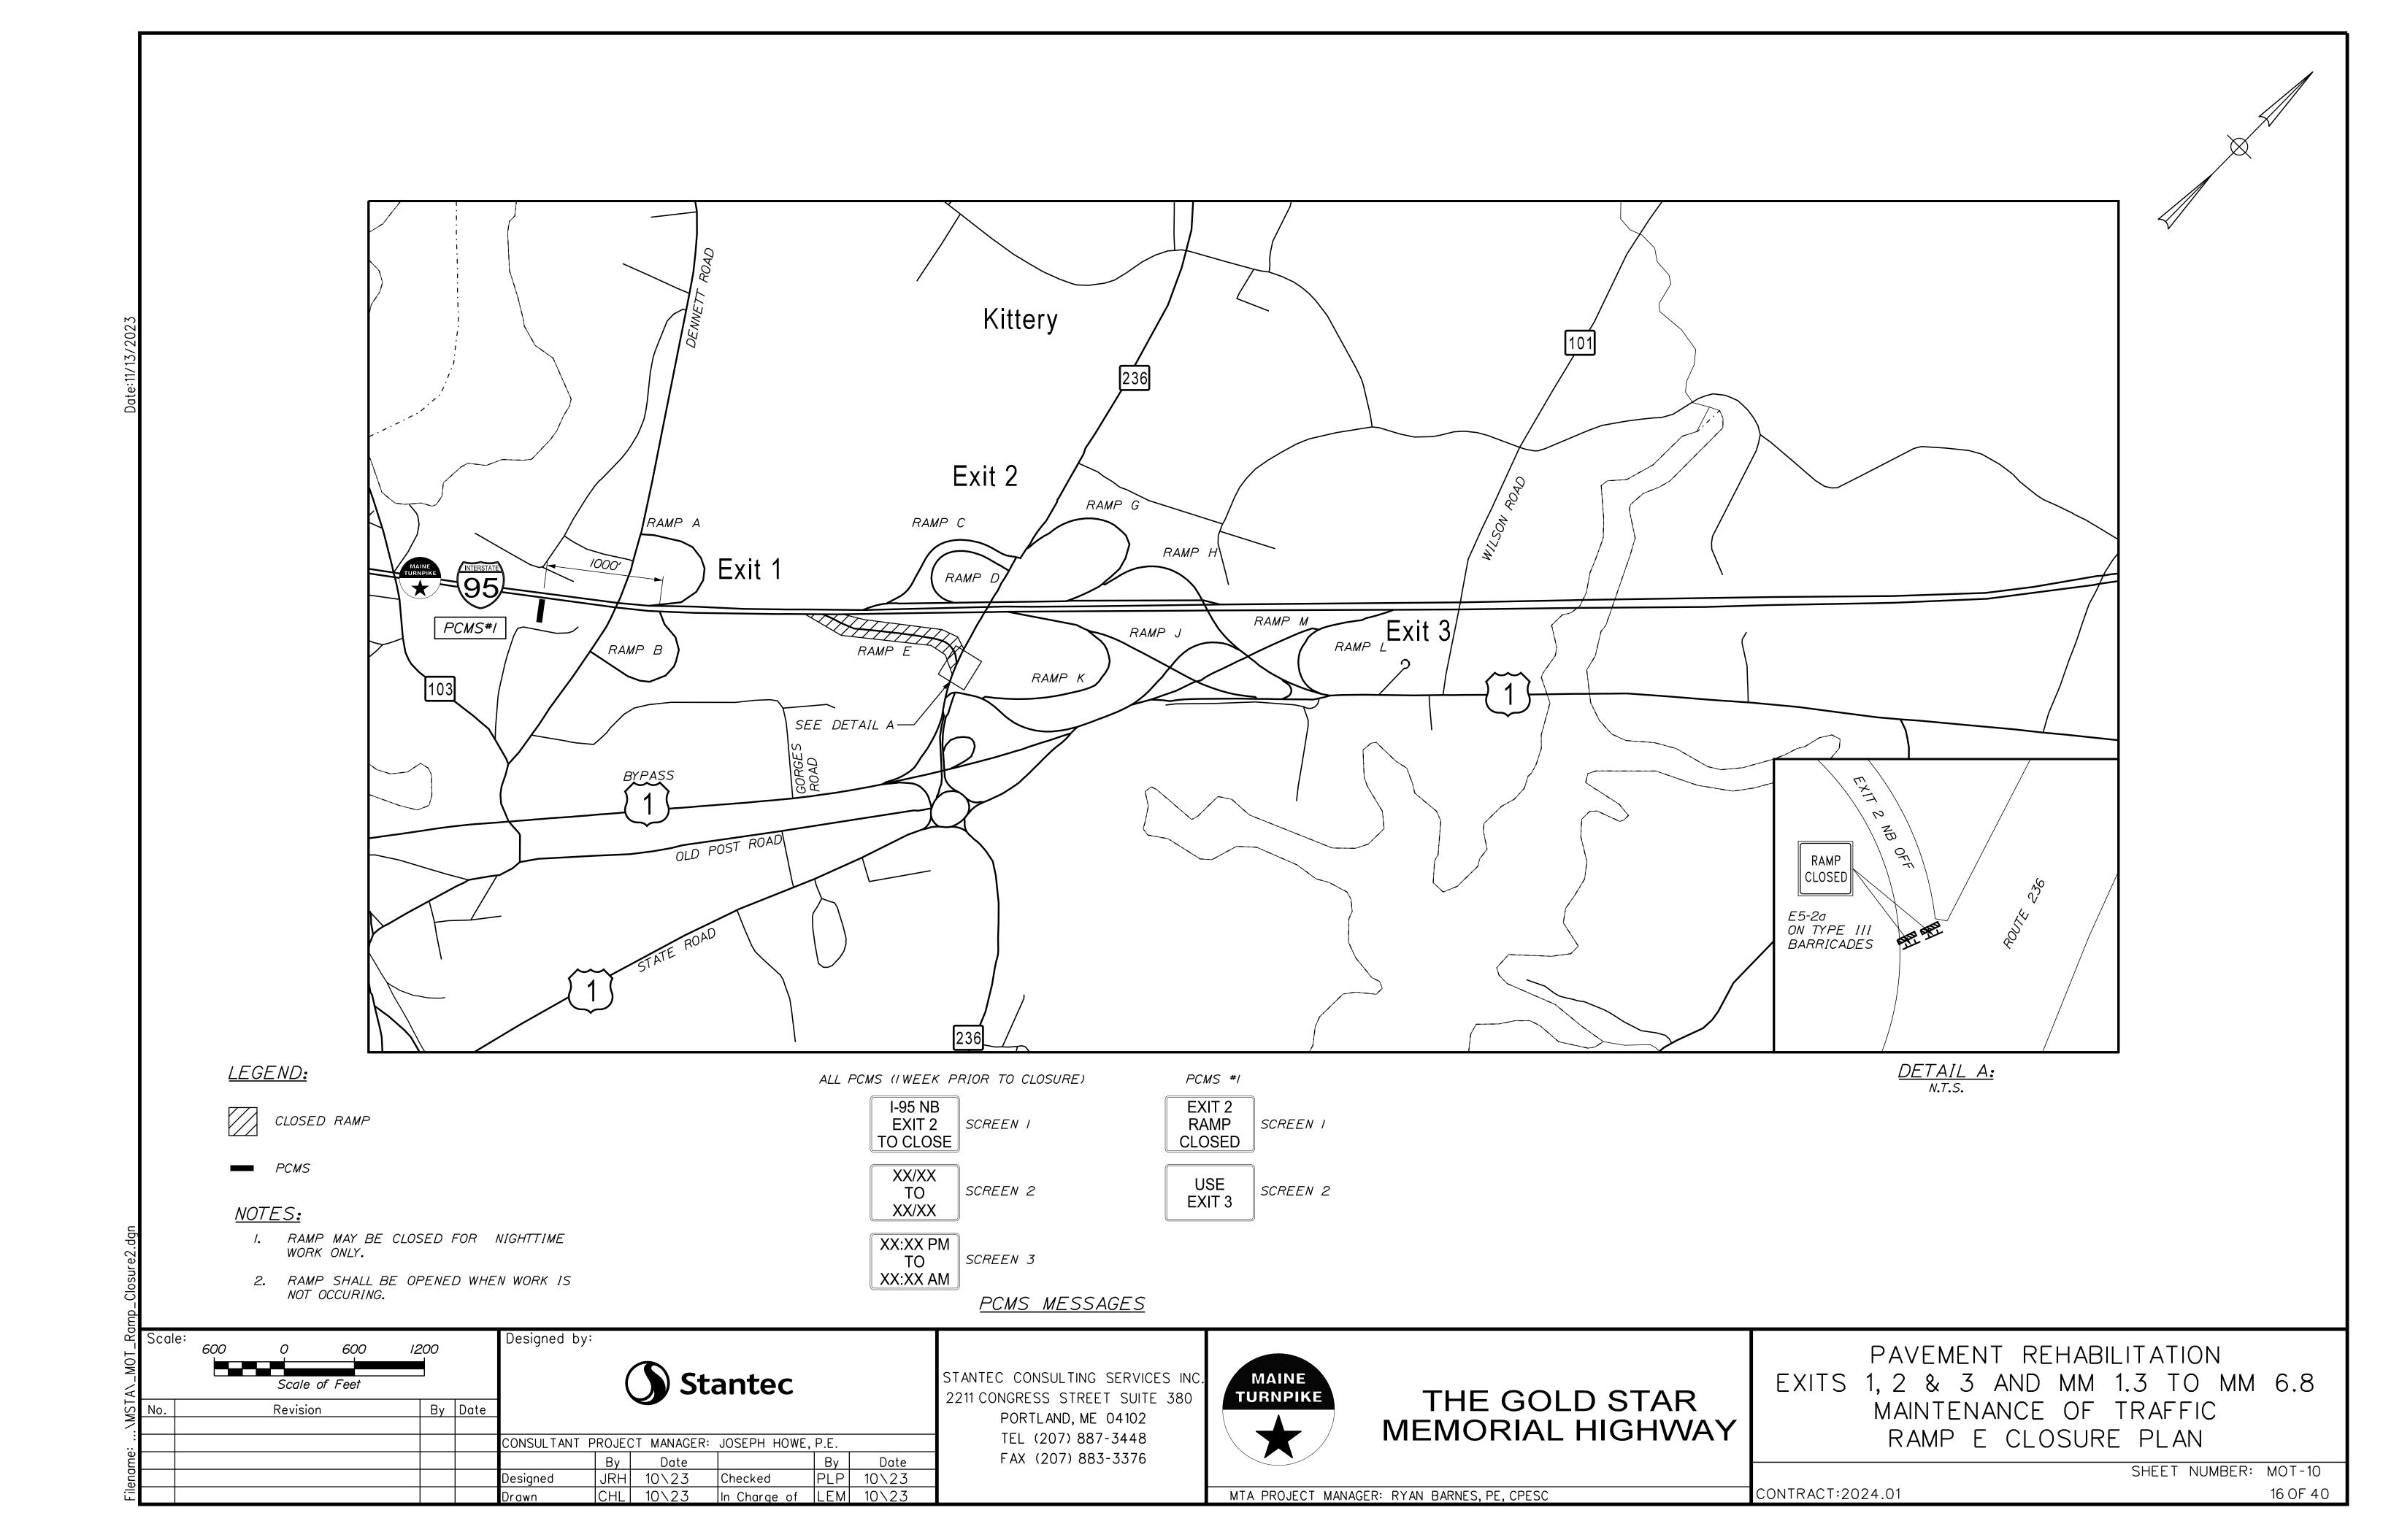

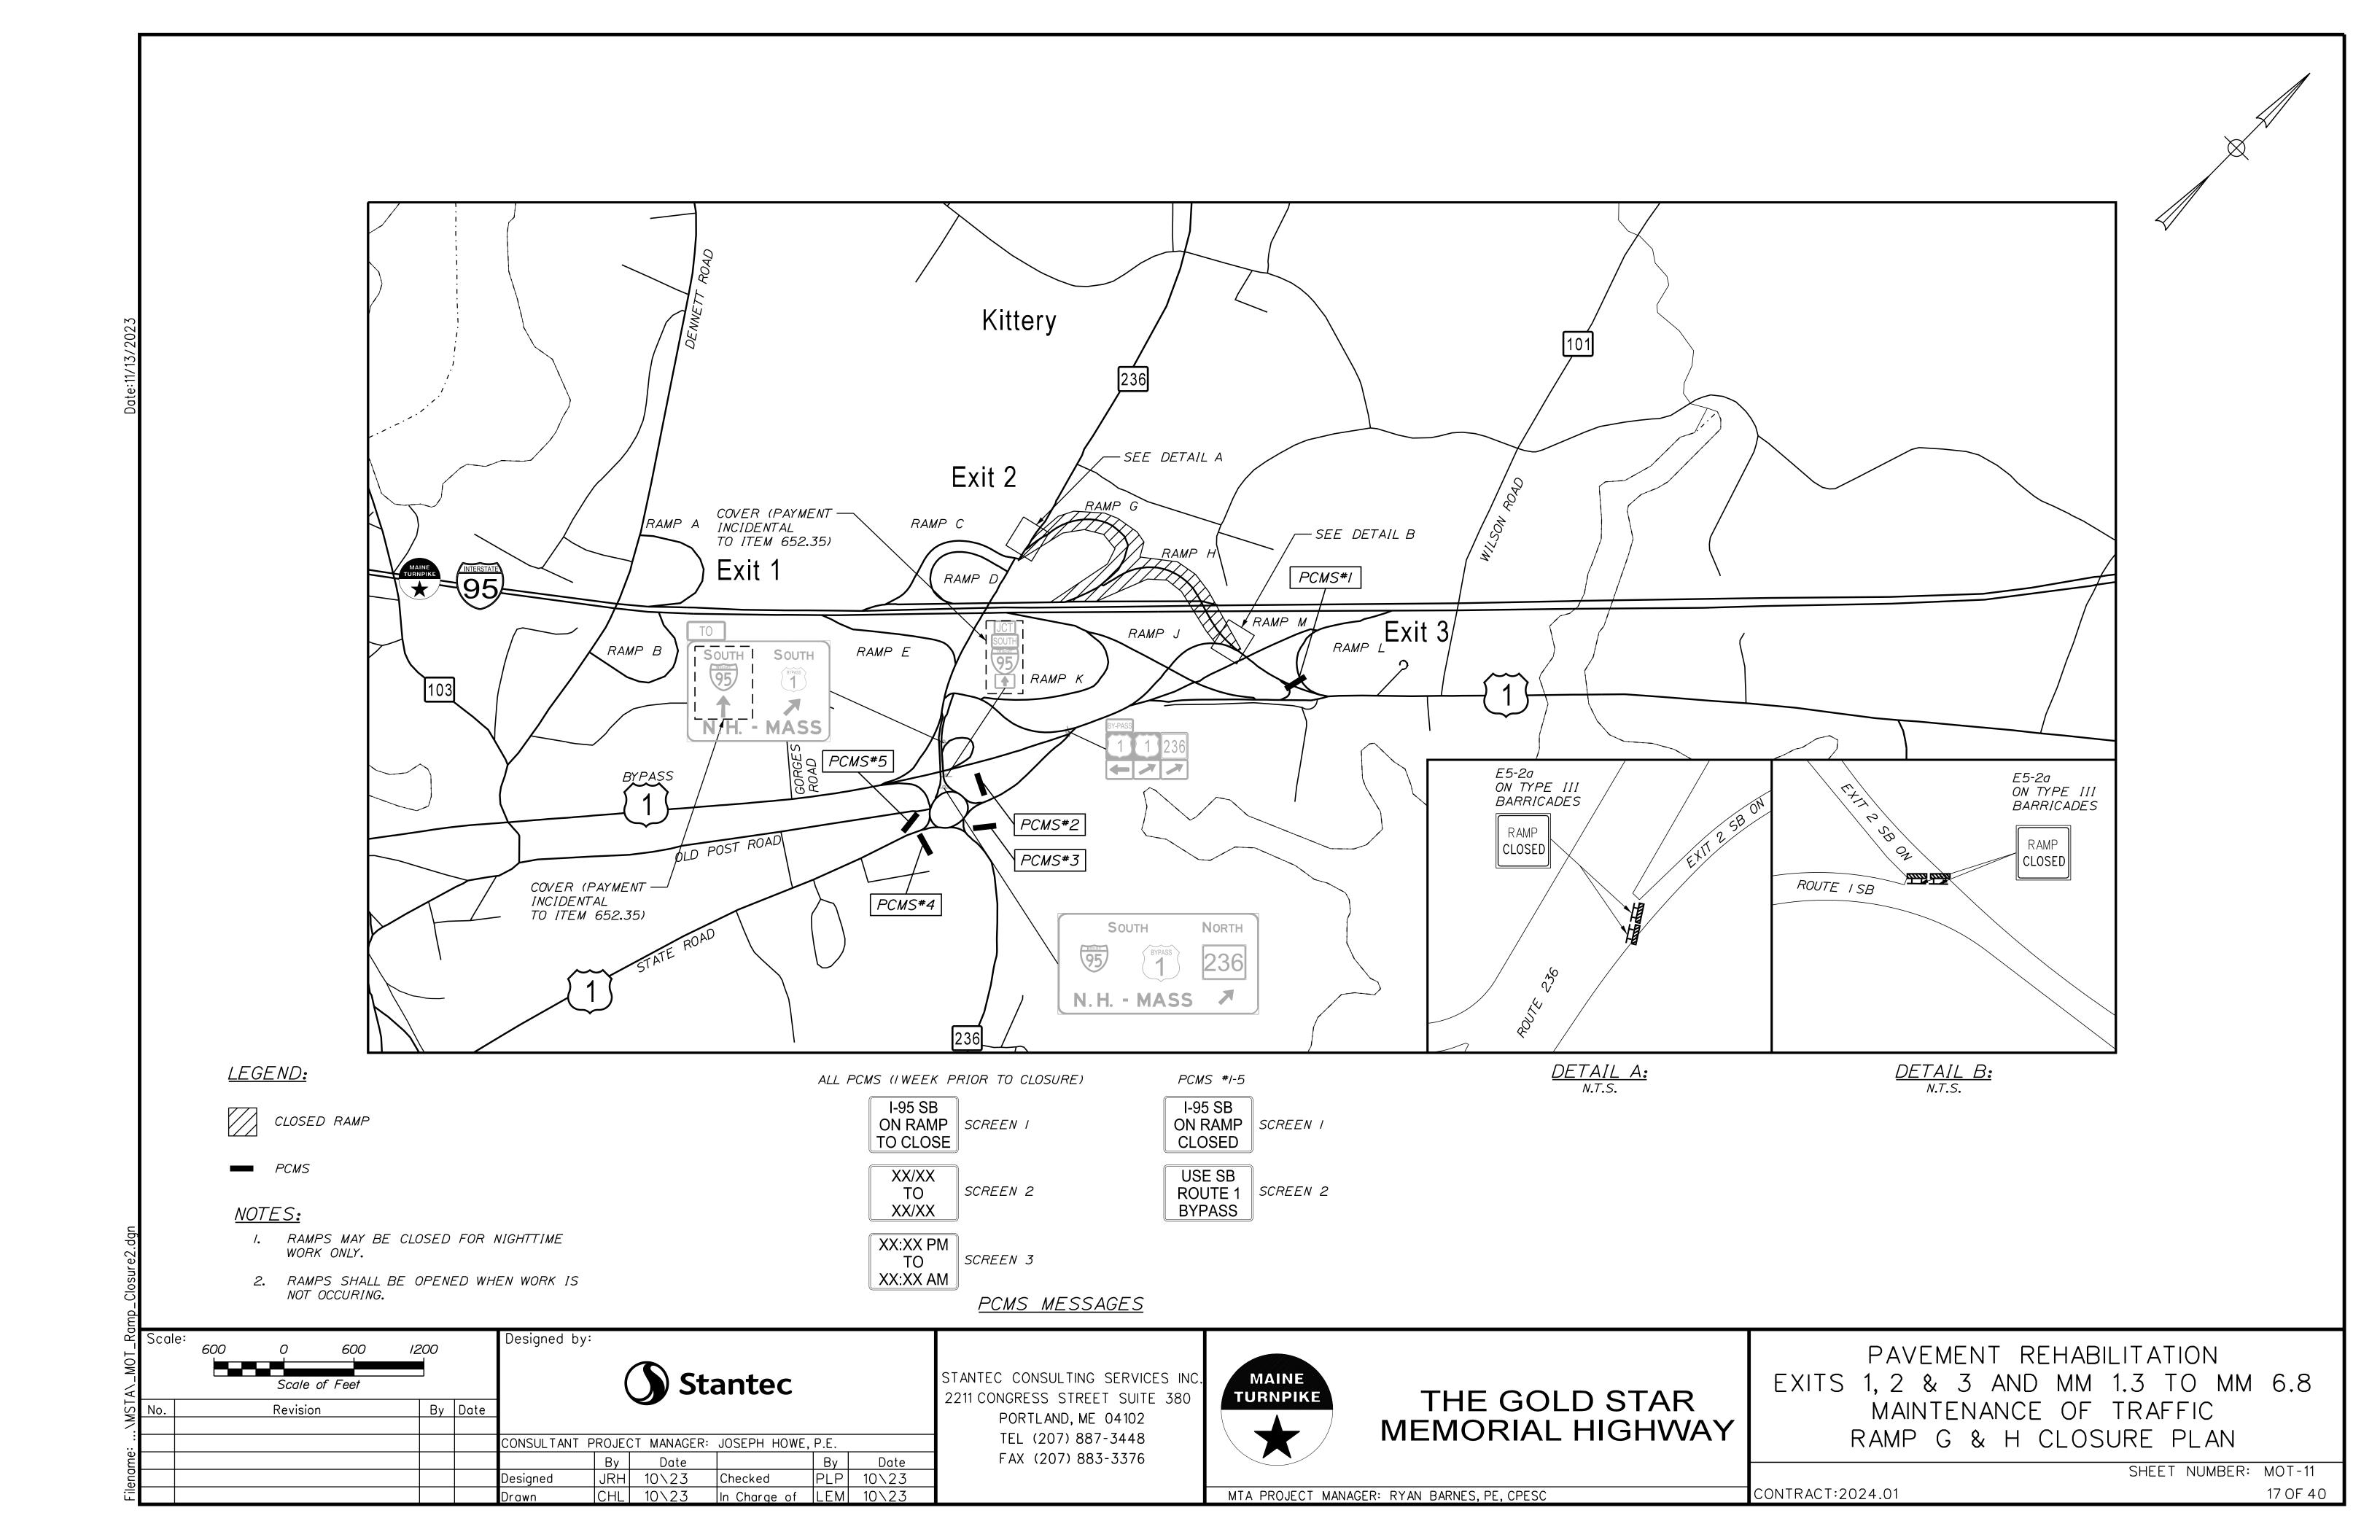

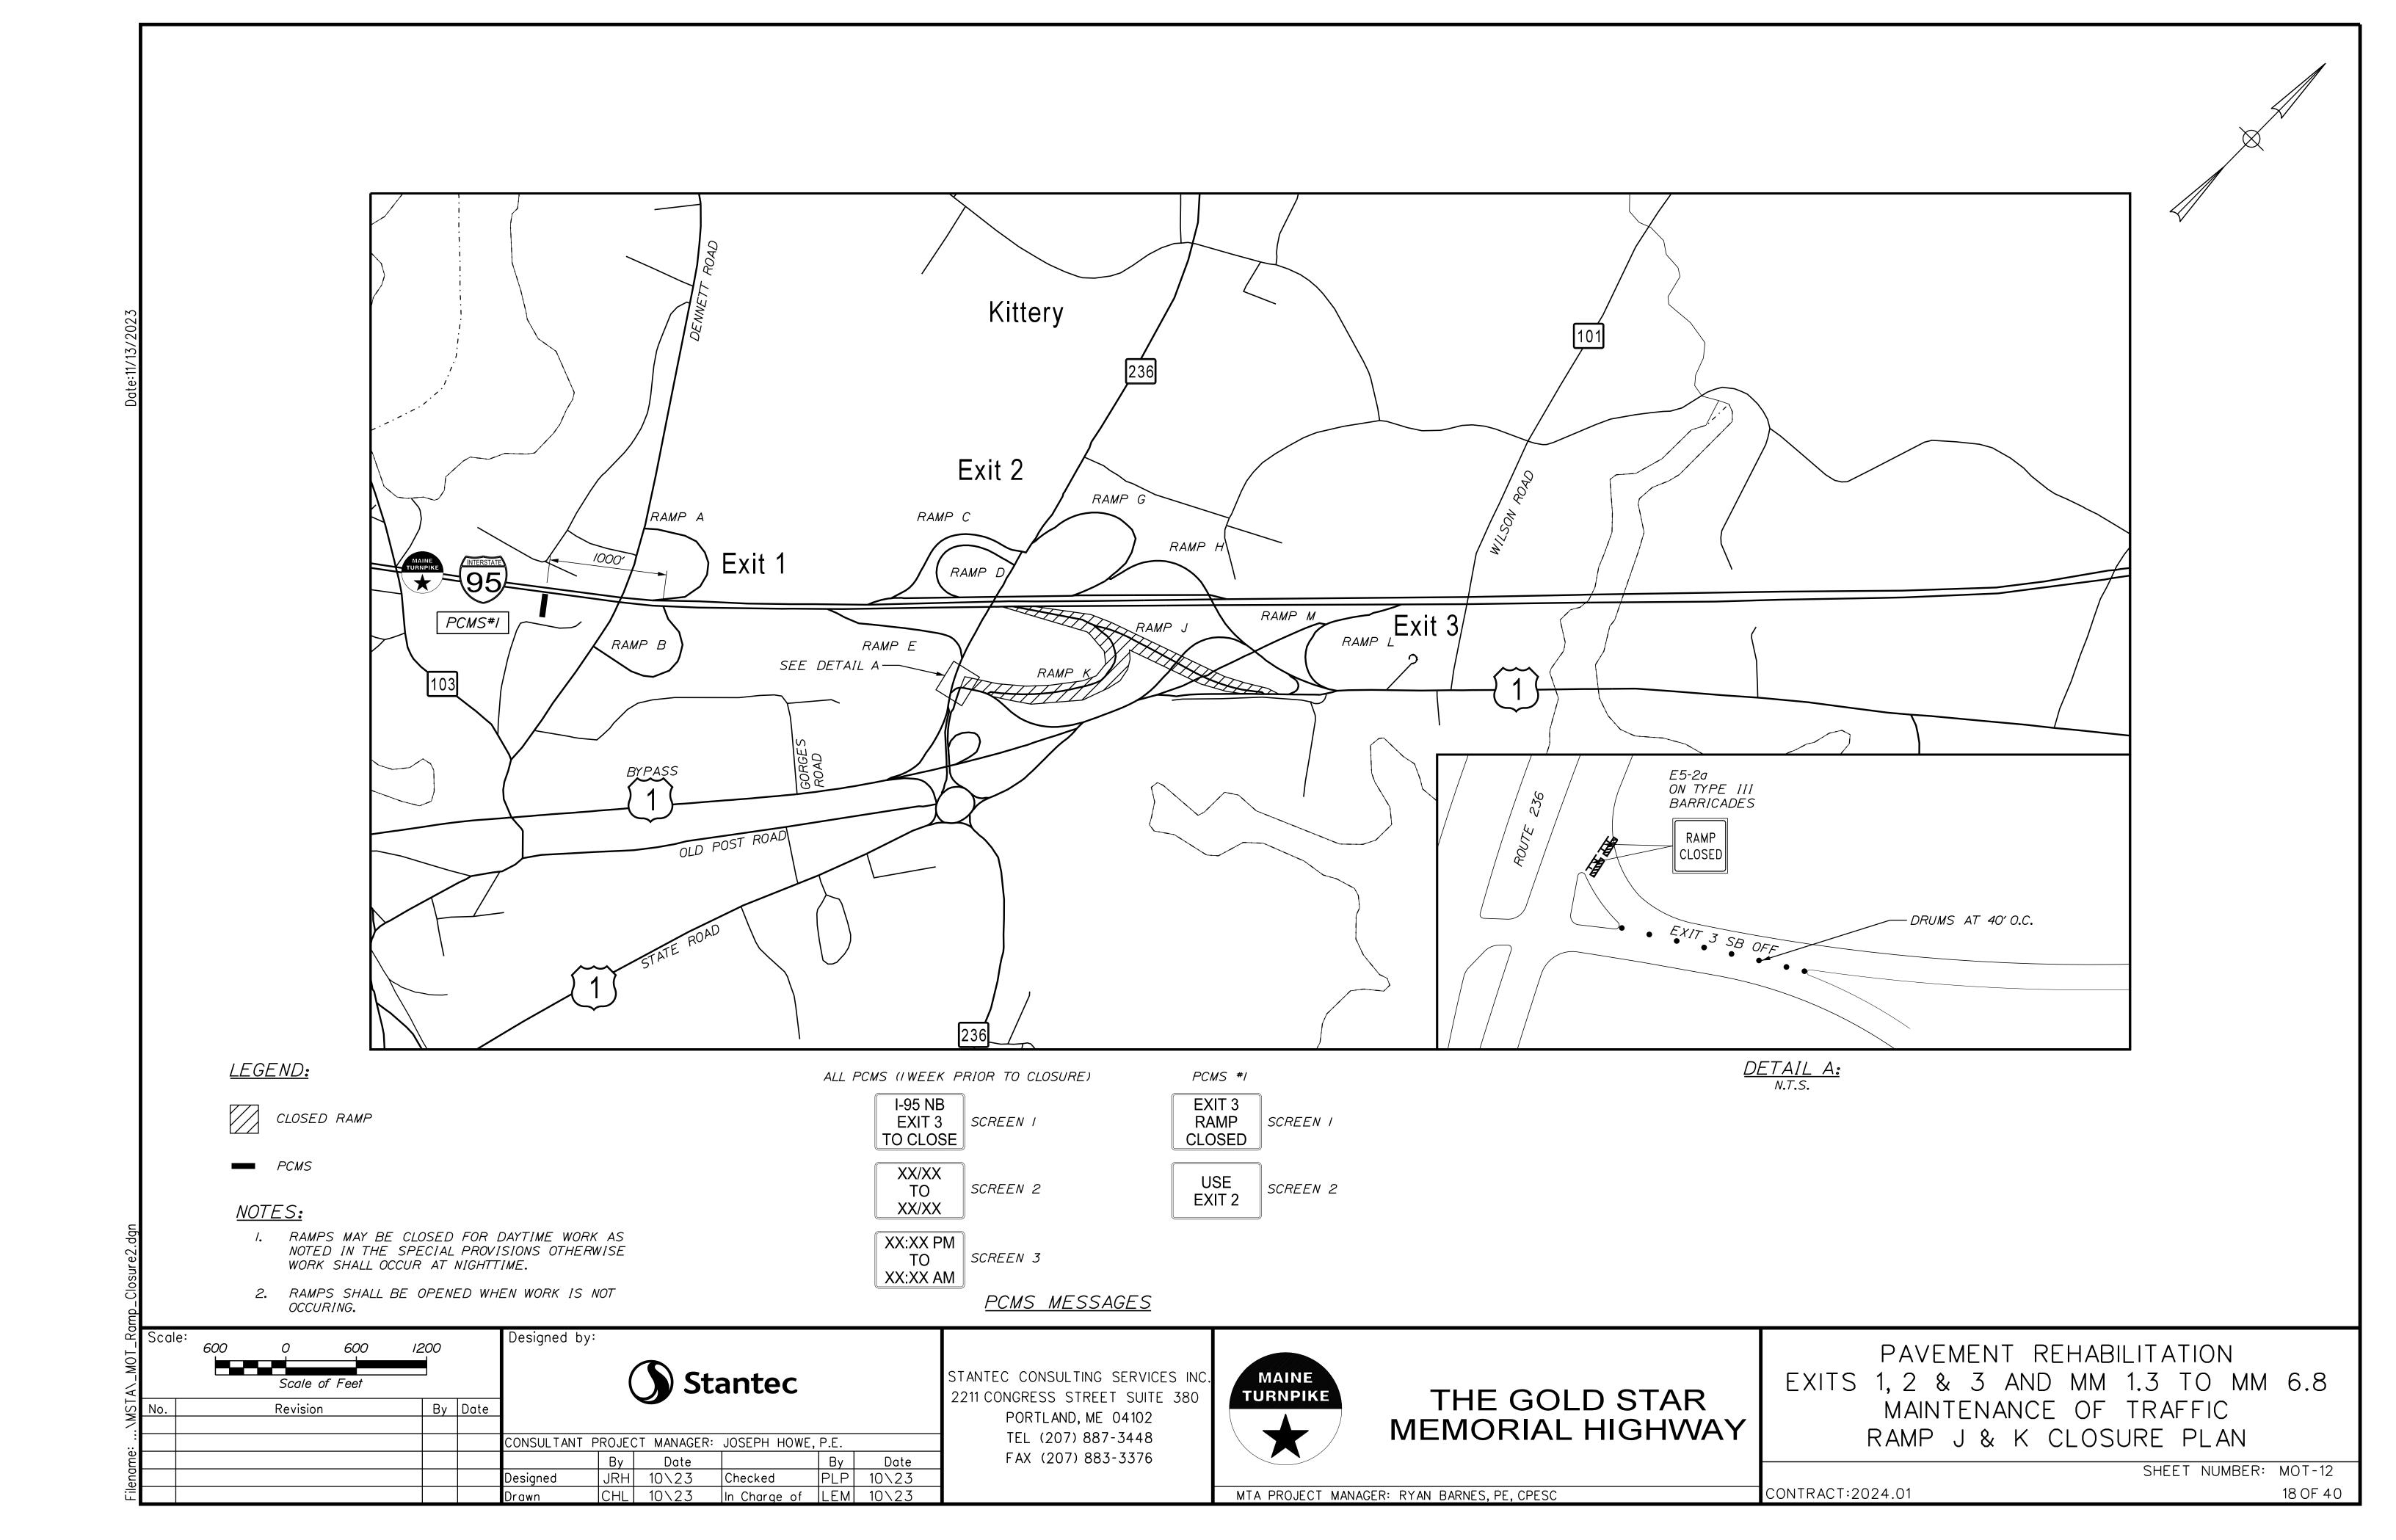

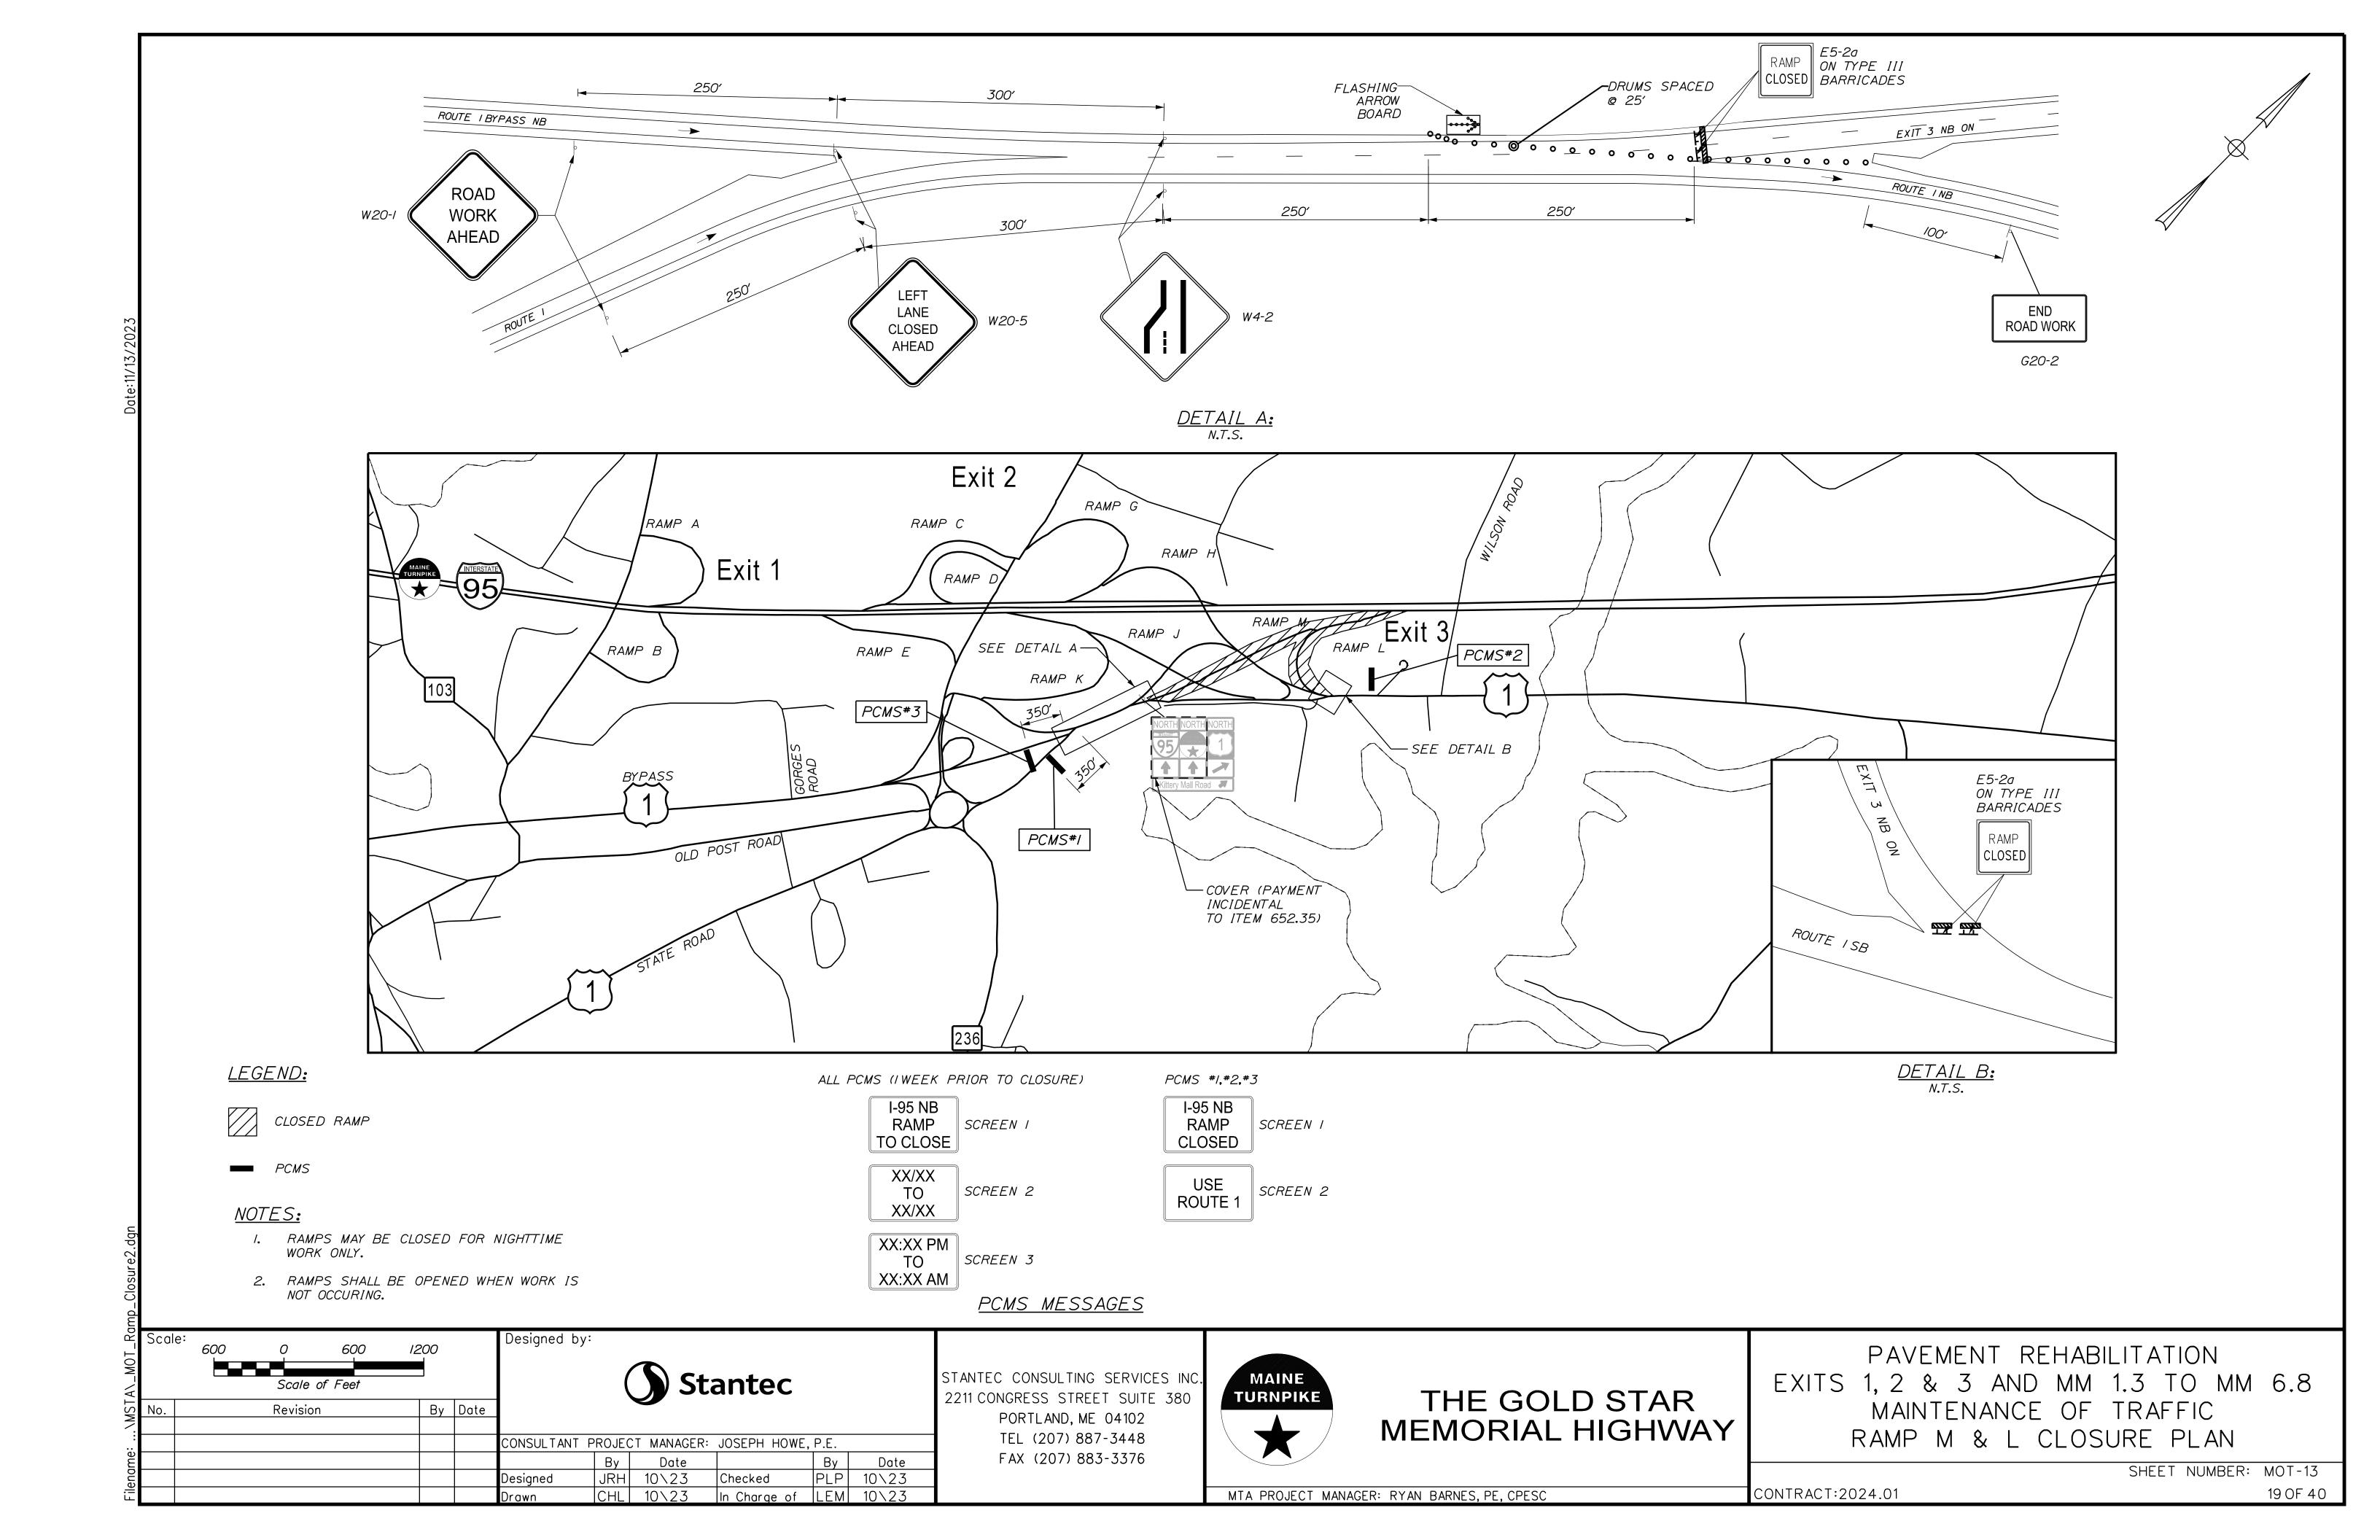

MUTCD NUMBER		SIGN		C	OLOR	TEXT DIME	ENSIONS	NUMBER	SIGN AREA	(SQ. FEET)	1,11,1TO D	SIZE OF	SIGN		CC	LOR	TEXT DIMENSIONS	NUMBER	SIGN AREA	(SQ. FEET)
NOWBLIN	WIDTH	HEIGHT	TEXT	BACK- GROUND	LEGEND BORDER	LETTER VERTION HEIGHT SPACE	CAL SHIELD/	OF SIGNS REQUIRED	NOM. AREA	TOTAL AREA	MUTCD NUMBER	WIDTH	HEIGHT	TEXT	BACK- GROUND		LETTER VERTICAL SHIELD HEIGHT SPACING ARRO	OF SIGNS	NOM. AREA	TOTAL AREA
CS-3	48"	48"	EXPECT STOPPED TRAFFIC	ORANGE		TEXT DIMENSI CONFORM TO HIGHWAY	IONS SHALL "STANDARD	6	16.00	128.00	M/-/	36"	36"	MAINE 95	RED/ BLUE	WHITE	TEXT DIMENSIONS SHALL CONFORM TO "STANDARD HIGHWAY SIGNS"		9.00	90.00
CS-4	48"	48"	EXIT CLOSED AHEAD	ORANGE	BLACK			2	16.00	32.00	M3-/	24"	12"	SOUTH	ORANGE	BLACK		/	2.00	2.00
CS-10	48"	48"	TRUCKS	ORANGE	BLACK			4	16.00	64.00	M4-5	24"	12"	TO	ORANGE	BLACK		3	2.00	6.00
CS-II	48"	48"	NO STOPPING ON PAVEMENT	ORANGE	BLACK			6	16.00	96.00	M4-8	24"	12"	DETOUR	ORANGE	BLACK		5	2.00	10.00
CS-33	96"	36"	WATCH FOR TRUCK ENTERING AND LEAVING WORK AREA	ORANGE	BLACK			4	24.00	96.00	M6-I(L)	21"	/5"		ORANGE	BLACK		3	2.19	6. 57
E5-I	48"	36"	EXIT	GREEN	WHITE			2	12.00	24.00	M6-2(R)	21"	/5"		ORANGE	BLACK		/	2.19	2.19
E5-2	48"	36"	EXIT OPEN	ORANGE	BLACK			2	12.00	24.00	M6-3	21"	15"		ORANGE	BLACK		/	2.19	2.19
E5-2a	48"	36"	RAMP	ORANGE	BLACK			12	12.00	144.00	RI-I	48"	48"	STOP	RED	WHITE		2	16.00	<i>32.00</i>
G20-2	48"	24"	END ROAD WORK	ORANGE	BLACK			16	8.00	112.00	RI-2	60" 60	0" 60"	Y I E L D	RED	WHITE		2	12.50	25.00
G20-5aP	48"	24"	WORK ZONE	ORANGE	BLACK			20	8.00	160.00	R2-I (35) (50) (60)	48"	60"	SPEED LIMIT XX	WHITE	BLACK		/ /6 8	20.00 20.00 20.00	20.00 320.00 160.00

By Date Revision

CONSULTANT PROJECT MANAGER: JOSEPH HOWE, P.E.

By Date

JRH 10\23

CHL 10\23

Designed

By Date
Checked LEM 10\23
In Charge of LEM 10\23

2211 CONGRESS STREET SUITE 380 TURNPIKE PORTLAND, ME 04102 TEL (207) 887-3448 FAX (207) 883-3376



THE GOLD STAR MEMORIAL HIGHWAY

MAINTENANCE OF TRAFFIC SIGN SUMMARY (1 OF 3)

CONTRACT:2024.01

SHEET NUMBER: MT-01 20 OF 40

		SIZE	OF SIGN		COLOR	TEXT DIMENSIONS	NUMBER	SIGN AREA	(SQ. FEET)	—	SIZE	OF SIGN		COL	.OR	TEXT DIMENSIONS	NUMBER	SIGN AREA	(SQ. FEET)
	MUTCD NUMBER		HEIGHT	TEVE	BACK- LEGEND	LETTER VERTICAL SHIELD/	OF SIGNS	NOM.	TOTAL	MUTCD NUMBER		HEIGHT	TEVE	BACK-	LEGEND	LETTER VERTICAL SHIELD/	OF SIGNS	NOM.	TOTAL
					GROUND BORDER	HEIGHT SPACING ARROW	REQUIRED	AREA	AREA					GROUND	BORDER	HEIGHT SPACING ARROW	REQUIRED	AREA	AREA
	R2-6aP	48"	24"	FINES DOUBLE	ORANGE BLACK	TEXT DIMENSIONS SHALL CONFORM TO "STANDARD HIGHWAY SIGNS"	16	8.00	128.00	W7-3aP (I MILE) (6 MILES	36"	30"	NEXT X MILES	ORANGE	BLACK		8 2	7.50 7.50	60.00 15.00
2025	R2-I2	36"	54"	END WORK ZONE SPEED LIMIT	ORANGE BLACK		12	/3.5	162.00	W8-I	48"	48"	BUMP	ORANGE	BLACK		12	16.00	192.00
Uate: 11/ 13/ 4	W3-/	48"	48"		ORANGE BLACK		2	16.00	32.00	W8-II	48"	48"	UNEVEN	ORANGE	BLACK		4	16.00	64.00
	W3-2	48"	48"		ORANGE BLACK		2	16.00	32.00	W8-15	48"	48"	GROOVED PAVEMENT	ORANGE	BLACK		21	<i>16.00</i>	336.00
	W3-4	48"	48"	BE PREPARED TO STOP	ORANGE BLACK		4	16.00	64.00	W8-I5P	30"	24"		ORANGE	BLACK		21	5.00	105.00
	W3-5 (50) (60)	48"	48"	SPEED LIMIT XX	ORANGE/ WHITE BLACK		12 12	16.00 16.00	192 192	W8-24a	48"	48"	RUMBLE STRIPS AHEAD	ORANGE	BLACK		8	16.00	128.00
	W4-1	48"	48"		ORANGE BLACK		2	16.00	32.00	W/3-4p	36"	36"	ON RAMP	ORANGE	BLACK		10	9.00	90.00
	W4-2L	48"	48"		ORANGE BLACK		16	16.00	256.00	WI6-4P	36"	30"	NEXT 1000 FT	ORANGE	BLACK		10	7.50	75.00
	W4-2R	48"	48"		ORANGE BLACK		12	16.00	192.00	W/6-9p	24"	12"	AHEAD	ORANGE	BLACK		2	2.00	4.00
ımary.dgn	W4-5p	24"	30"	NO MERGE AREA	ORANGE BLACK	TEXT DIMENSIONS SHALL CONFORM TO "STANDARD HIGHWAY SIGNS"	2	5.00	10.00	W20-I (AHEAD) (I MILE)		48"	ROAD WORK AHEAD	ORANGE	BLACK	TEXT DIMENSIONS SHALL CONFORM TO "STANDARD HIGHWAY SIGNS"	26 16	16.00 16.00	416.00 256.00
A_MO ;	cale: V(T 7() SCA		signed by:	Stantec		CONSULTING SI		MAINE TURNPIKE		THE	E GOLD S	TAR	{	PAVEMENT EXITS 1, 2 & 3 A MAINTENAN	ND MM	1.3 TO	MM 6.8

By Date Revision

By Date
Checked LEM 10\23
In Charge of LEM 10\23

CONSULTANT PROJECT MANAGER: JOSEPH HOWE, P.E.

By Date

JRH 10\23

CHL 10\23

Designed

PORTLAND, ME 04102 TEL (207) 887-3448 FAX (207) 883-3376



THE GOLD STAR MEMORIAL HIGHWAY


MAINTENANCE OF TRAFFIC SIGN SUMMARY (2 OF 3)

CONTRACT:2024.01

SHEET NUMBER: MT-01 210F 40

		OF CICAL		Τ		T ==.		0110			
MUTCD	SIZE U	F SIGN			DLOR		T DIMENSI		NUMBER	SIGN AREA	1
NUMBER	WIDTH	HEIGHT	TEXT	BACK- GROUND	LEGEND BORDER		VERTICAL SPACING			NOM. AREA	TOTAL AREA
W20-4	48"	48"	ONE LANE ROAD AHEAD	ORANGE	BLACK				2	16.00	32.00
W20-5L (AHEAD) (I/2 MILE)	48"	48"	LEFT LANE CLOSED AHEAD	ORANGE	BLACK				4	16.00 16.00	64 64
W2O-5aL (I/2 MILE)	48"	48"	2 LEFT LANES CLOSED 1/2 MILE	ORANGE	BLACK				4	16.00	64.00
W20-5aR (I/2 MILE)	48"	48"	RIGHT LANES CLOSED 1/2 MILE	ORANGE	BLACK				4	16.00	64.00
W20-5R (AHEAD) (I/2 MILE)	48"	48"	RIGHT LANE CLOSED 1/2 MILE	ORANGE	BLACK				2 2	16.00 16.00	32.00 32.00
W20-7	48"	48"		ORANGE	BLACK				2	16.00	32.00
W2I-5	48"	48"	SHOULDER	ORANGE	BLACK				6	16.00	96.00
W2I-5a (LEFT) (RIGHT)	48"	48"	RIGHT SHOULDER CLOSED	ORANGE	BLACK				2 2	16.00 16.00	32.00 32.00
W2I-5b (LEFT) (RIGHT)	48"	48"	RIGHT SHOULDER CLOSED 1000 FT	ORANGE	BLACK		V	•	2 2	16.00 16.00	32.00 32.00

MUTCD	SIZE (OF SIGN		CC	DLOR	TEX	T DIMENS	IONS	NUMBER	SIGN AREA	(SQ. FEET)
NUMBER	WIDTH	HEIGHT	TEXT	BACK- GROUND			VERTICAL SPACING		OF SIGNS REQUIRED	NOM. AREA	TOTAL AREA
LOGO S	36"	36"	MAINE TURNPIKE		Si	EE DET.	AILS		9	9.00	81.00

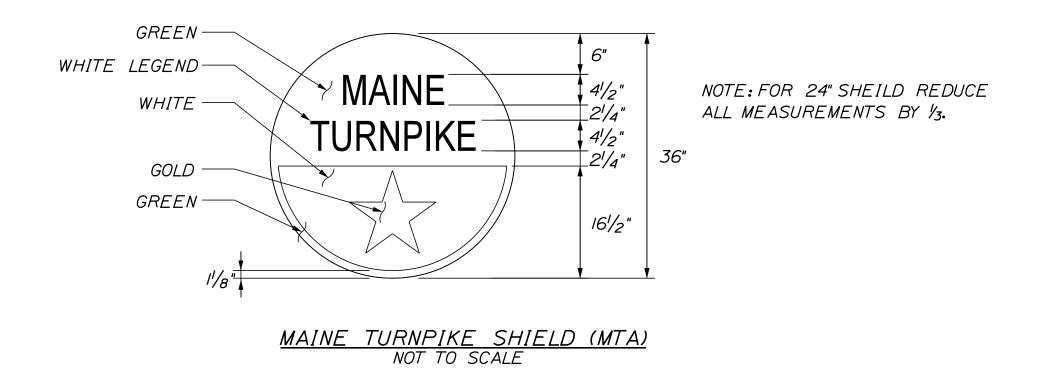

NOTES:

I. SIGN SUMMARY SHEETS INCLUDE SIGNS REQUIRED FOR SPRUCE CREEK BRIDGE WORK.

Revision

NOT TO SCALE **Stantec** By Date CONSULTANT PROJECT MANAGER: JOSEPH HOWE, P.E. By Date
JRH 10\23 By Date LEM 10\23 Checked Designed

CHL 10\23

In Charge of LEM 10\23

Designed by:

STANTEC CONSULTING SERVICES INC. 2211 CONGRESS STREET SUITE 380 PORTLAND, ME 04102 TEL (207) 887-3448 FAX (207) 883-3376



THE GOLD STAR MEMORIAL HIGHWAY

PAVEMENT REHABILITATION EXITS 1, 2 & 3 AND MM 1.3 TO MM 6.8 MAINTENANCE OF TRAFFIC SIGN SUMMARY (3 OF 3)

> SHEET NUMBER: MT-01 22 OF 40


MTA PROJECT MANAGER: RYAN BARNES, PE, CPESC

CONTRACT:2024.01

DIMENSIONS FOR SLOPE OF 2:1


							STONE	STONE
D	а	b	С	е	f	g	DEPTH	(CY)
	(FT)	(FT)	(FT)	(FT)	(FT)	(FT)	(FT)	
12"	1.00	4.00	3.00	2.00	6.00	1.00	1.50	1.30
15"	1.00	4.50	3.37	2.25	6.75	1.63	1.50	1.70
18"	1.00	5.00	3.75	2.50	7.50	2.25	1.50	2.09
21"	1.00	5.50	4.13	2.75	8.25	2.88	1.50	2.58
24"	1.00	6.00	4.50	3.00	9.00	3.50	1.50	3.12
30"	1.00	7.00	5.25	3.50	10.50	4.75	1.50	4.33
36"	1.00	8.00	6.00	4.00	12.00	6.00	1.50	5.75
42"	1.00	9.00	6.75	4.50	13.50	7.25	1.50	7.37
48"	1.00	10.00	7.50	5.00	15.00	8.50	1.50	9.18
54"	1.00	11.00	8.25	5.50	16.50	9.75	1.50	11.19
60"	1.00	12.00	9.00	6.00	18.00	11.00	1.50	13.40
66"	1.00	13.00	9.75	6.50	19.50	12.25	1.50	15.81
72"	1.00	14.00	10.50	7.00	21.00	13.50	1.50	18.41
84"	1.00	16.00	12.00	8.00	24.00	16.00	1.50	24.22

PLAIN RIPRAP (ITEM 610.08)

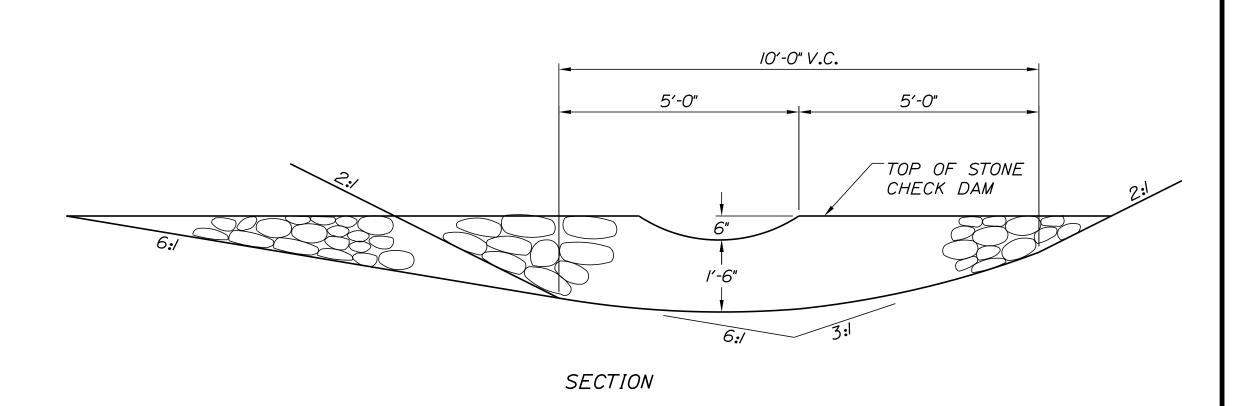

DIMENSIONS FOR SLOPE OF 4:1

							STONE	STONE
D	а	Ь	С	е	f	g	DEPTH	(CY)
	(FT)	(FT)	(FT)	(FT)	(FT)	(FT)	(FT)	
12"	1.00	8.00	6.00	2.00	6.00	0.00	1.50	2.20
15"	1.00	9.00	6.75	2.25	6.75	0.00	1.50	2.80
18"	1.00	10.00	7.50	2.50	7.50	0.00	1.50	3.40
21"	1.00	11.00	8.25	2.75	8.25	0.00	1.50	4.10
24"	1.00	12.00	9.00	3.00	9.00	0.00	1.50	4.86
30"	1.00	14.00	10.50	3.50	10.50	0.00	1.50	6.58
36"	1.00	16.00	12.00	4.00	12.00	0.00	1.50	8.56
42"	1.00	18.00	13.50	4.50	13.50	0.50	1.50	10.92
48"	1.00	20.00	15.00	5.00	15.00	1.00	1.50	13.57
54"	1.00	22.00	16.50	5.50	16.50	1.50	1.50	16.50
60"	1.00	24.00	18.00	6.00	18.00	2.00	1.50	19.72
66"	1.00	26.00	19.50	6.50	19.50	2.50	1.50	23.22
72"	1.00	28.00	21.00	7.00	21.00	3.00	1.50	27.01
84"	1.00	32.00	24.00	8.00	24.00	4.00	1.50	35.45

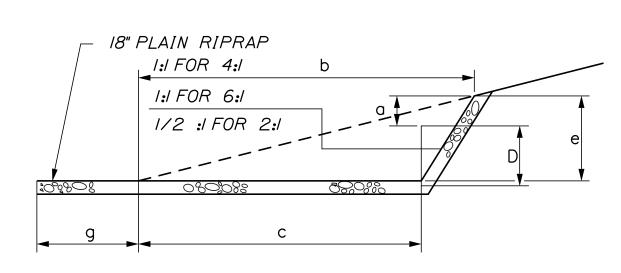

SECTION B-B

STONE DITCH CHECK DAM
(SEE PLAN SHEETS FOR LOCATION)

BOTTOM OF STONE

TOP OF STONE


9'-10' (6:1 FORESLOPE)

6'-0' (2:1 FORESLOPE)

PLAN

DIMENSIONS FOR SLOPE OF 6:1

D	a	b	С	е	f	0	STONE DEPTH	STONE (CY)
	(FT)	(FT)	(FT)	(FT)	(FT)	g (FT)	(FT)	
12"	0.50	9.00	7.50	1.50	4.50	0.00	1.50	2.30
15"	0.50	10.50	8.75	1.75	5.50	0.00	1.50	2.93
18"	0.50	12.00	10.00	2.00	6.50	0.00	1.50	3.57
21"	0.50	13.50	11.25	2.25	7.25	0.00	1.50	4.46
24"	0.50	15.00	12.50	2.50	8.00	0.00	1.50	5.44
30"	0.50	18.00	15.00	3.00	9.50	0.00	1.50	7.71
36"	0.50	21.00	17.50	3.50	11.00	0.00	1.50	10.37
42"	0.50	24.00	20.00	4.00	12.50	0.00	1.50	13.42
48"	0.50	27.00	22.50	4.50	14.00	0.00	1.50	16.87
54"	0.50	30.00	25.00	5.00	15.50	0.00	1.50	20.70
60"	0.50	33.00	27.50	5.50	17.00	0.00	1.50	24.93
66"	0.50	36.00	30.00	6.00	18.50	0.00	1.50	29.55
72"	0.50	39.00	32.50	6.50	20.00	0.00	1.50	34.56
84"	0.50	45.00	37.50	7.50	23.00	0.00	1.50	45.76

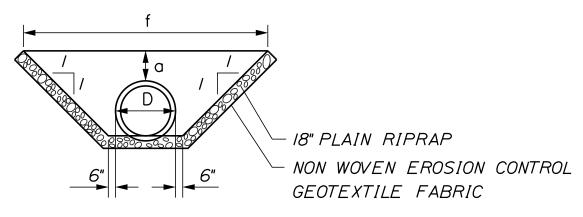

 FORESLOPE
 BACKSLOPE
 QUANTITY C.Y. STONE

 6:1
 3:1
 2.5

 2:1
 3:1
 2.0

I.STONE FOR TEMPORARY AND PERMANENT STONE
CHECK DAMS SHALL MEET THE REQUIREMENTS
OF MDOT SPECIFICATION 703.29, STONE DITCH
PROTECTION.
2. TEMPORARY STONE CHECK DAMS WILL BE

PAID FOR UNDER ITEM 610.181.

STONE CHECK DAM

ROADWAY CULVERT END SLOPE TREATMENT

SECTION A-A

NOTES:
I. THE DIMENSIONS SHOWN ARE APPROXIMATE AND MAY
BE MODIFIED BY THE RESIDENT.
2.STONE QUANTITIES ARE FOR ONE END OF THE PIPE.

Scale:	Designed by:								
	Stantec								
No.	Revision	Ву	Date	1					
				CONSULTANT	PROJE(CT MANAGER	: JOSEPH HOWE,	, P.E.	
					Ву	Date		Ву	Date
				Designed	JRH	10\23	Checked	LEM	10\23
				Drawn	СНІ	10\23	In Charge of	IFM	10 \ 2.3


STANTEC CONSULTING SERVICES INC.
2211 CONGRESS STREET SUITE 380
PORTLAND, ME 04102
TEL (207) 887-3448
FAX (207) 883-3376




THE GOLD STAR MEMORIAL HIGHWAY


PAVEMENT REHABILITATION
EXITS 1, 2 & 3 AND MM 1.3 TO MM 6.8
DRAINAGE DETAILS
(1 OF 2)

SHEET NUMBER: DT-01 CONTRACT:2024.01 23 OF 40

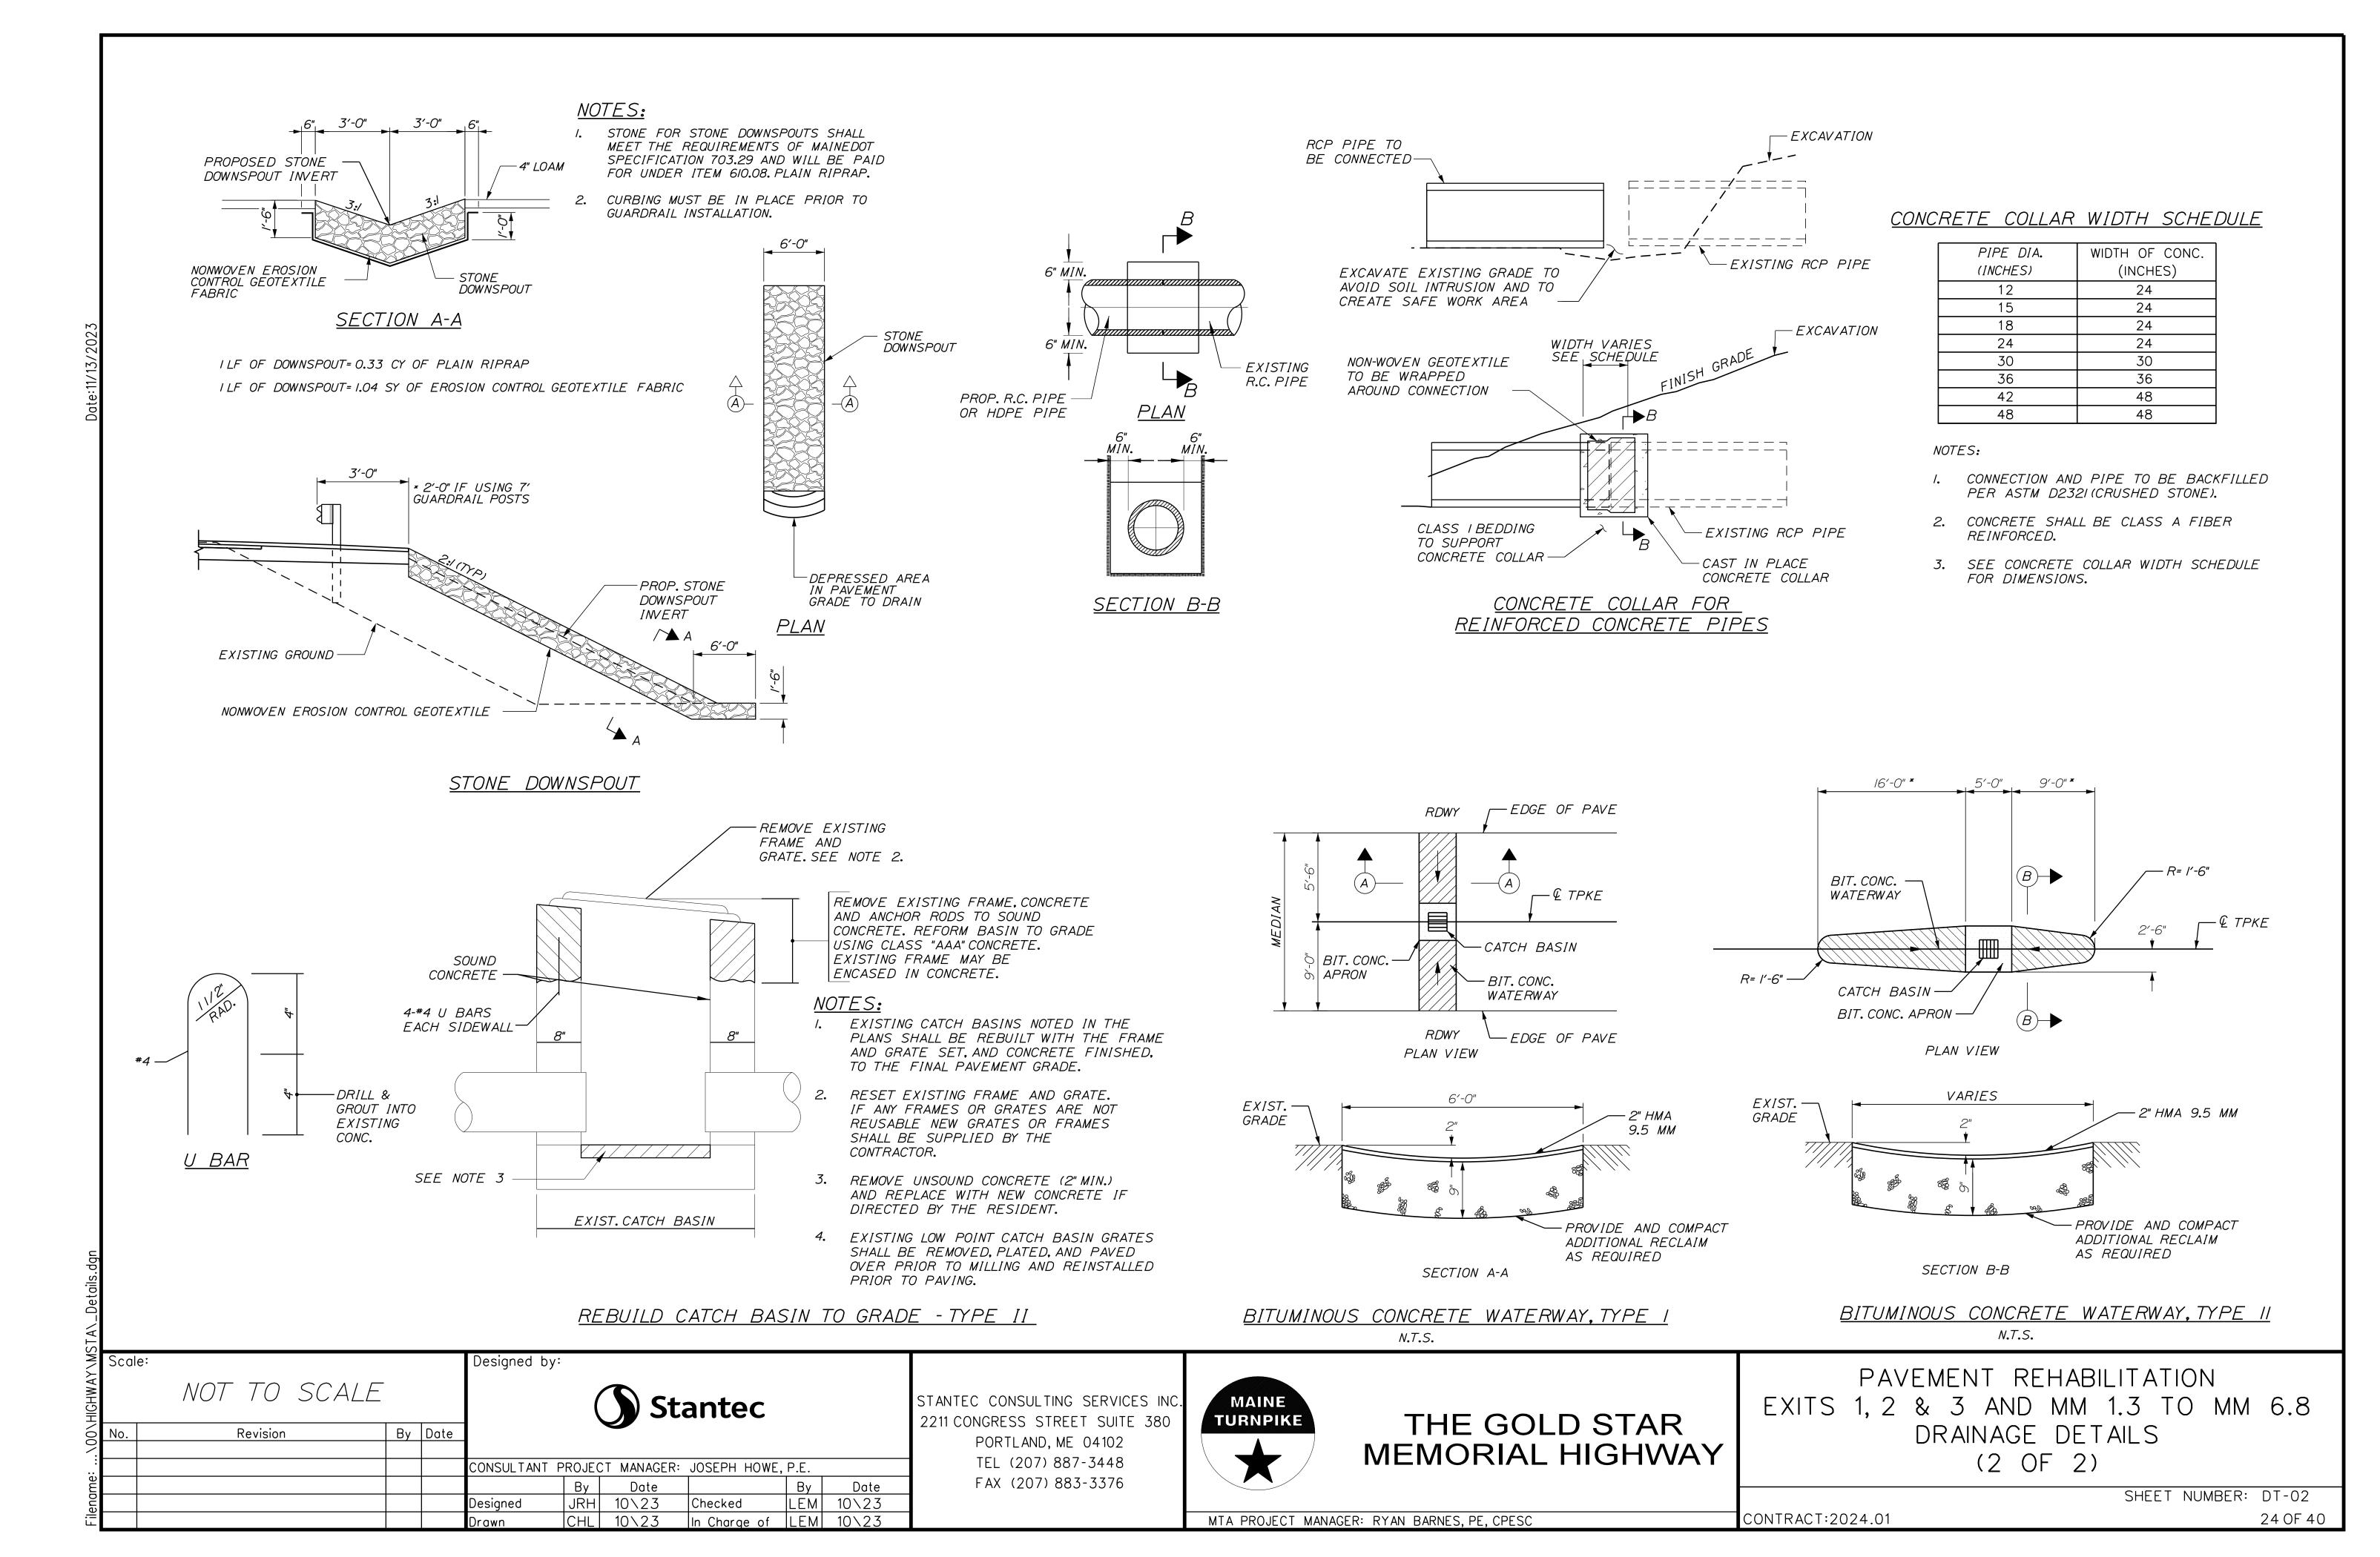


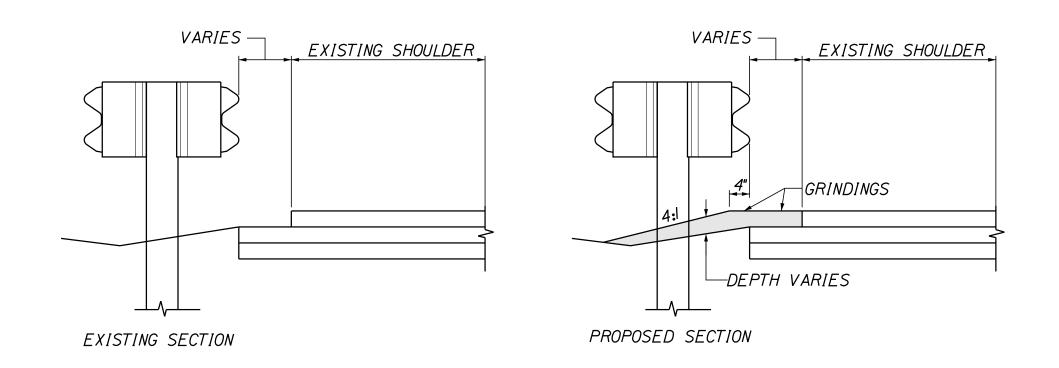

BERM DROPOFF CORRECTION WITH GUARDRAIL MEDIAN GUARDRAIL

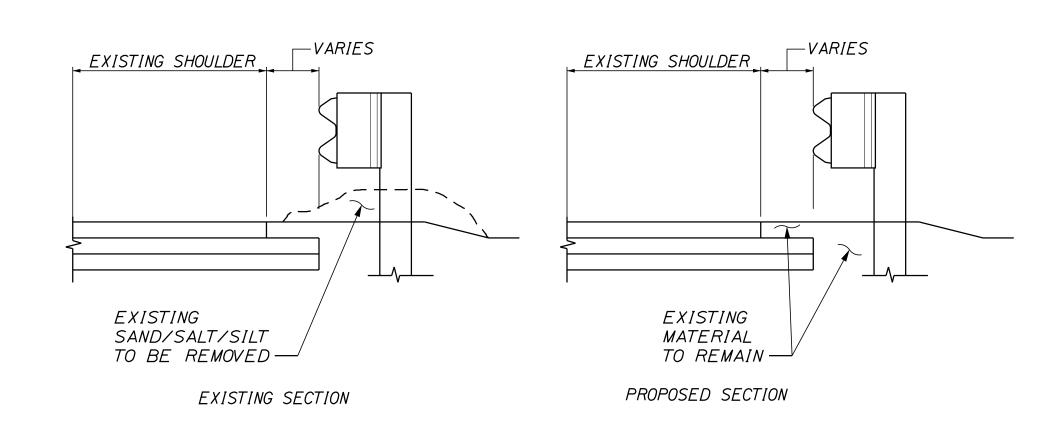


BERM CORRECTION WITH SAND REMOVAL

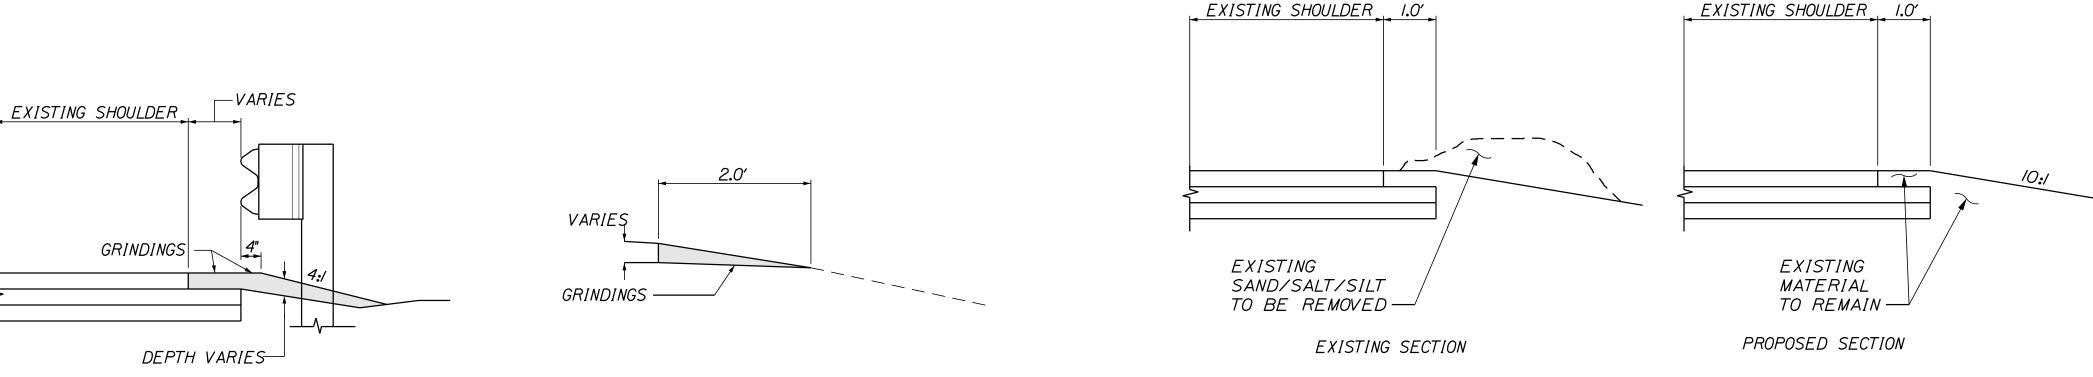

DETAIL A BERM DROPOFF CORRECTION WITH GUARDRAIL

<u>DETAIL B</u> BERM DROPOFF CORRECTION WITHOUT GUARDRAIL

BERM CORRECTION WITH SAND REMOVAL WITHOUT GUARDRAIL

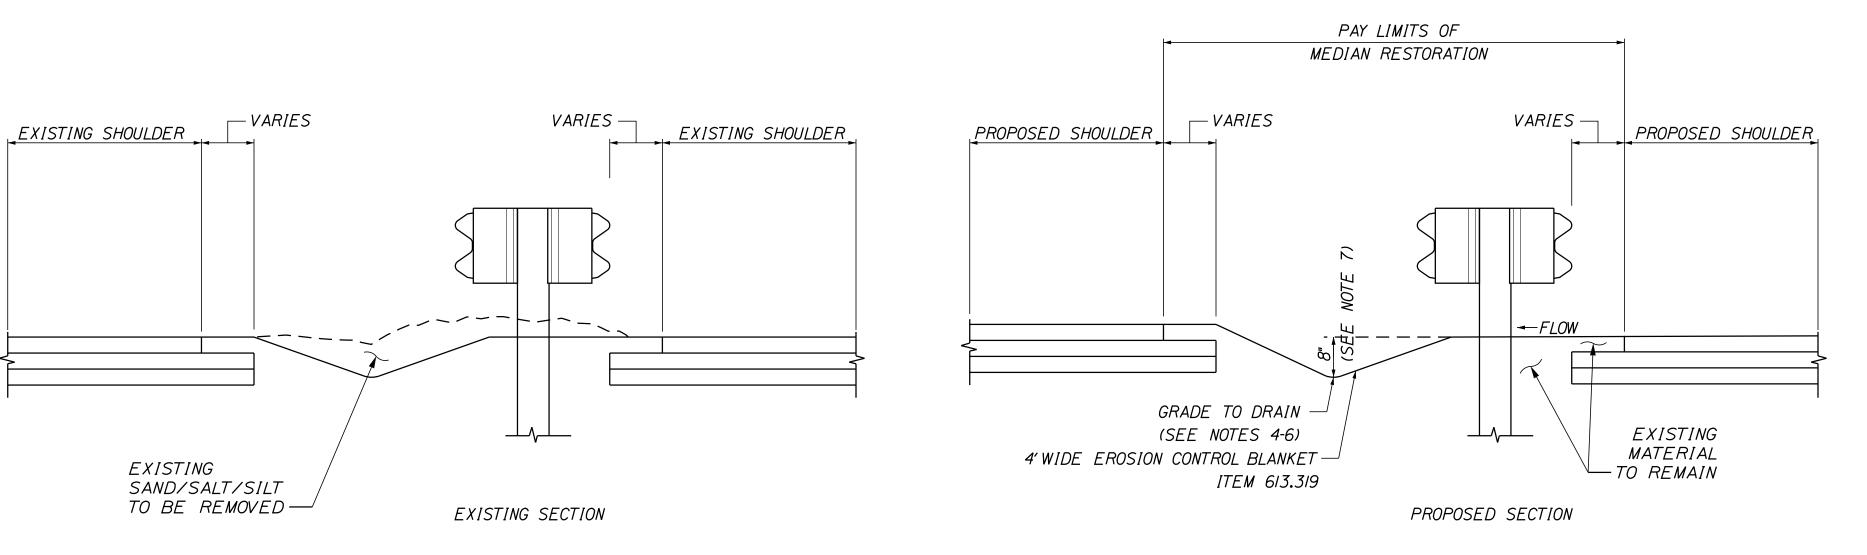

NOTES:

- I. BERM DROPOFF CORRECTION WILL BE PLACED AT
- 2. BERM DROPOFF CORRECTION OF 3 INCHES OR MORE SHALL BE PLACED PRIOR TO SHIFTING TRAFFIC TO THE LANE ADJACENT TO THE SHOULDER REQUIRING CORRECTION.
- 3. BERM DROPOFF CORRECTION WILL BE PAID UNDER ITEM 470.08, BERM CORRECTION WILL BE PAID UNDER ITEM 470.081. MEDIAN RESTORATION WILL BE PAID UNDER ITEM 211.50.
- 4. TAPER SLOPE DOWN TO CATCH BASINS TO PREVENT DROP OFF. USE DEPTH GREATER THAN 8" IN TAPER SECTION IF REQUIRED.
- 5. HYDROSEEDING WITH FIBER MULCH SHALL BE USED IN THE MEDIAN, NO STRAW OR HAY MULCH SHALL BE USED.
- 6. ALL MATERIAL UNDER GUARDRAIL THAT WILL PREVENT SHEET FLOW FROM PROPOSED SHOULDER TO MEDIAN SHALL BE REMOVED, THIS IS INCLUDED AS PART OF THE MEDIAN RESTORATION ITEM # 211.50. IF SAW CUTTING IS REQUIRED TO FACILITATE THE REMOVAL OF PAVEMENT TO ACHIEVE SHEET FLOW, THE SAW CUTTING WILL BE PAID FOR UNDER ITEM 419.30.
- 7. MEDIAN SWALE SHALL BE 8 INCHES BELOW LOWEST EDGE OF PAVEMENT.

<u>MEDIAN RESTORATION</u>

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EC CONSULTING SERVICES INC. ONGRESS STREET SUITE 380 PORTLAND, ME 04102 TEL (207) 887-3448 FAX (207) 883-3376




THE GOLD STAR MEMORIAL HIGHWAY


PAVEMENT REHABILITATION EXITS 1, 2 & 3 AND MM 1.3 TO MM 6.8 BERM DROPOFF CORRECTION AND MEDIAN RESTORATION DETAILS

SHEET NUMBER: DT-03


MTA PROJECT MANAGER: RYAN BARNES, PE, CPESC

CONTRACT:2024.01 25 OF 40

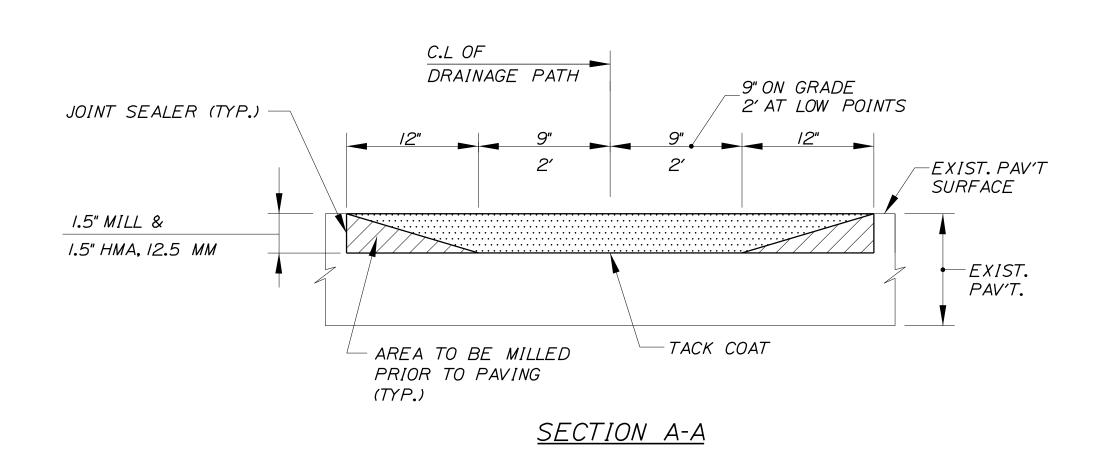


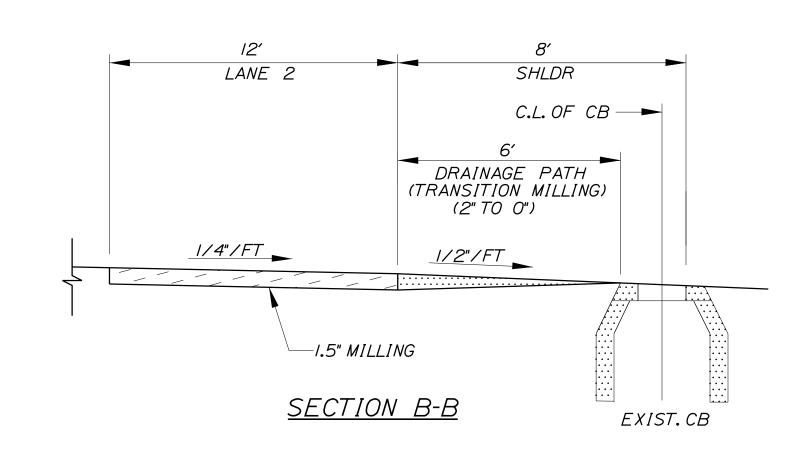

DRAINAGE PATH DETAILS

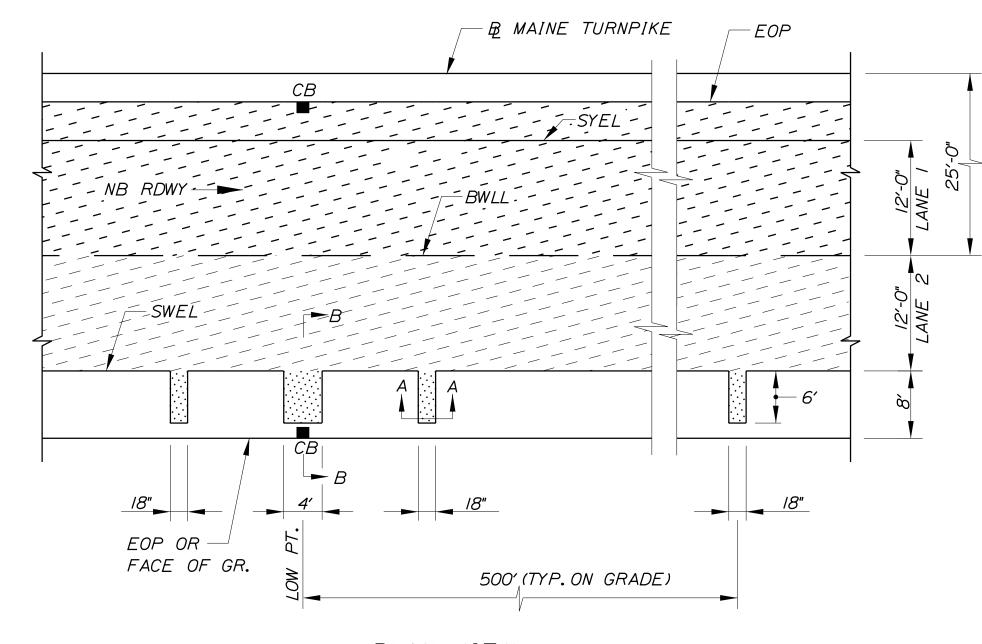



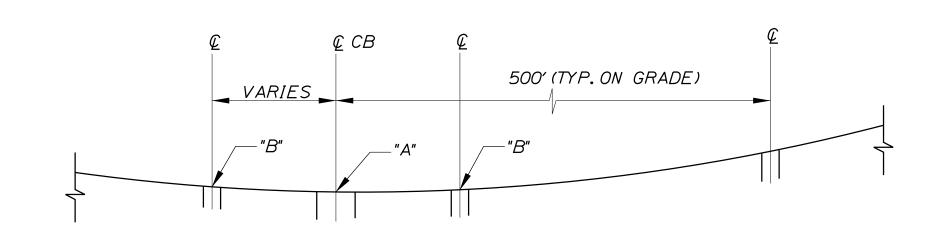

PROFILE ALONG EDGE OF MILLING

<u>LEGEND</u>

MTA PROJECT MANAGER: RYAN BARNES, PE, CPESC

= DRAINAGE PATH MILLING

NOTES:

I. POINT "B" IS I" HIGHER THAN POINT "A".

2. DRAINAGE PATH REQUIRED AT ALL LOW POINTS.

= TRAVEL LANE MILLING

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ena					Designed	JŔH	10\23	Checked	LEM	10\23	
File					Drawn	CHL	10\23	In Charge of	LEM	10\23	

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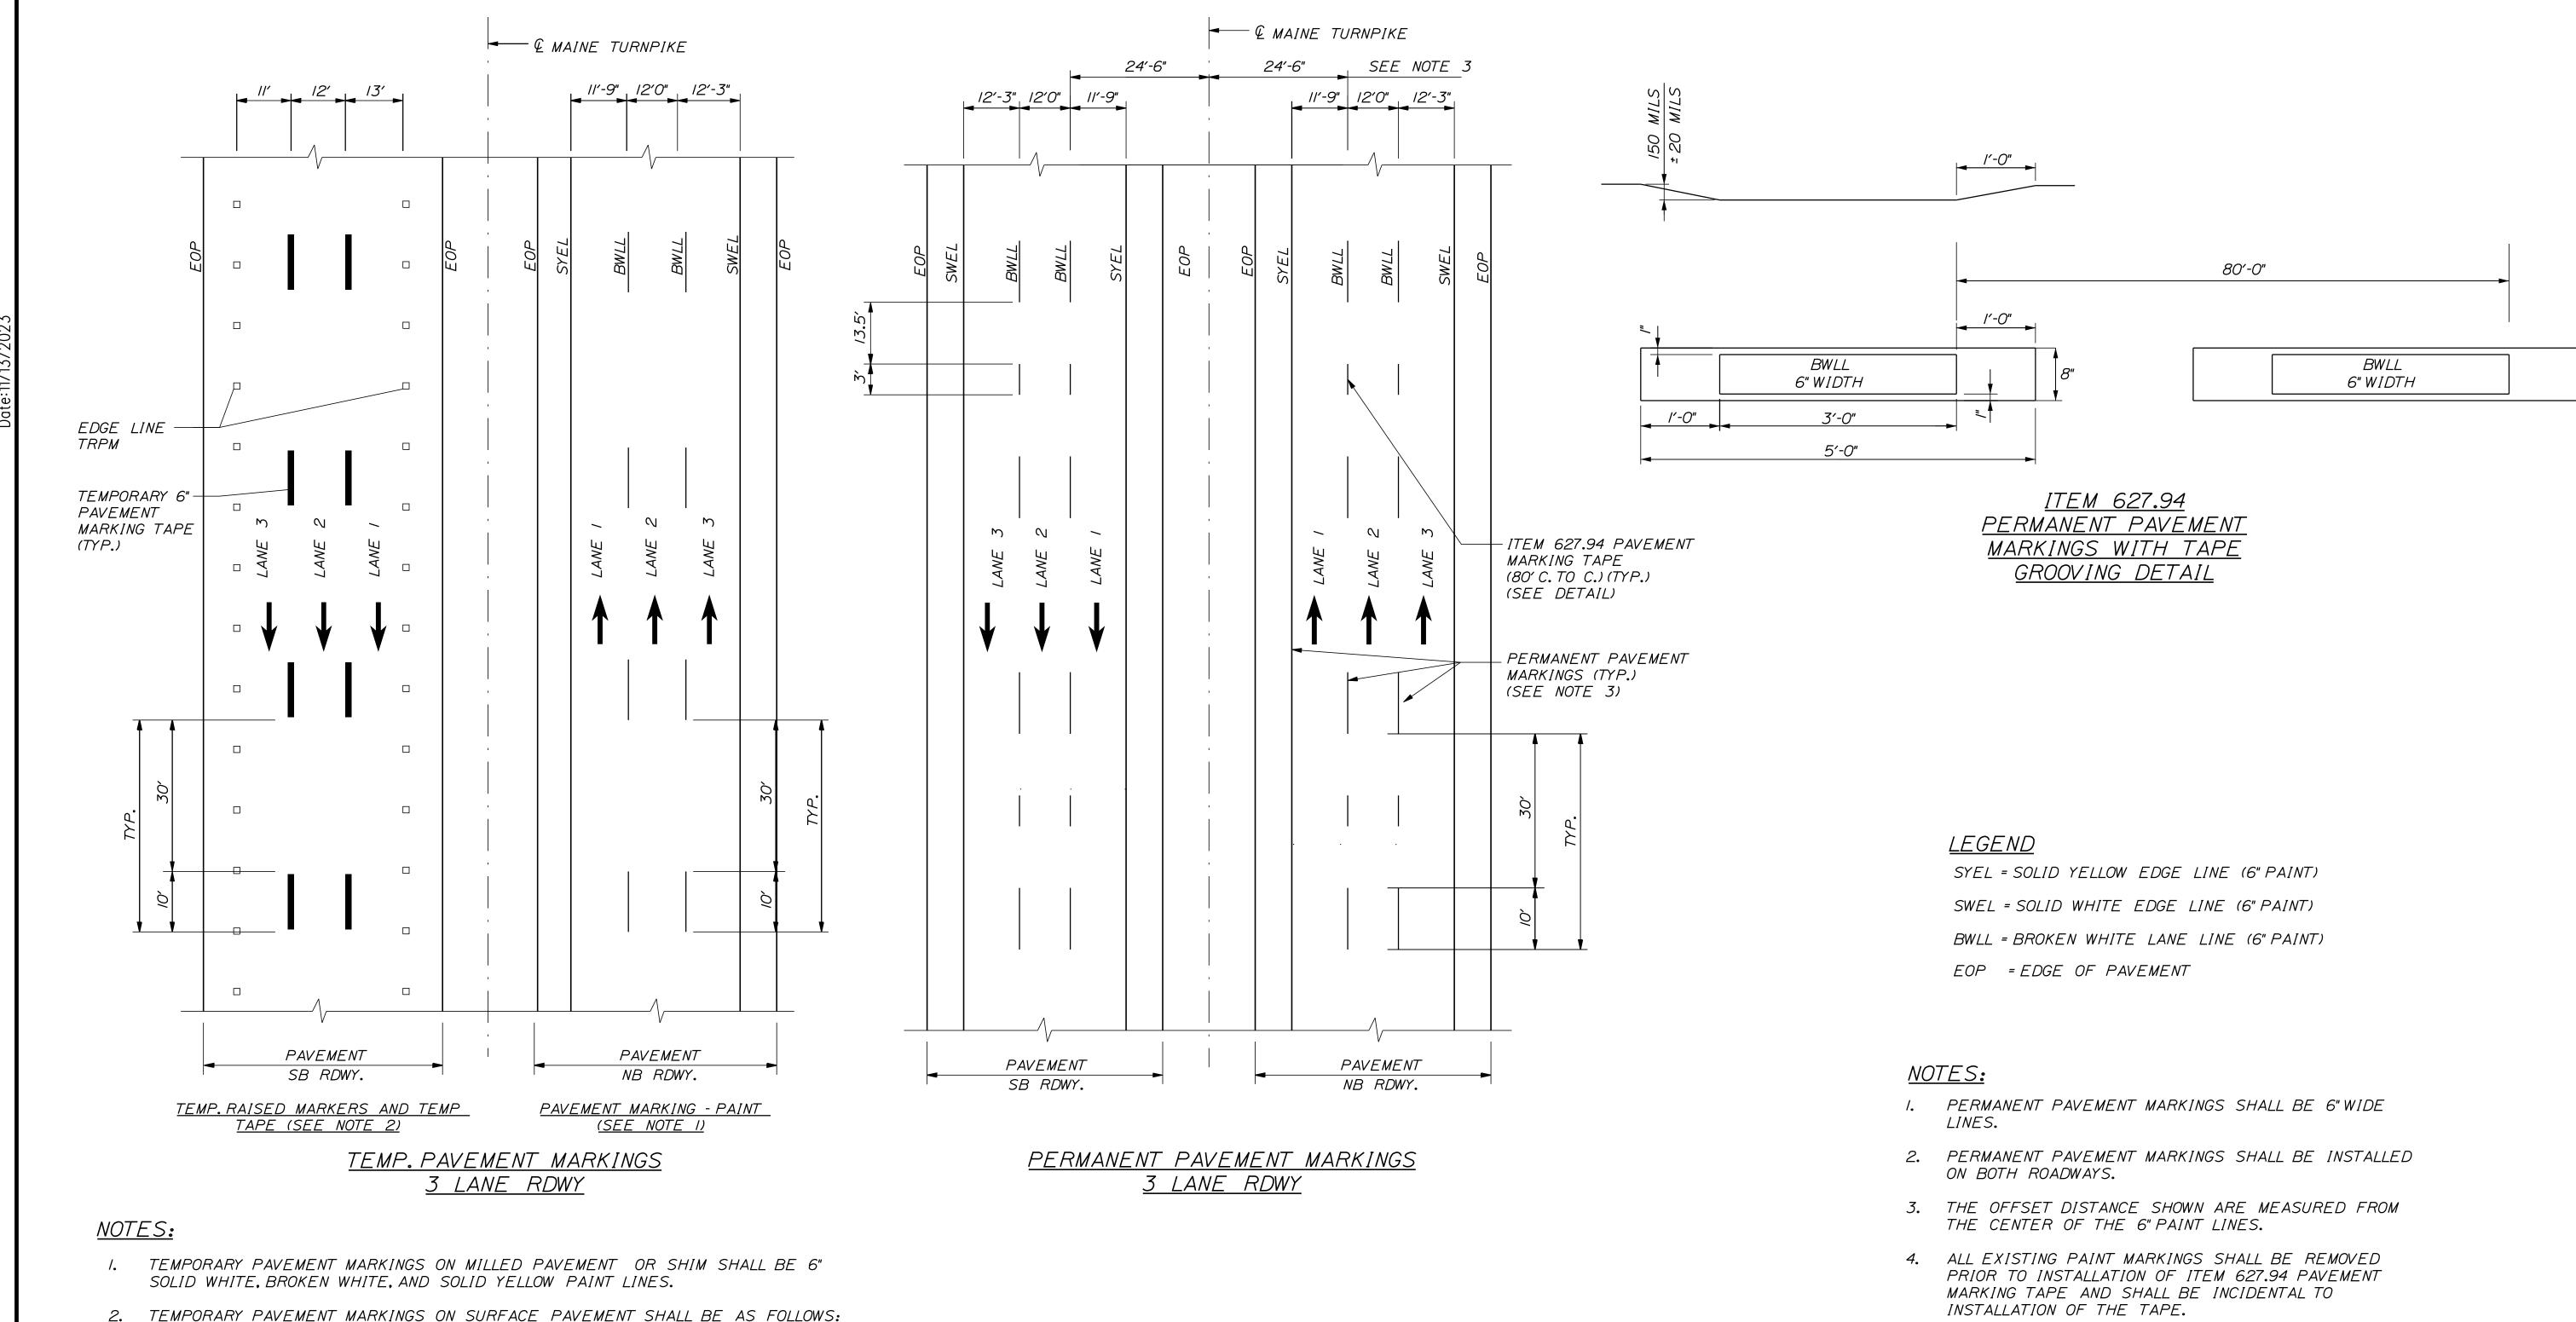


THE GOLD STAR MEMORIAL HIGHWAY

PAVEMENT REHABILITATION
EXITS 1, 2 & 3 AND MM 1.3 TO MM 6.8

DRAINAGE PATH FOR MILLING DETAILS

SHEET NUMBER: DT-04 CONTRACT:2024.01 26 OF 40



- 2. TEMPORARY PAVEMENT MARKINGS ON SURFACE PAVEMENT SHALL BE AS FOLLOWS:
 - FOR "SOLID WHITE" AND "SOLID YELLOW" EDGE LINES TEMPORARY PAVEMENT MARKINGS SHALL BE TEMPORARY RAISED PAVEMENT MARKERS SPACED AT 10' C. TO C.
 - FOR "BROKEN WHITE" LANE LINES TEMPORARY PAVEMENT MARKINGS SHALL BE 6" TEMPORARY PAVEMENT MARKING TAPE WITH A 10' PIECE EVERY 40'.

5. ITEM 627.94 PAVEMENT MARKING TAPE FOR DWLL SHALL BE INSTALLED IN AN "IN-AND-OUT" GROOVING PATTERN. SEE DETAIL THIS SHEET.

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end				Designed	JRH	10\23	Checked	LEM	10\23	
¥ I				Drawn	CHL	10\23	In Charge of	LEM	10\23	

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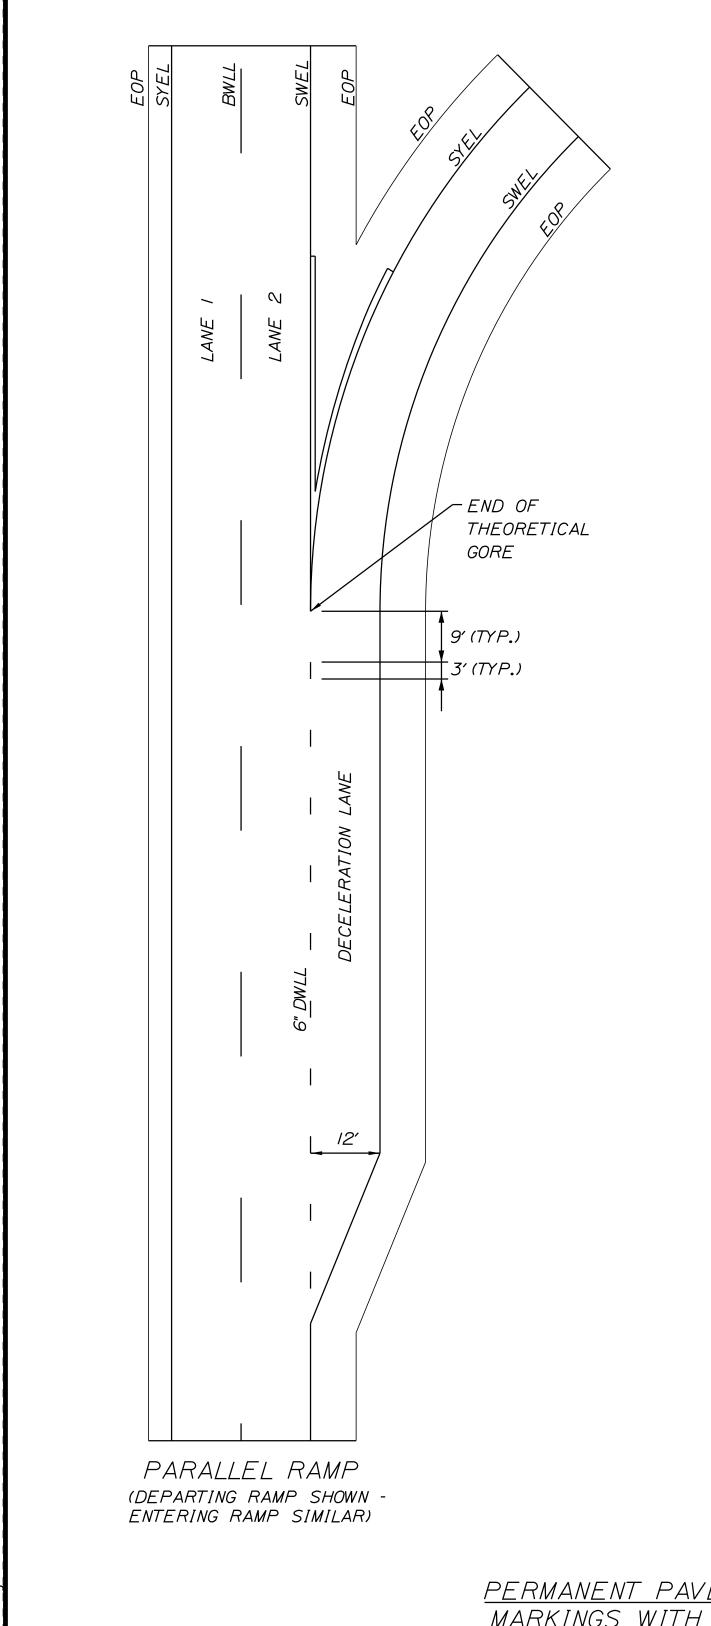



MTA PROJECT MANAGER: RYAN BARNES, PE, CPESC


THE GOLD STAR MEMORIAL HIGHWAY

PAVEMENT REHABILITATION EXITS 1, 2 & 3 AND MM 1.3 TO MM 6.8 STRIPING DETAILS (1 OF 2)

SHEET NUMBER: DT-05 CONTRACT:2024.01 27 OF 40



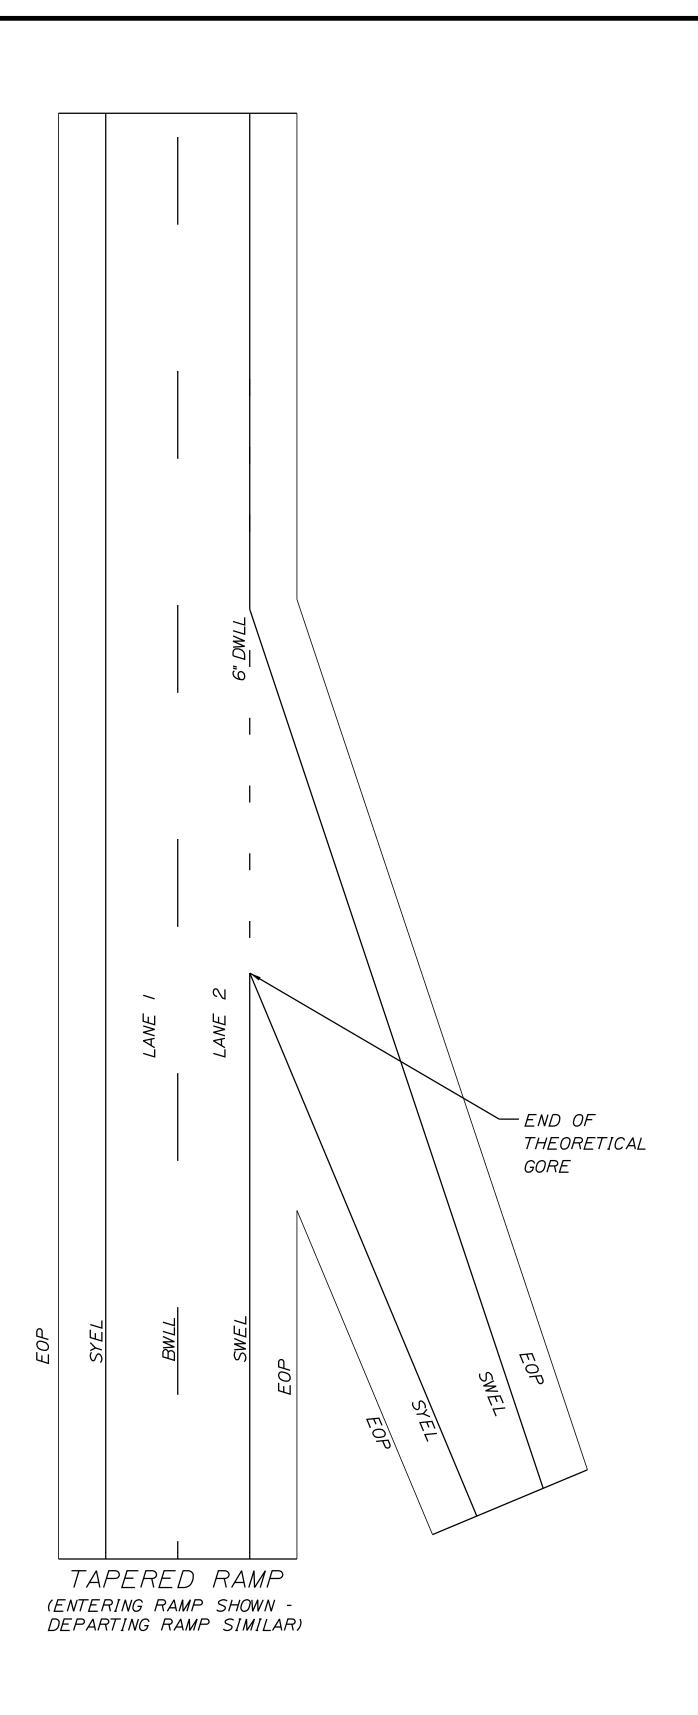

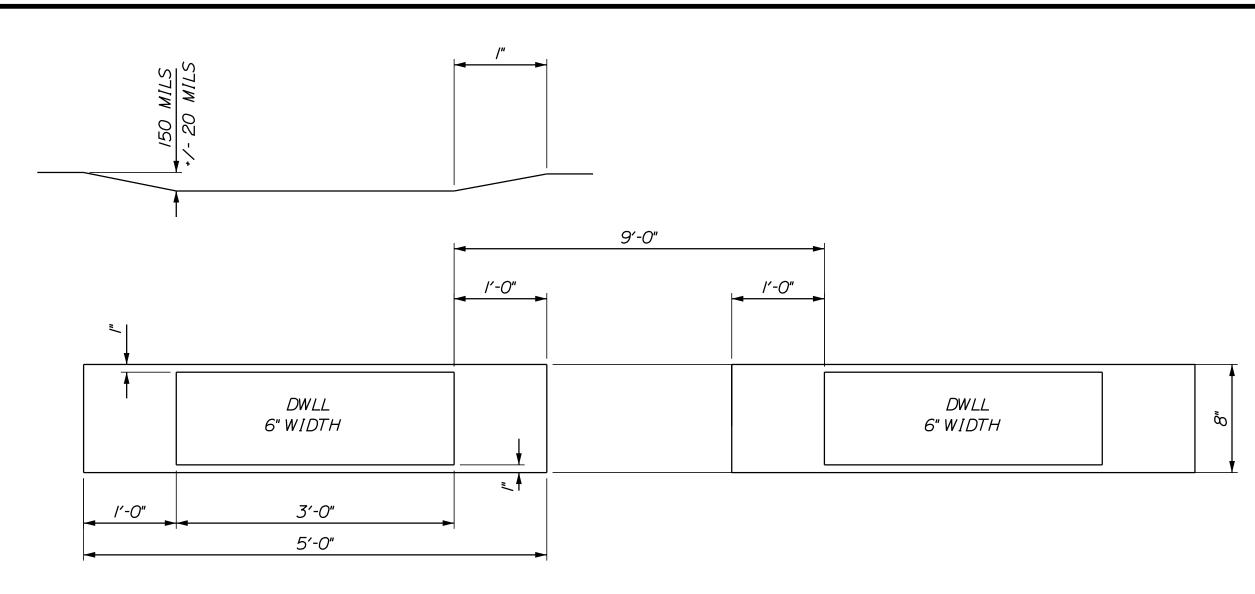

ITEM 627.941

DWLL PERMANENT PAVEMENT

MARKINGS WITH TAPE

GROOVING DETAIL

<u>LEGEND</u>

SYEL = SOLID YELLOW EDGE LINE (6" PAINT)

SWEL = SOLID WHITE EDGE LINE (6" PAINT)

BWLL = BROKEN WHITE LANE LINE (6" PAINT)

DWLL = DOTTED WHITE LANE LINE (6" PAINT)

EOP = EDGE OF PAVEMENT

NOTES:

- I. ALL EXISTING PAINT MARKINGS SHALL BE REMOVED PRIOR TO INSTALLATION OF ITEM 627.941 PAVEMENT MARKING TAPE AND SHALL BE INCIDENTAL TO INSTALLATION OF THE TAPE.
- 2. ITEM 627.941 PAVEMENT MARKING TAPE FOR DWLL SHALL BE INSTALLED IN AN "IN-AND-OUT" GROOVING PATTERN. SEE DETAIL THIS SHEET.
- 3. CONTRACTOR SHALL FOLLOW MANUFACTURERS RECOMMENDATIONS FOR INSTALLATION OF THE TAPE. ANY CHANGES TO INSTALLATION PROCEDURES SHALL BE APPROVED THE RESIDENT ENGINEER.

PERMANENT PAVEMENT
MARKINGS WITH TAPE
(ITEM 627.941 PAVEMENT MARKING TAPE)

Scale:

No. Revision

By Date

CONSULTANT PROJECT MANAGER: JOSEPH HOWE, P.E.

By Date

By Date

Designed by:

CONSULTANT PROJECT MANAGER: JOSEPH HOWE, P.E.

Designed JRH 10\23 Checked LEM 10\23

Drawn

CHL 10\23 In Charge of LEM 10\23

STANTEC CONSULTING SERVICES INC.

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THE GOLD STAR
MEMORIAL HIGHWAY

PAVEMENT REHABILITATION
EXITS 1, 2 & 3 AND MM 1.3 TO MM 6.8
STRIPING DETAILS
(2 OF 2)

SHEET NUMBER: DT-06
CONTRACT:2024.01 28 OF 40

GUARDRAIL EARTHWORK AND PAVEMENT REPAIR NOTES

- ALL EARTHWORK AND PAVEMENT REPAIRS ASSOCIATED WITH GUARDRAIL INSTALLATIONS AND/OR MODIFICATIONS FOR THIS CONTRACT SHALL BE INCIDENTAL TO THE GUARDRAIL ITEMS UNLESS OTHERWISE NOTED.
- 2. ALL DISTURBED AREAS DUE TO THE WORK PERFORMED UNDER THIS CONTRACT FOR GUARDRAIL REPAIRS, MODIFICATION AND/OR INSTALLATIONS SHALL BE REPAIRED AND RESTORED TO ORIGINAL CONDITION. GRASSED AREAS SHALL RECEIVE 4" OF LOAM, SEED, FERTILIZER AND MULCH, IN PAVED AREAS, SUBBASE GRAVEL SHALL BE REPLACED AND RECOMPACTED WITH MAINE DOT TYPE-D GRAVEL AND HOT MIX ASPHALT TO A THICKNESS TO MATCH SURROUNDING PAVEMENT.
- 3. COMPACTION OF EARTH AND/OR SUBBASE GRAVEL AROUND GUARDRAIL POSTS DISTURBED DURING THE WORK IS REQUIRED. ALL POSTS SHALL BE PLUMB AFTER COMPACTION.

GUARDRAIL INSTALLATION AND MODIFICATION NOTES

- I. THE CONTRACTOR SHALL FOLLOW ALL MANUFACTURER'S INSTALLATION INSTRUCTIONS FOR THE INSTALLATION AND/OR MODIFICATION OF ANY AND ALL GUARDRAIL COMPONENTS TO BE INSTALLED UNDER THIS CONTRACT. THE CONTRACTOR SHALL NOTIFY THE RESIDENT ENGINEER IF THE CONTRACTOR DISCOVERS CONFLICTS OR IRREGULARITIES OF ANY SORT BETWEEN THE MANUFACTURER'S INSTALLATION INSTRUCTIONS AND THESE CONTRACT DOCUMENTS.
- 2. THE CONTRACTOR IS REQUIRED TO HAVE AN APPROVED CRASH END TREATMENT ON ALL GUARDRAIL ENDS IN ALL WORK AREAS AT THE END OF EACH DAY. THE CONTRACTOR SHALL ENSURE THAT ENOUGH TIME EXISTS IN THE WORK DAY TO COMPLETE ALL MODIFICATIONS AND/OR INSTALLATIONS TO END TERMINALS. THE CONTRACTOR SHALL ENSURE THAT ALL PARTS AND MANPOWER ARE ON-SITE PRIOR TO UNDERTAKING ANY GUARDRAIL MODIFICATIONS.
- 3. EXISTING GUARDRAIL NOTED TO BE ADJUSTED SHALL BE ADJUSTED TO 30" (+0", -1/2") HEIGHT. GUARDRAIL HEIGHT SHALL BE MEASURED FROM THE EDGE OF PAVEMENT WHEN WITHIN 2 FEET. IF GUARDRAIL IS OFFSET FROM EDGE OF PAVEMENT GREATER THAN 2 FEET, THEN HEIGHT OF RAIL SHALL BE MEASURED AT GROUND ELEVATION ADJACENT TO EACH POST BELOW THE RAIL TO THE TOP OF GUARDRAIL AND AFTER FINAL GRADING OF SHOULDER.
- 4. PROPOSED GUARDRAIL SHALL BE INSTALLED TO THE HEIGHTS SHOWN IN THE GUARDRAIL DETAILS.
- THE CONTRACTOR SHALL REMOVE AND DISPOSE OF ALL CUT BOLTS, DISCARDED PARTS, TRASH, PAVEMENT DEBRIS, ETC., AFTER COMPLETING GUARDRAIL MODIFICATIONS AND/OR INSTALLATIONS.
- CONNECTIONS FOR PROPOSED RAIL TO EXISITNG RAIL SHALL BE INCIDENTAL TO THE INSTALLATION OF PROPOSED GUARDRAIL.
- ALL DAMAGE TO GUARDRAIL COMPONENTS RESULTING FROM ADJUSTMENTS MADE TO THE GUARDRAIL SHALL BE REPAIRED AT NO ADDITIONAL COST TO THE AUTHORITY.
- CONNECTIONS FOR PROPOSED GUARDRAIL TO EXISTING GUARDRAIL SHALL BE INCIDENTAL TO THE PROPOSED GUARDRAIL ITEMS.
- ALL EXISTING GUARDRAIL NOTED TO BE REMOVED SHALL BECOME THE PROPERTY OF THE CONTRACTOR. REMOVAL AND DISPOSAL SHALL BE CONSIDERED INCIDENTAL TO THE GUARDRAIL ITEMS.
- ONE REFLECTORIZED FLEXIBLE GUARDRAIL MARKER SHALL BE INSTALLED AT EACH GUARDRAIL TERMINAL.TWO REFLECTORIZED FLEXIBLE GUARDRAIL MARKERS SHALL BE INSTALLED AT EACH GUARDRAIL END TREATMENT.
- ALL PERMANENT GUARDRAIL AND END TERMINALS SHALL BE MASH 2016 COMPLIANT.
- HOLES CREATED BY GUARDRAIL REMOVAL WILL BE FILLED AND COMPACTED WITH APPROVED MATERIALS AS DIRECTED BY THE RESIDENT. PAYMENT TO BE CONSIDERED INCIDENTAL TO THE GUARDRAIL ITEMS.
- 13. TRANSITIONS FROM EXISTING GUARDRAIL TO PROPOSED MIDWAY SPLICE GUARDRAIL SHALL BE IN ACCORDANCE WITH MAINEDOT STANDARD DETAIL 606(17).

Designed by: Scale: NOT TO SCALE Stantec By Date Revision CONSULTANT PROJECT MANAGER: JOSEPH HOWE, P.E. Date By Date JRH 10\23 LEM 10\23 Checked Designed In Charge of LEM 10\23 10\23

STANTEC CONSULTING SERVICES INC. MAINE **TURNPIKE** 2211 CONGRESS STREET SUITE 380

PORTLAND, ME 04102

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FAX (207) 883-3376

THE GOLD STAR MEMORIAL HIGHWAY

PAVEMENT REHABILITATION EXITS 1, 2 & 3 AND MM 1.3 TO MM 6.8 GUARDRAIL DETAILS (1 OF 3)


> SHEET NUMBER: DT-07 29 OF 40

MTA PROJECT MANAGER: RYAN BARNES, PE, CPESC


CONTRACT:2024.01

I. THIS DETAIL MODIFIES THE SEW3I DRAWING SUCH THAT W-BEAM DOES NOT EXTEND BEYOND THE LAST GUARDRAIL POST. THE RWMI40 W-BEAM PANEL SHALL HAVE A LENGTH OF 9'-41/2" MEASURED FROM THE CENTER OF THE MIDWAY SPLICE TO THE CENTER OF THE LAST GUARDRAIL POST.


TERMINAL END - ANCHORED END - 31" W-BEAM GUARDRAIL (ITEM 606.1351) NOT TO SCALE

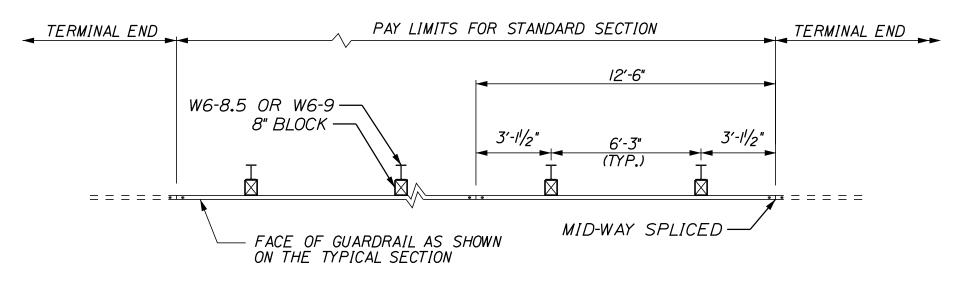


PLAN - SINGLE FACED

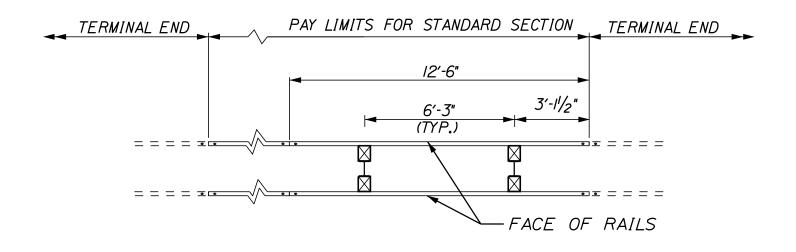

PLAN - DOUBLE FACED

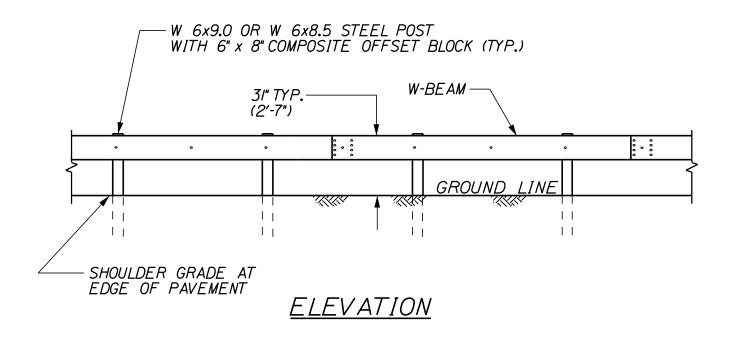

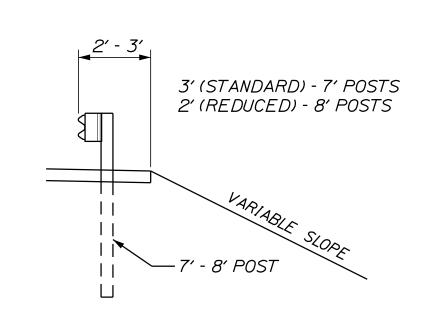

CROSS-SECTION

31" W-BEAM GUARDRAIL - MID-WAY SPLICE (8" OFFSET BLOCKS) (ITEMS 606.13, 606.132) NOT TO SCALE

Designed by: NOT TO SCALE **Stantec** By Date Revision CONSULTANT PROJECT MANAGER: JOSEPH HOWE, P.E. Date By Date LEM 10\23 JRH 10\23 Checked Designed In Charge of LEM 10\23 CHL 10\23

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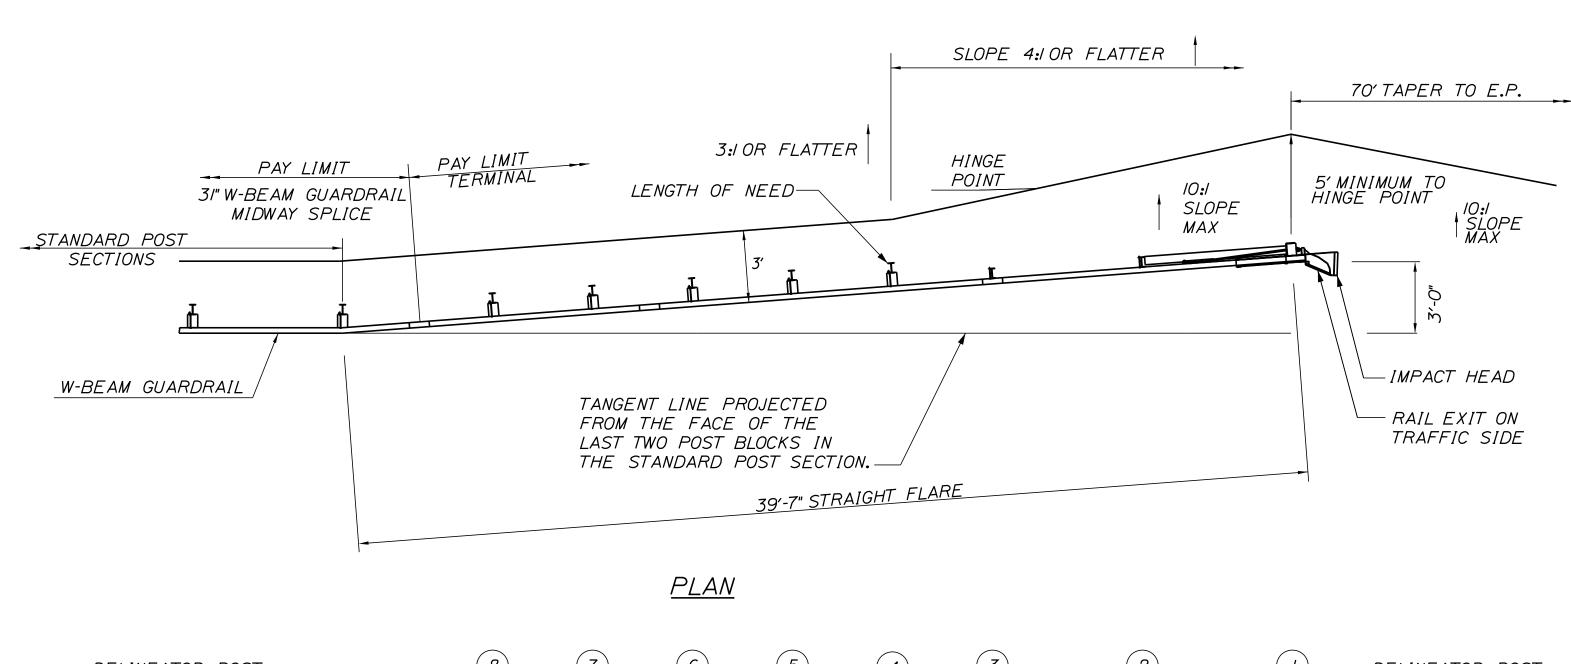



MTA PROJECT MANAGER: RYAN BARNES, PE, CPESC

THE GOLD STAR MEMORIAL HIGHWAY

PAVEMENT REHABILITATION EXITS 1, 2 & 3 AND MM 1.3 TO MM 6.8 GUARDRAIL DETAILS (2 OF 3)

SHEET NUMBER: DT-08 CONTRACT:2024.01 30 OF 40



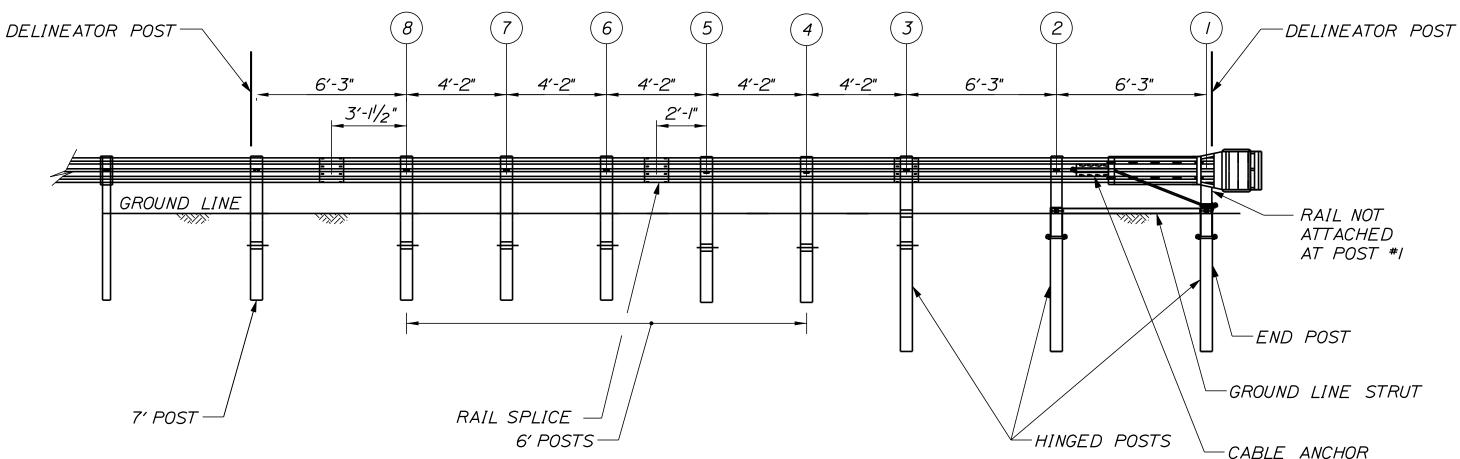


31" W-BEAM GUARDRAIL - MID-WAY SPLICE FLARED TERMINAL (MFLEAT MANUFACTURED BY RSI) NOT TO SCALE

<u>ELEVATION</u>

GENERAL GUARDRAIL INSTALLATION NOTES:

- I. THE CONTRACTOR SHALL FOLLOW ALL MANUFACTURER'S INSTALLATION INSTRUCTIONS FOR THE INSTALLATION OF ALL GUARDRAIL COMPONENTS TO BE INSTALLED. THE CONTRACTOR SHALL NOTIFY THE RESIDENT ENGINEER OF ANY CONFLICTS OR IRREGULARITIES BETWEEN THE MANUFACTURER'S INSTALLATION INSTRUCTIONS AND THE CONTRACT DOCUMENTS.
- 2. THE CONTRACTOR IS REQUIRED TO HAVE AN APPROVED CRASH END TREATMENT ON ALL GUARDRAIL ENDS PRIOR TO THE REMOVAL OF ANY MOT FEATURES.
- 3. GUARDRAIL HEIGHT SHALL BE MEASURED FROM GROUND ELEVATION ADJACENT TO EACH POST.
- 4. THE CONTRACTOR SHALL REMOVE AND DISPOSE OF ALL CUT BOLTS, DISCARD PARTS, TRASH, PAVEMENT DEBRIS, ETC., AFTER COMPLETING THE GUARDRAIL INSTALLATION.
- 5. CONNECTION FOR PROPOSED RAIL TO EXISTING RAIL SHALL BE INCIDENTAL TO THE PROPOSED GUARDRAIL ITEMS.
- 6. SEE SPECIFICATIONS FOR REFLECTIVE SHEETING REQUIREMENTS.
- 7. TERMINAL UNIT SHALL BE MFLEAT AND MASH CERTIFIED AS MANUFACTURED BY ROAD SYSTEMS INC.

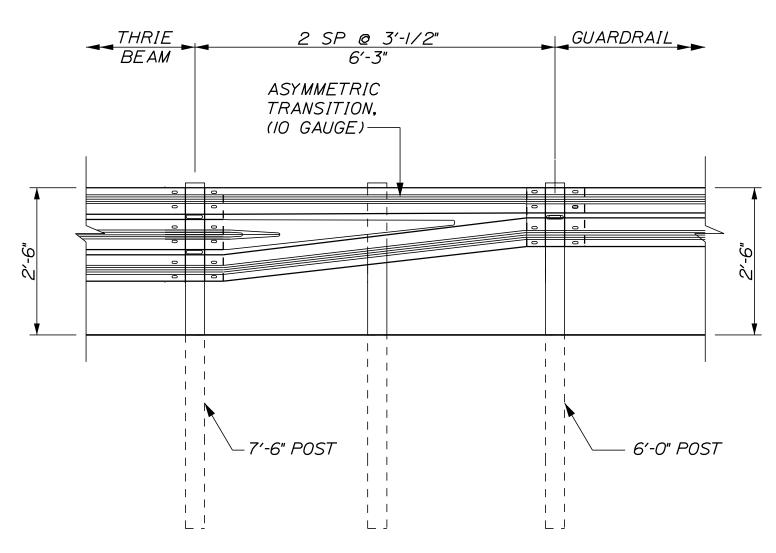

W-BEAM TO THRIE BEAM TRANSITION SECTION NOT TO SCALE

Scale: Designed by: NOT TO SCALE Stantec STANTEC CONSULTING SERVICES INC. 2211 CONGRESS STREET SUITE 380 By Date Revision CONSULTANT PROJECT MANAGER: JOSEPH HOWE, P.E. By Date Date LEM 10\23 JRH 10\23 Checked Designed CHL 10\23 In Charge of LEM 10\23



THE GOLD STAR MEMORIAL HIGHWAY

PAVEMENT REHABILITATION EXITS 1, 2 & 3 AND MM 1.3 TO MM 6.8 GUARDRAIL DETAILS (3 OF 3)


SHEET NUMBER: DT-09 CONTRACT:2024.01 310F 40

BOX ASSEMBLY

PORTLAND, ME 04102


TEL (207) 887-3448

FAX (207) 883-3376

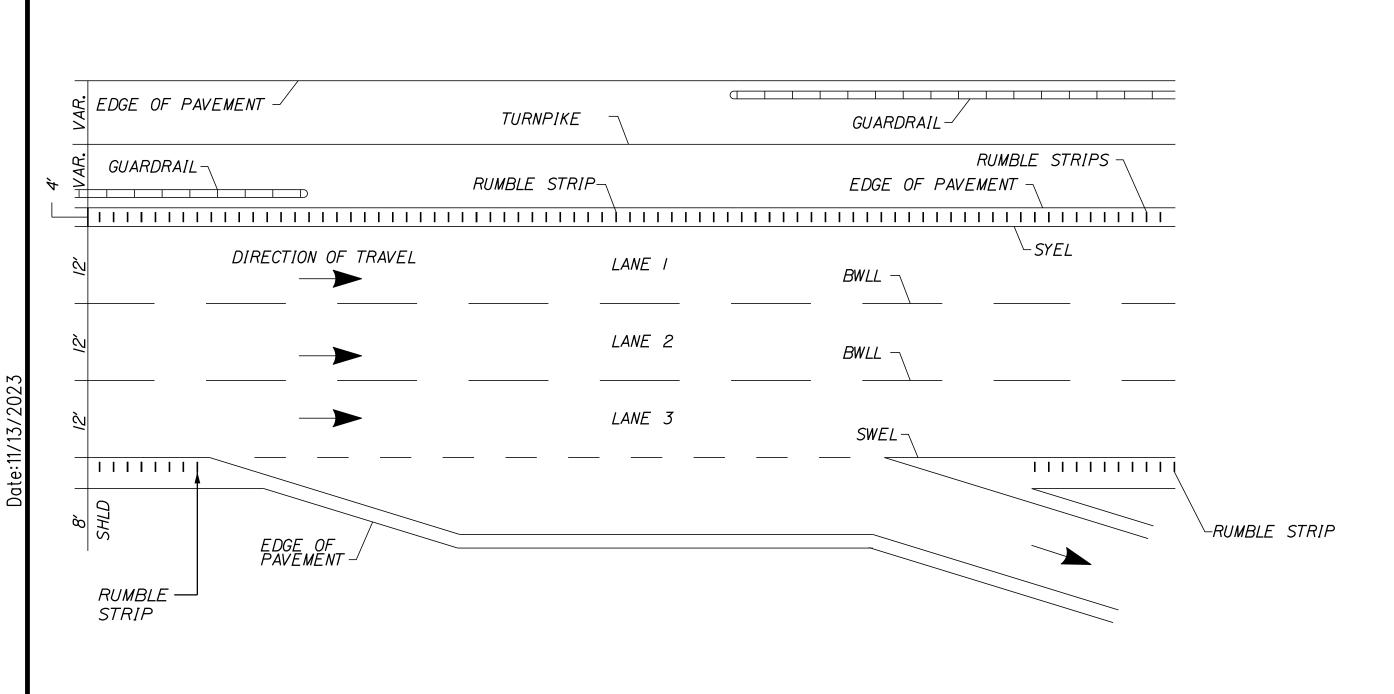

LOCATION OF RUMBLE STRIPS AT ENTRANCE AND EXIT RAMPS

(EXIT RAMP SHOWN, ENTRANCE RAMP SIMILAR)
N.T.S.

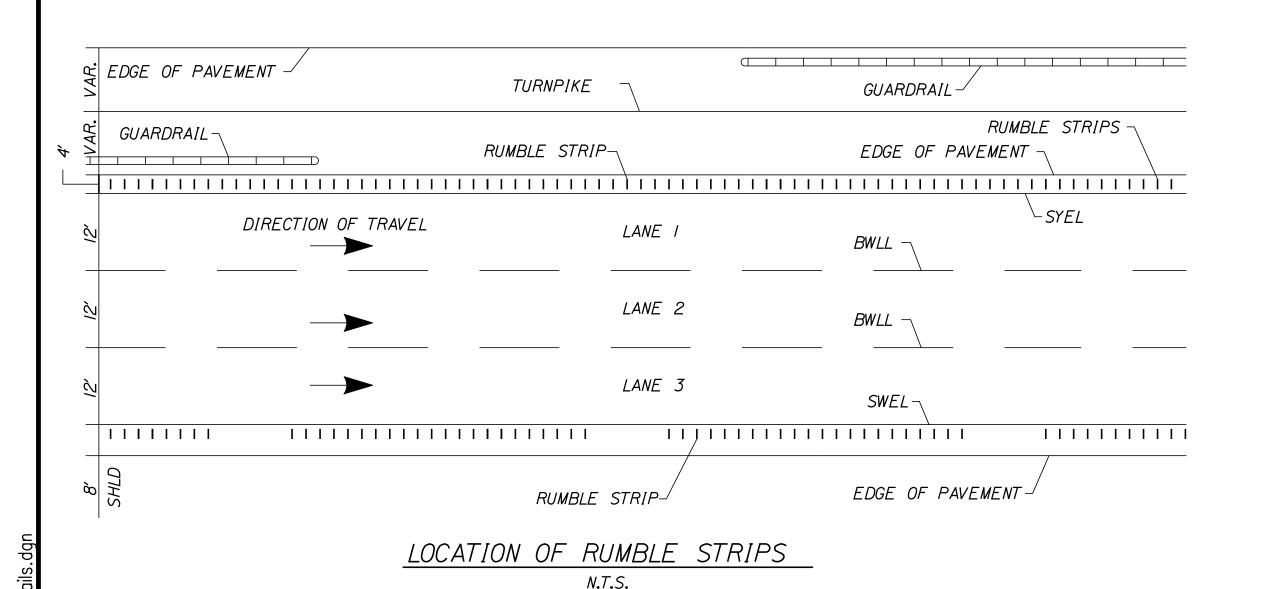


NOTES:


- I. INSTALL LANE 3 RUMBLE STRIP WITH A 20' GAP EVERY 100'.

 (I.E. 80' OF RUMBLE STRIP AND 20' OF NO RUMBLE STRIP;

 REPEAT...)
- 2. INSTALL LANE I RUMBLE STRIP WITH NO GAPS, A BREAK IN THE LANE I RUMBLE STRIP IS REQUIRED FOR A MEDIAN CROSSOVER, SEE RUMBLE STRIP PLACEMENT DETAIL FOR LAYOUT REQUIREMENTS.

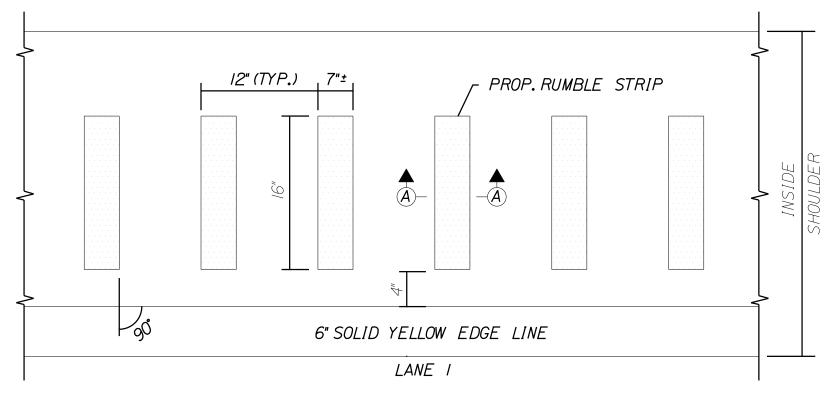

PLAN VIEW - LANE I

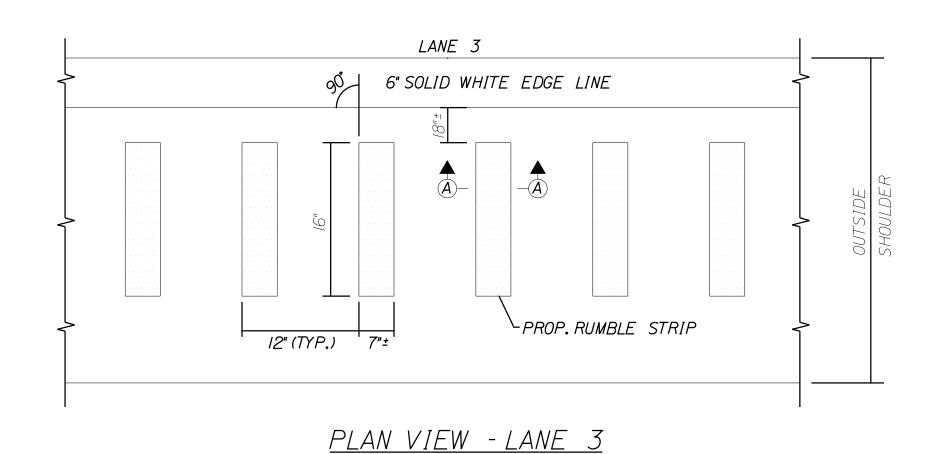

7"±

PAVEMENT SURFACE

SECTION A-A

N.T.S.

Scale: NOT TO SCALE No. Revision By Date CONSULTANT PROJECT MANAGER: JOSEPH HOWE, P.E. By Date By Date By Date

Designed

JRH 10\23

CHL 10\23

Checked

LEM 10\23

In Charge of LEM 10\23

STANTEC CONSULTING SERVICES INC.
2211 CONGRESS STREET SUITE 380
PORTLAND, ME 04102
TEL (207) 887-3448
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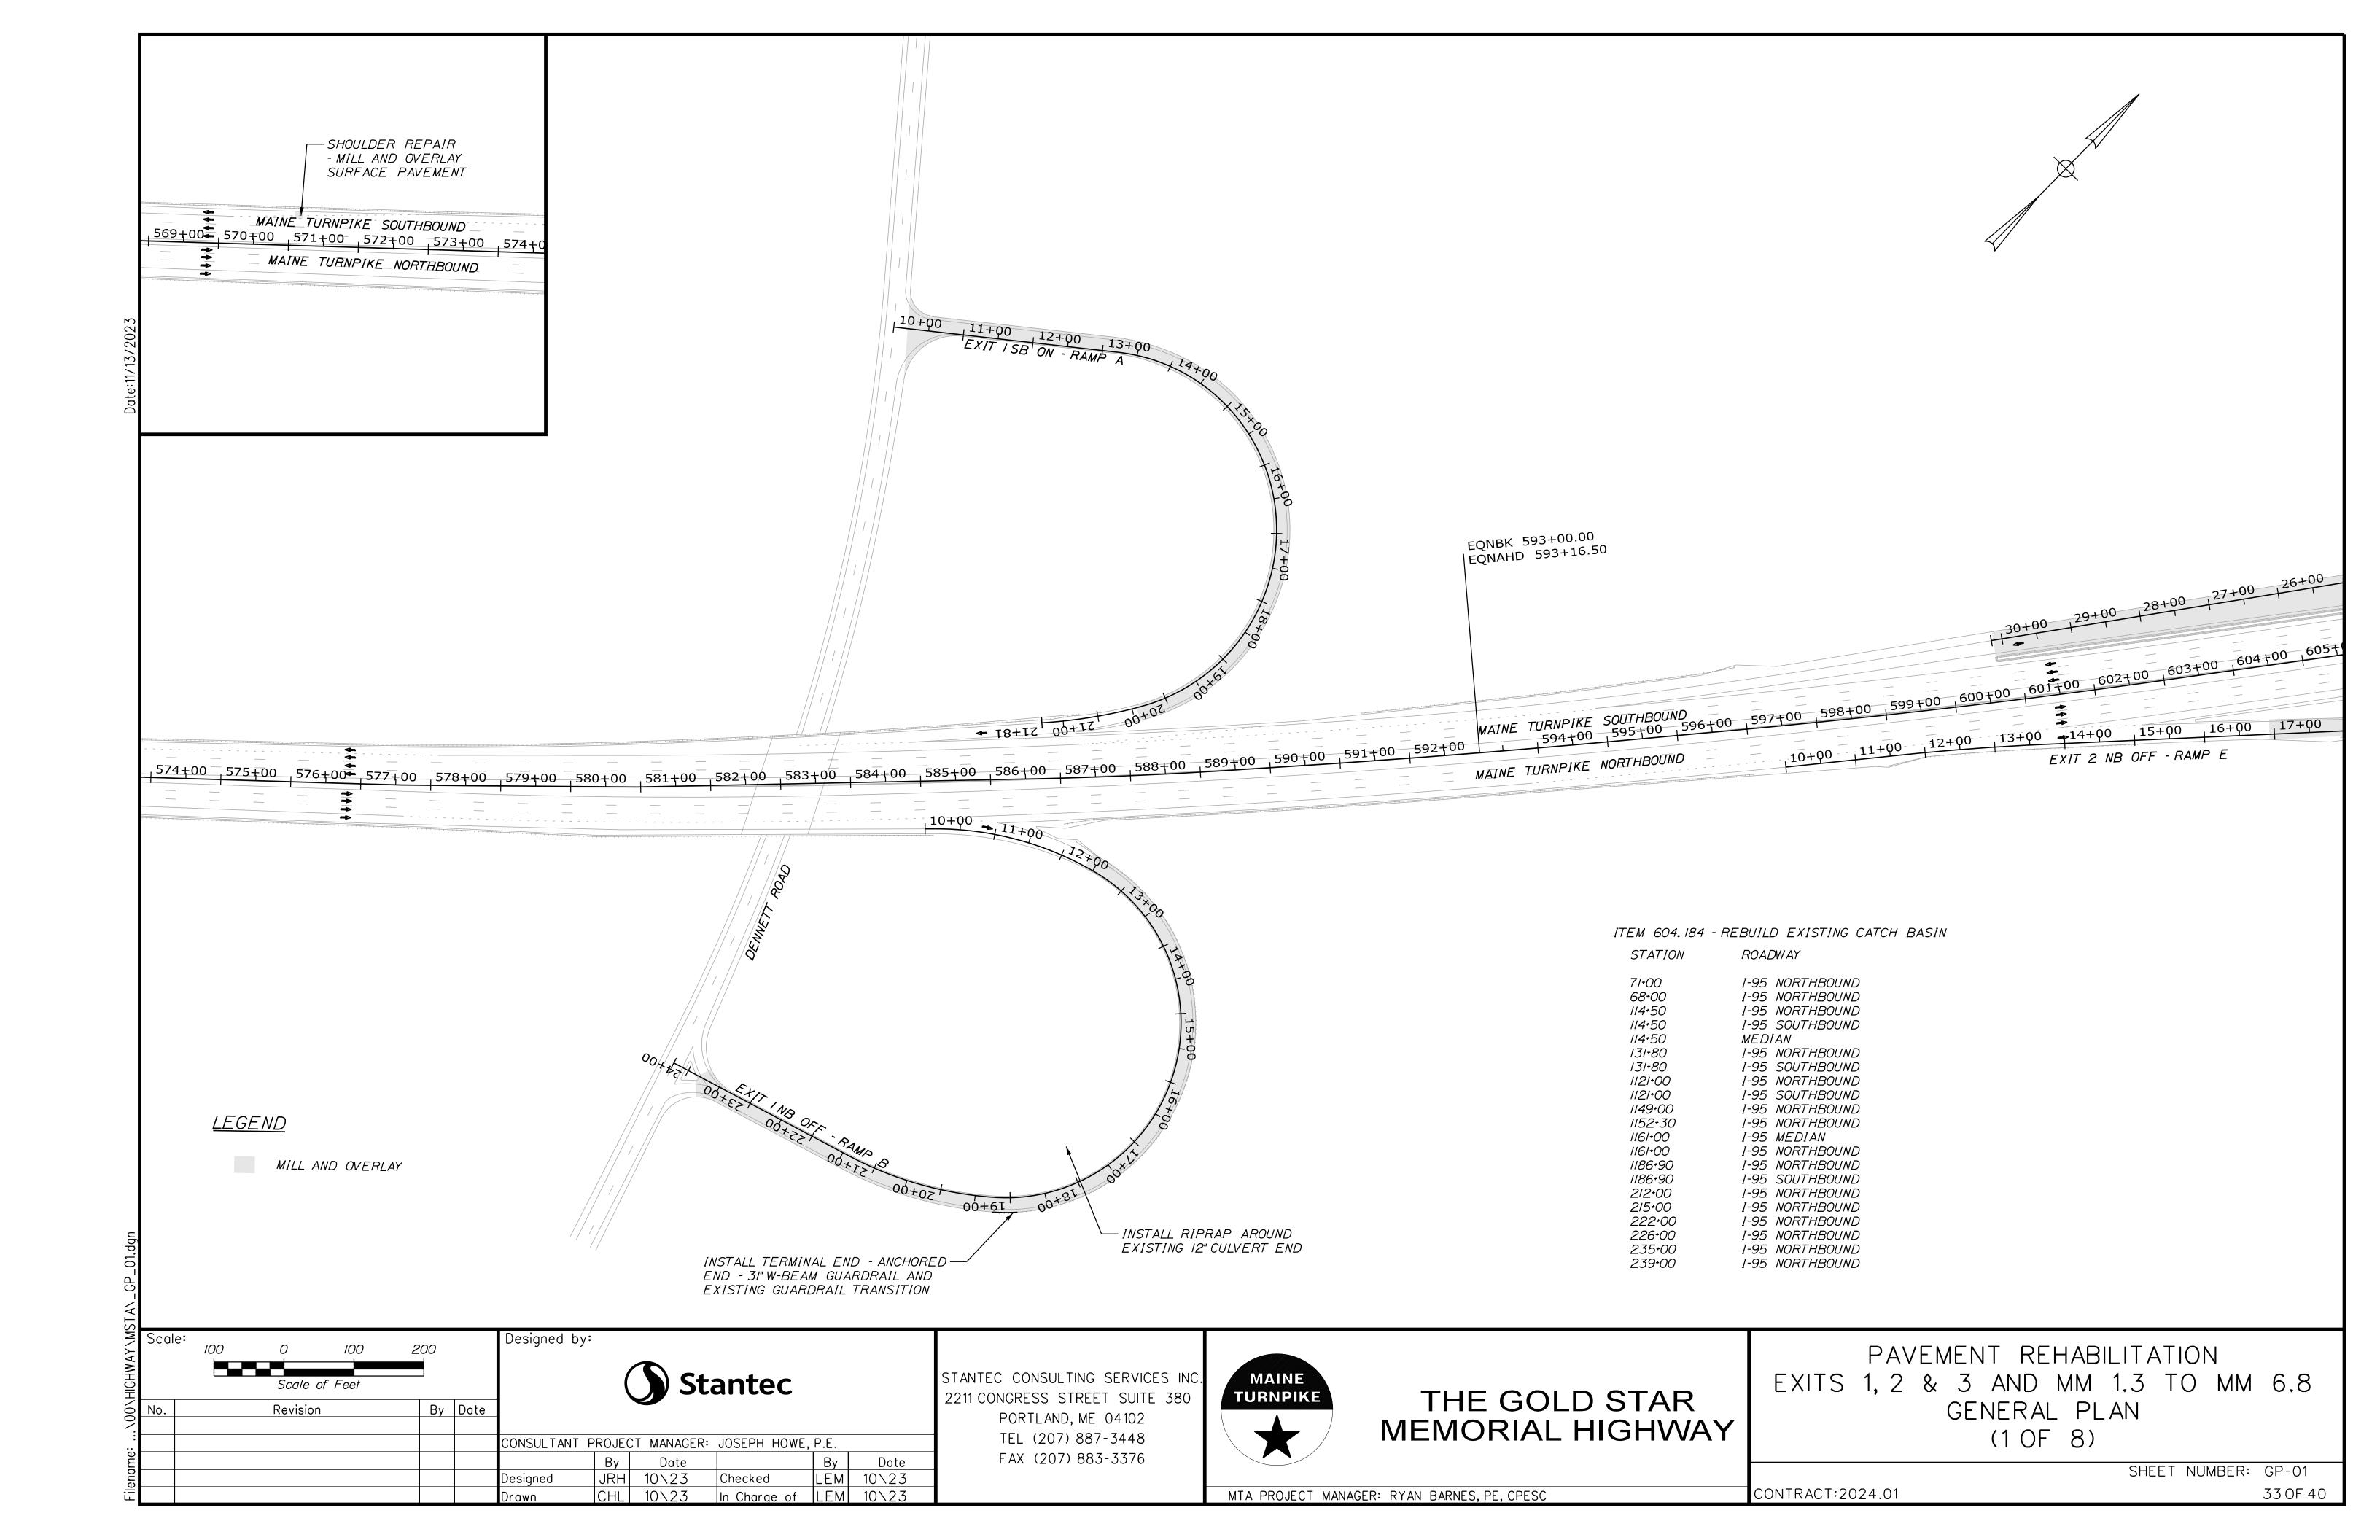



THE GOLD STAR MEMORIAL HIGHWAY


PAVEMENT REHABILITATION
EXITS 1, 2 & 3 AND MM 1.3 TO MM 6.8


RUMBLE STRIP DETAILS


SHEET NUMBER: DT-10 CONTRACT:2024.01 32 OF 40




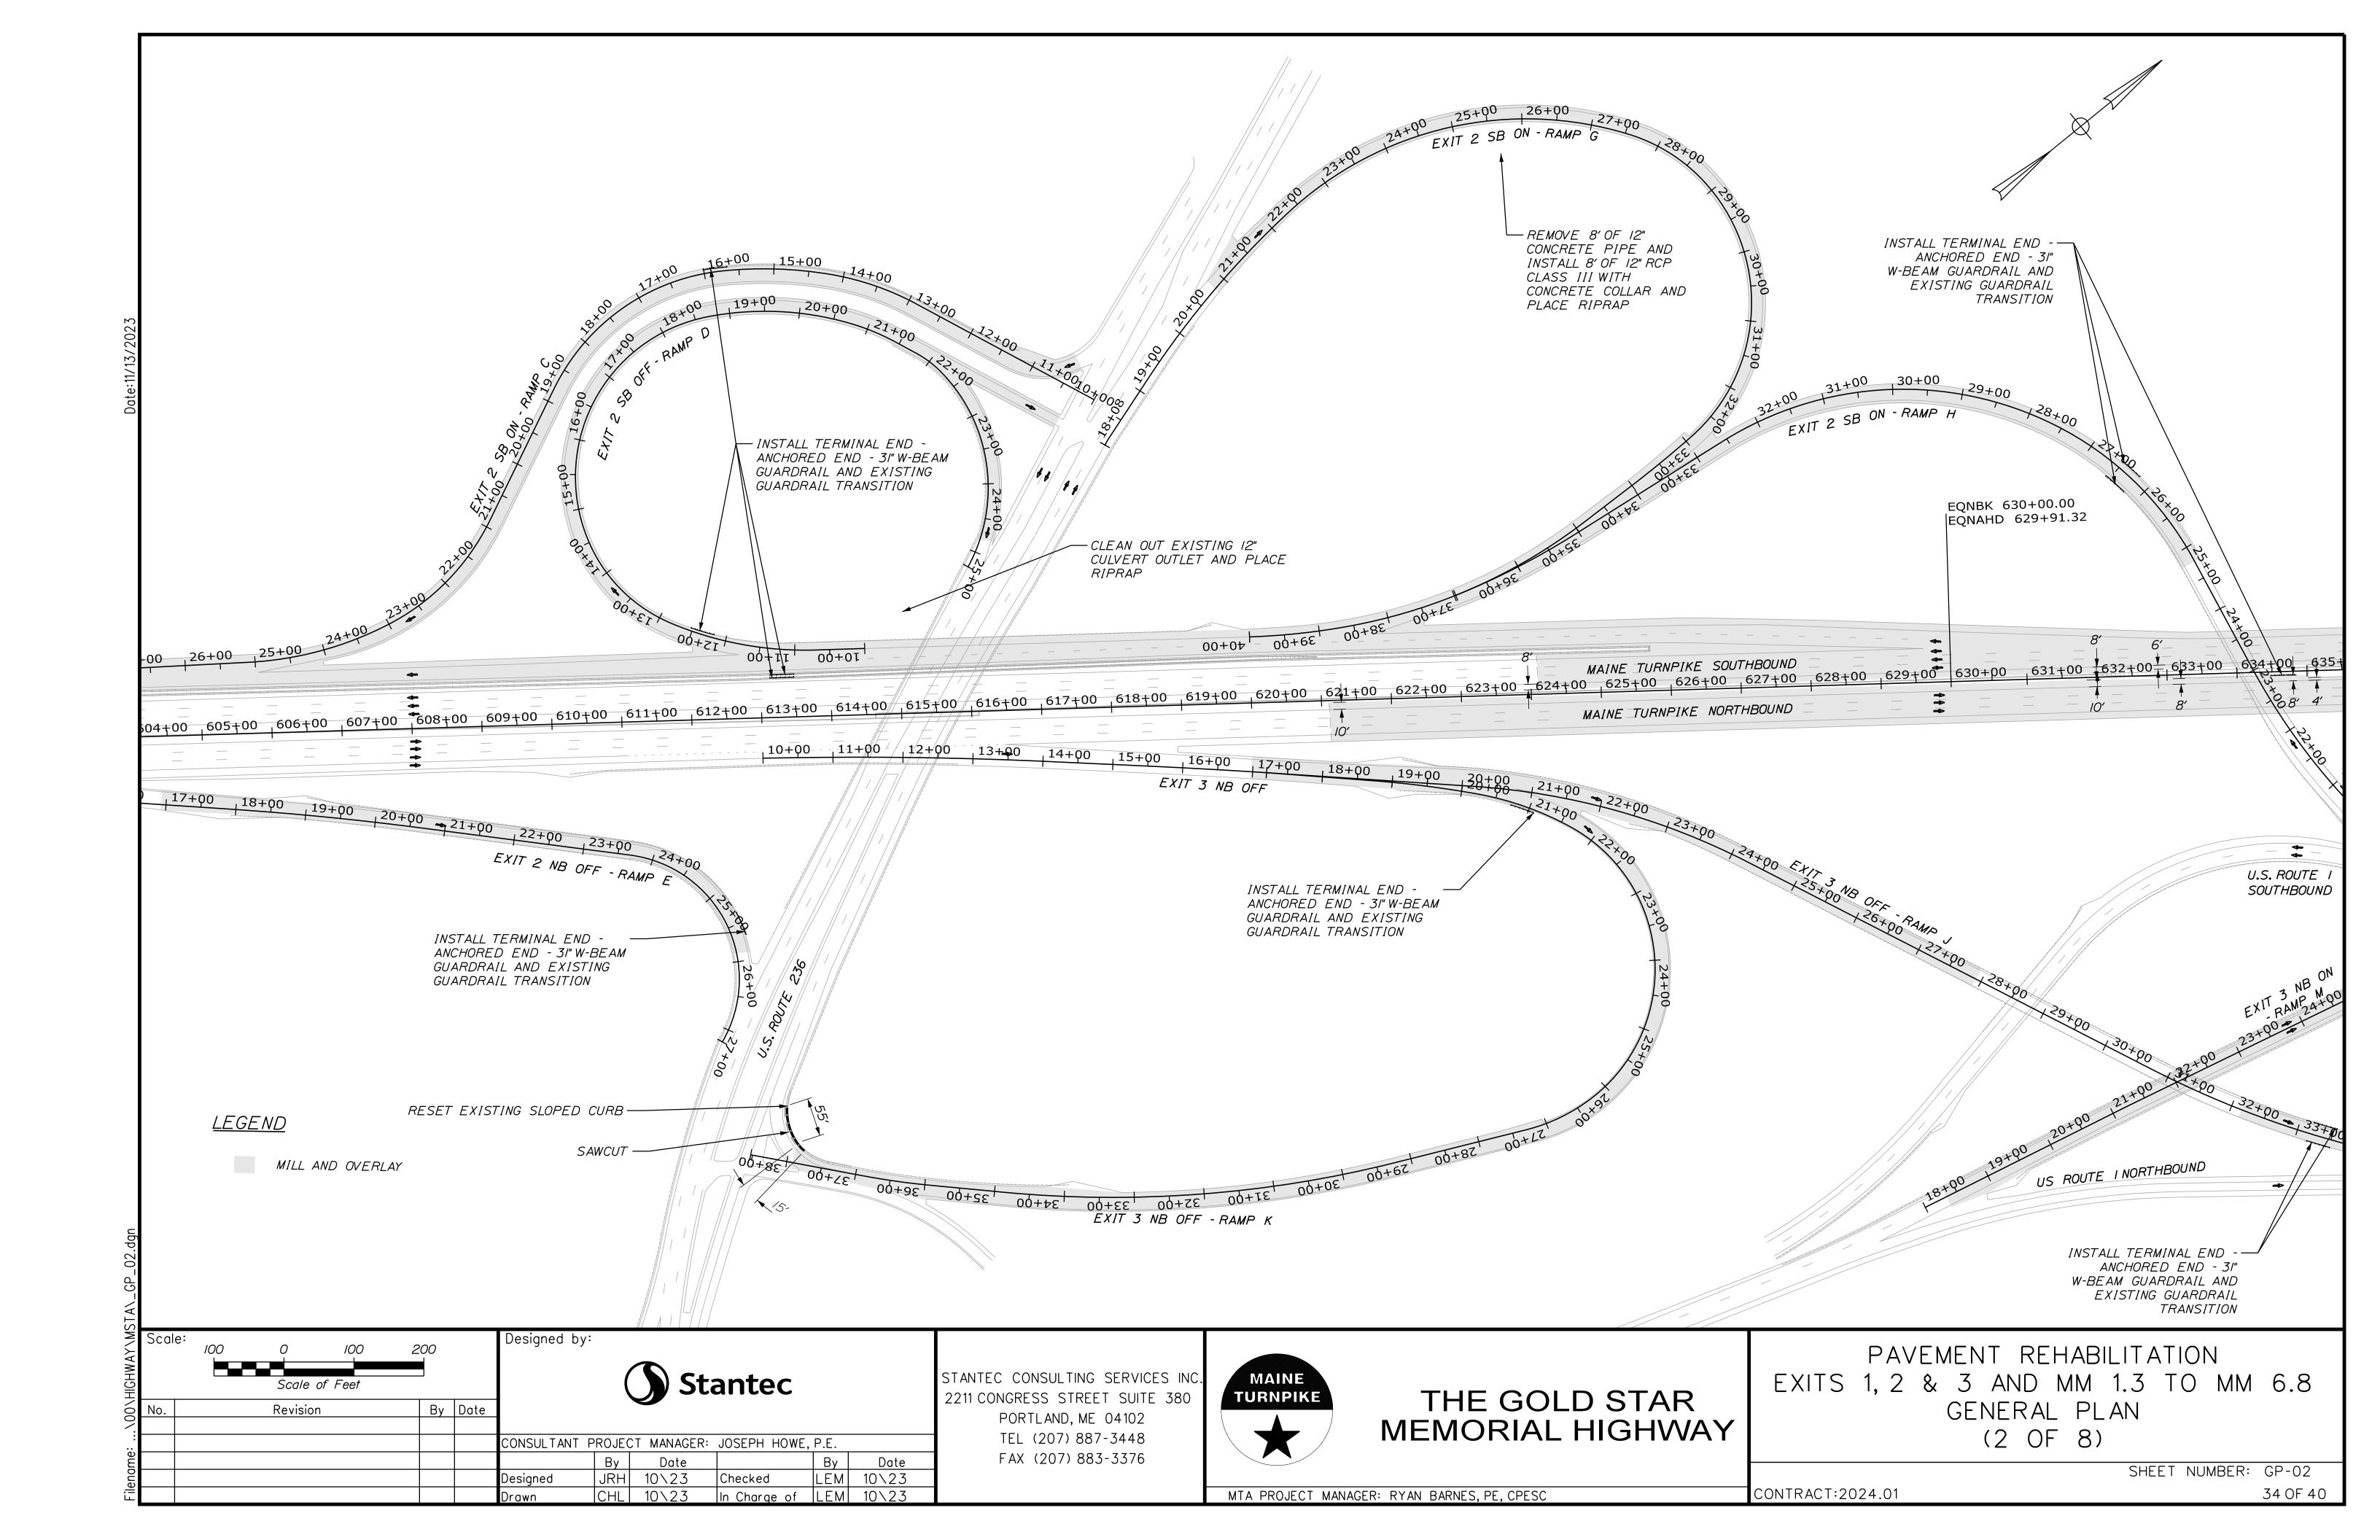


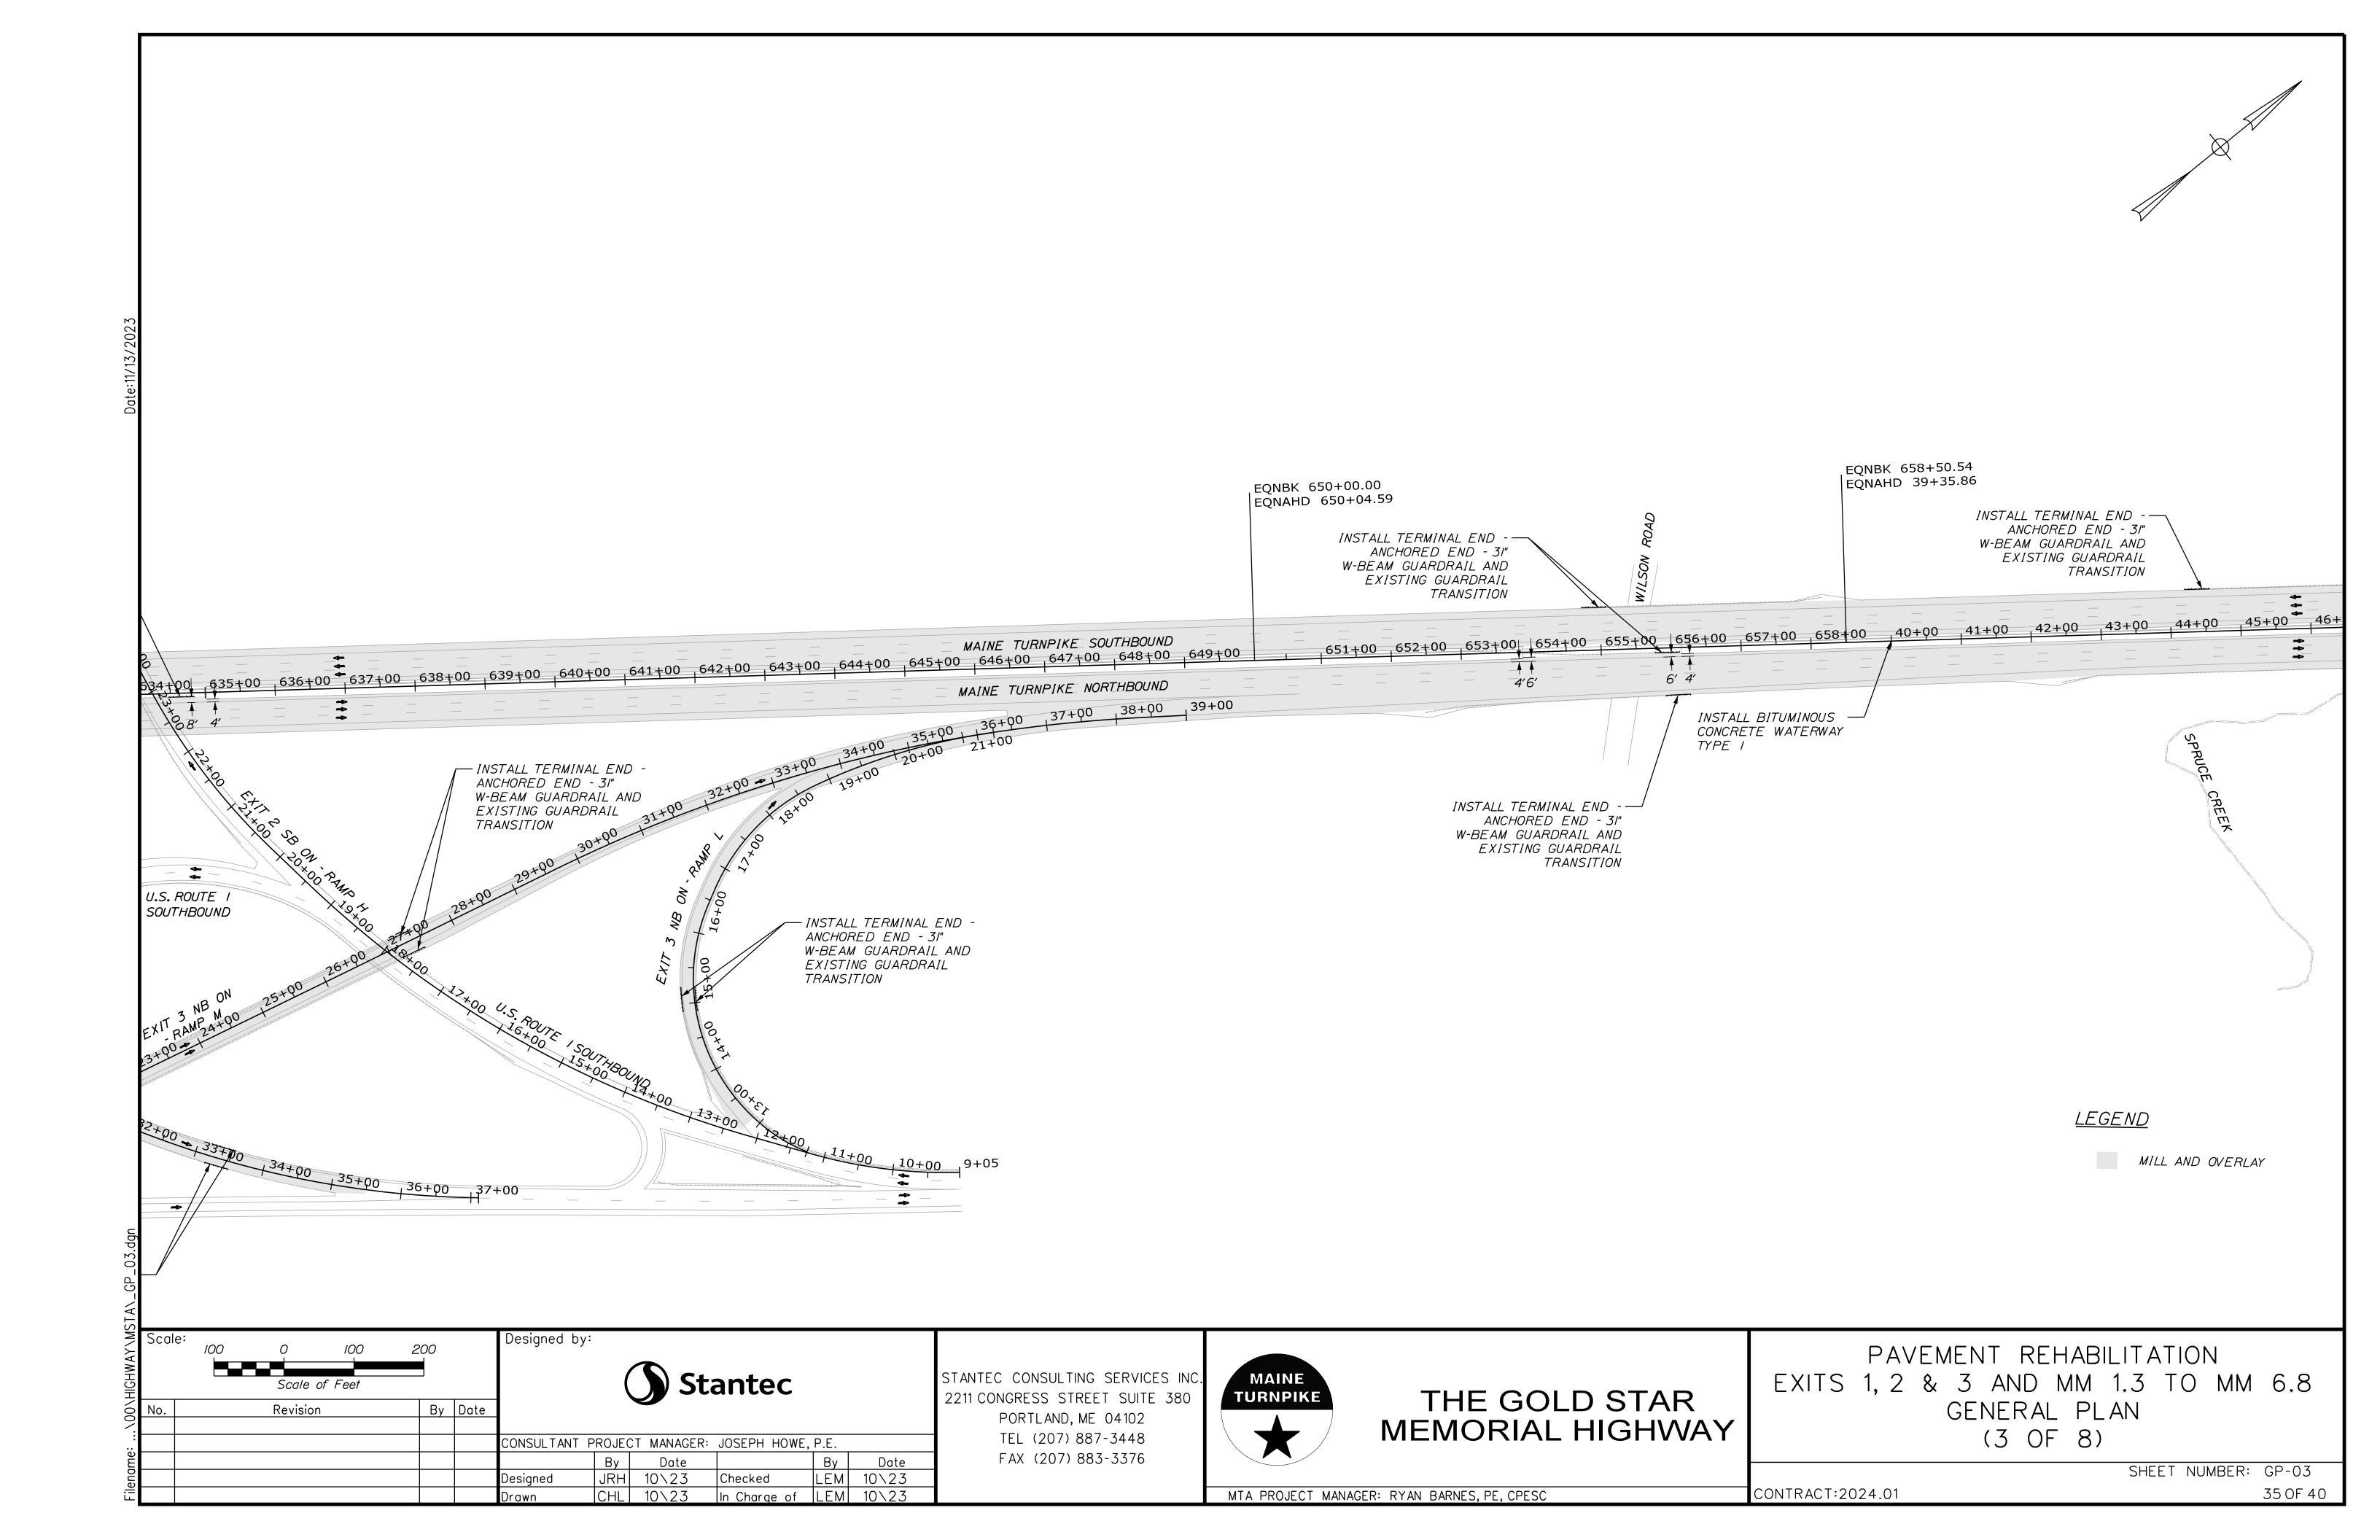


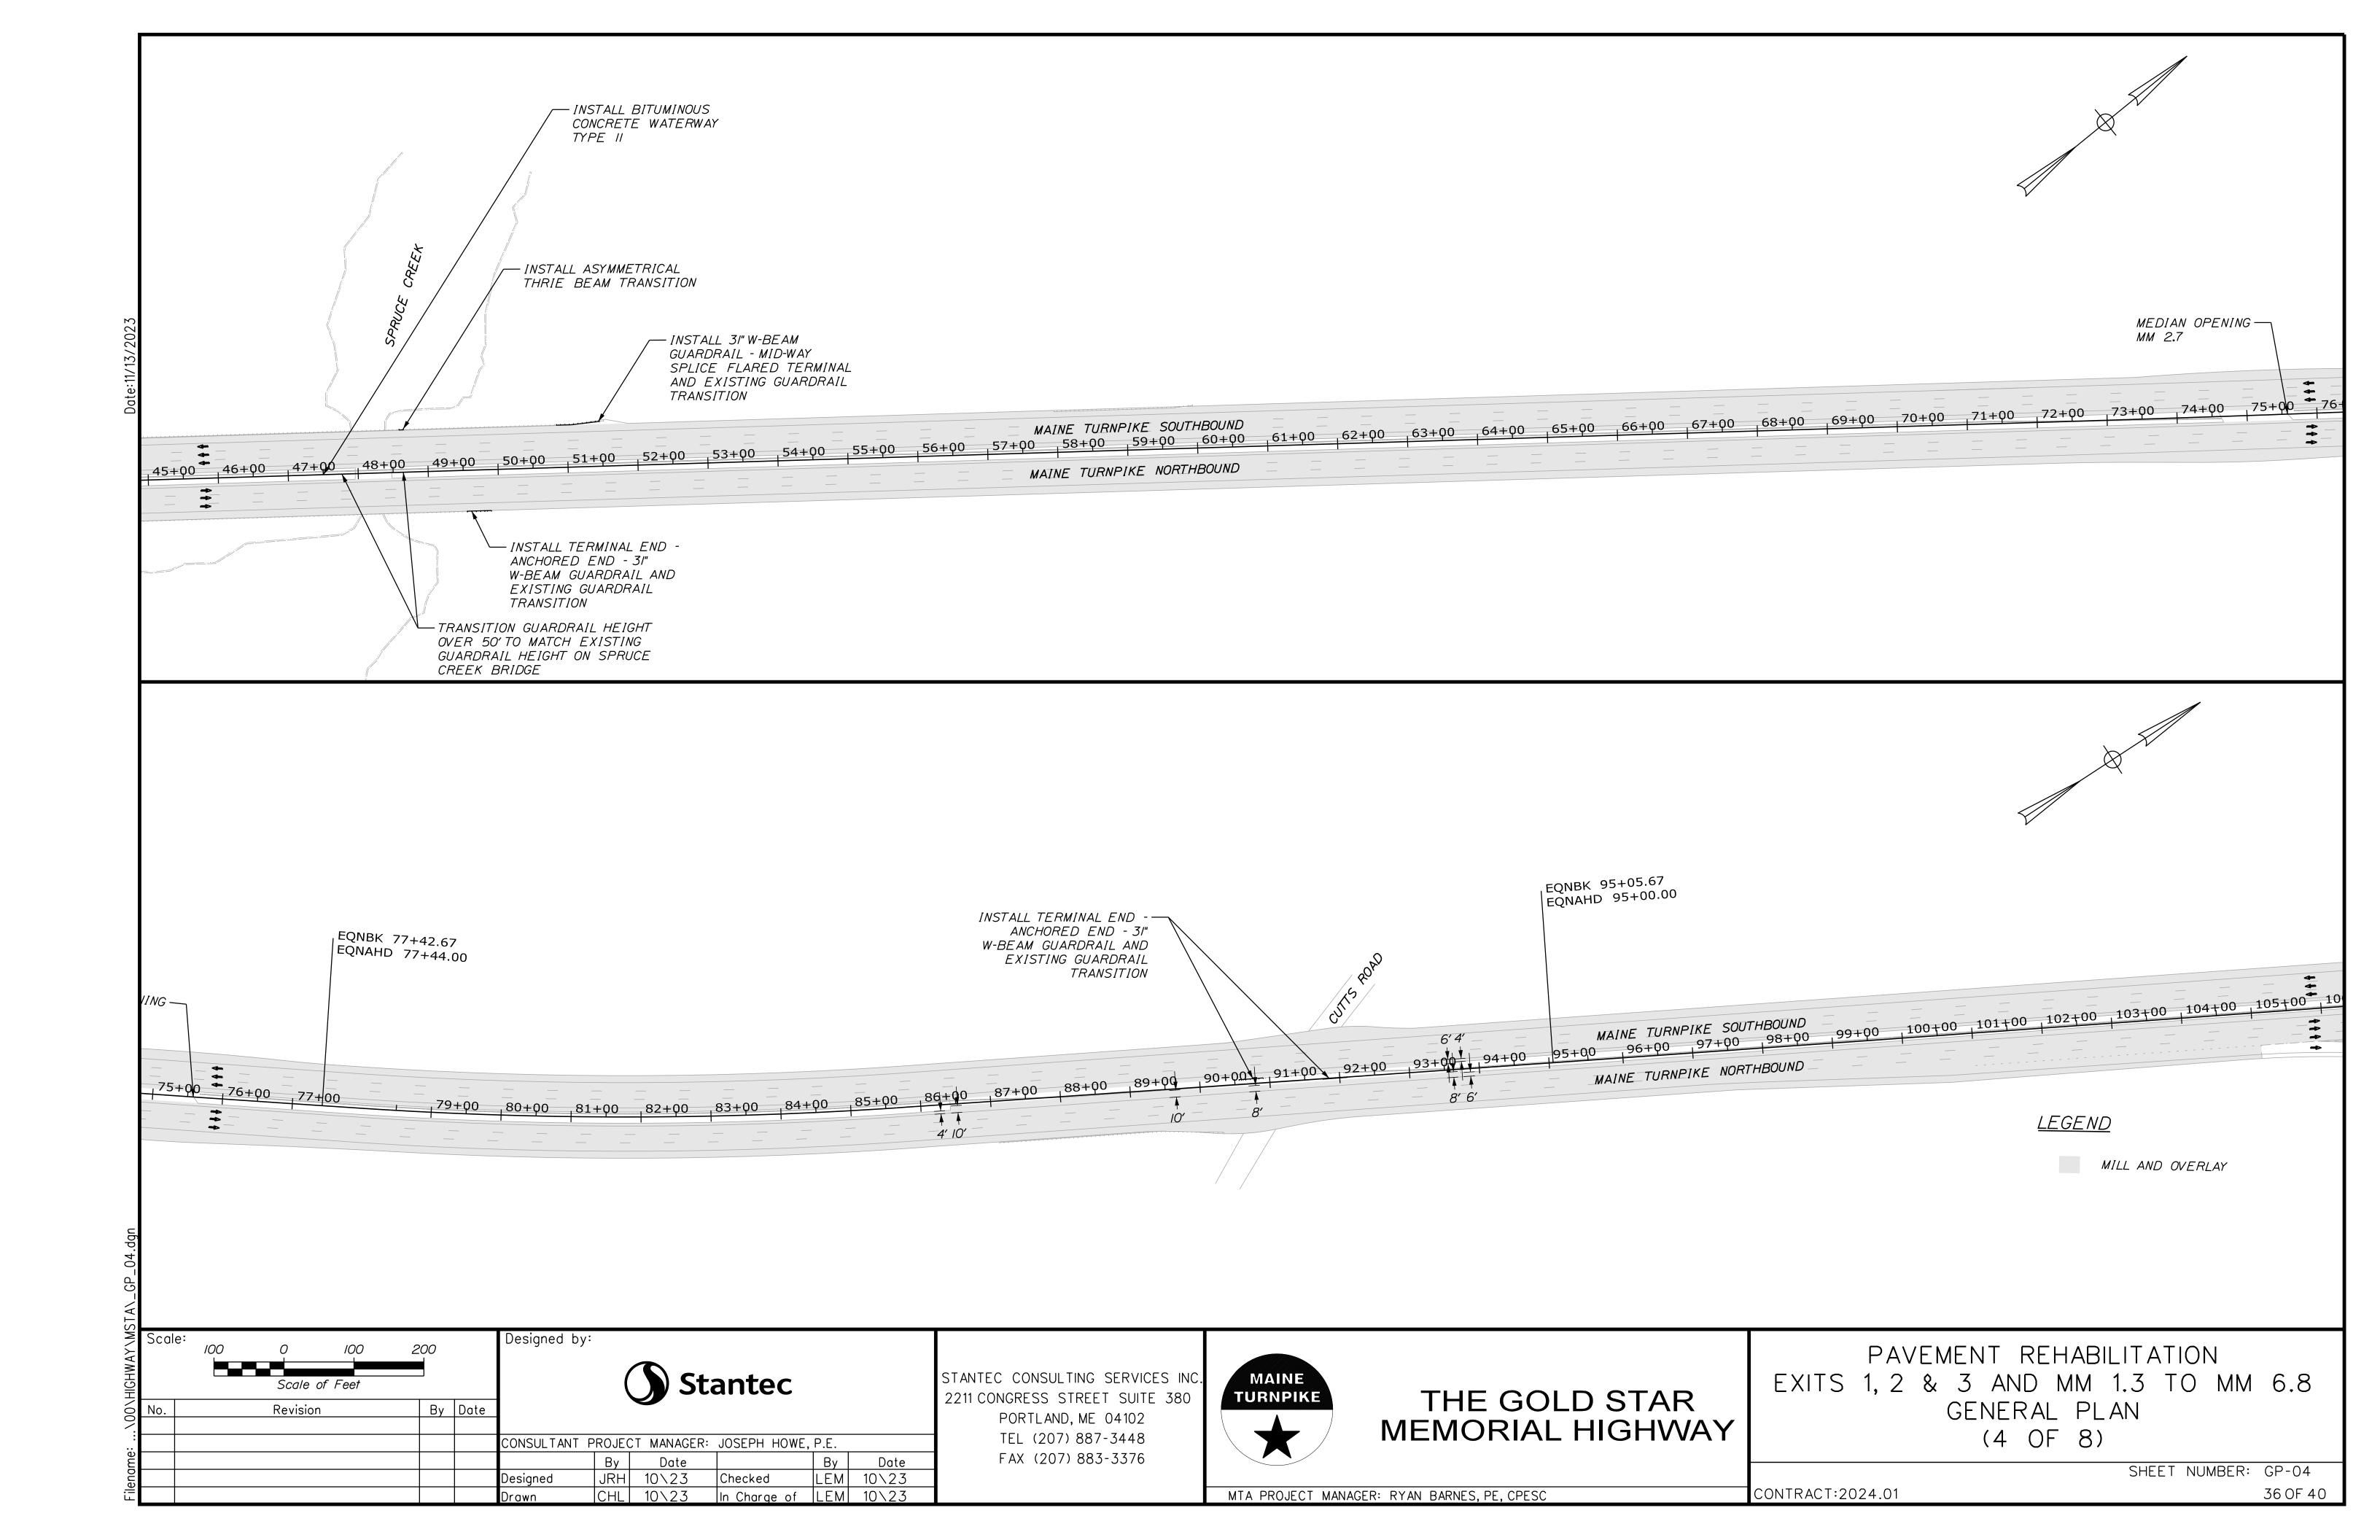


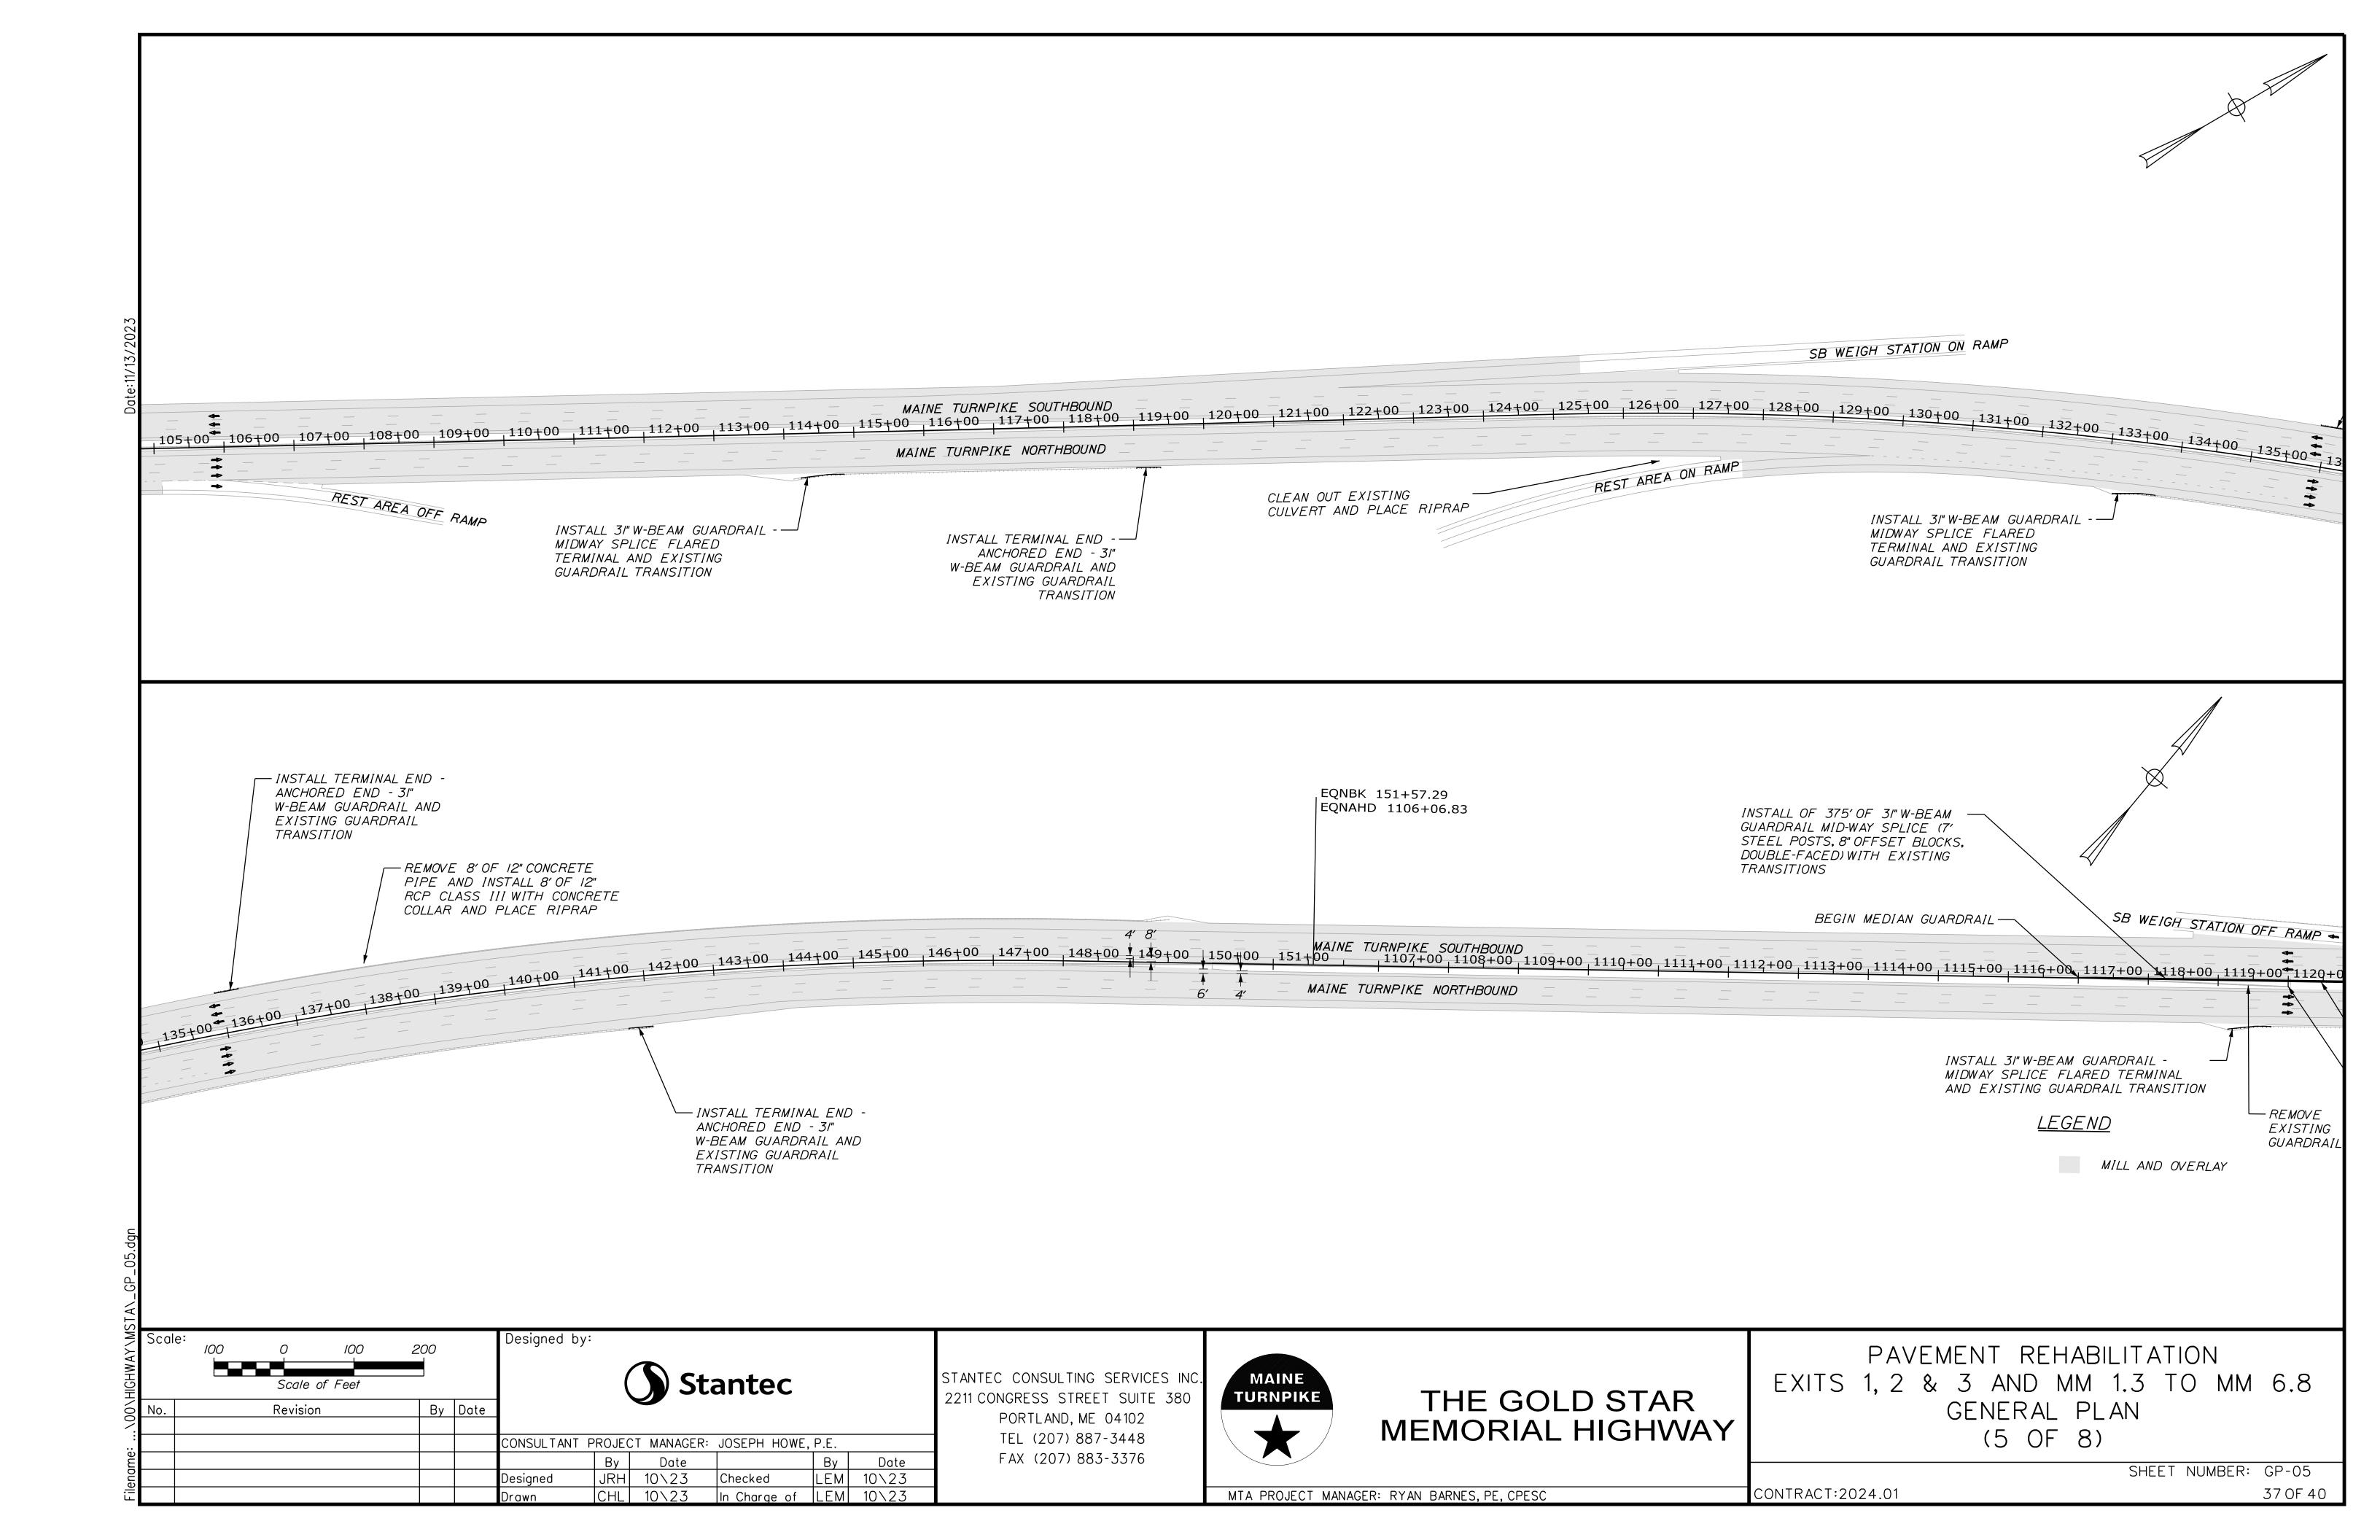


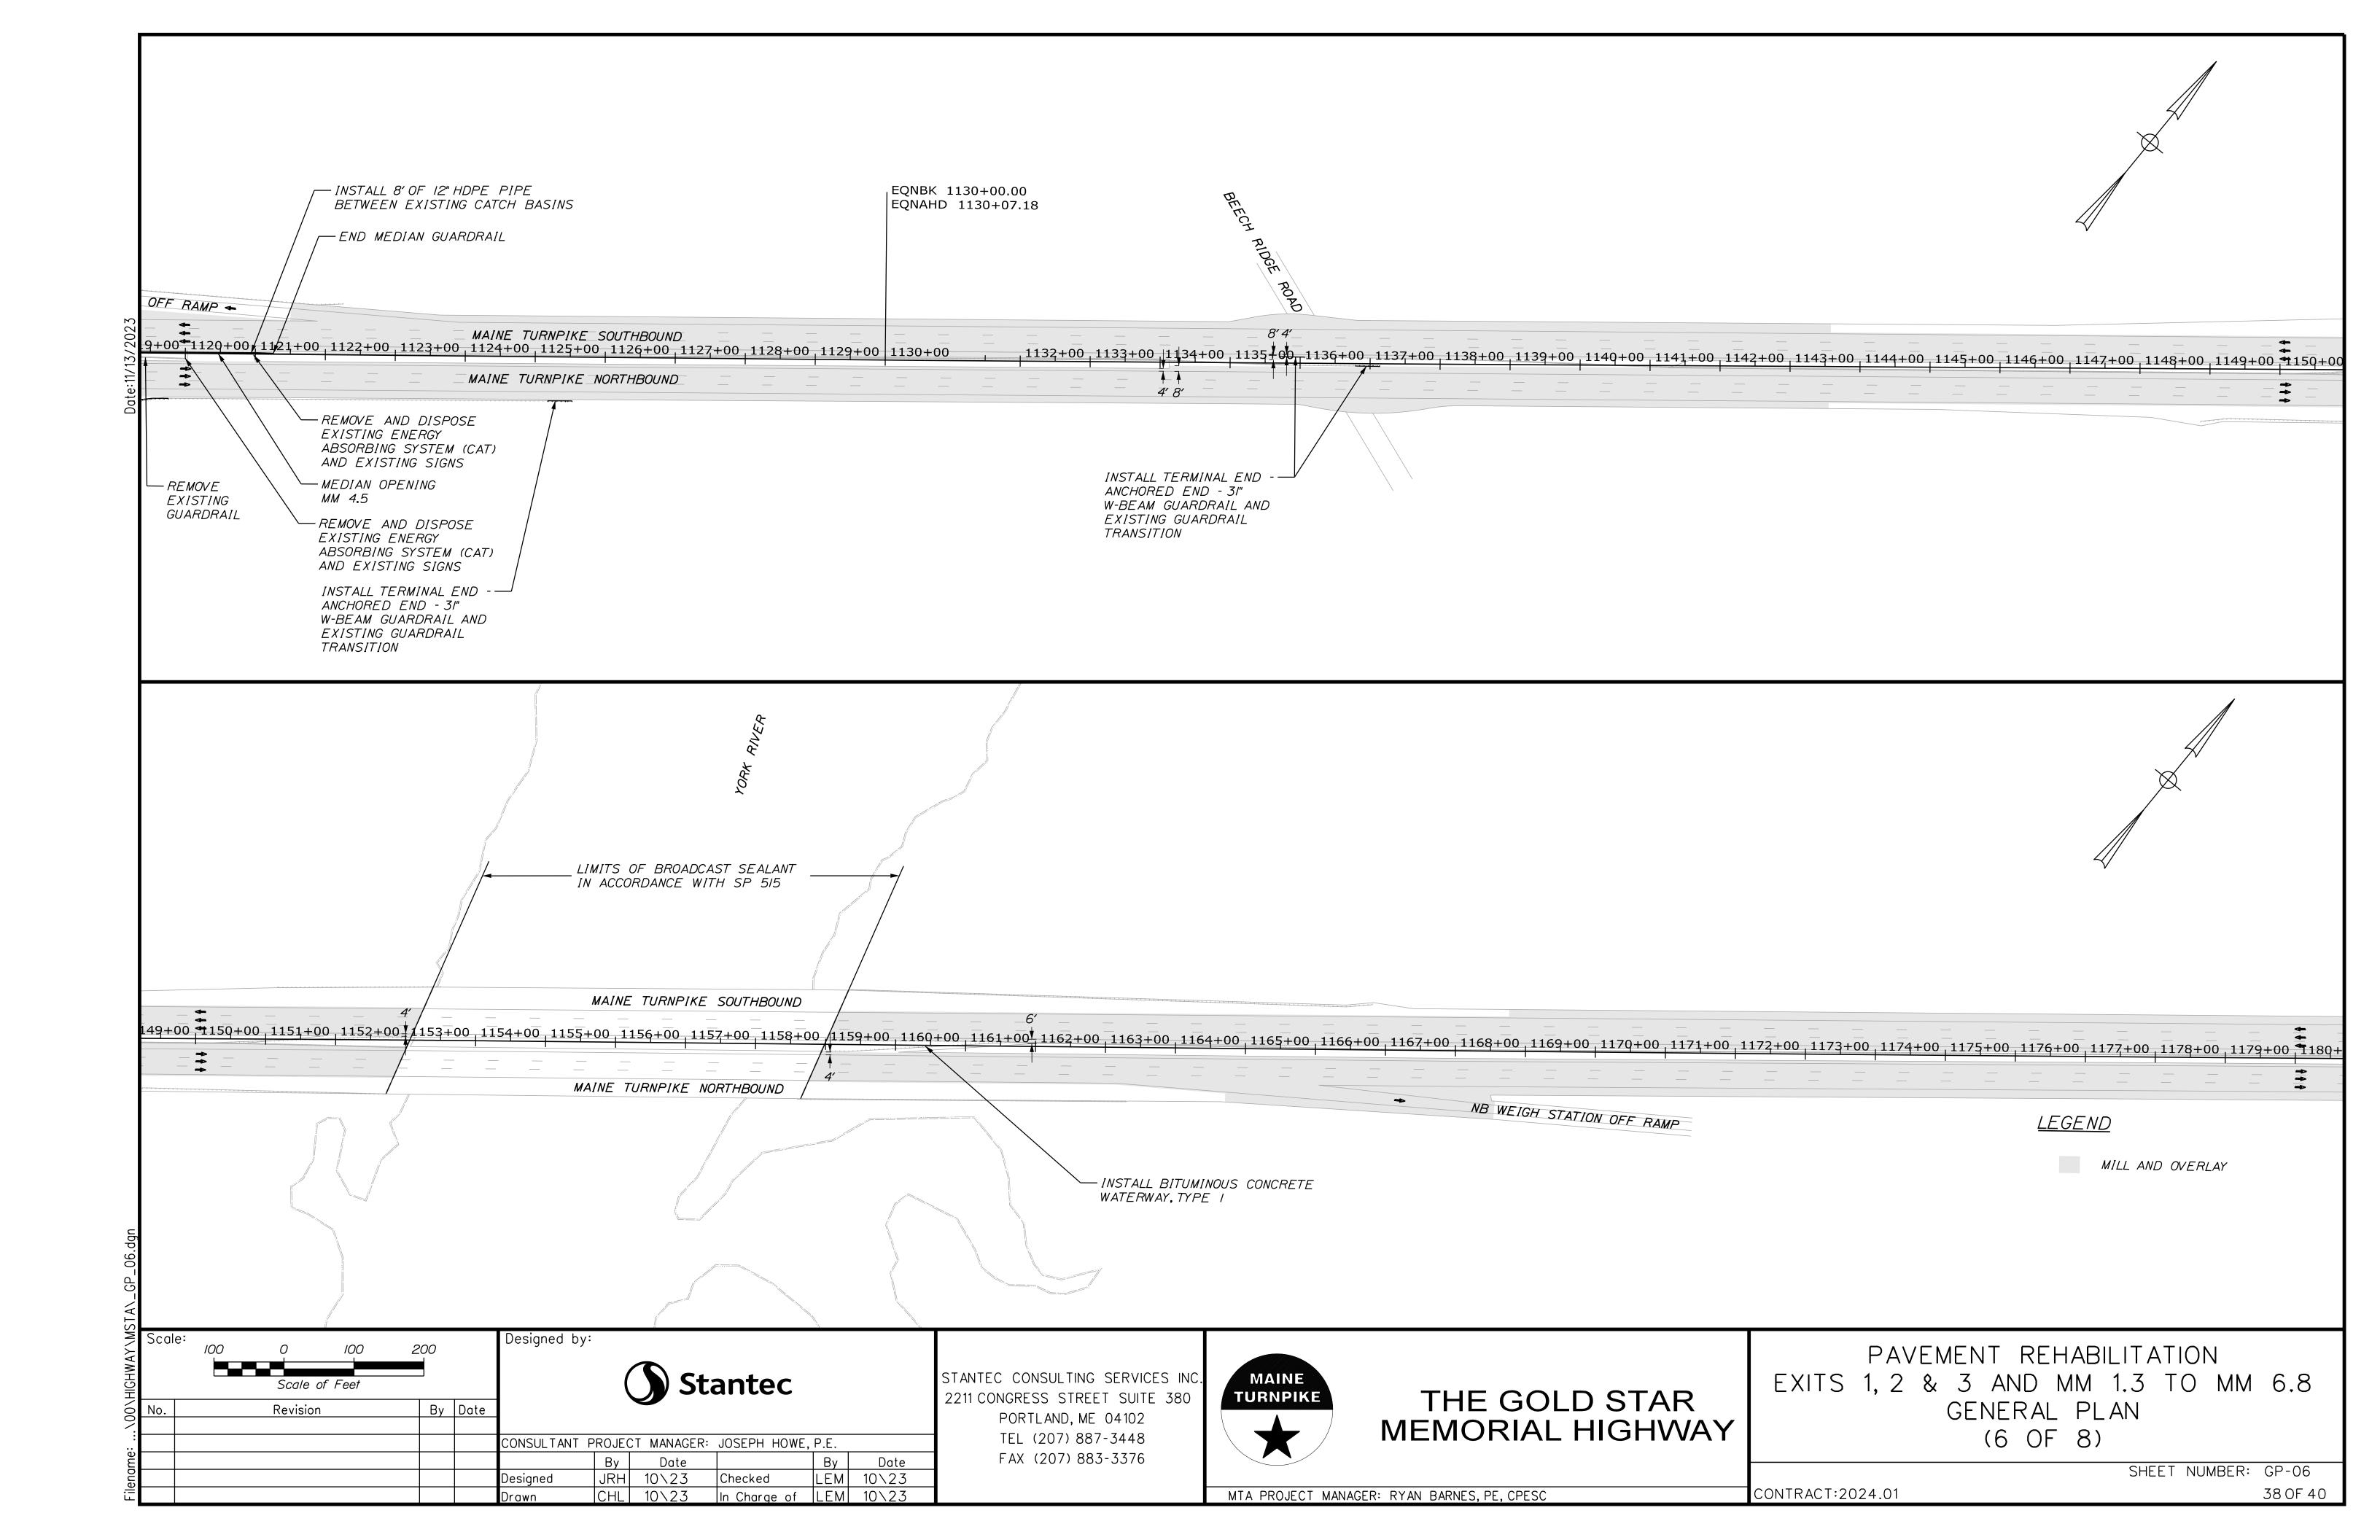


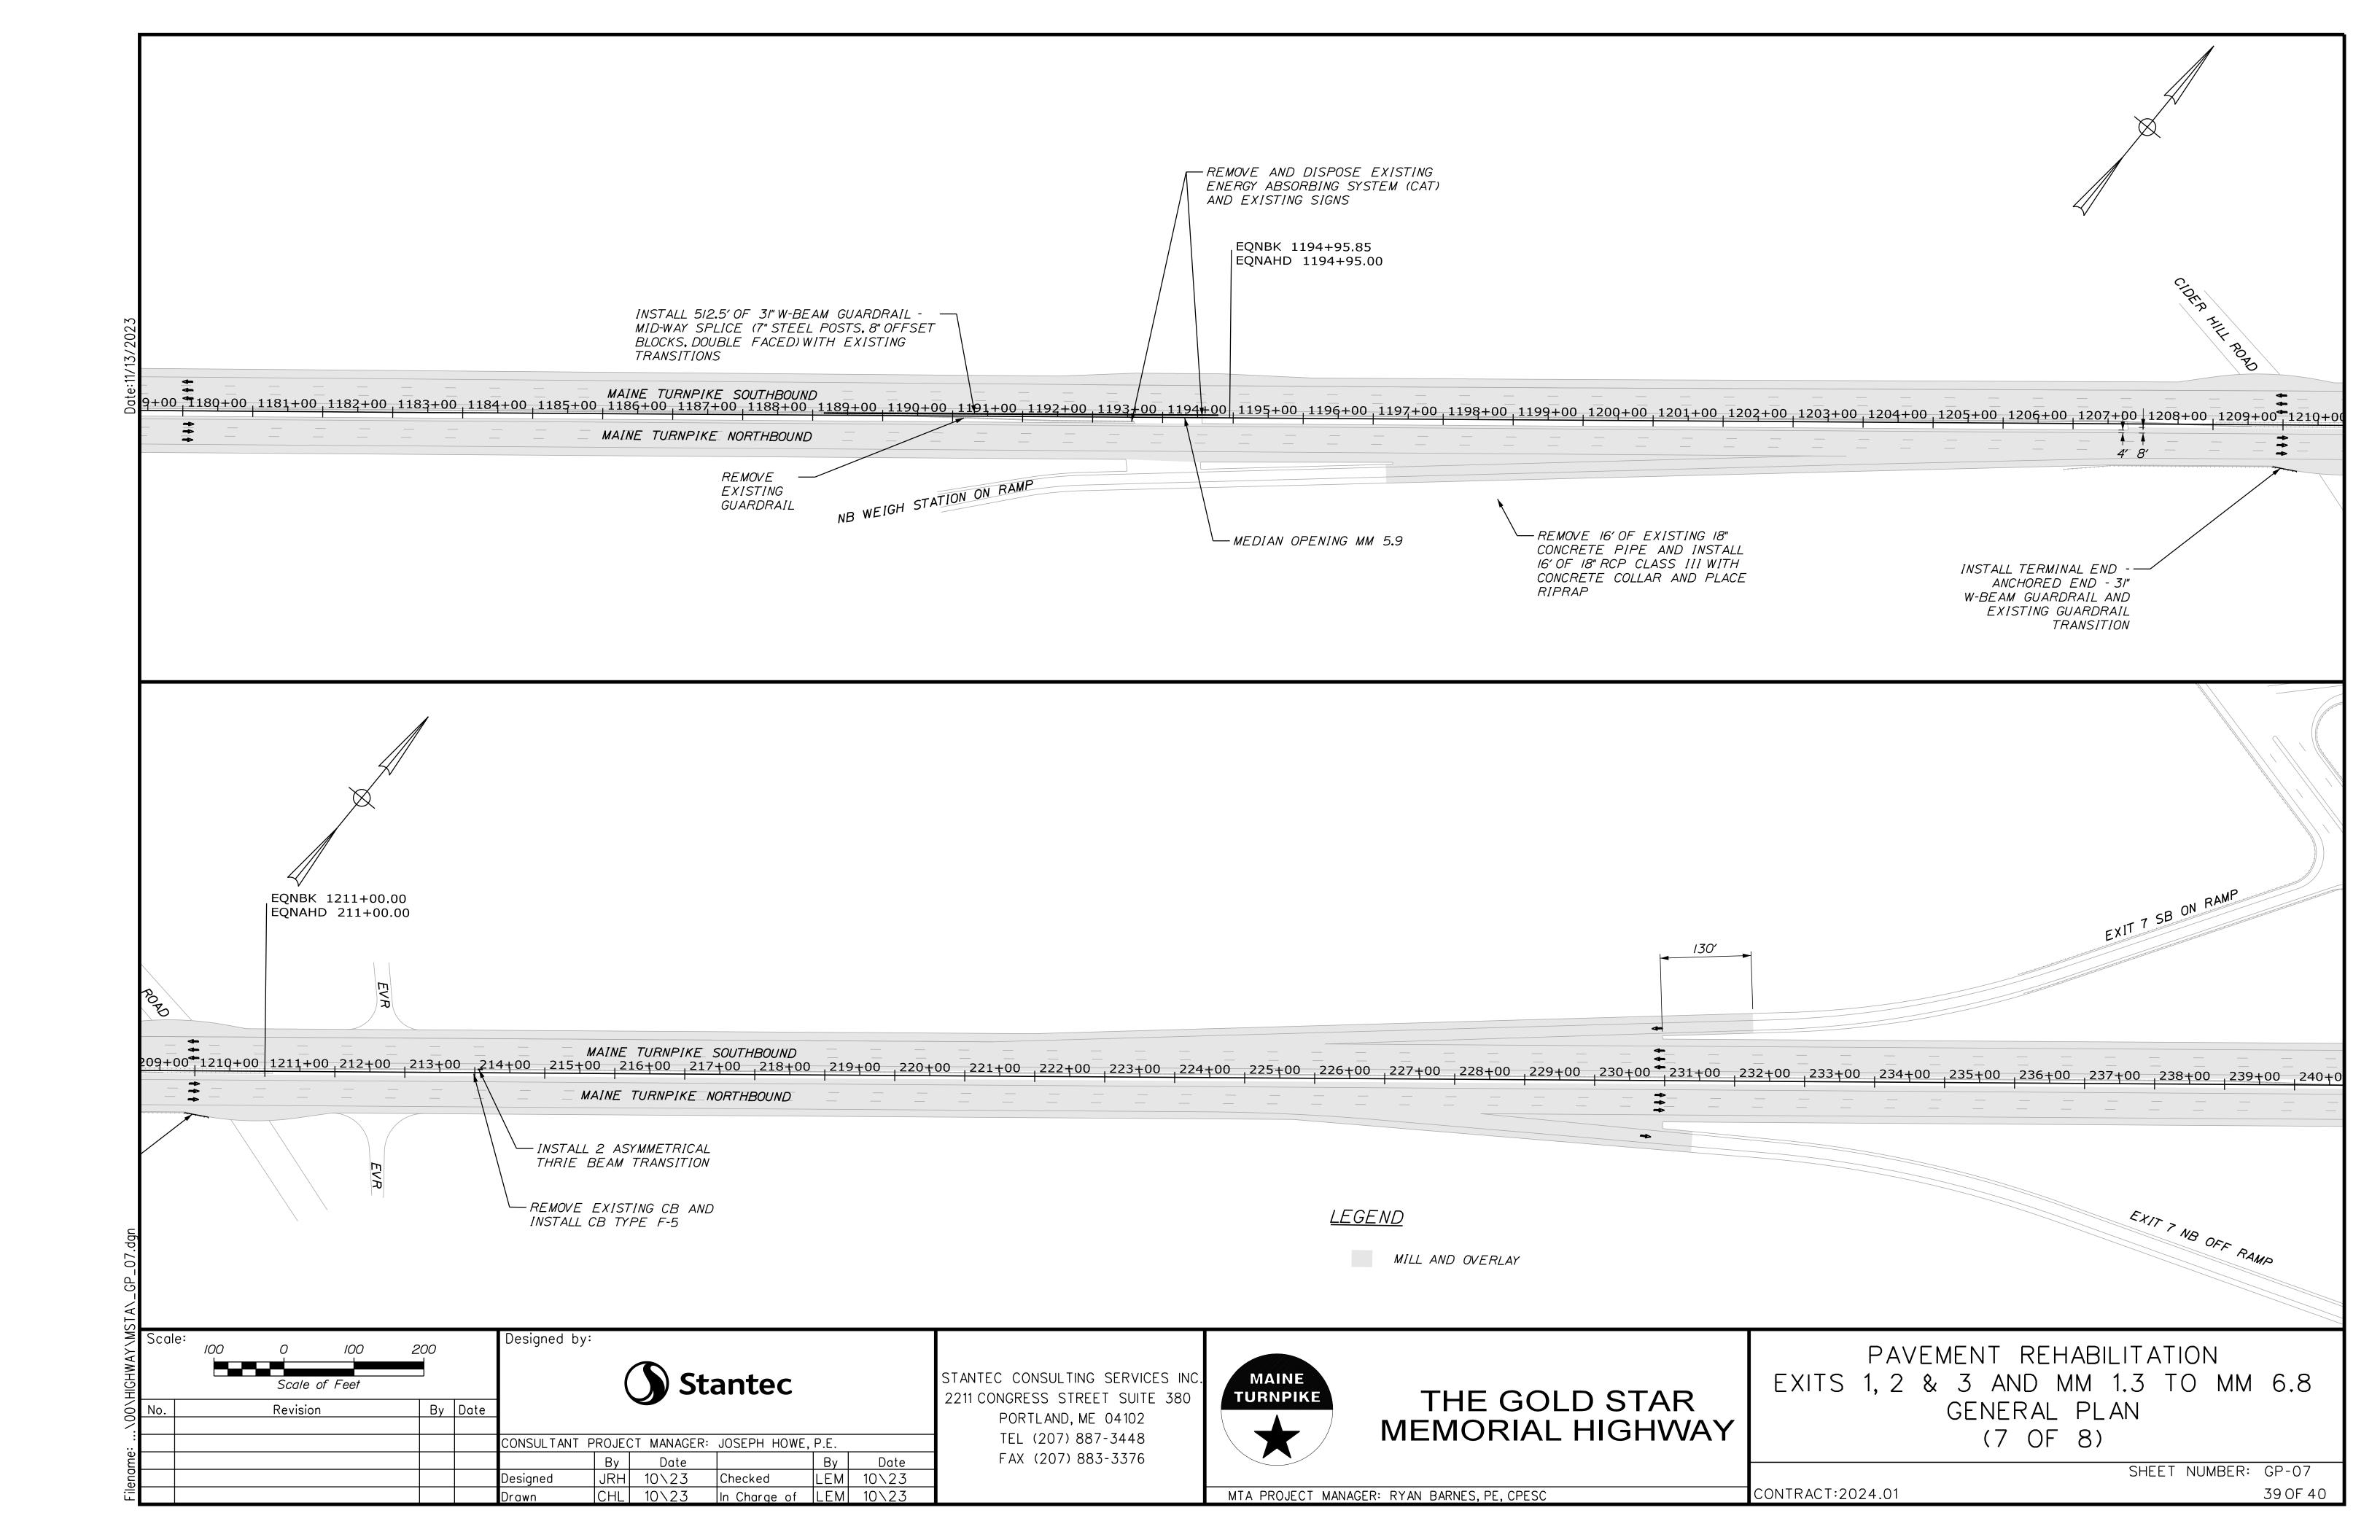


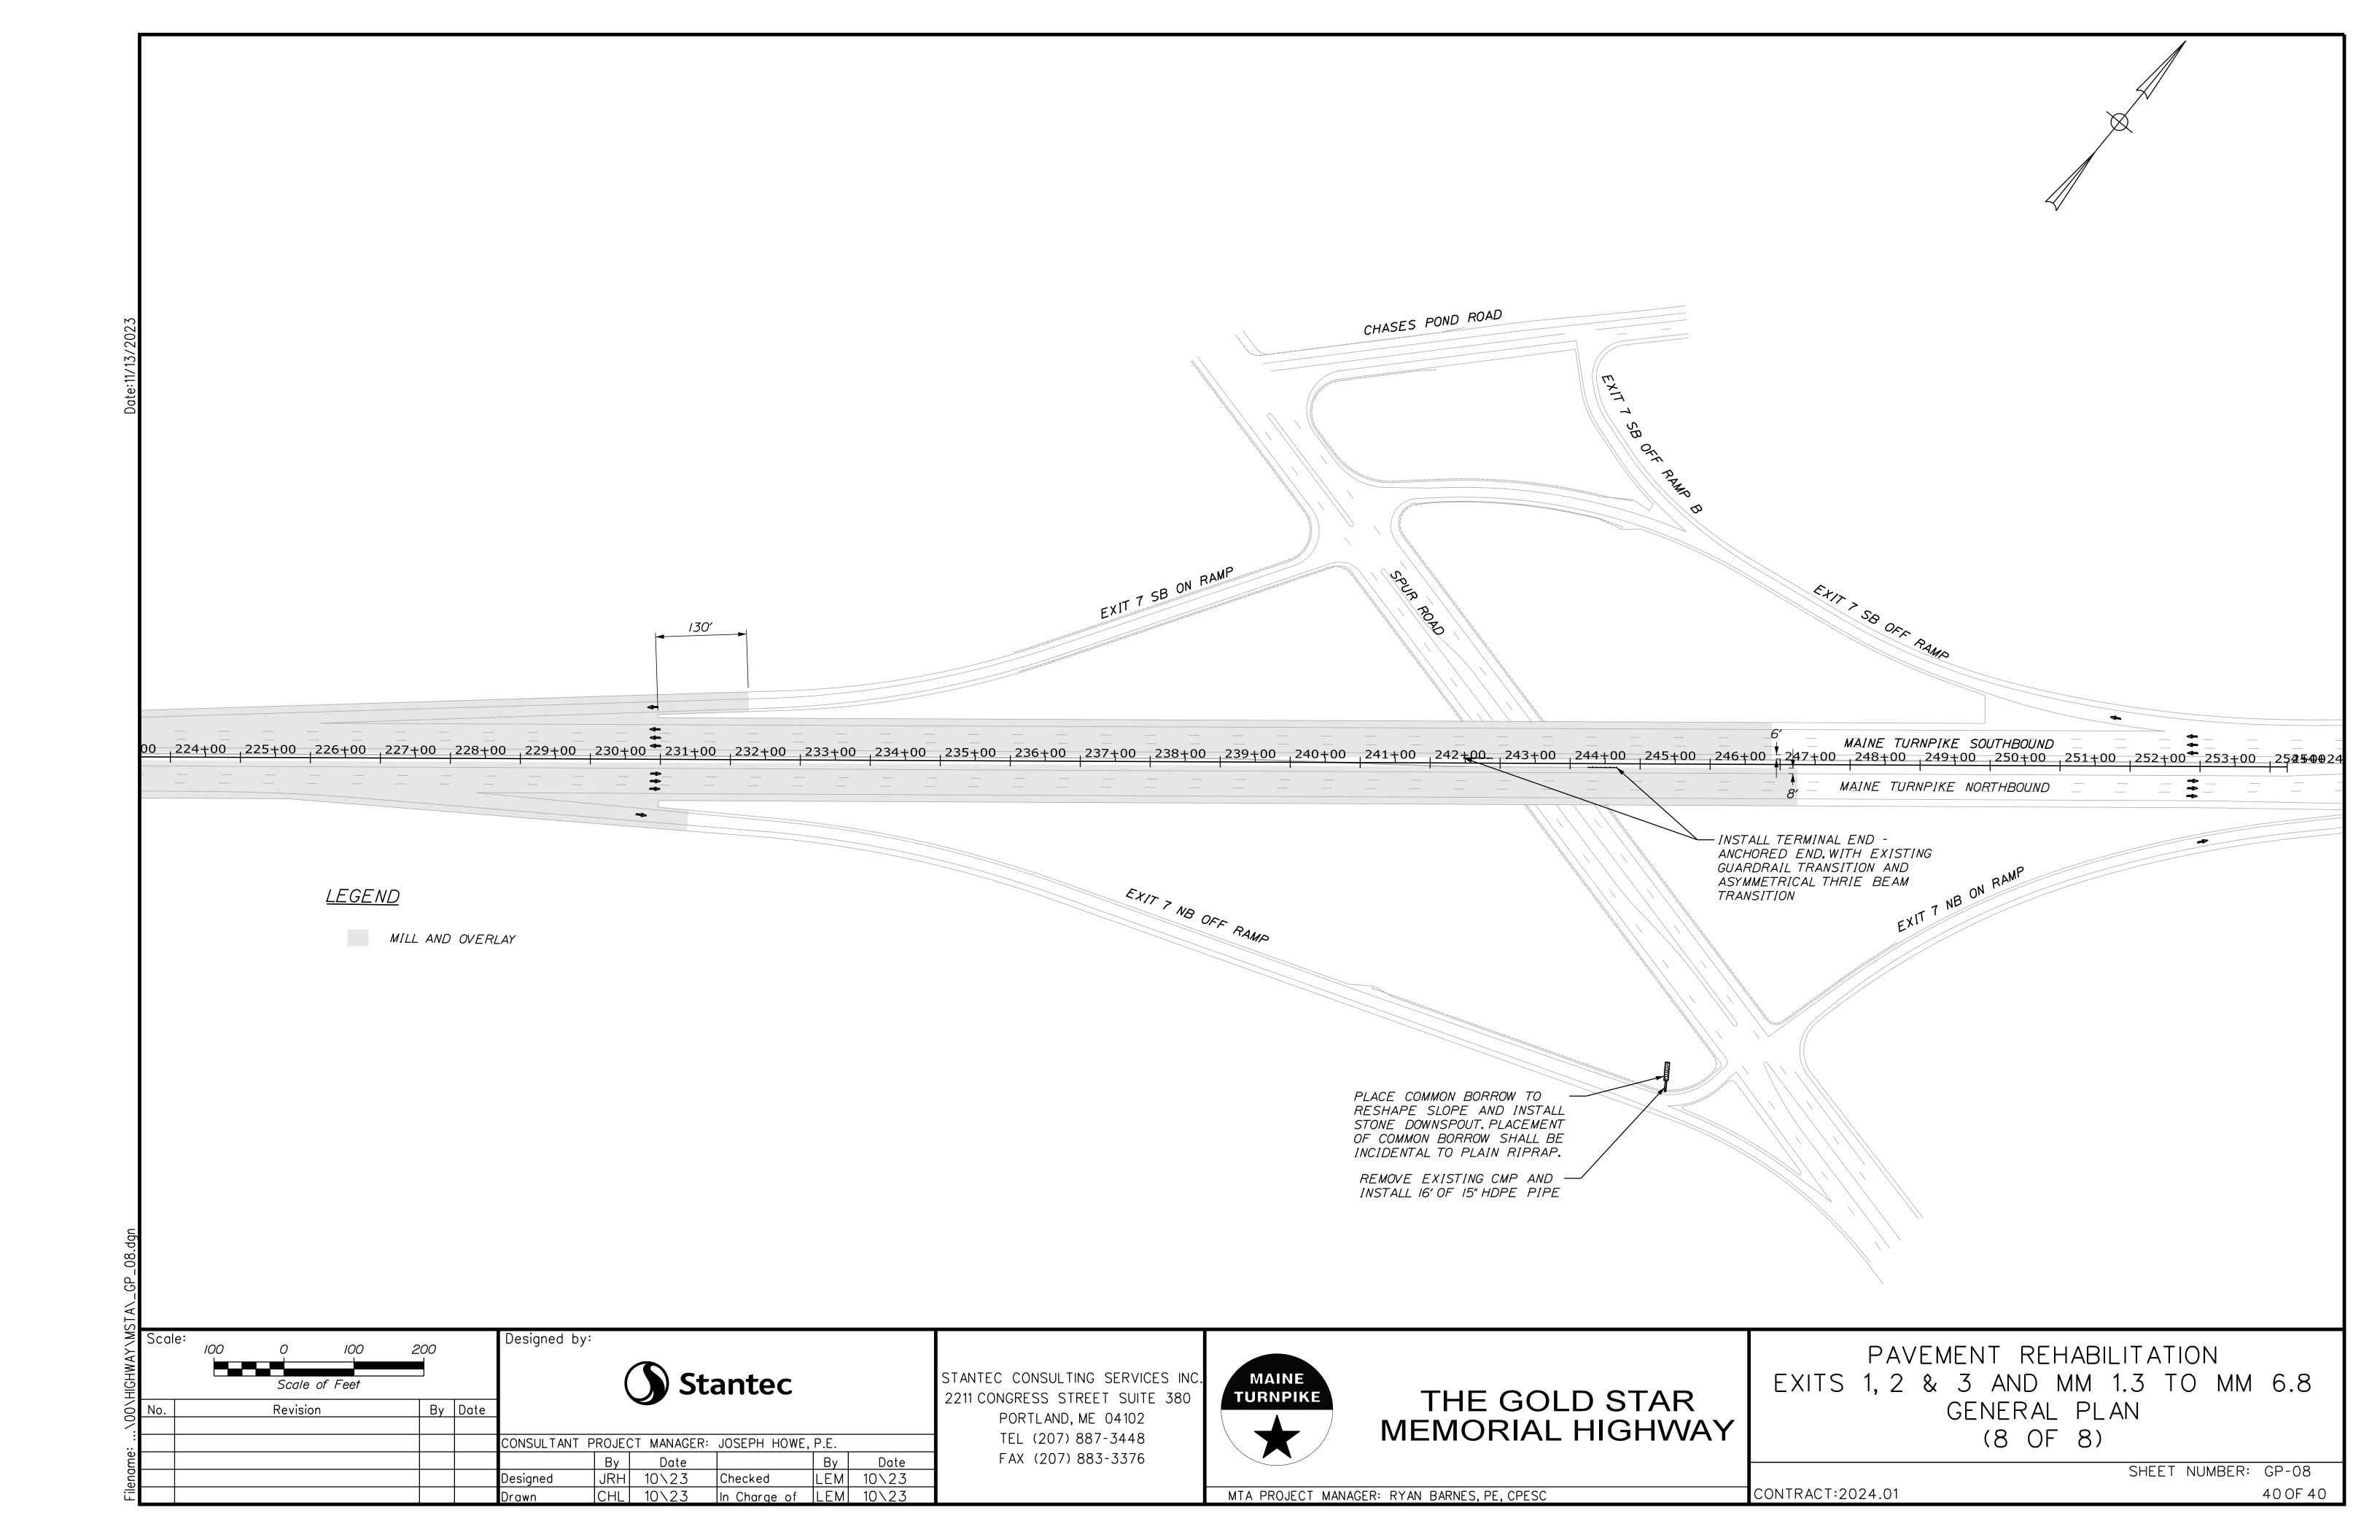


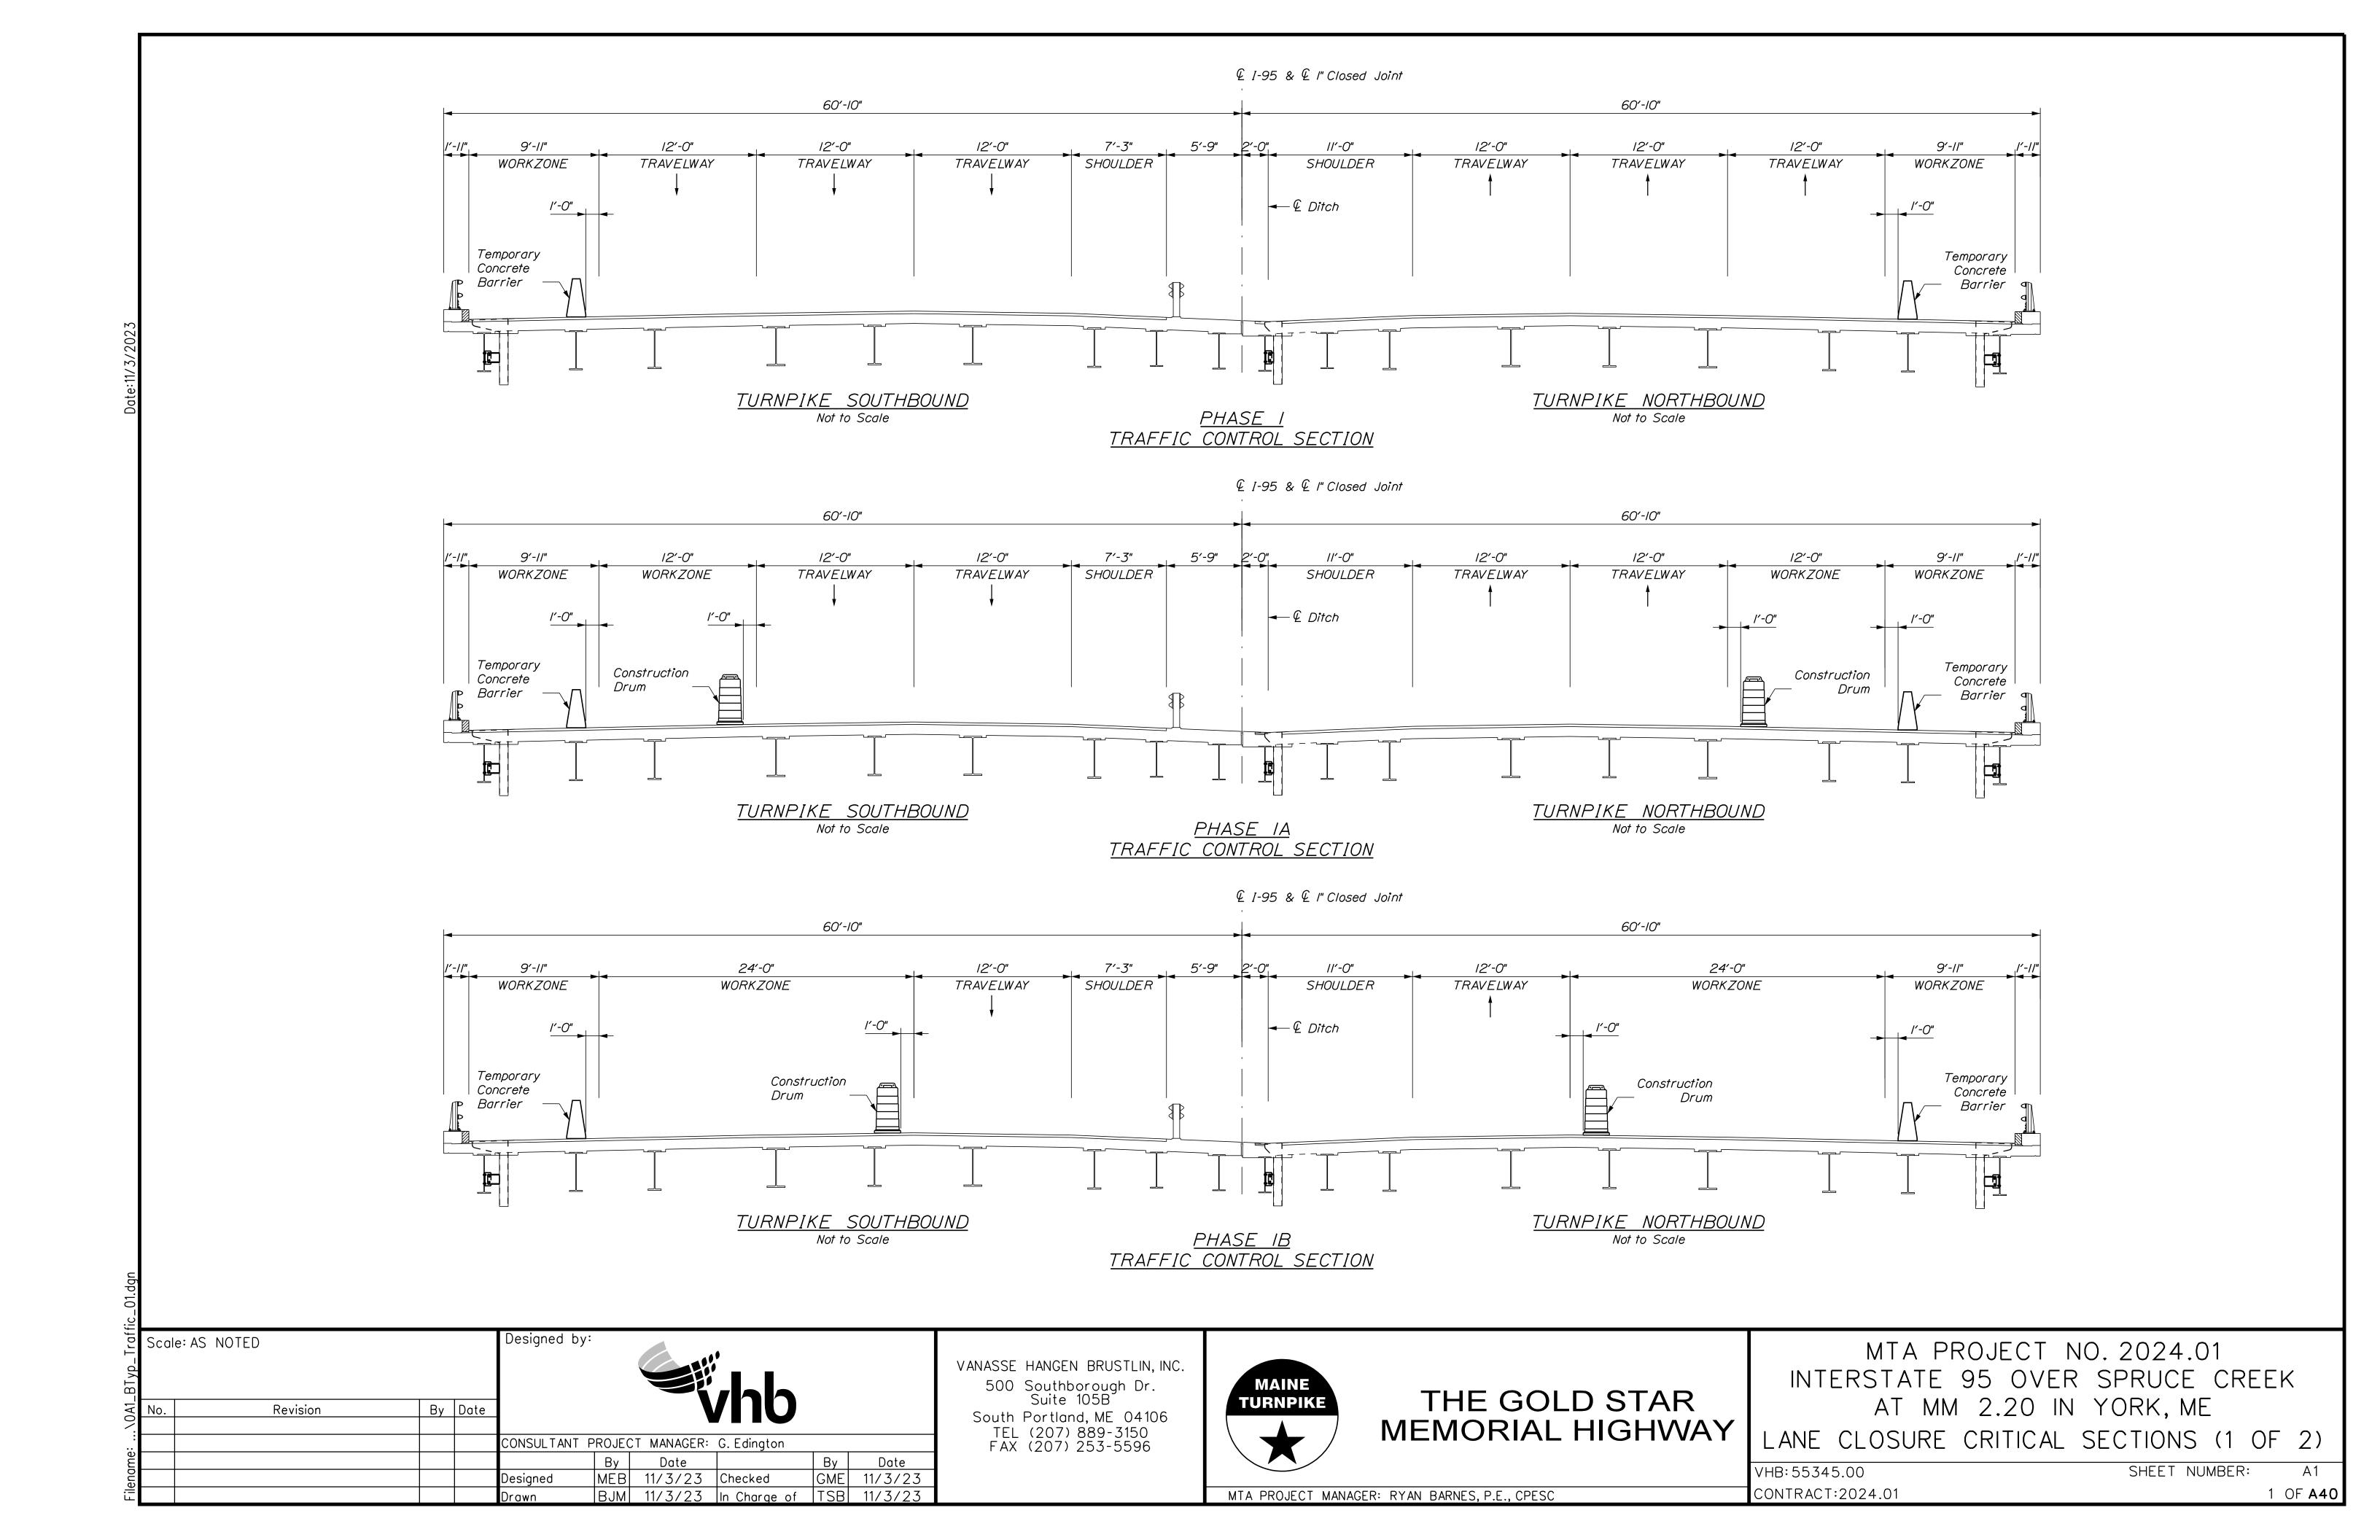


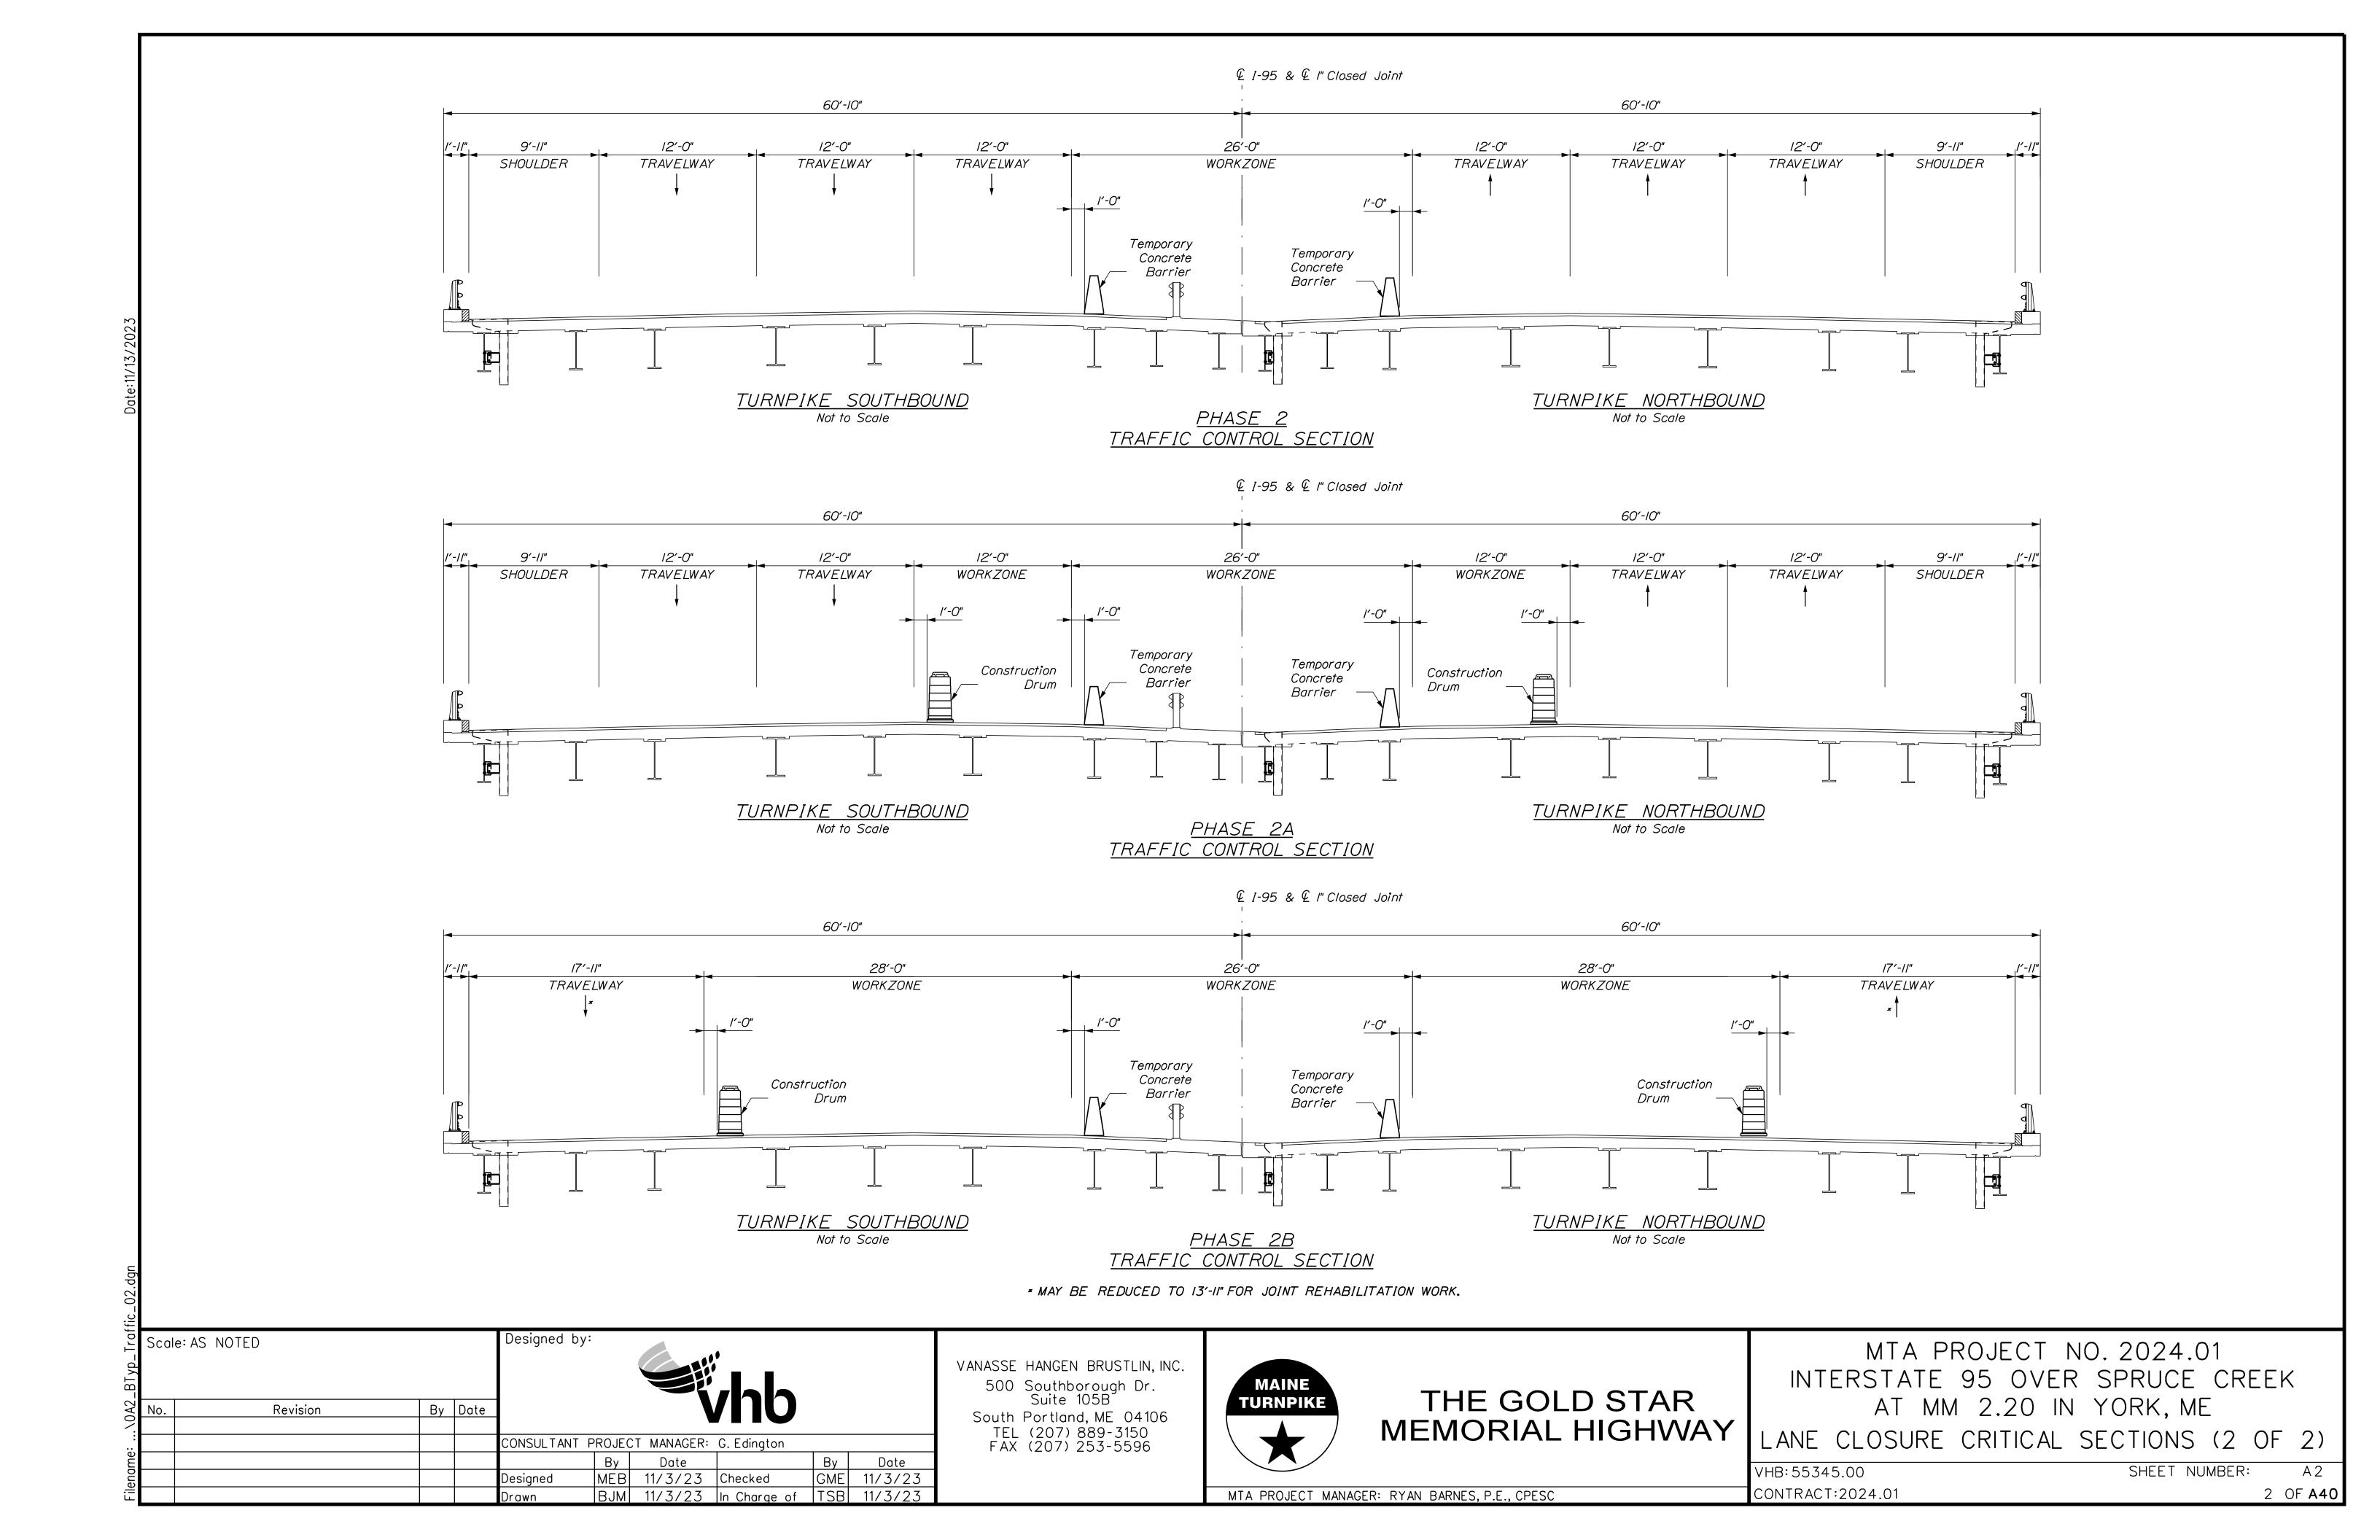


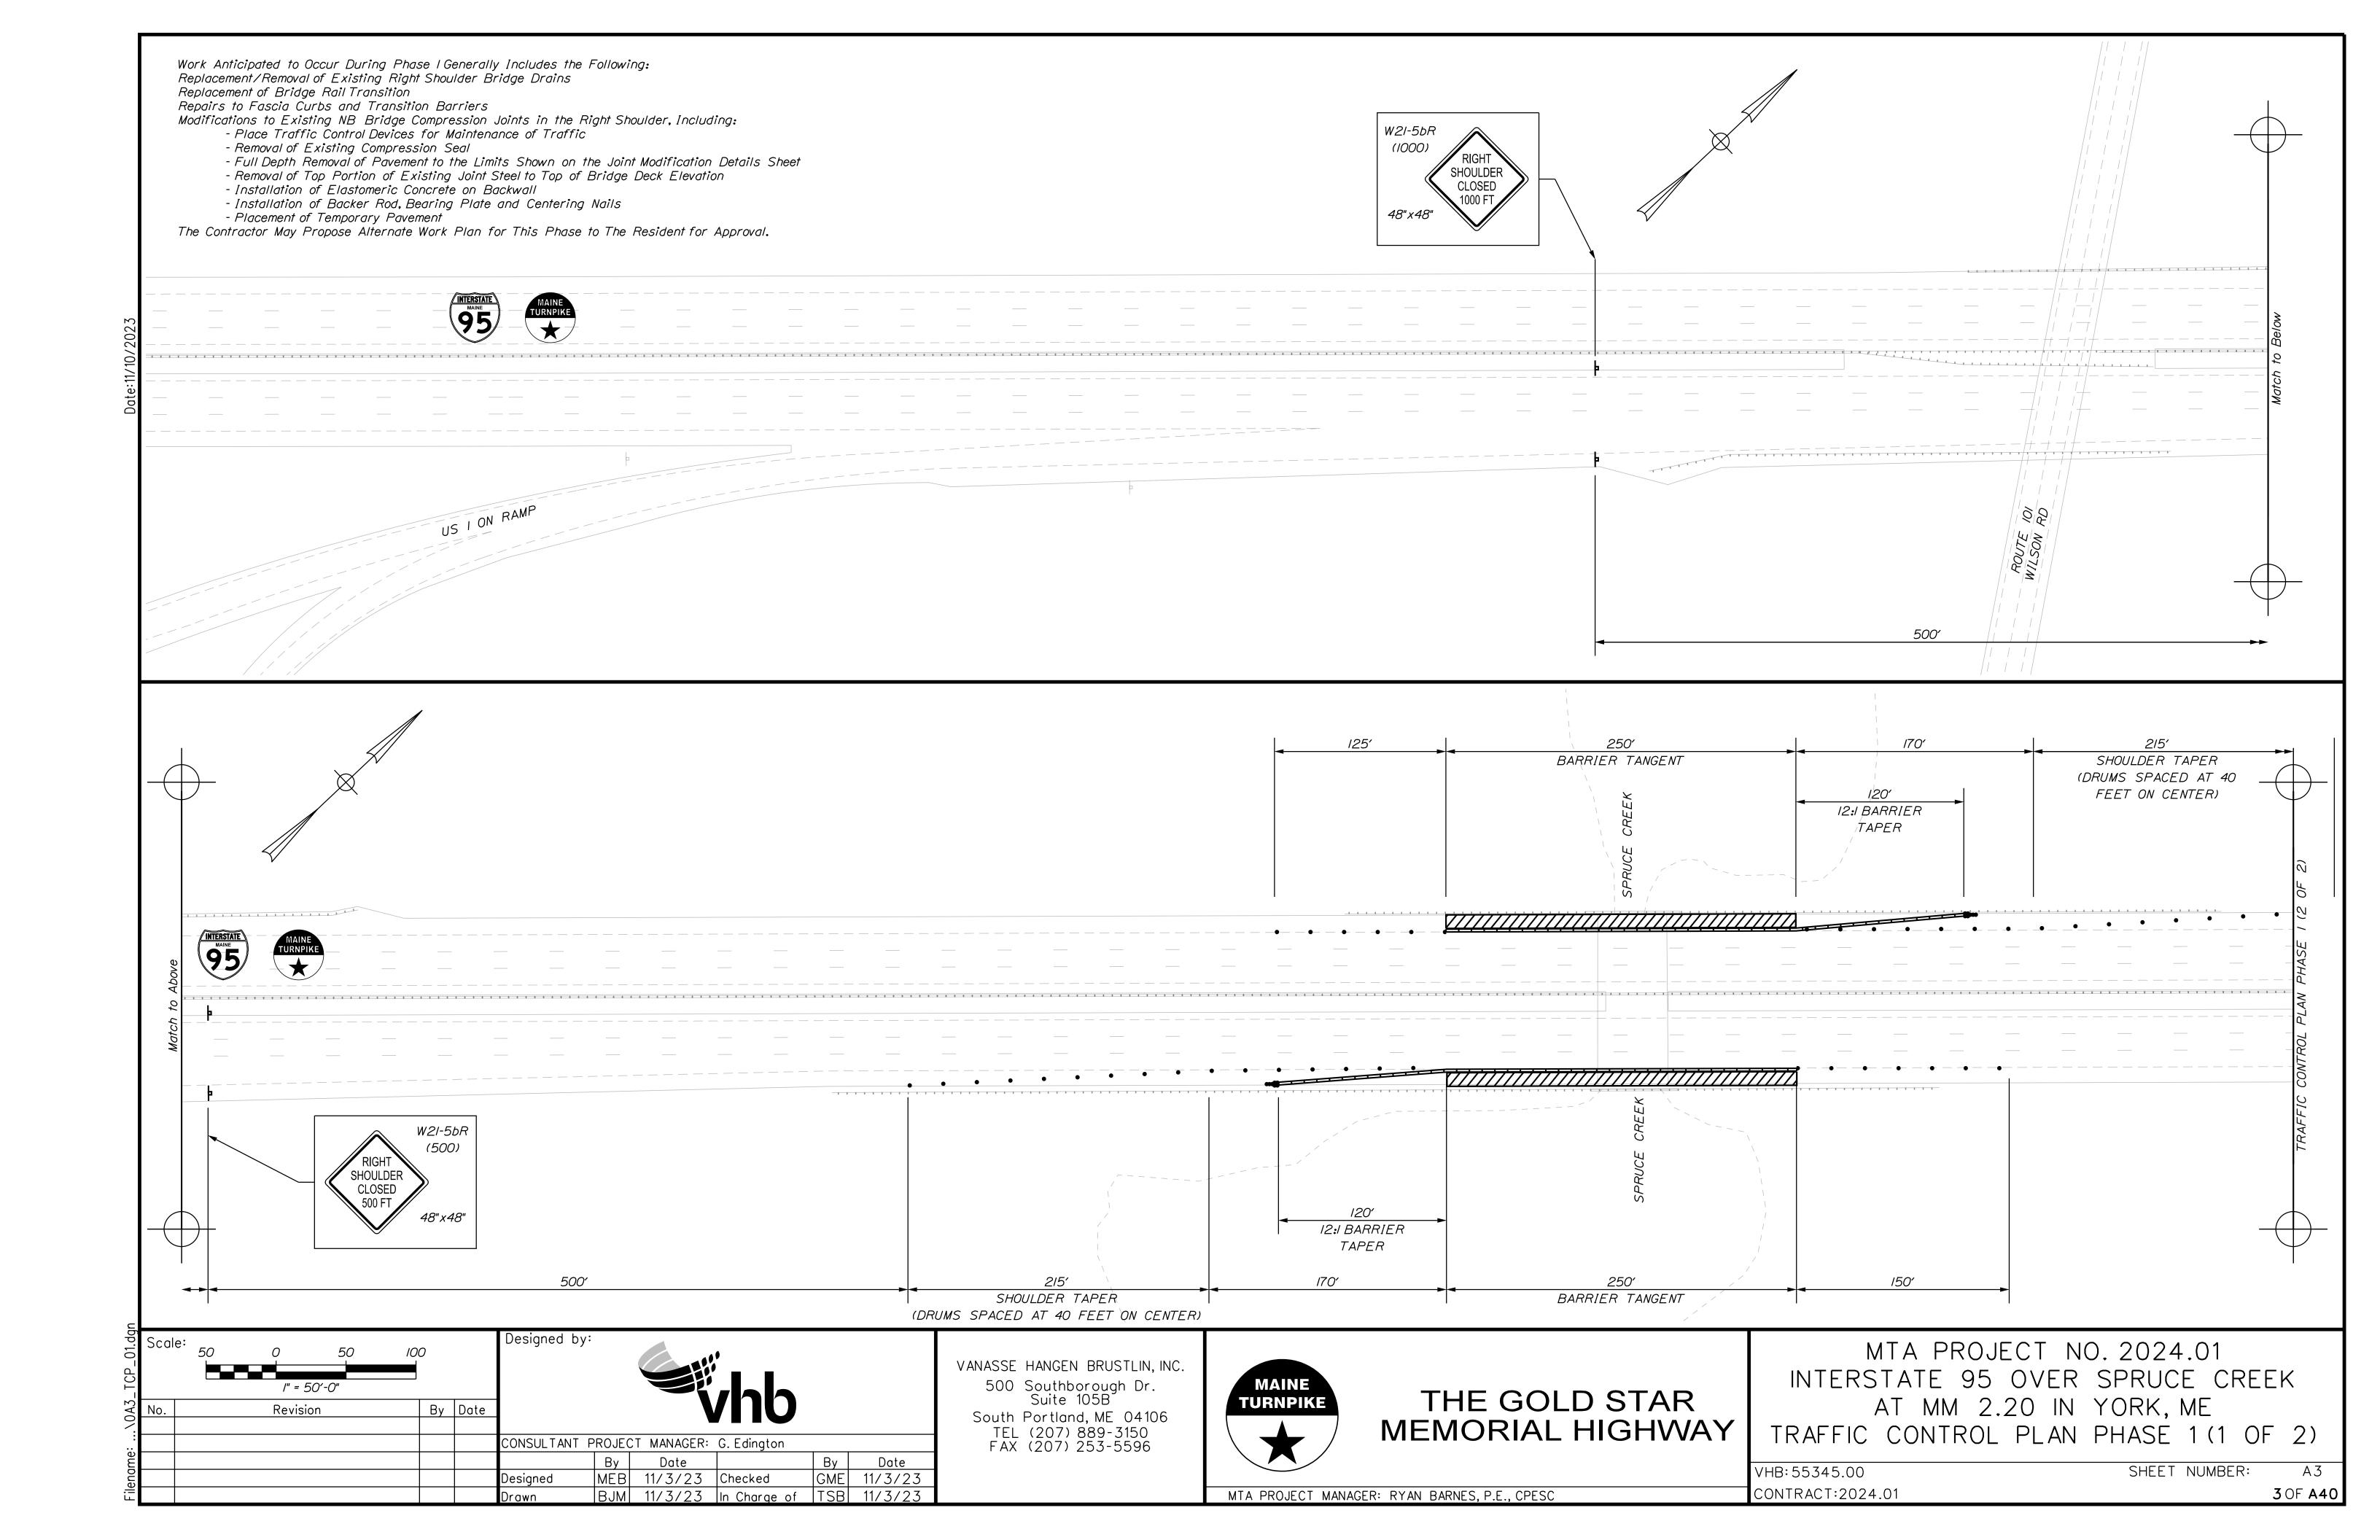


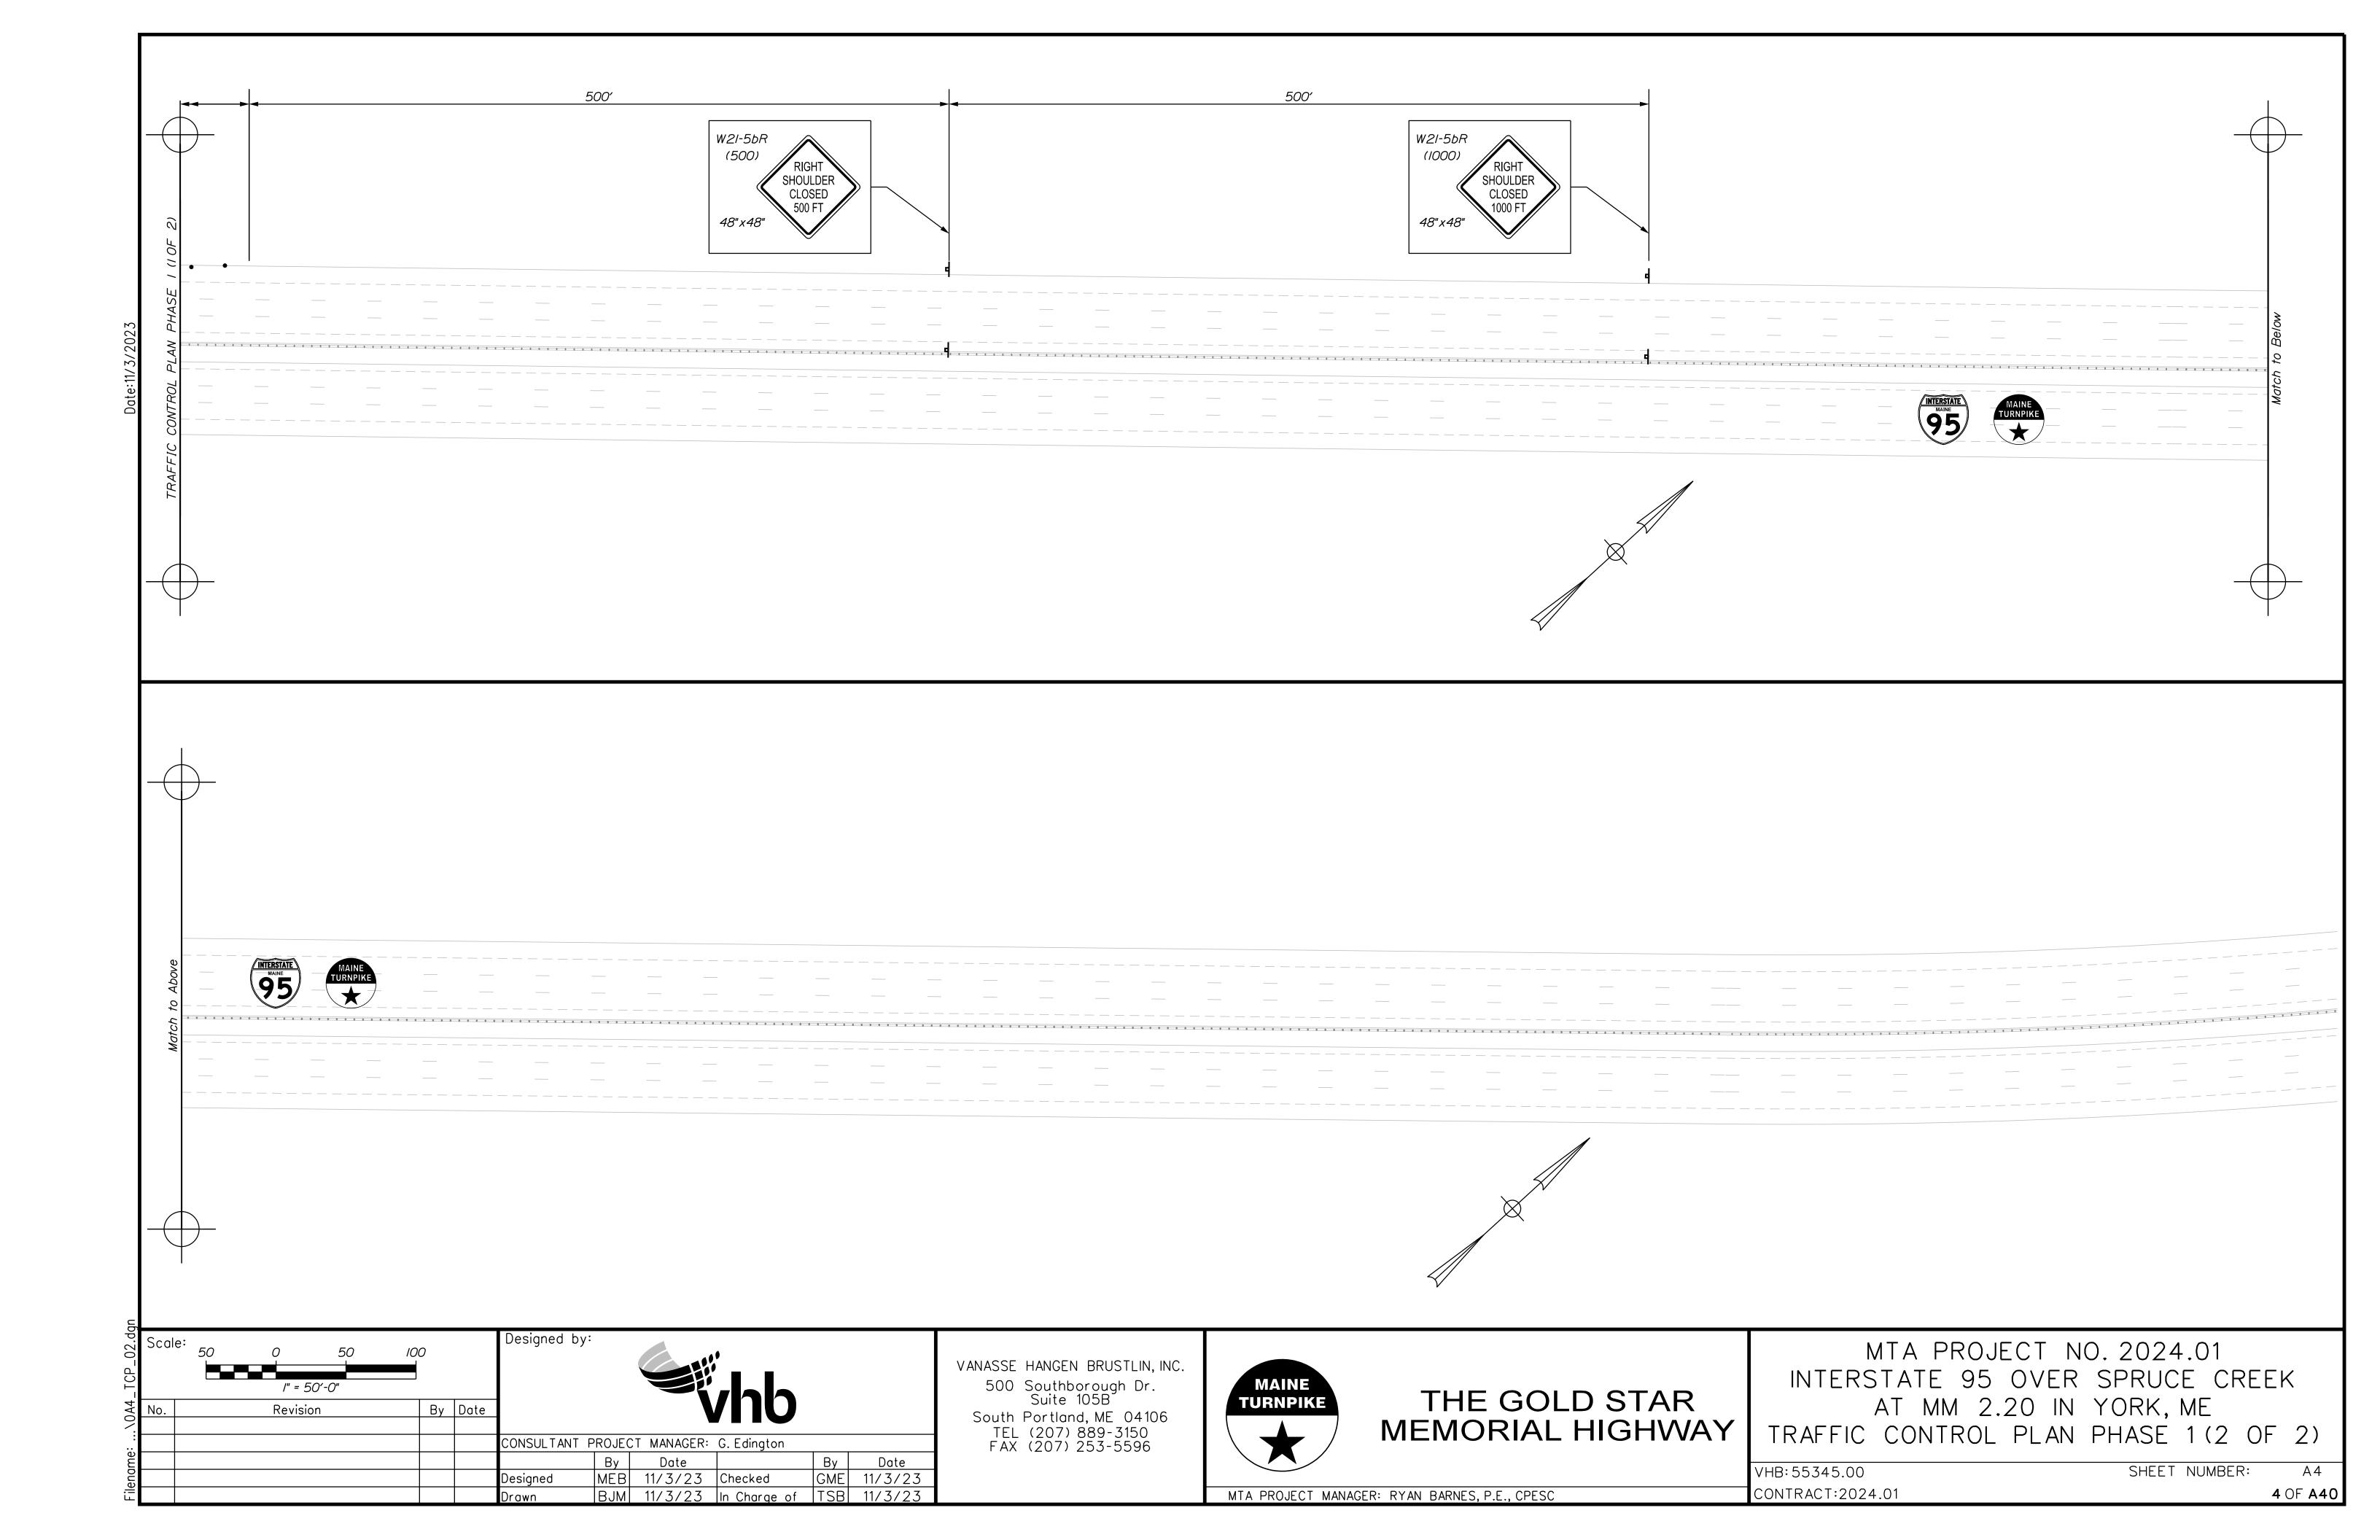


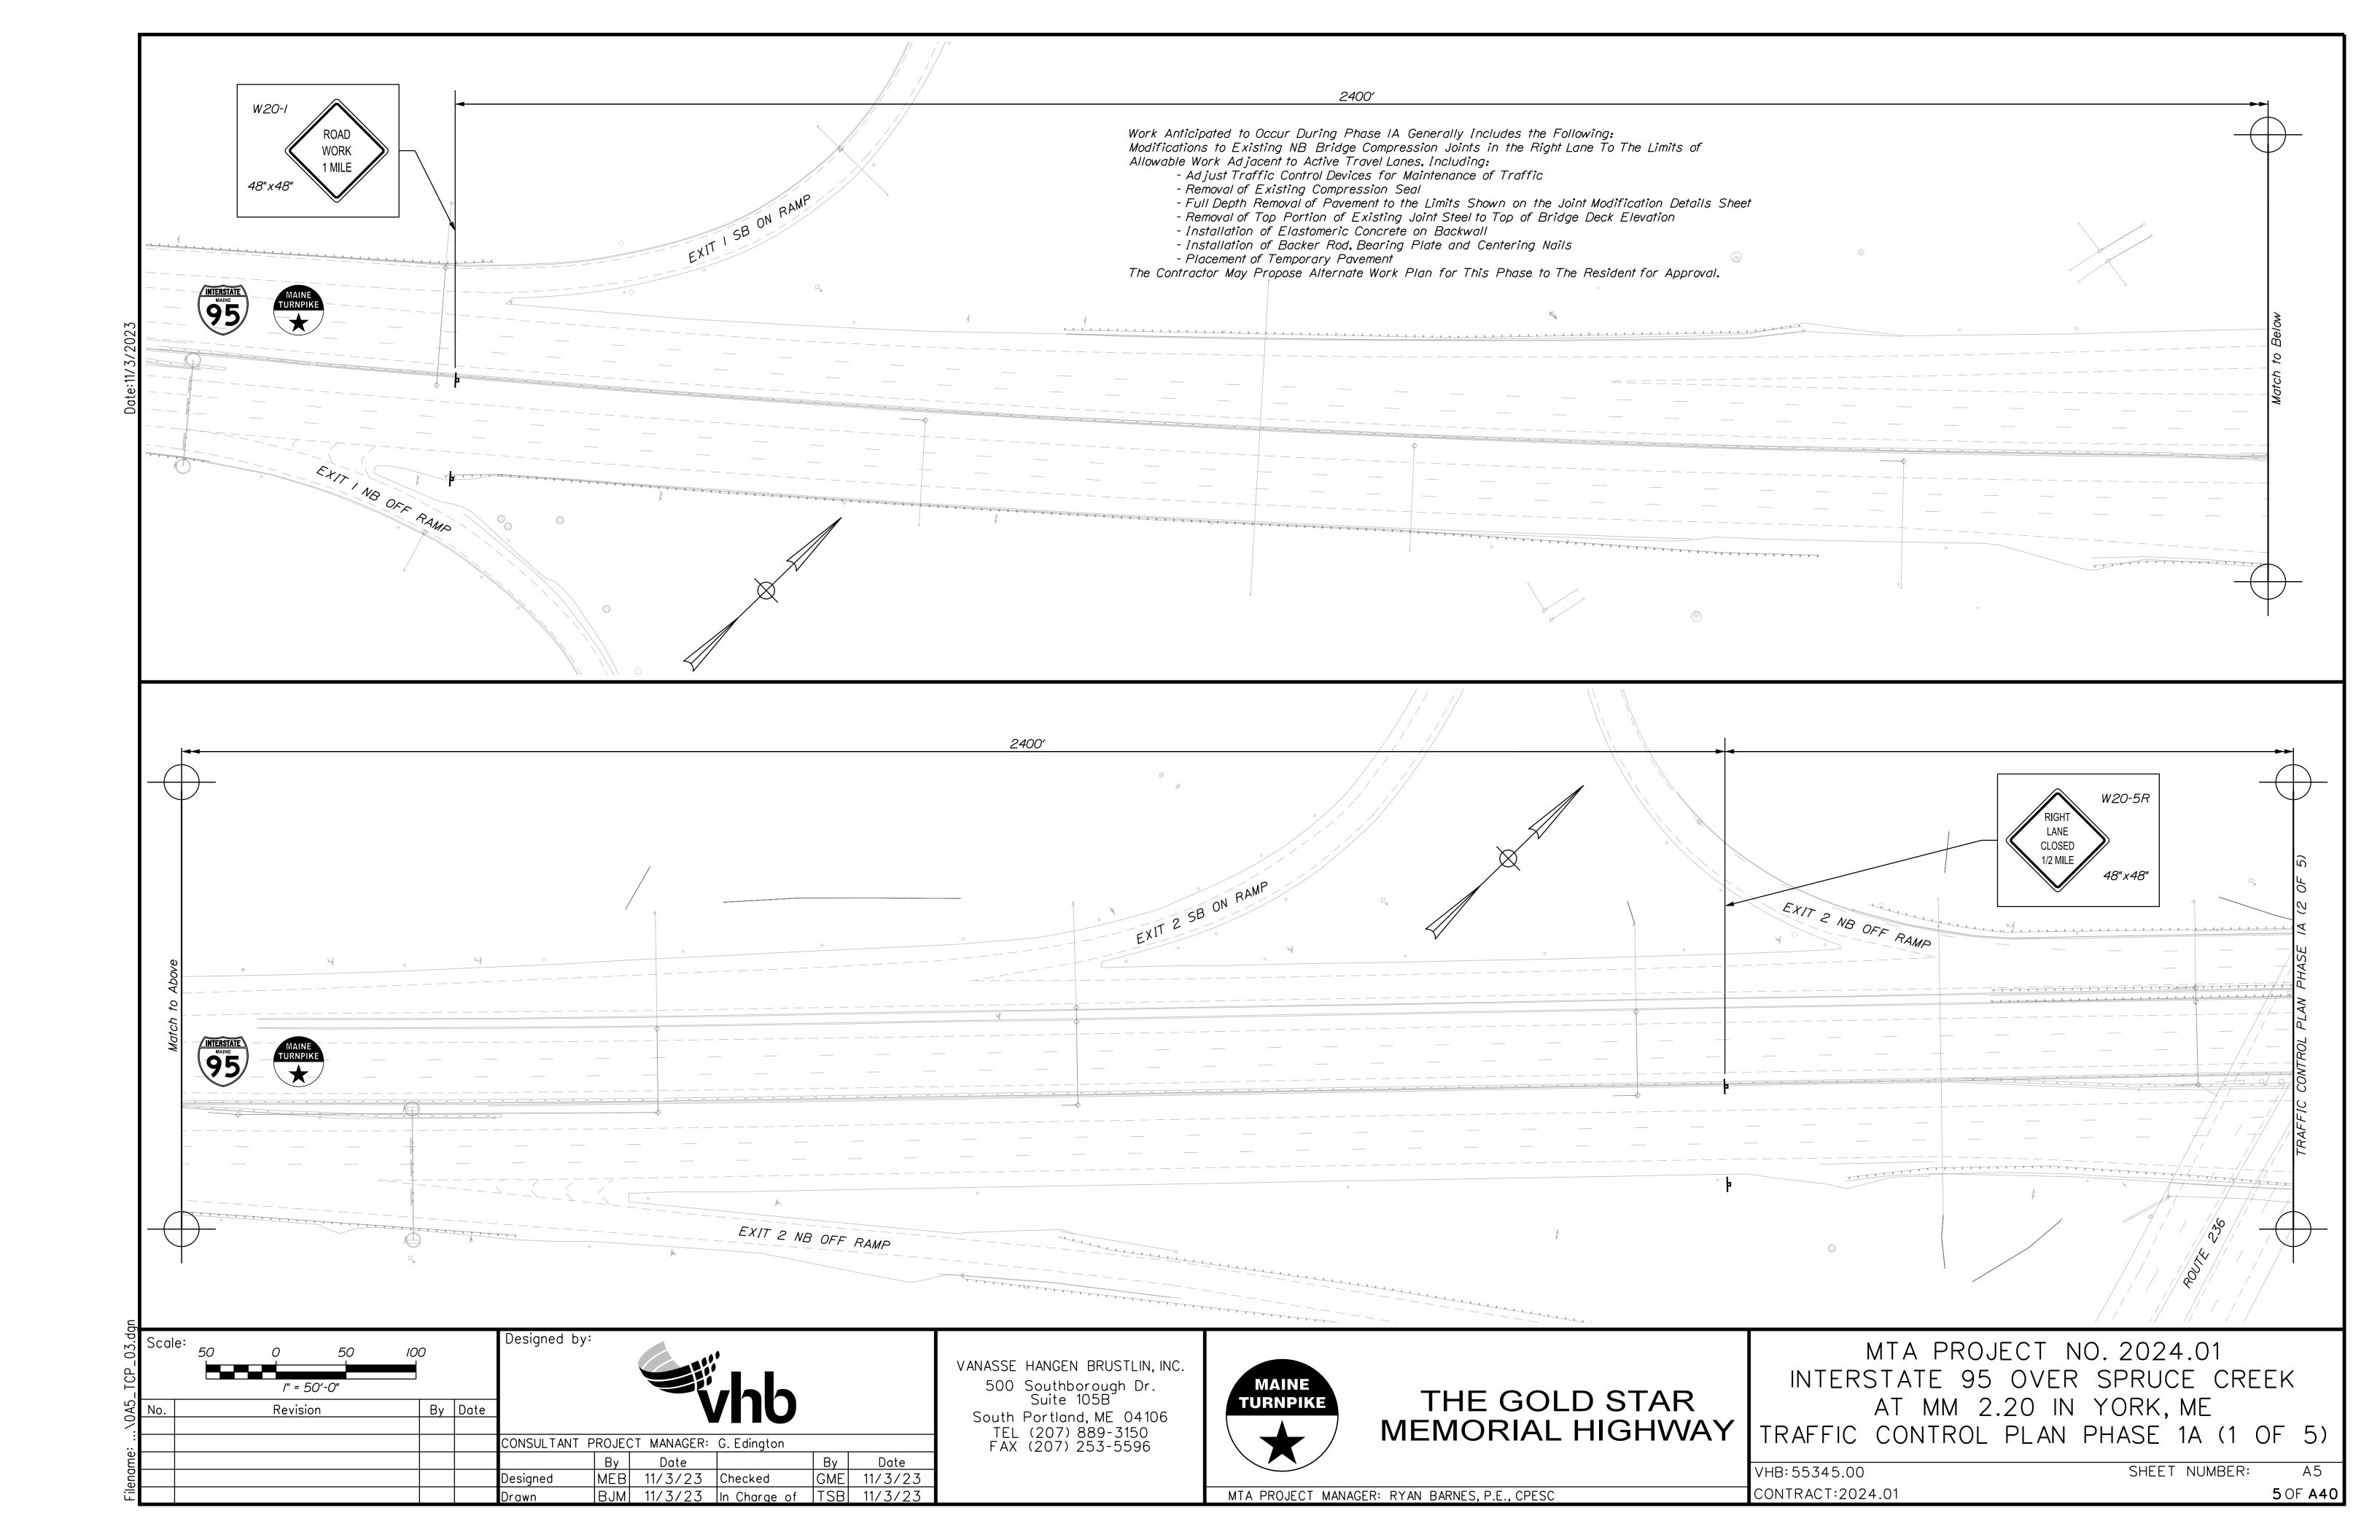


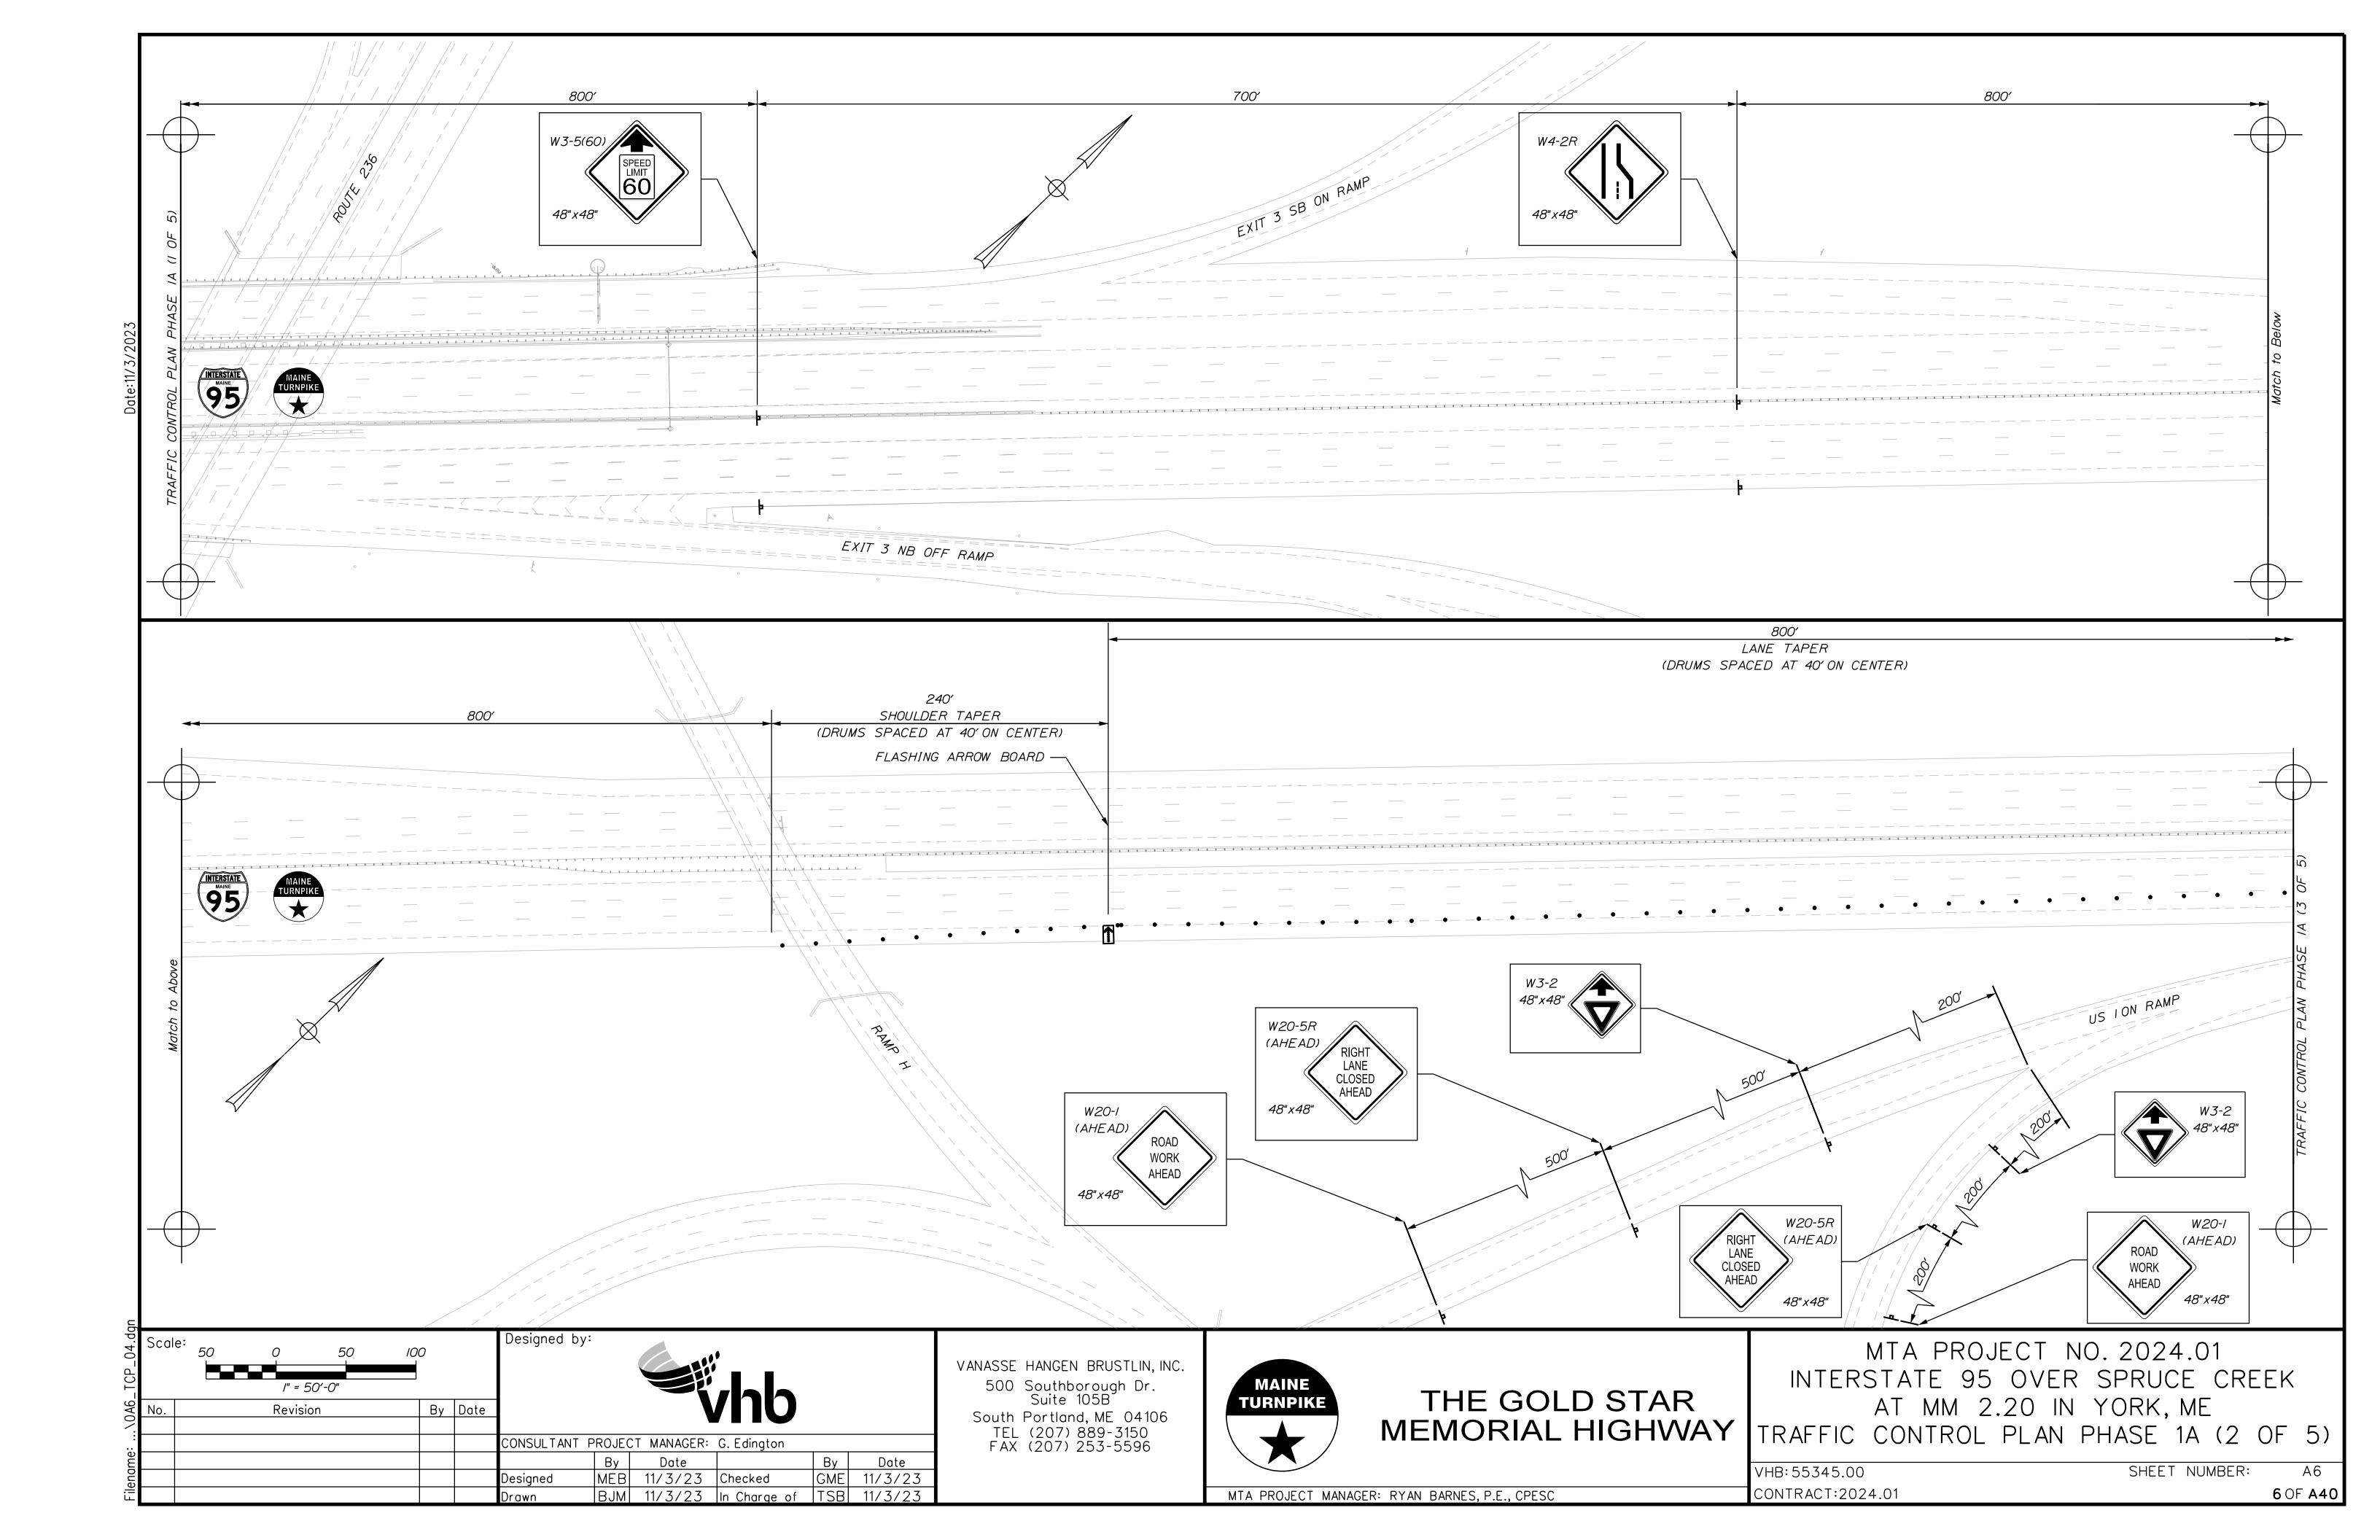


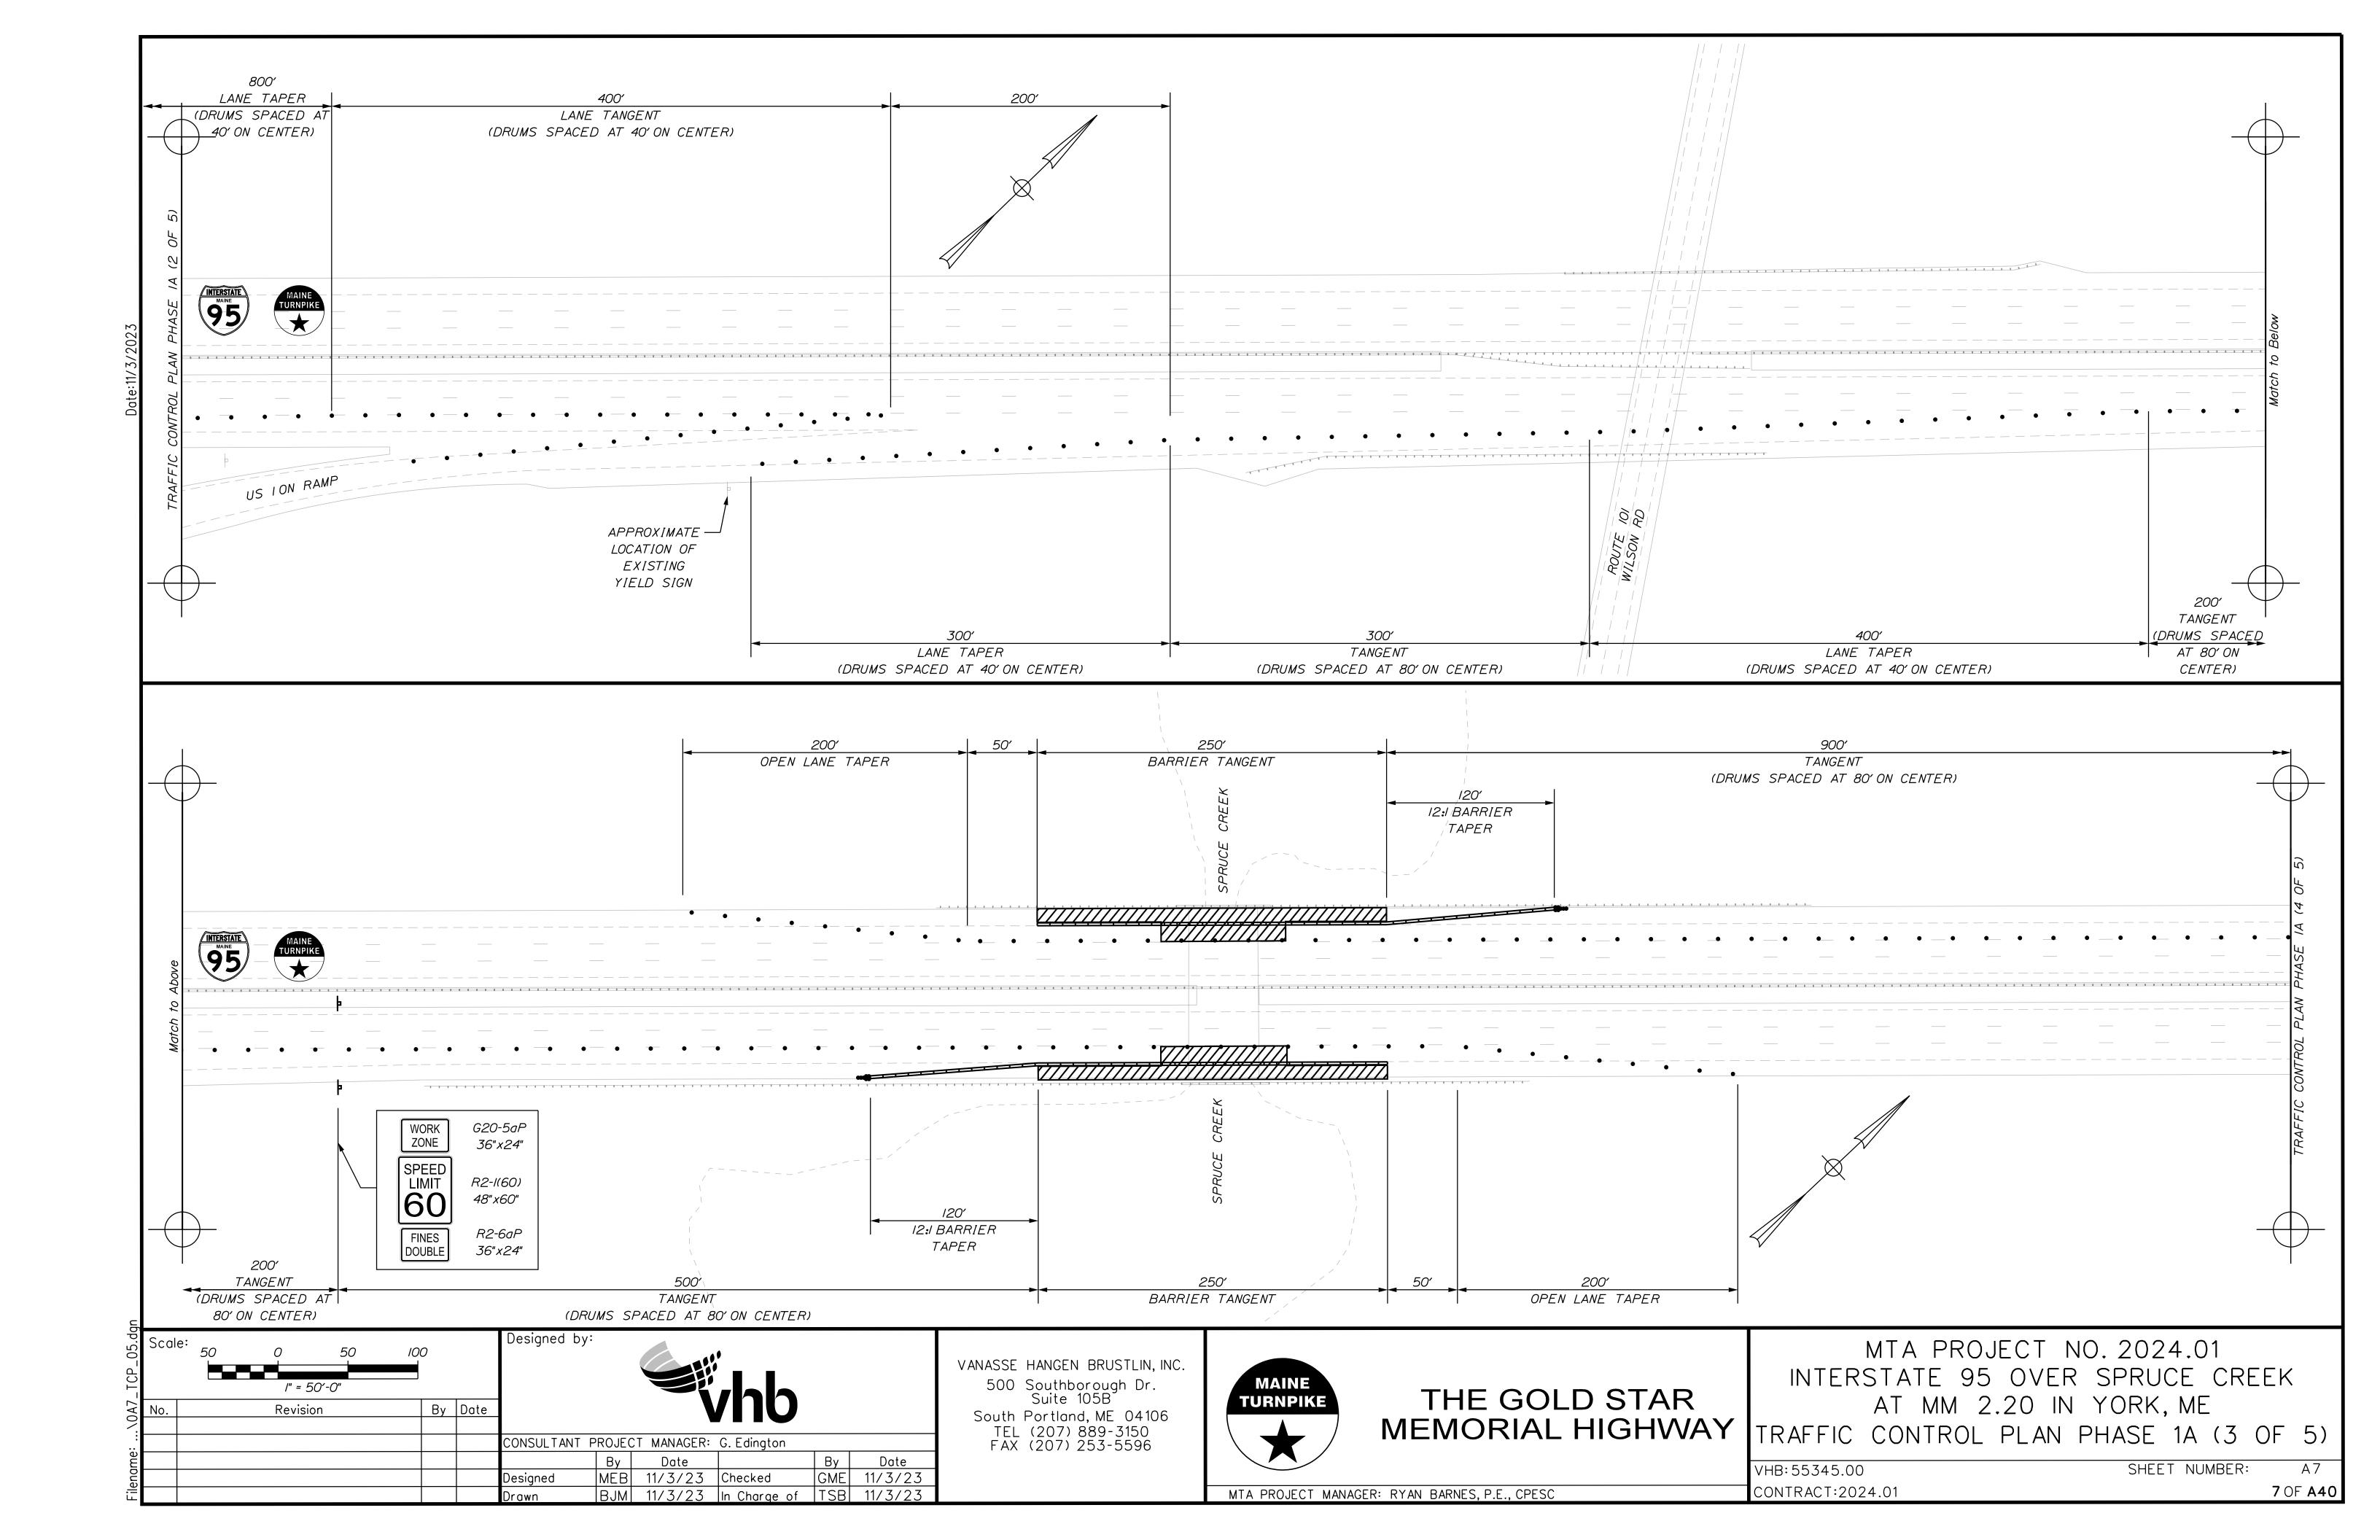


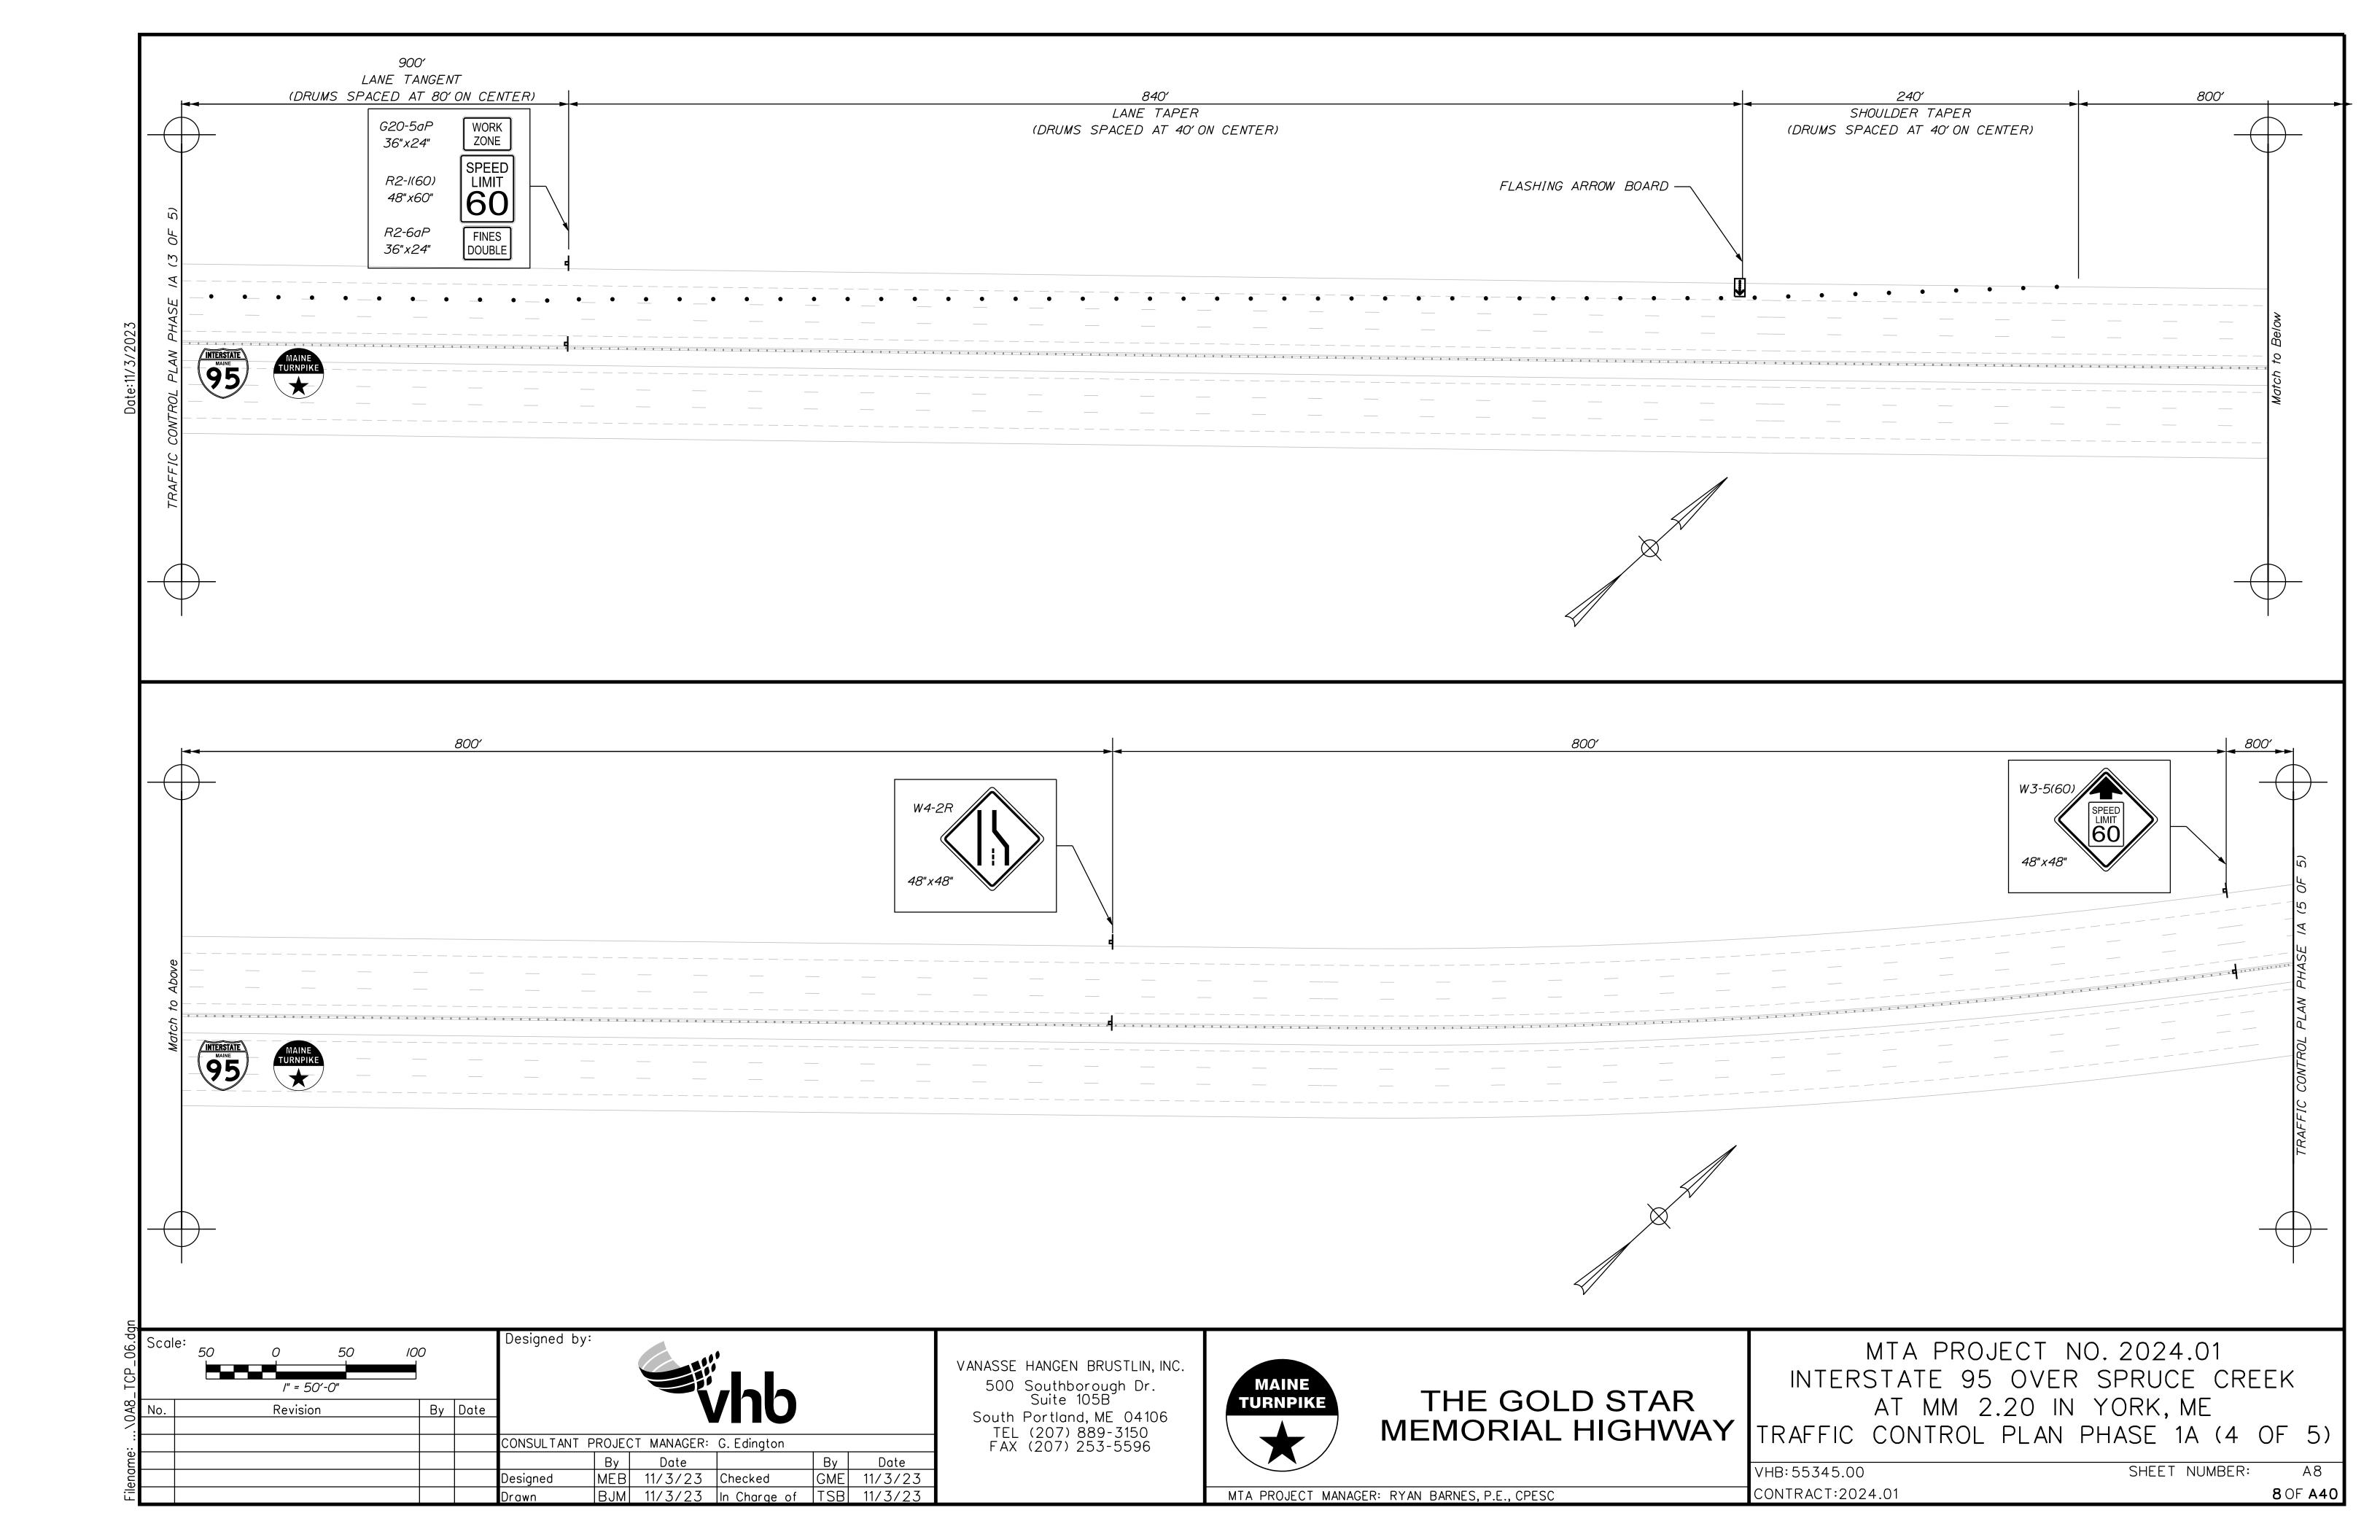


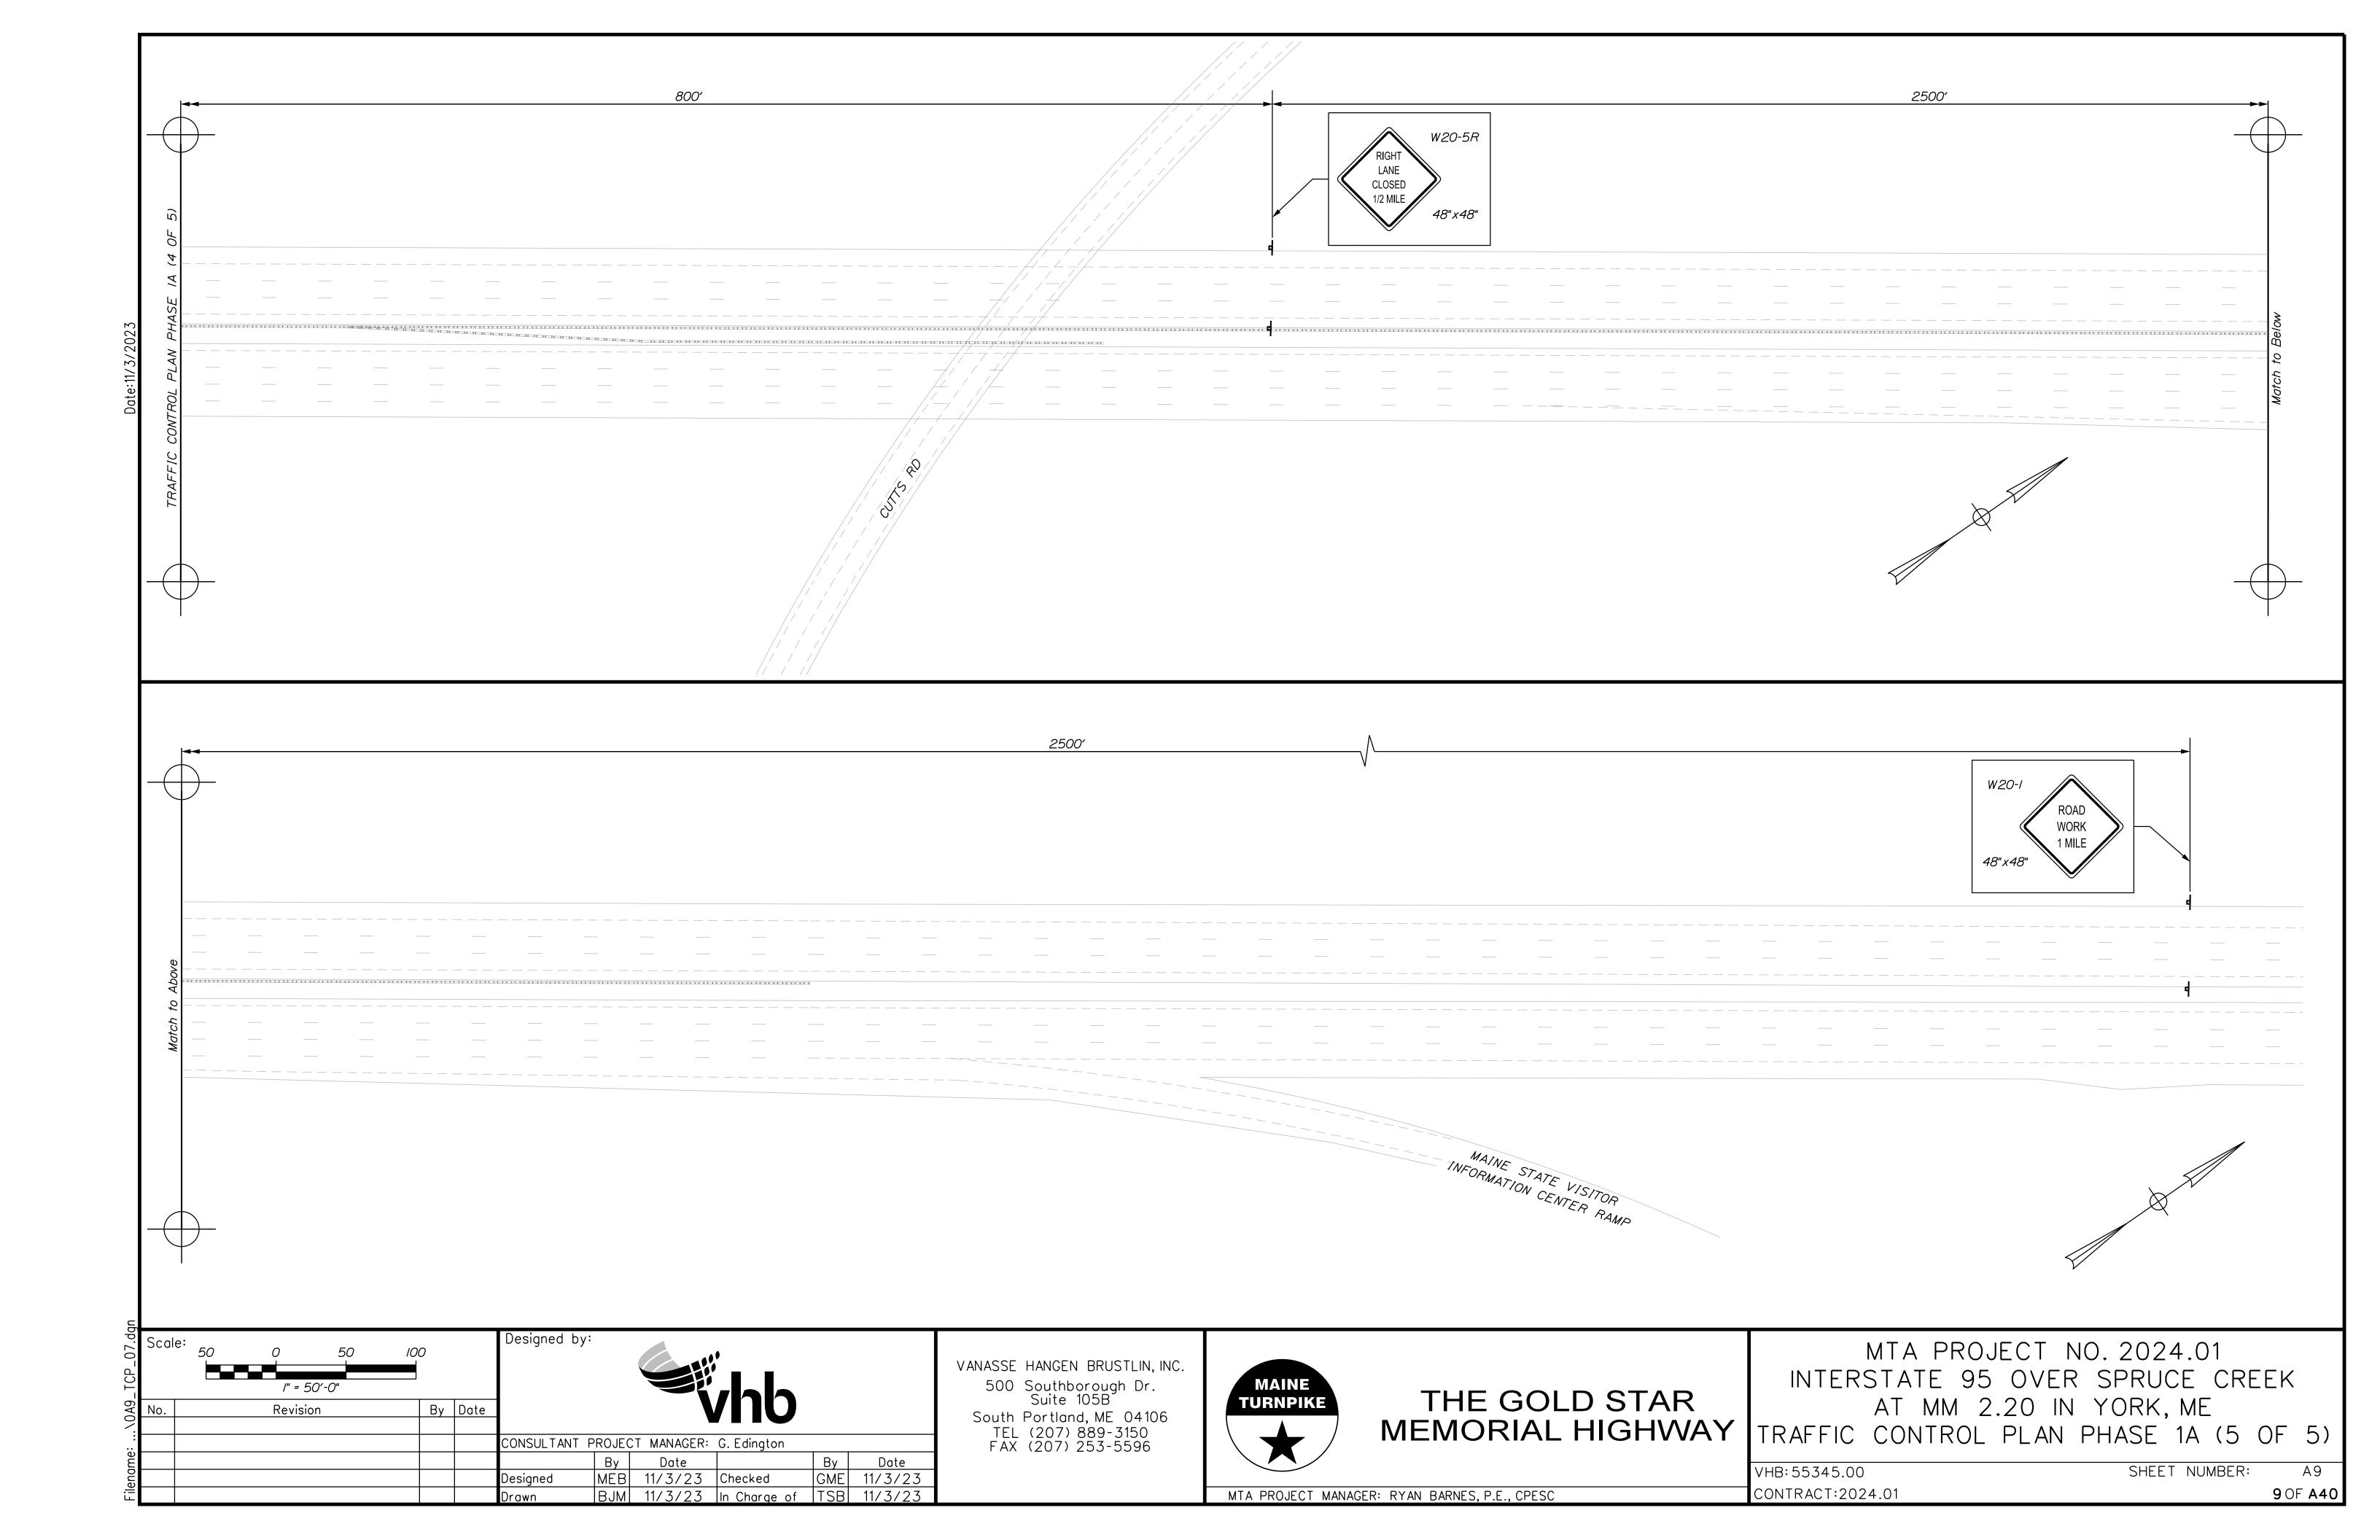


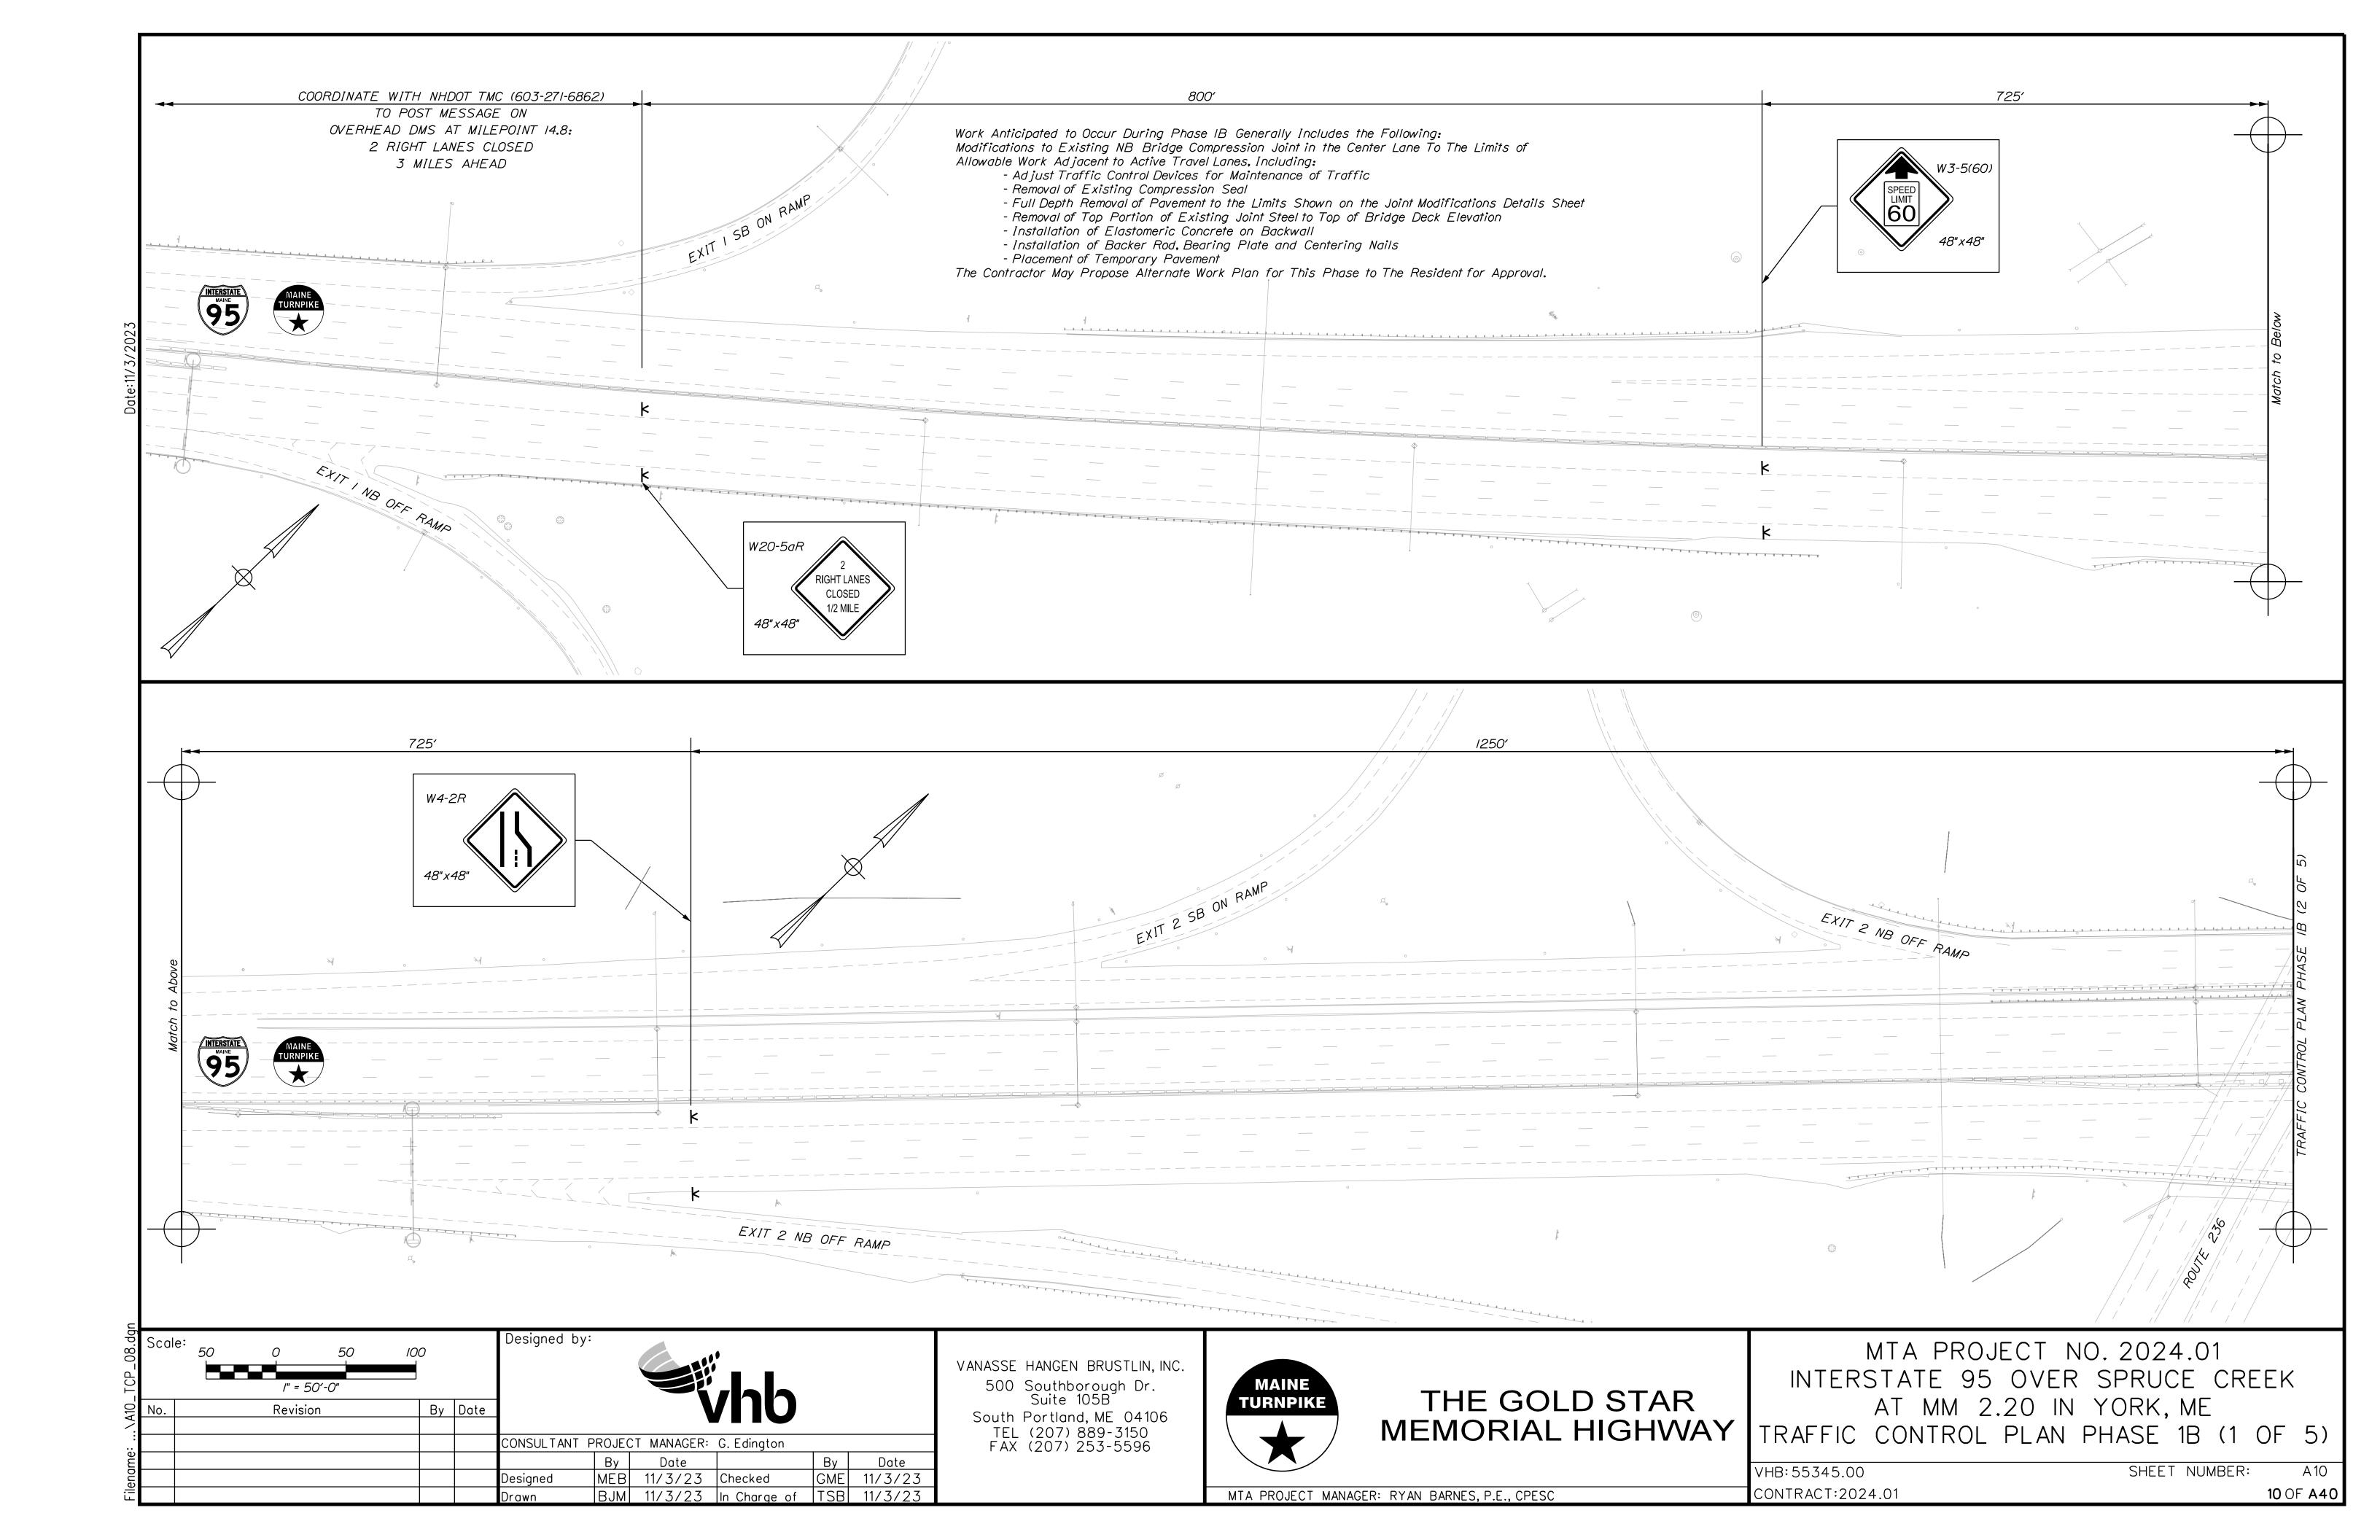


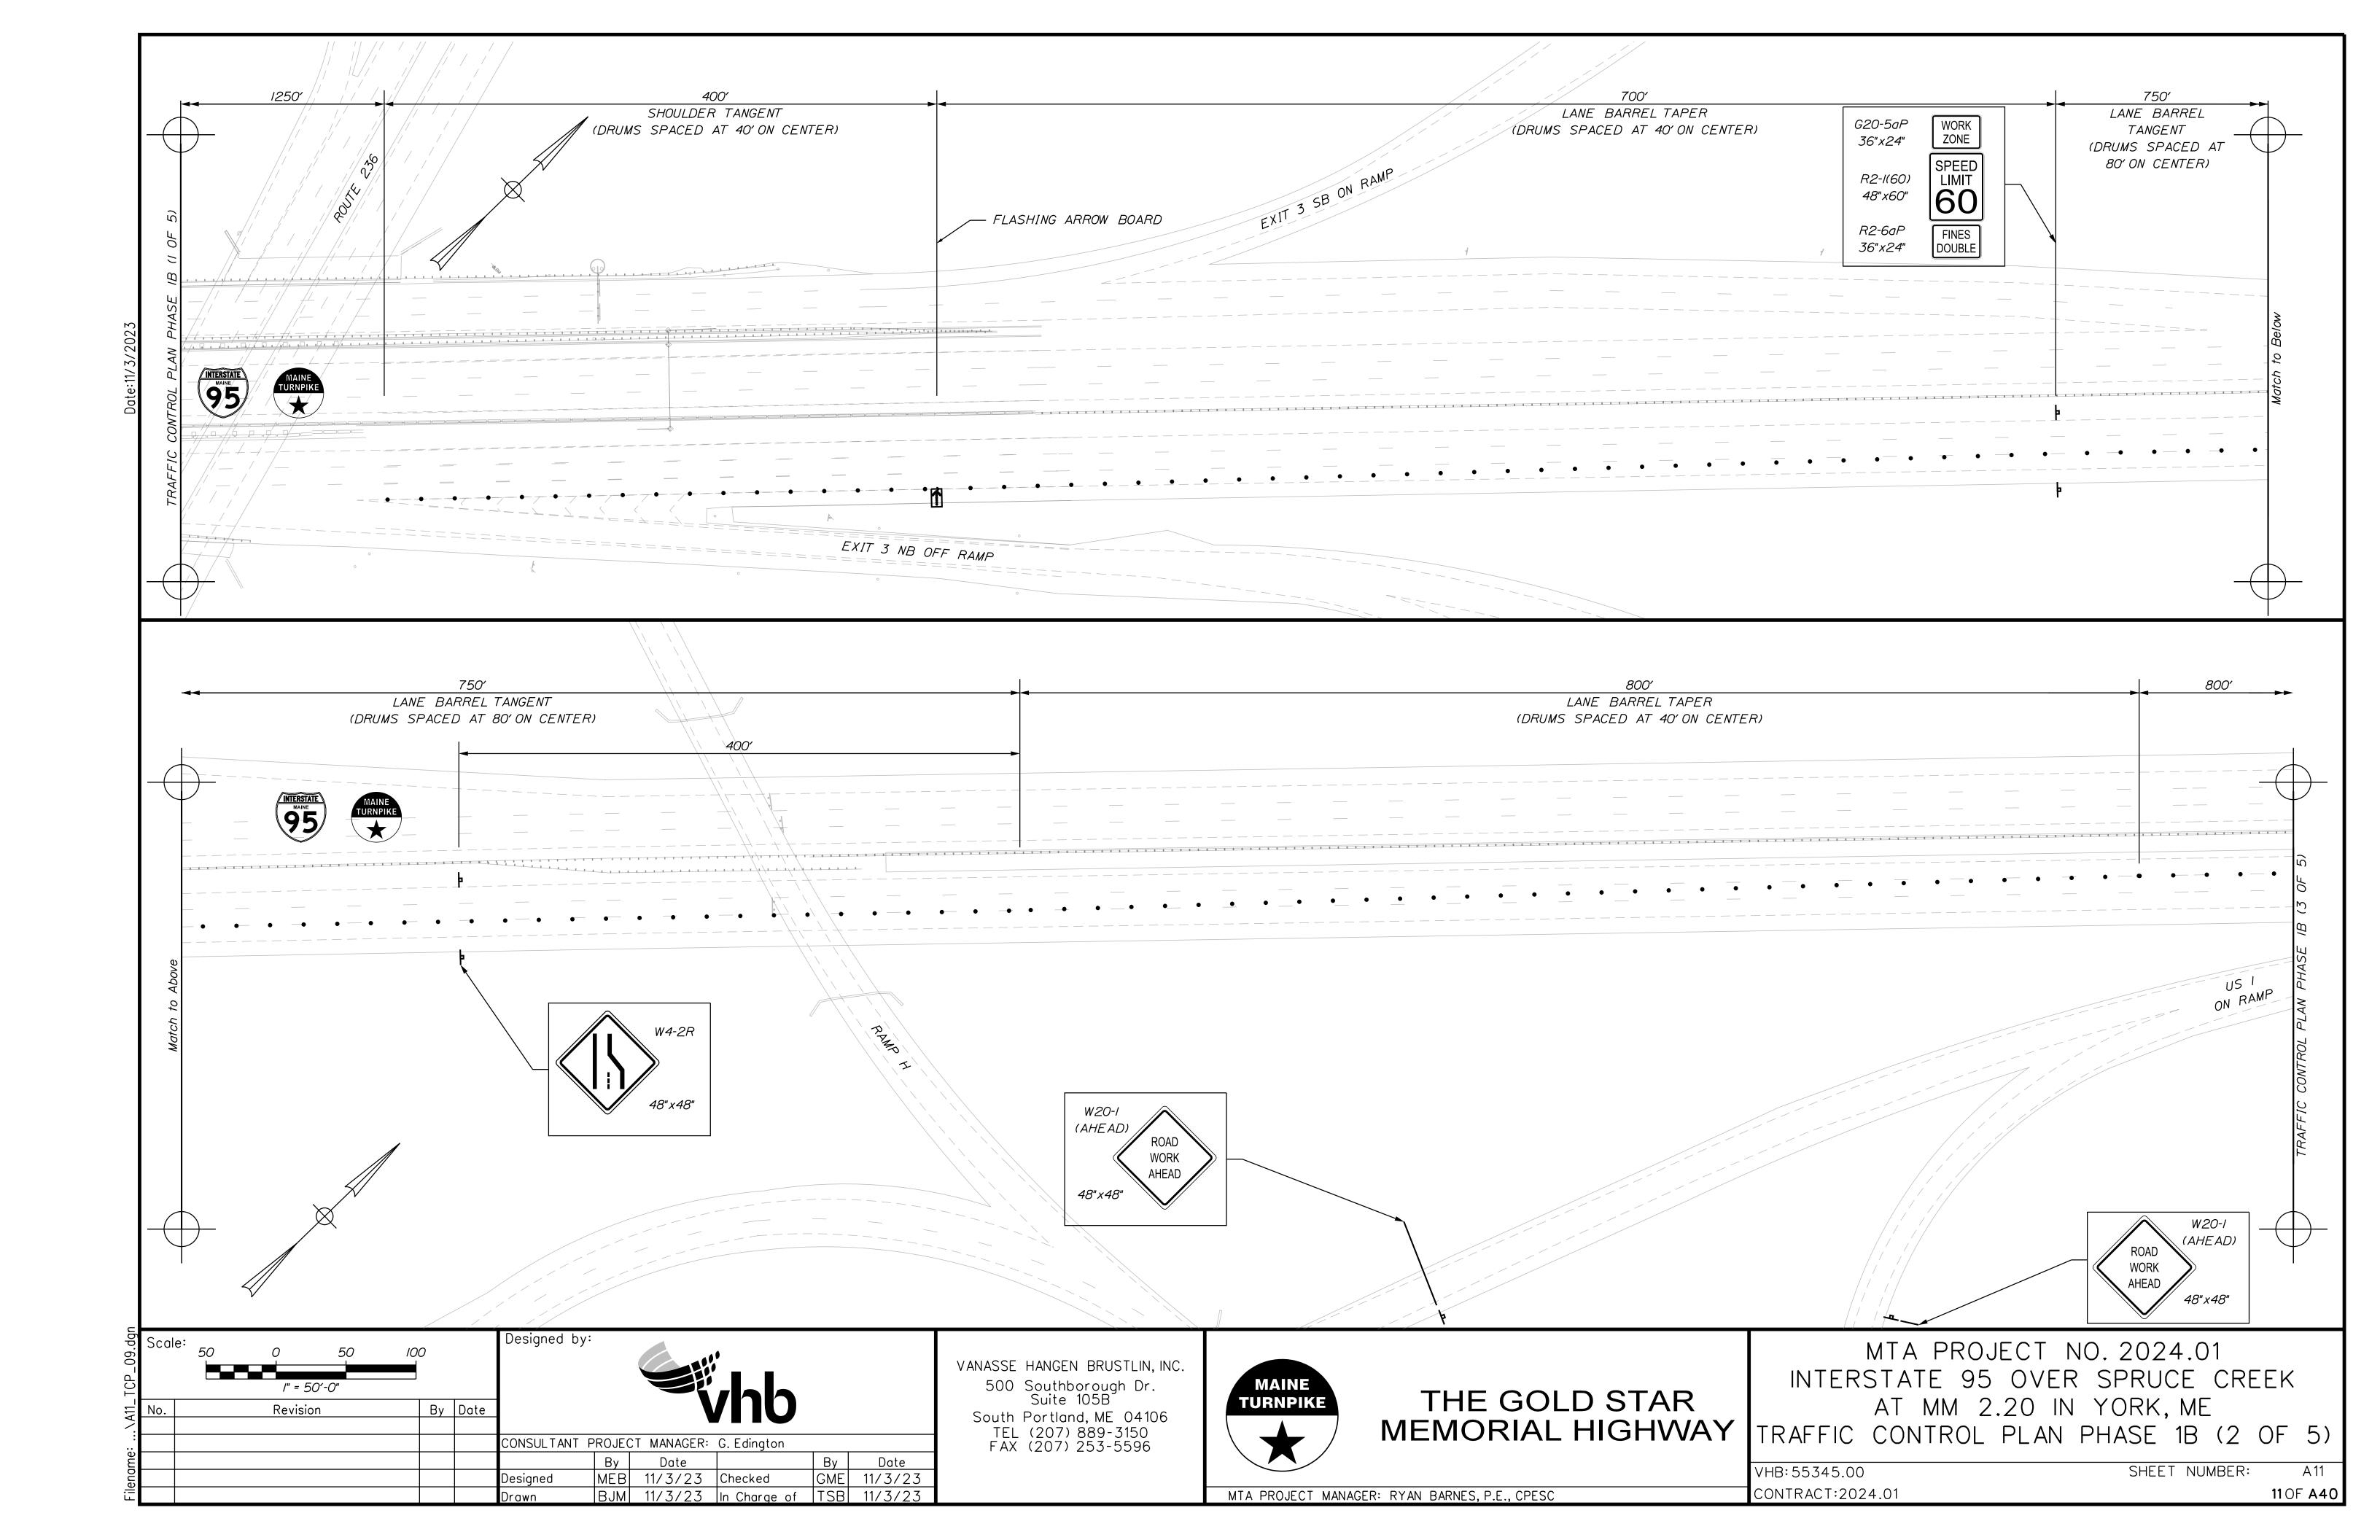


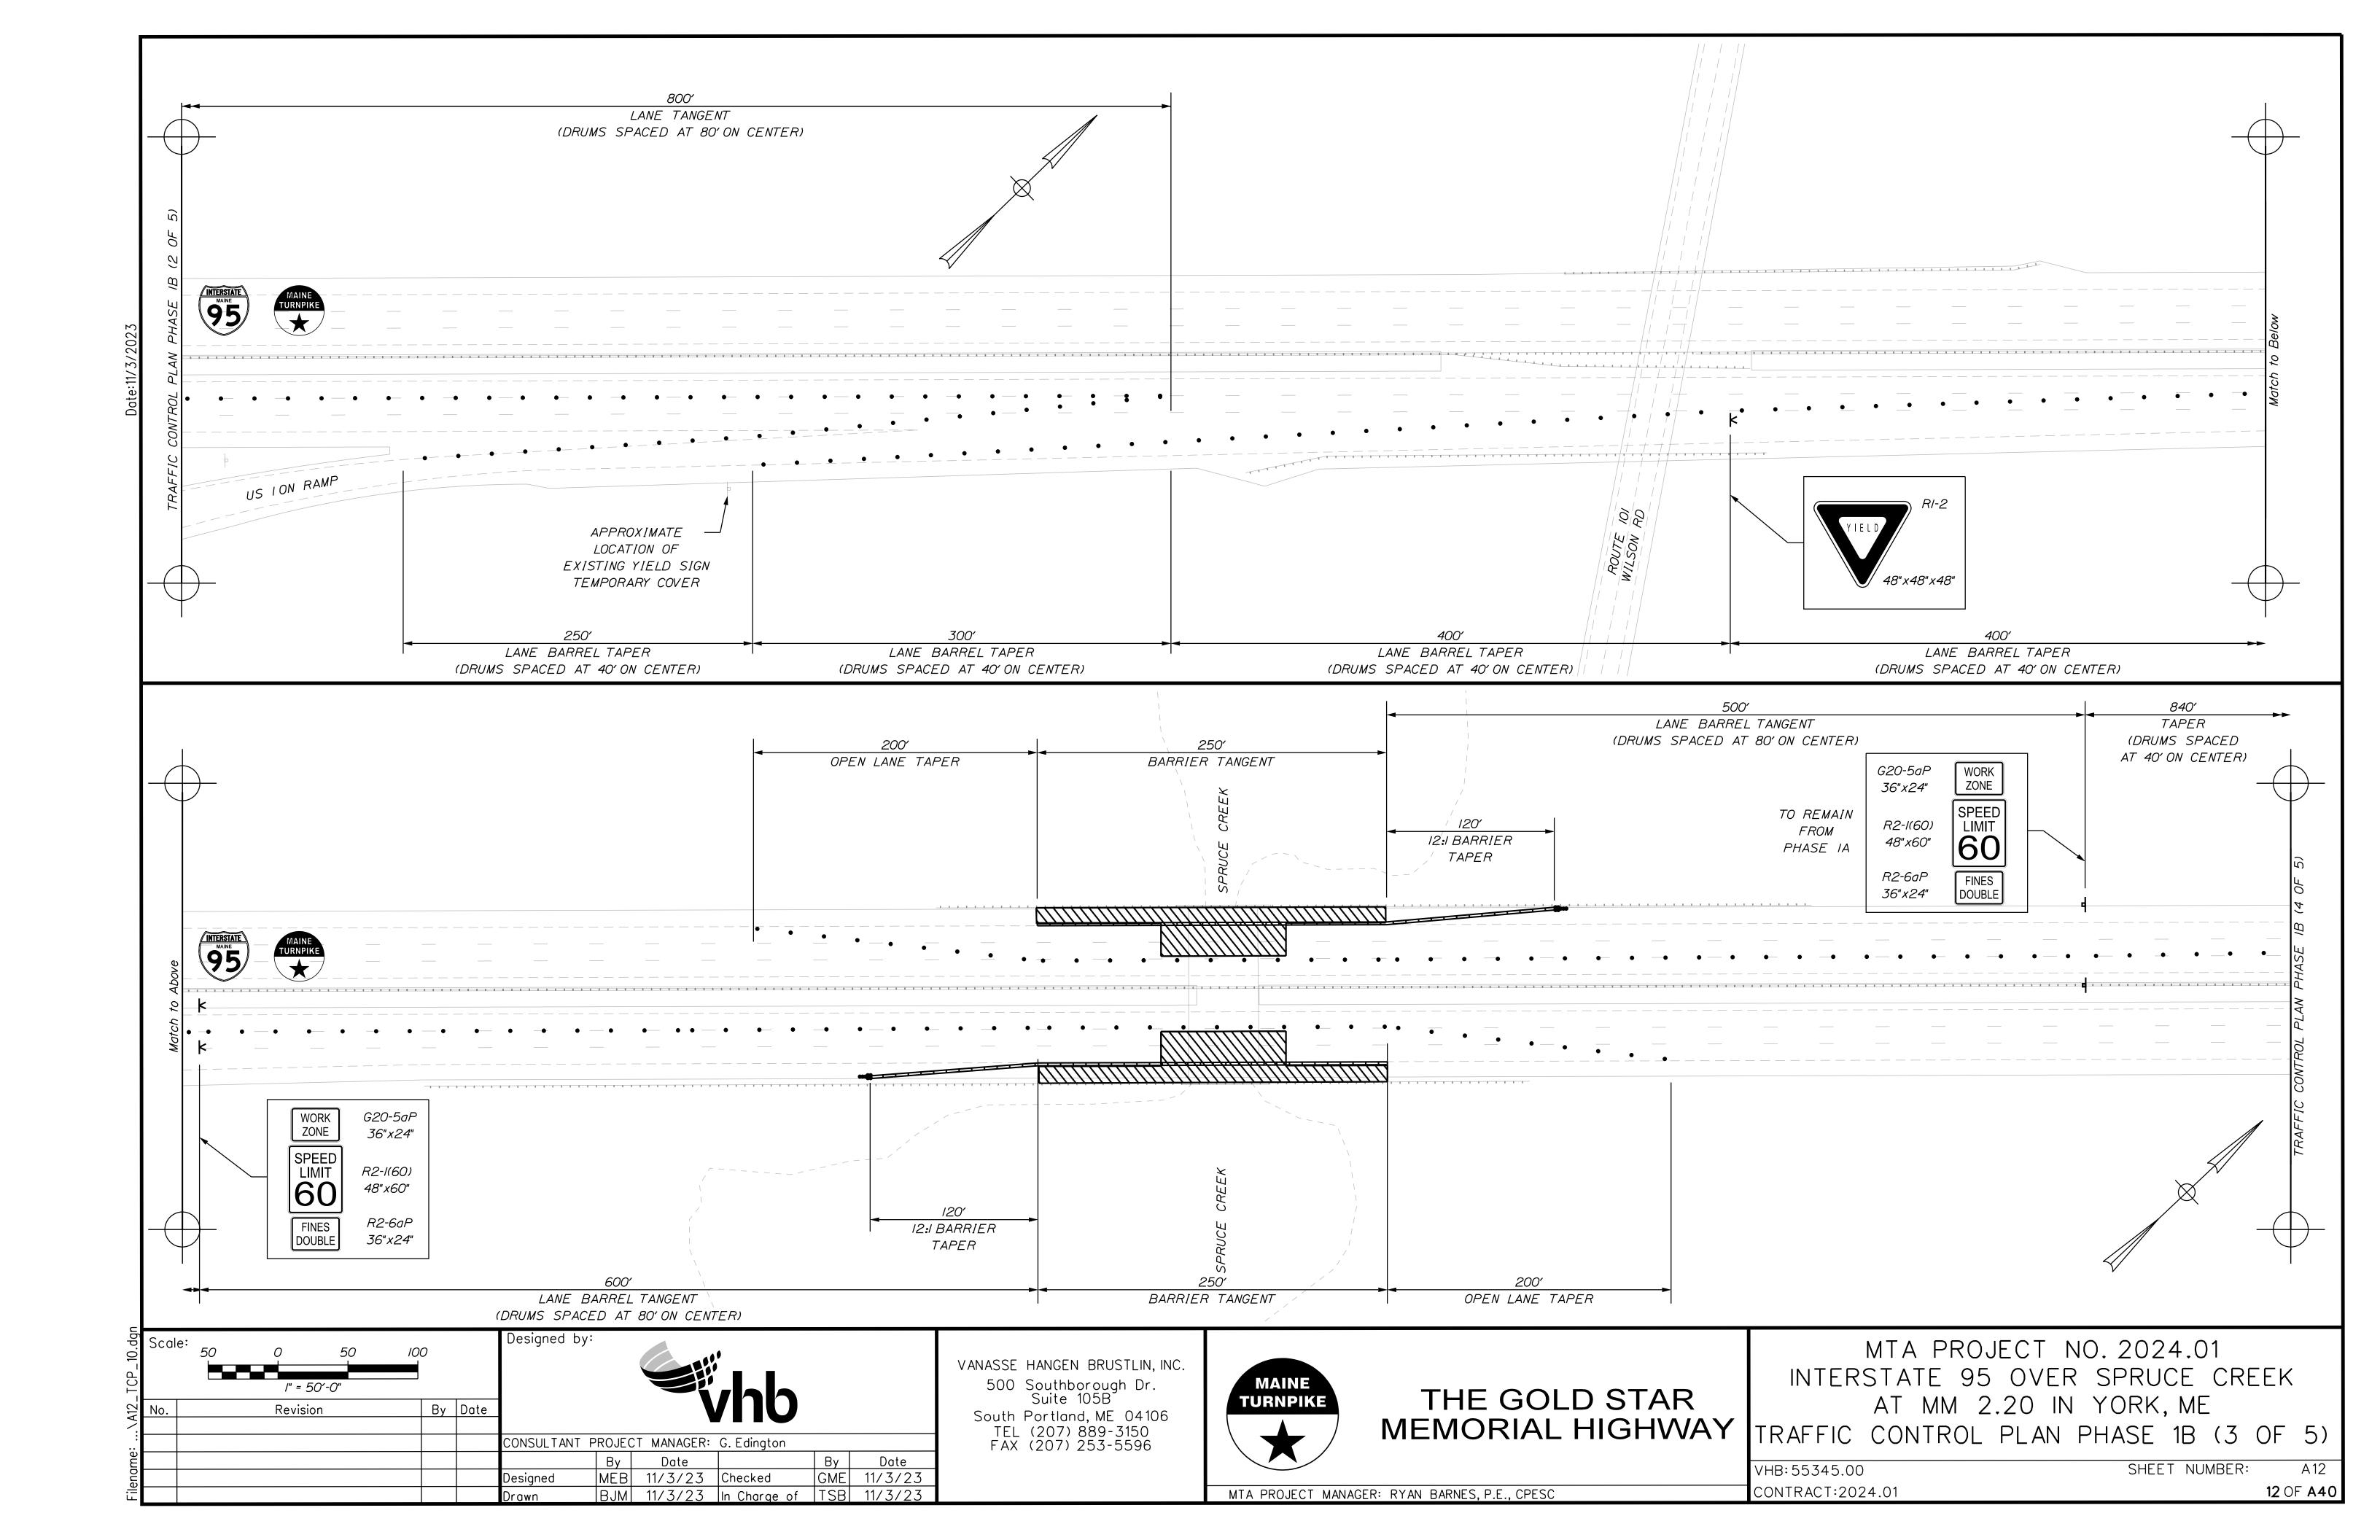


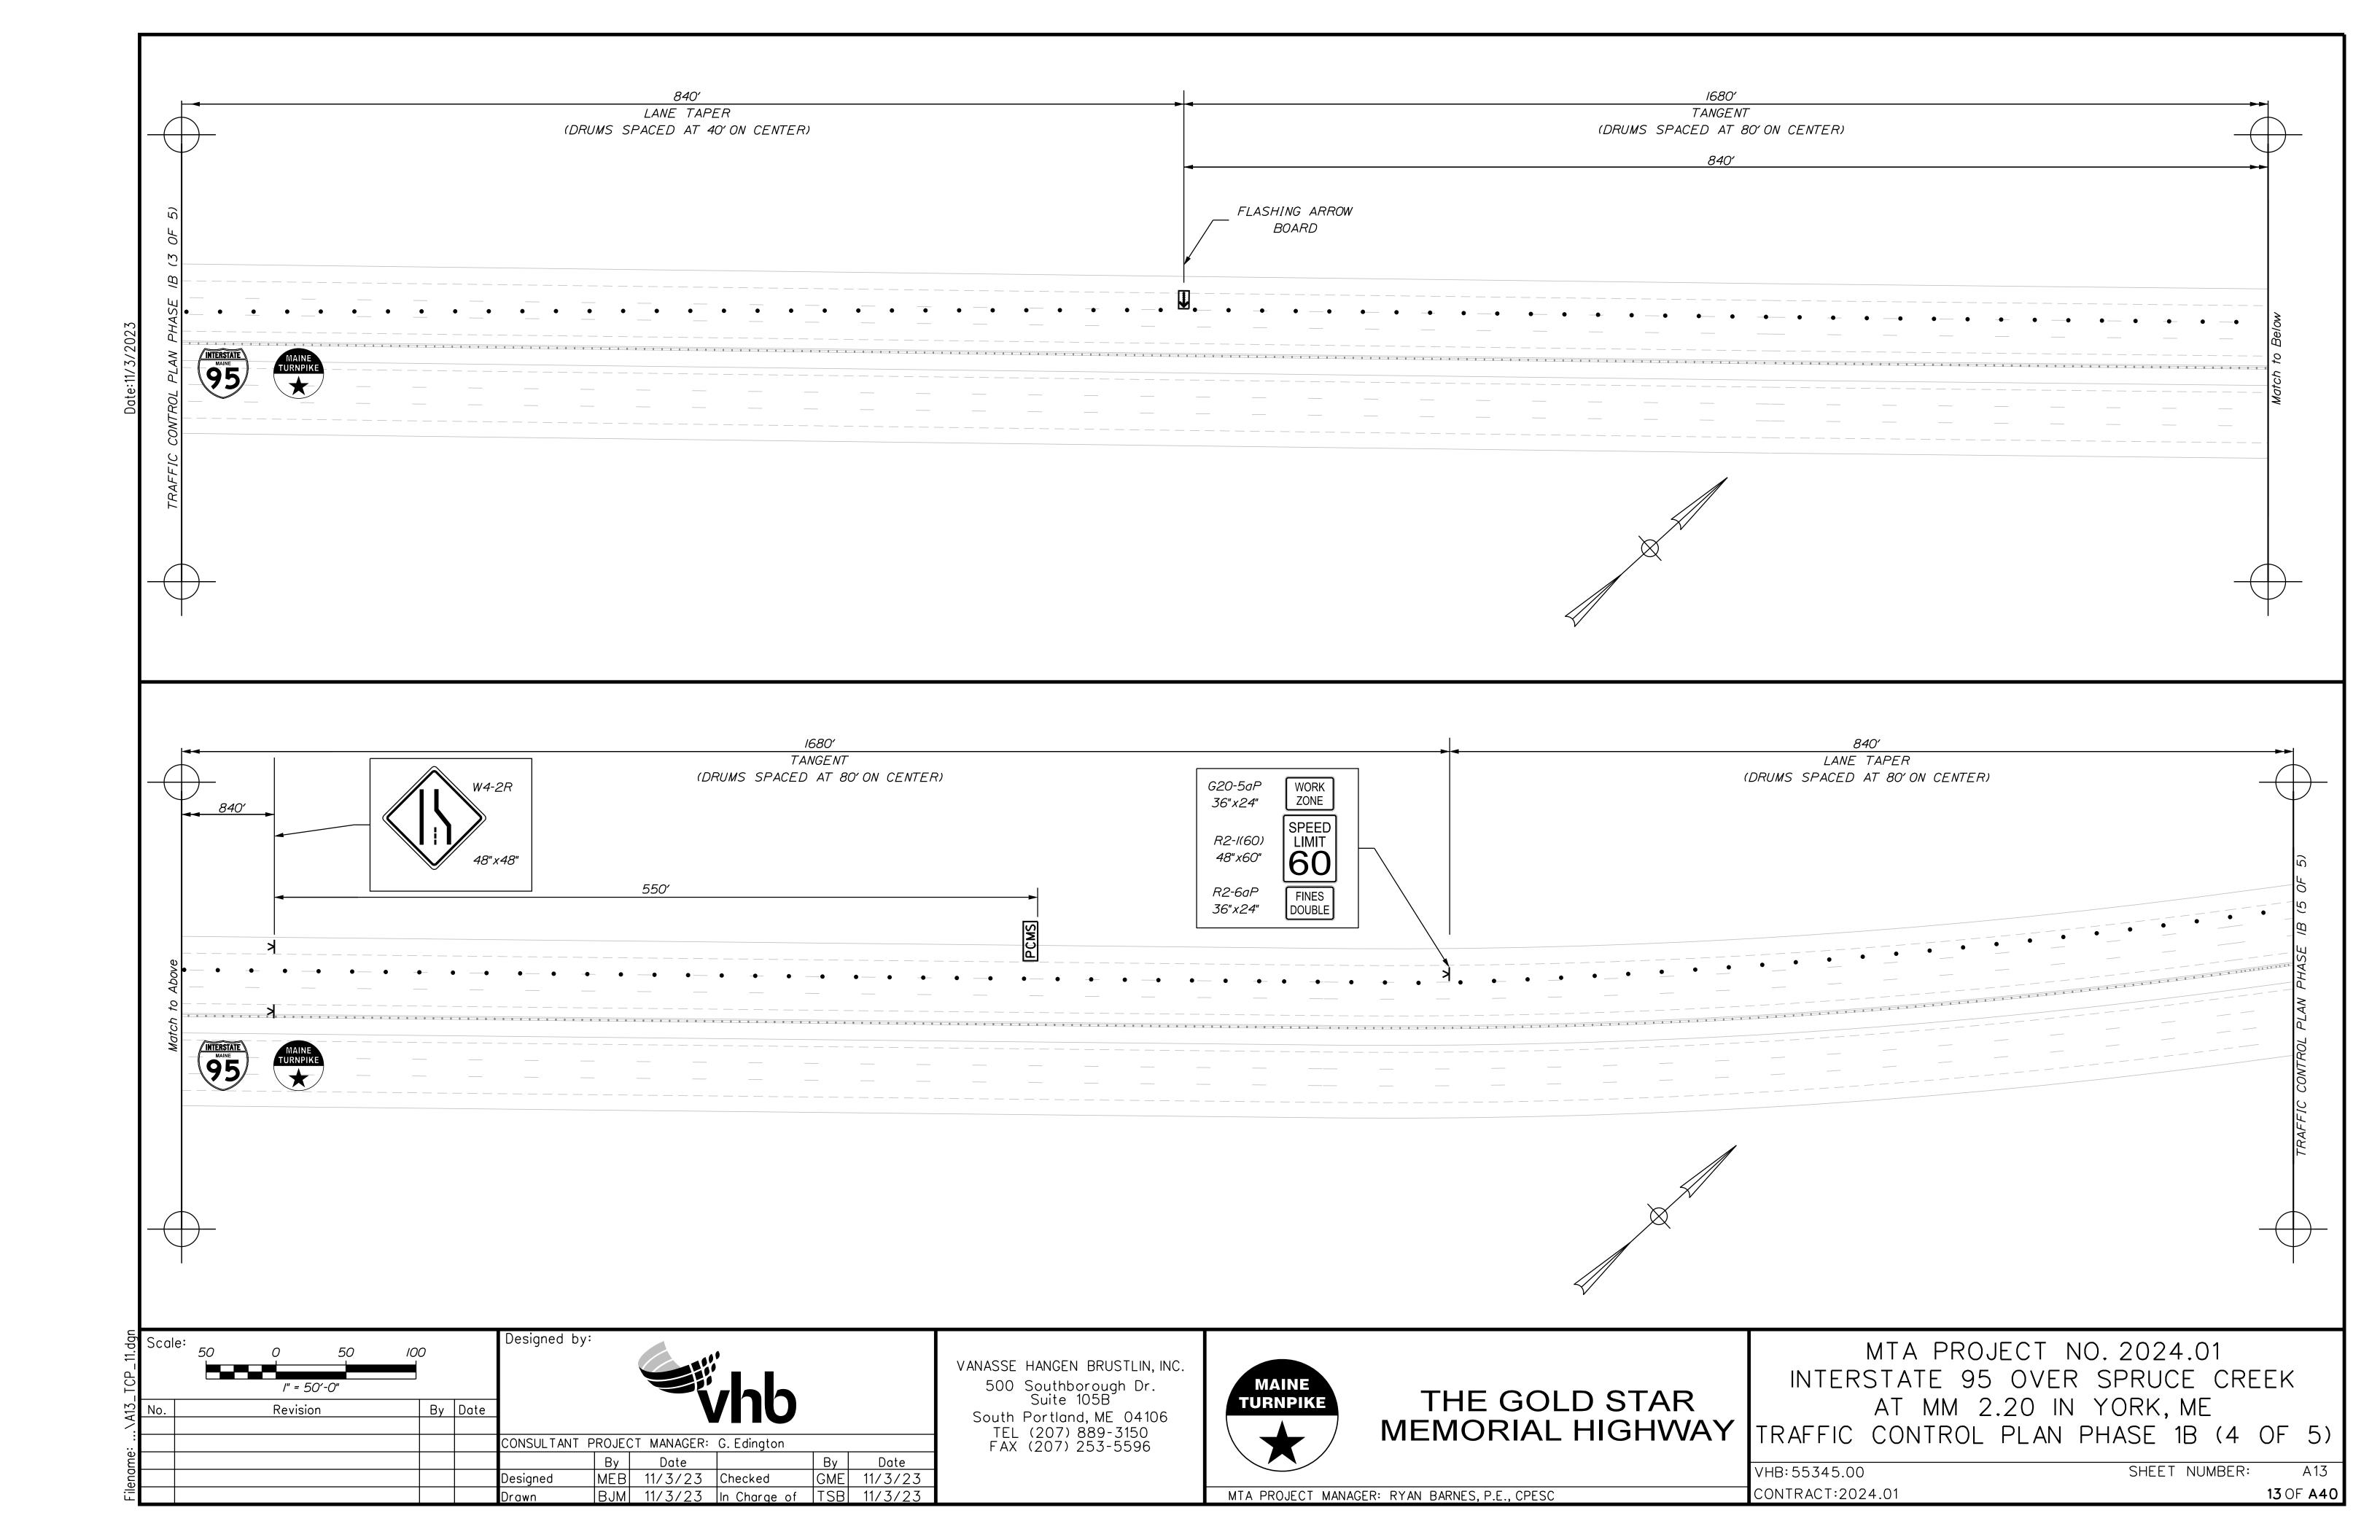


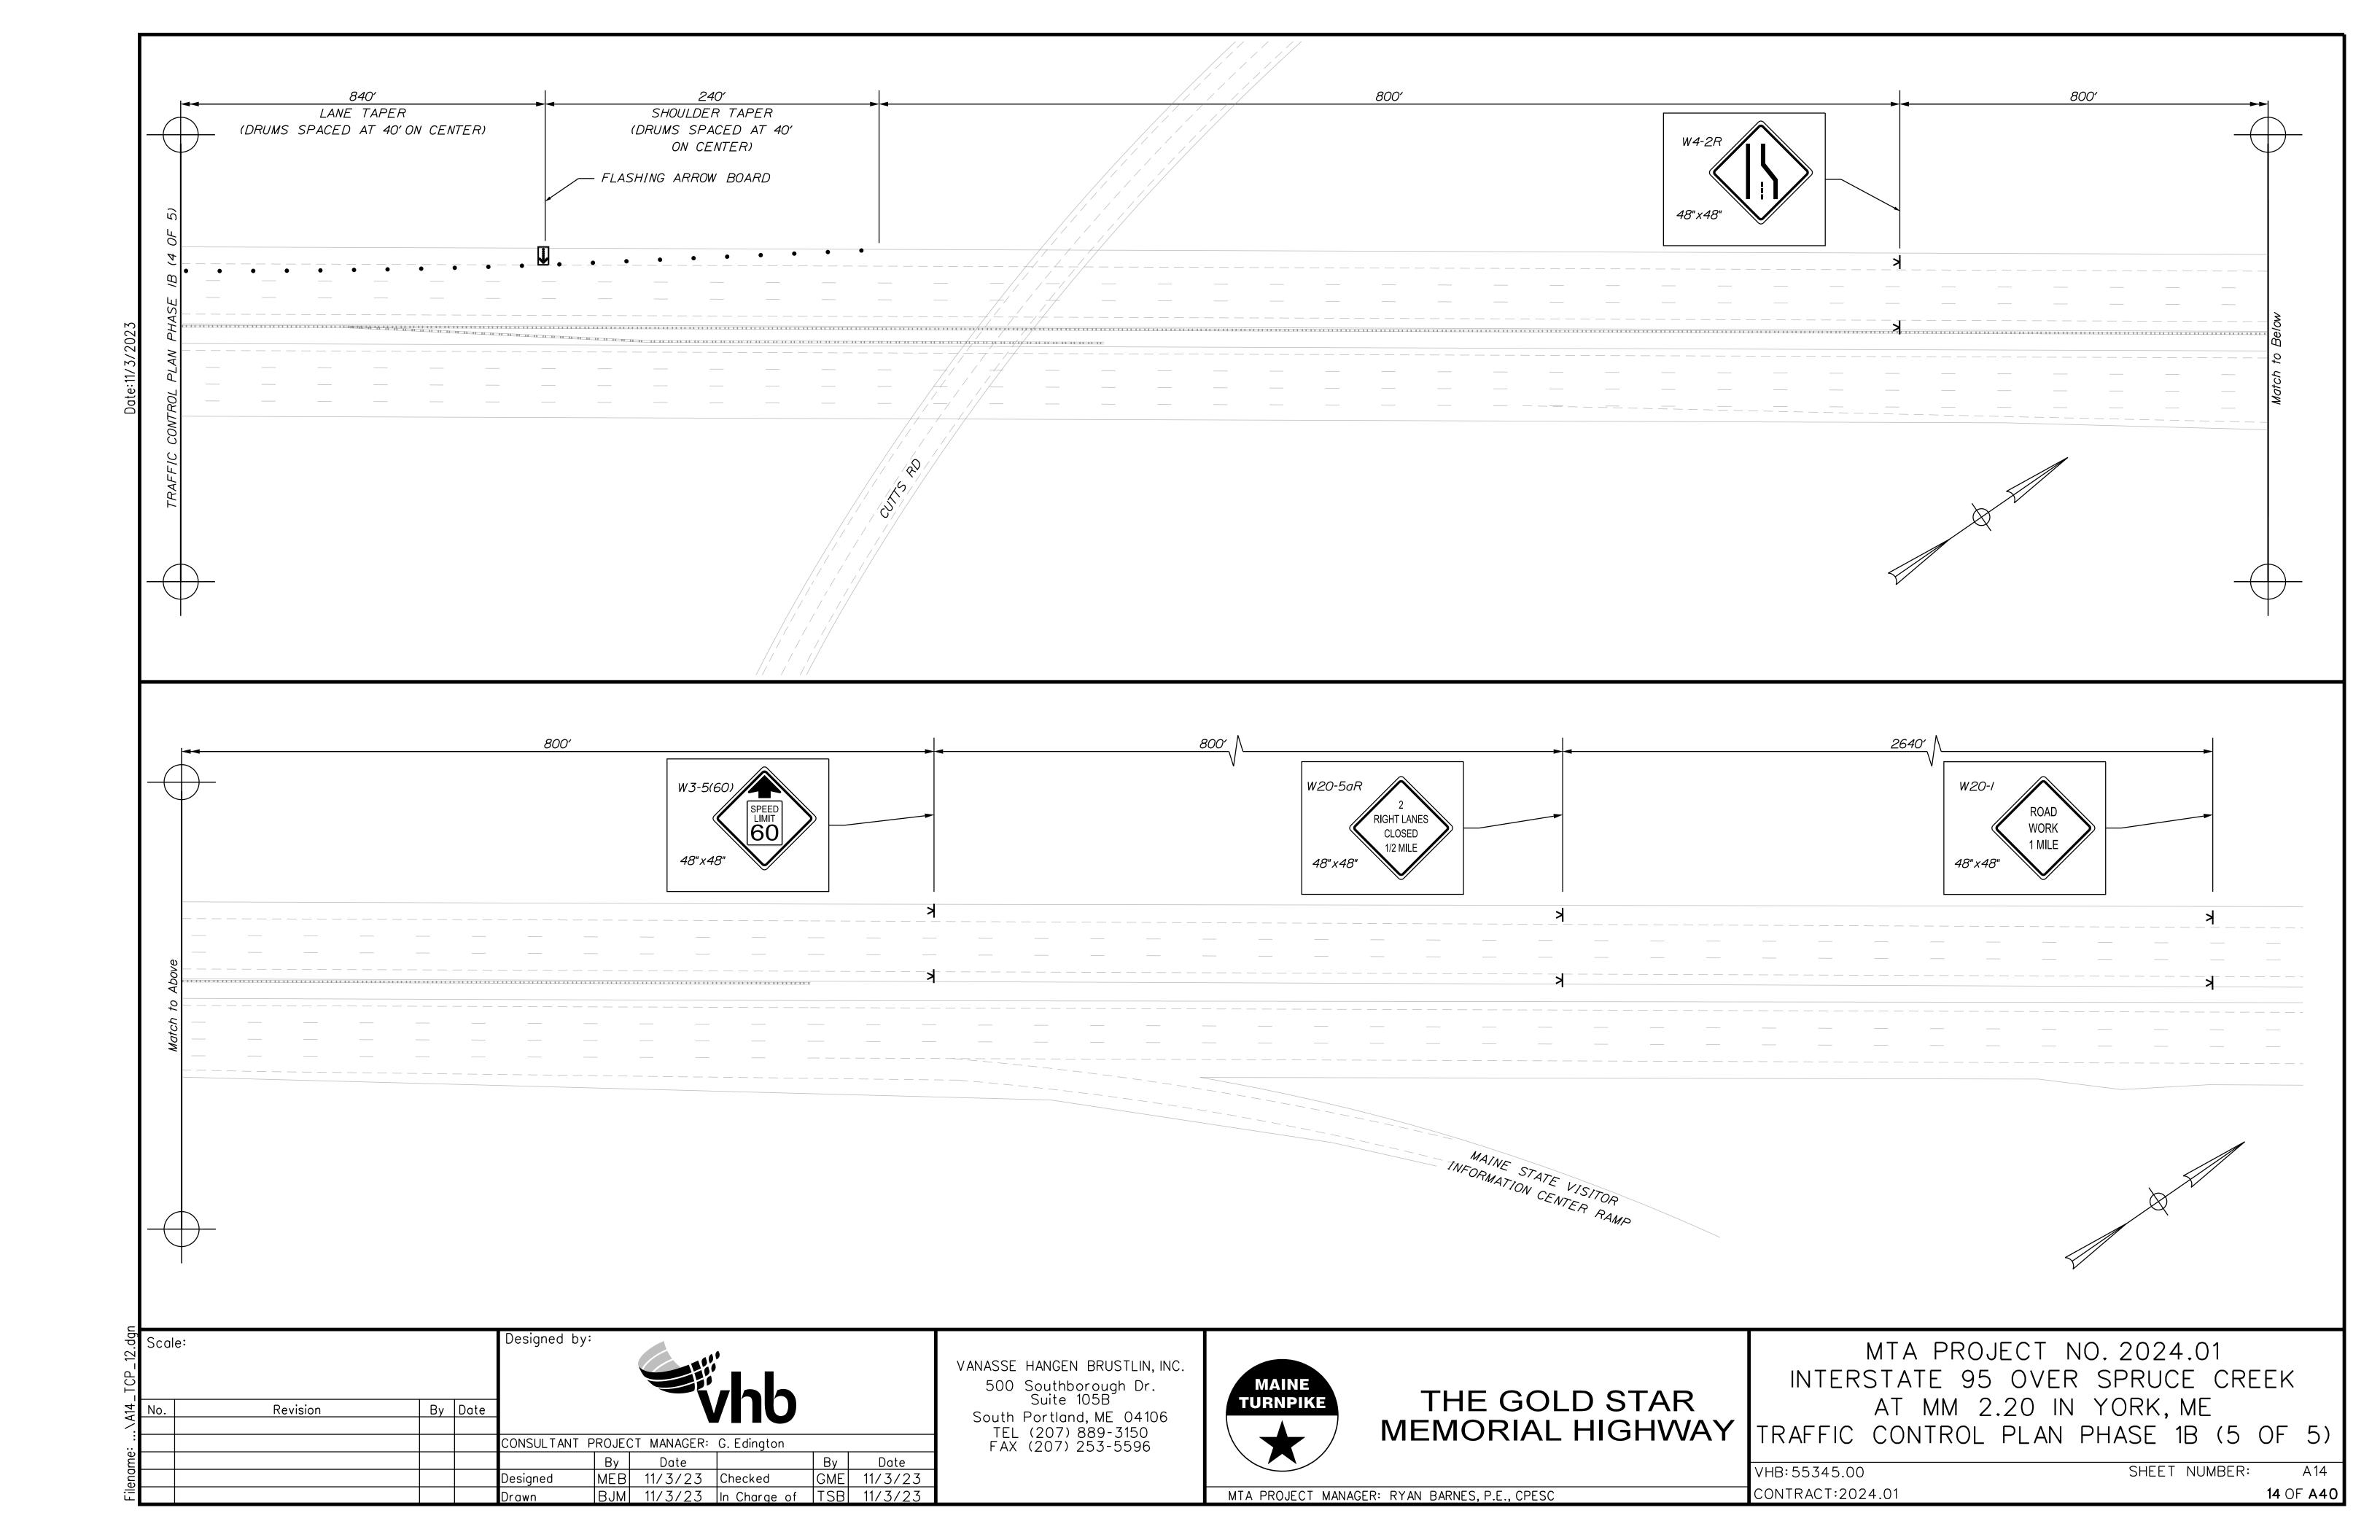


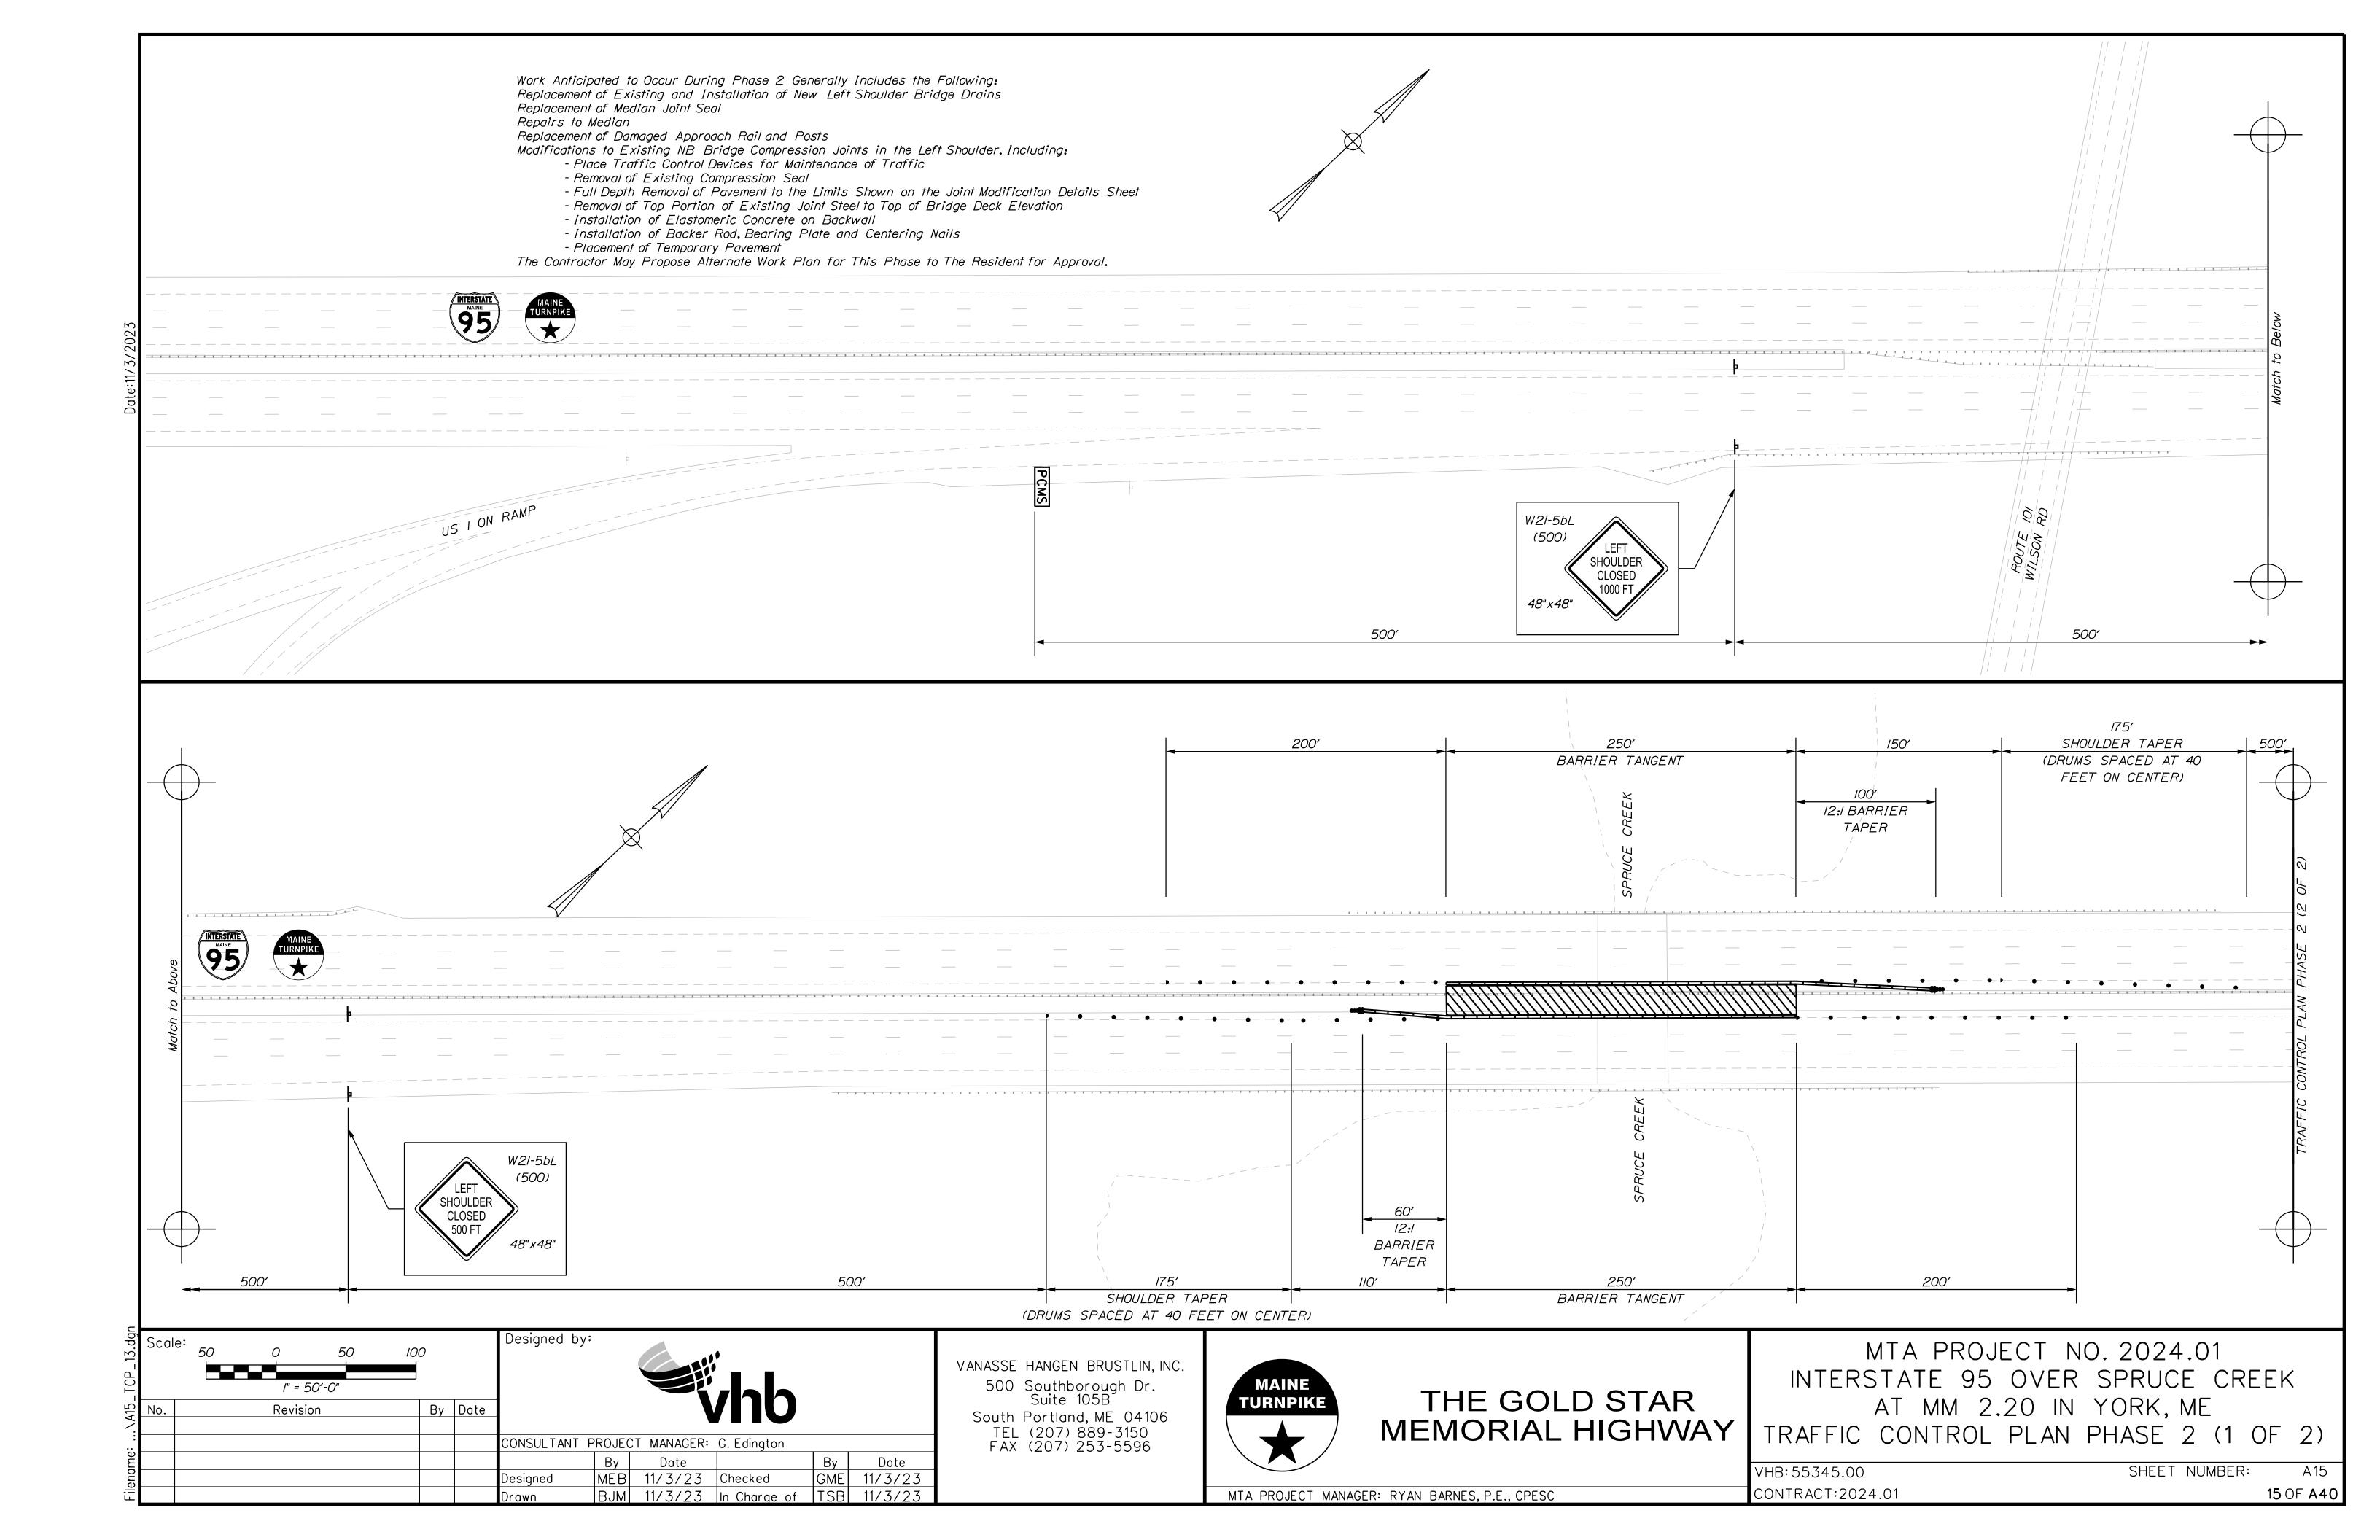


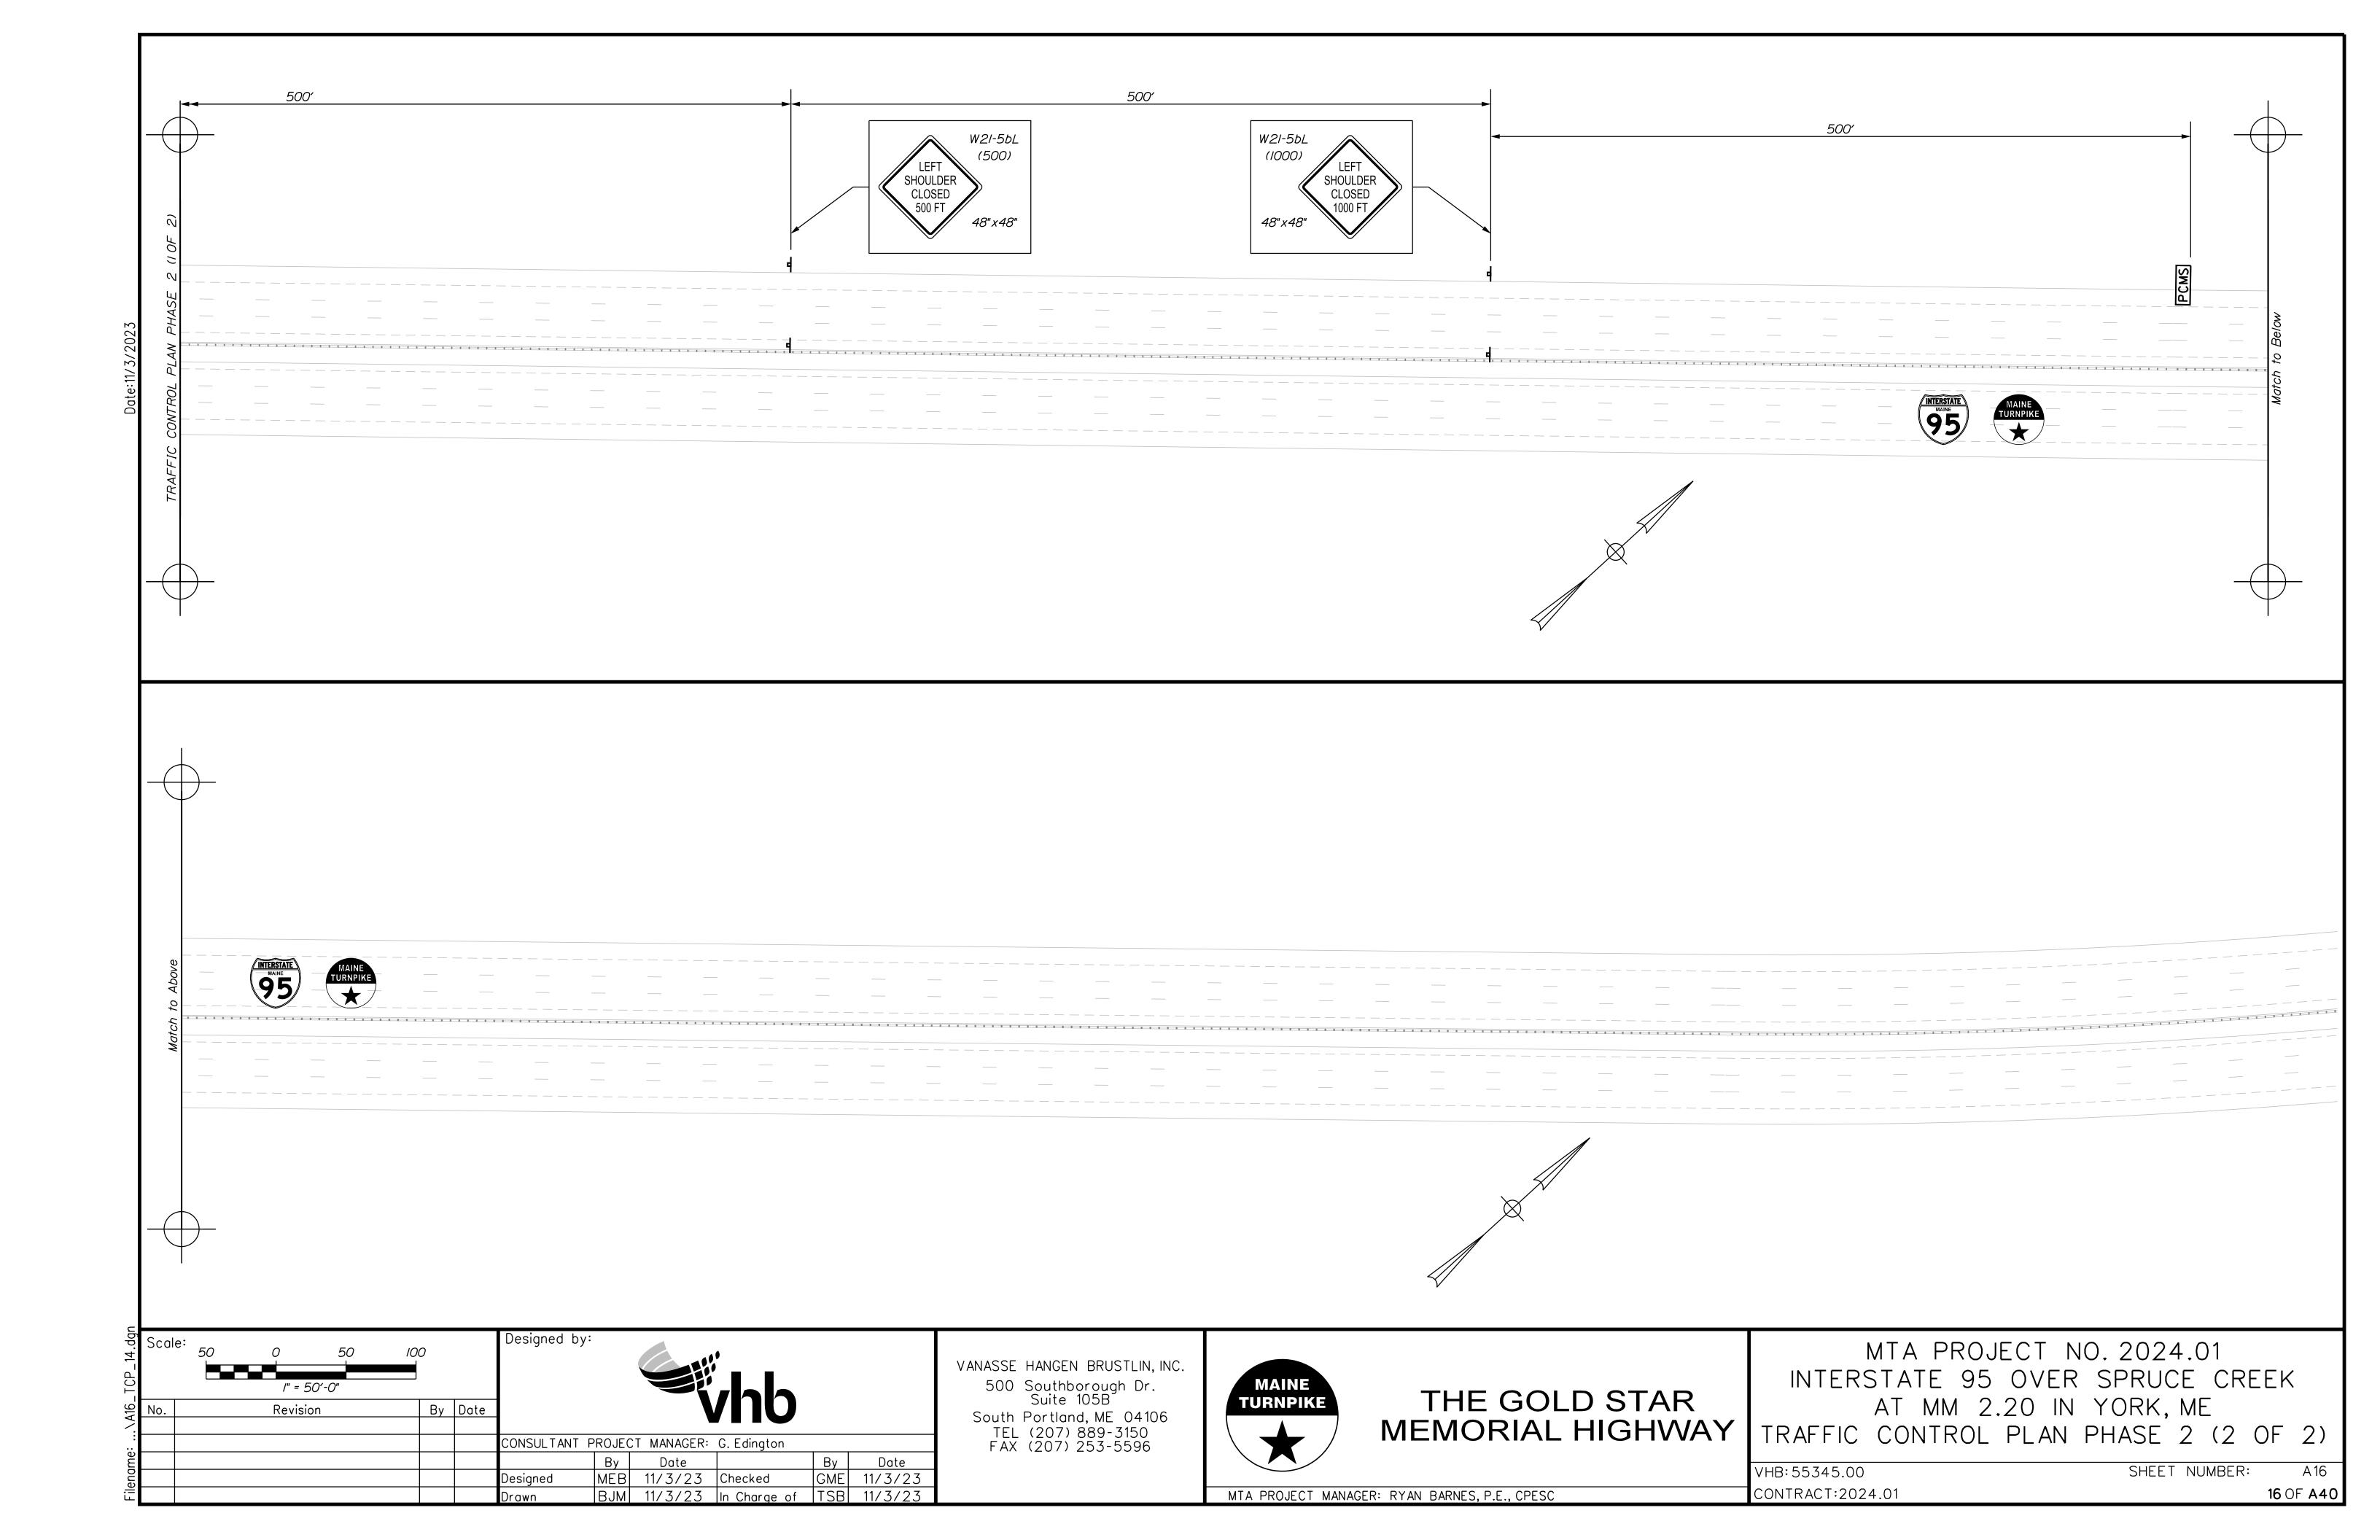


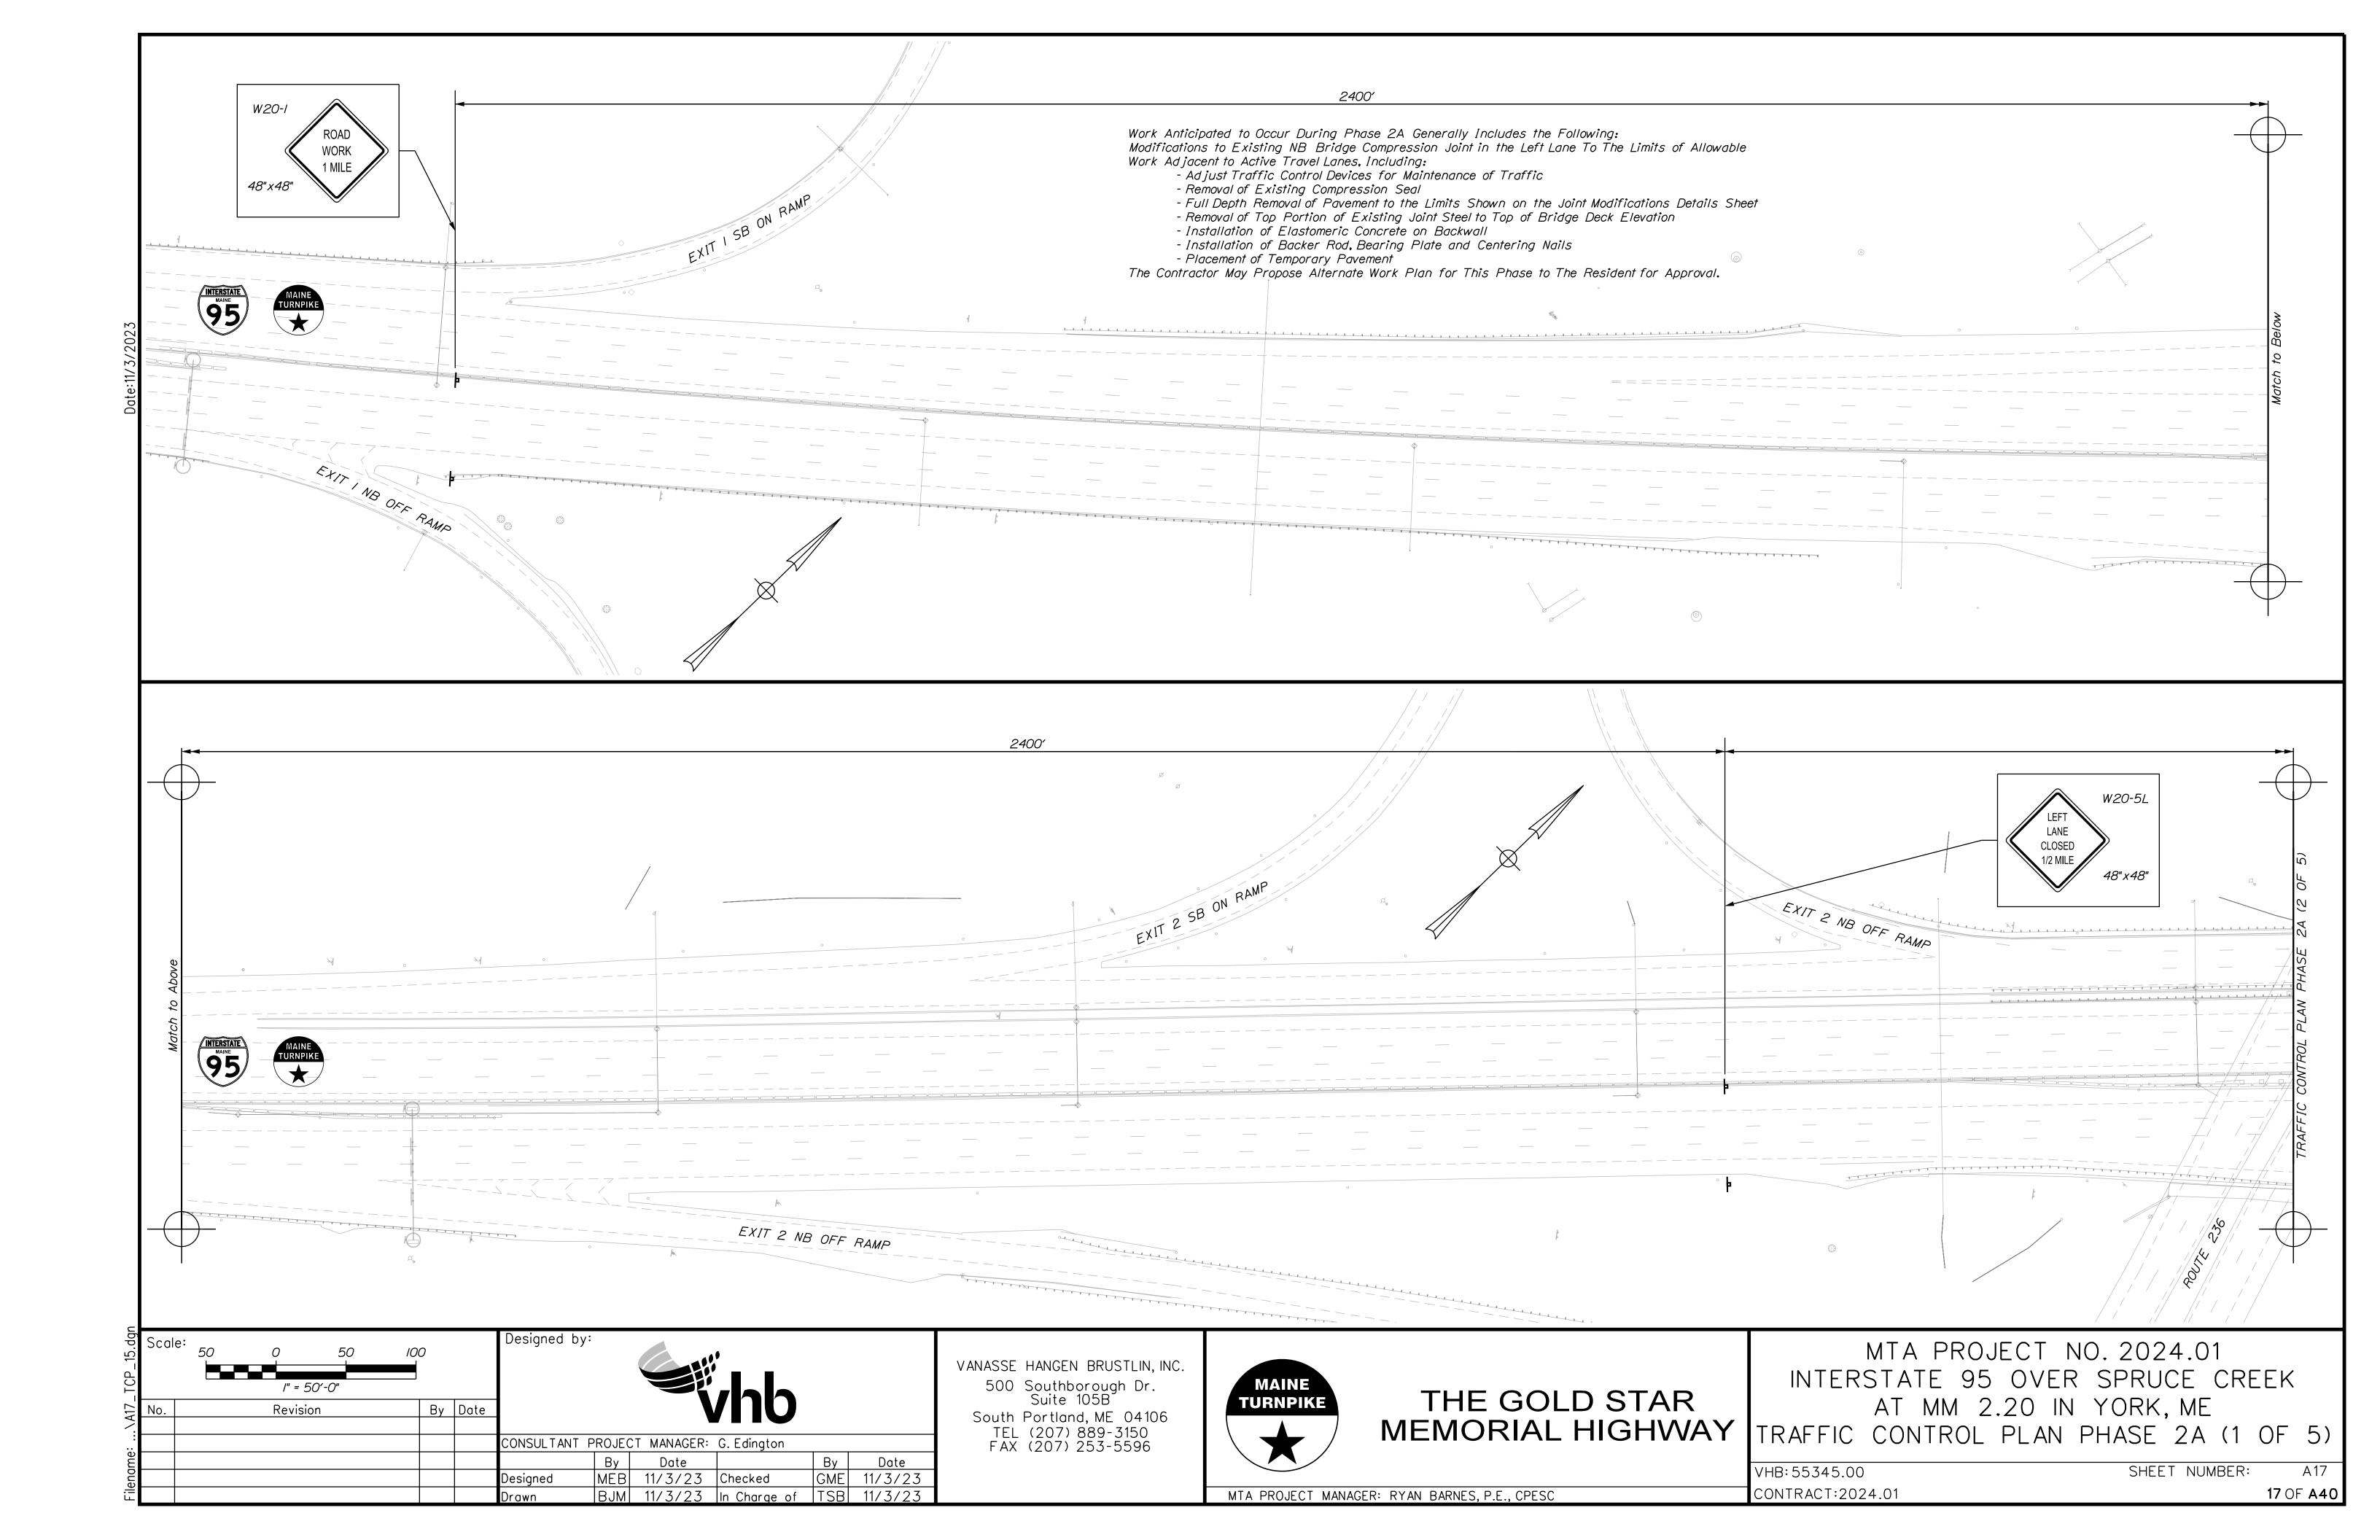


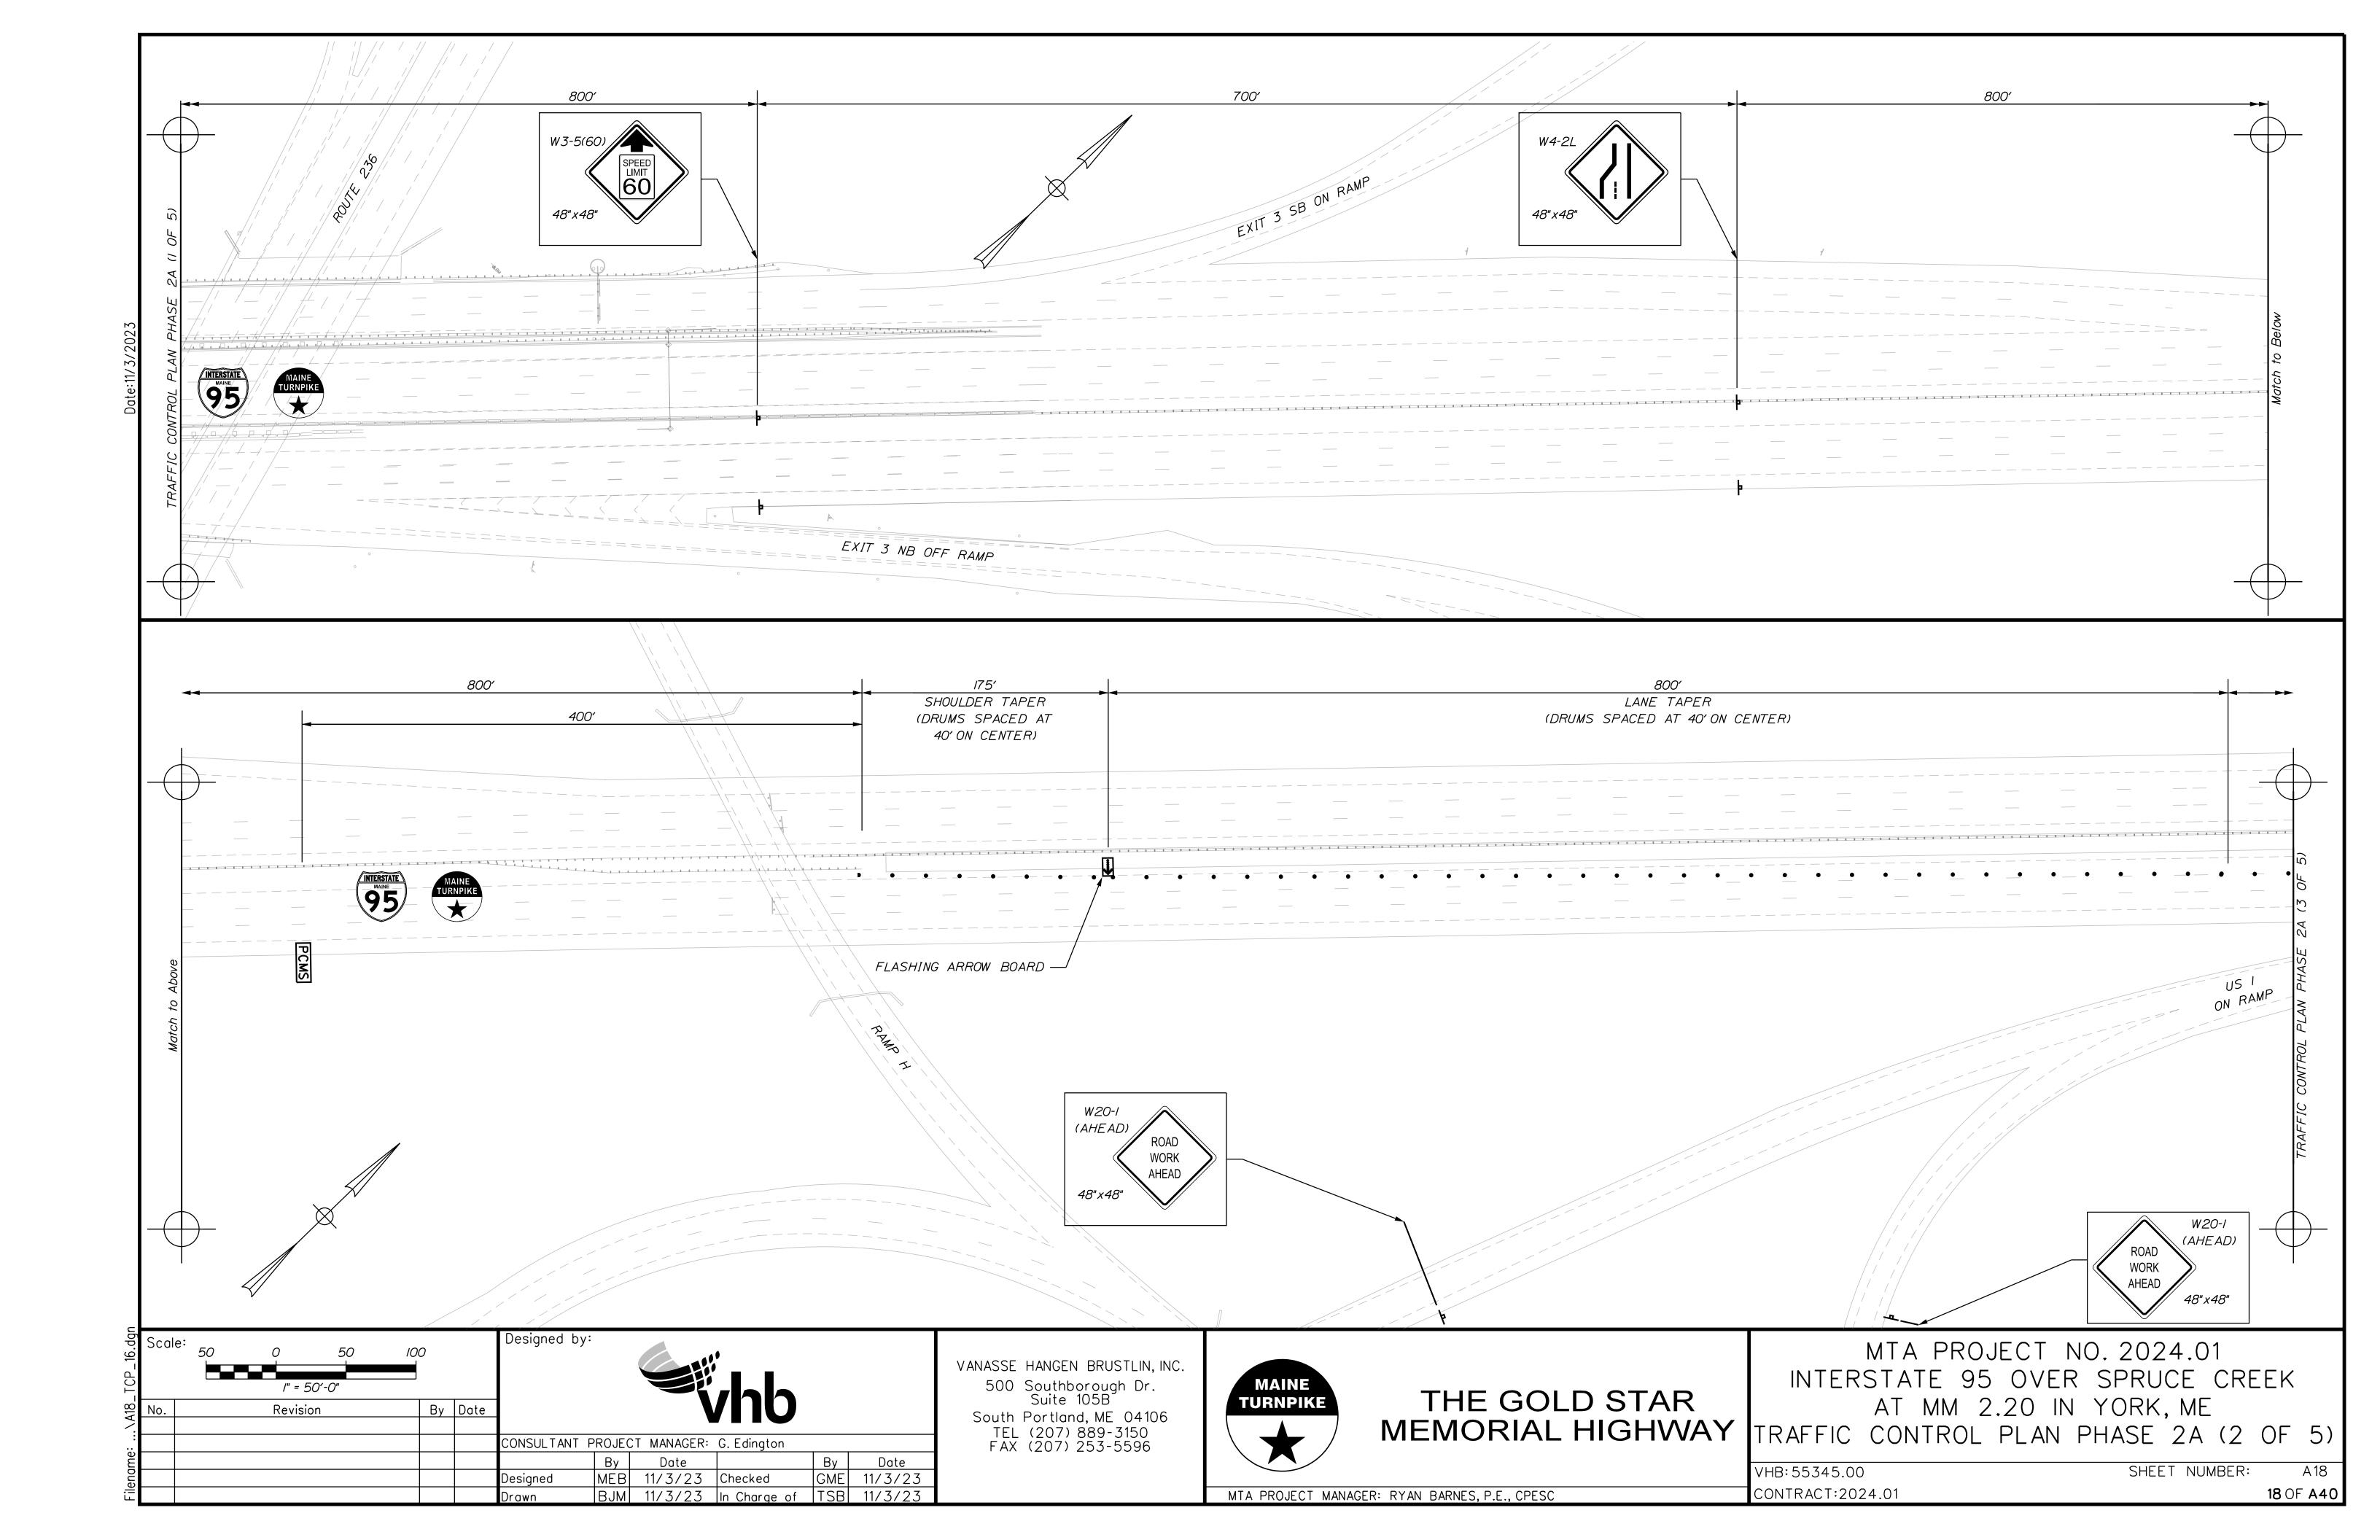


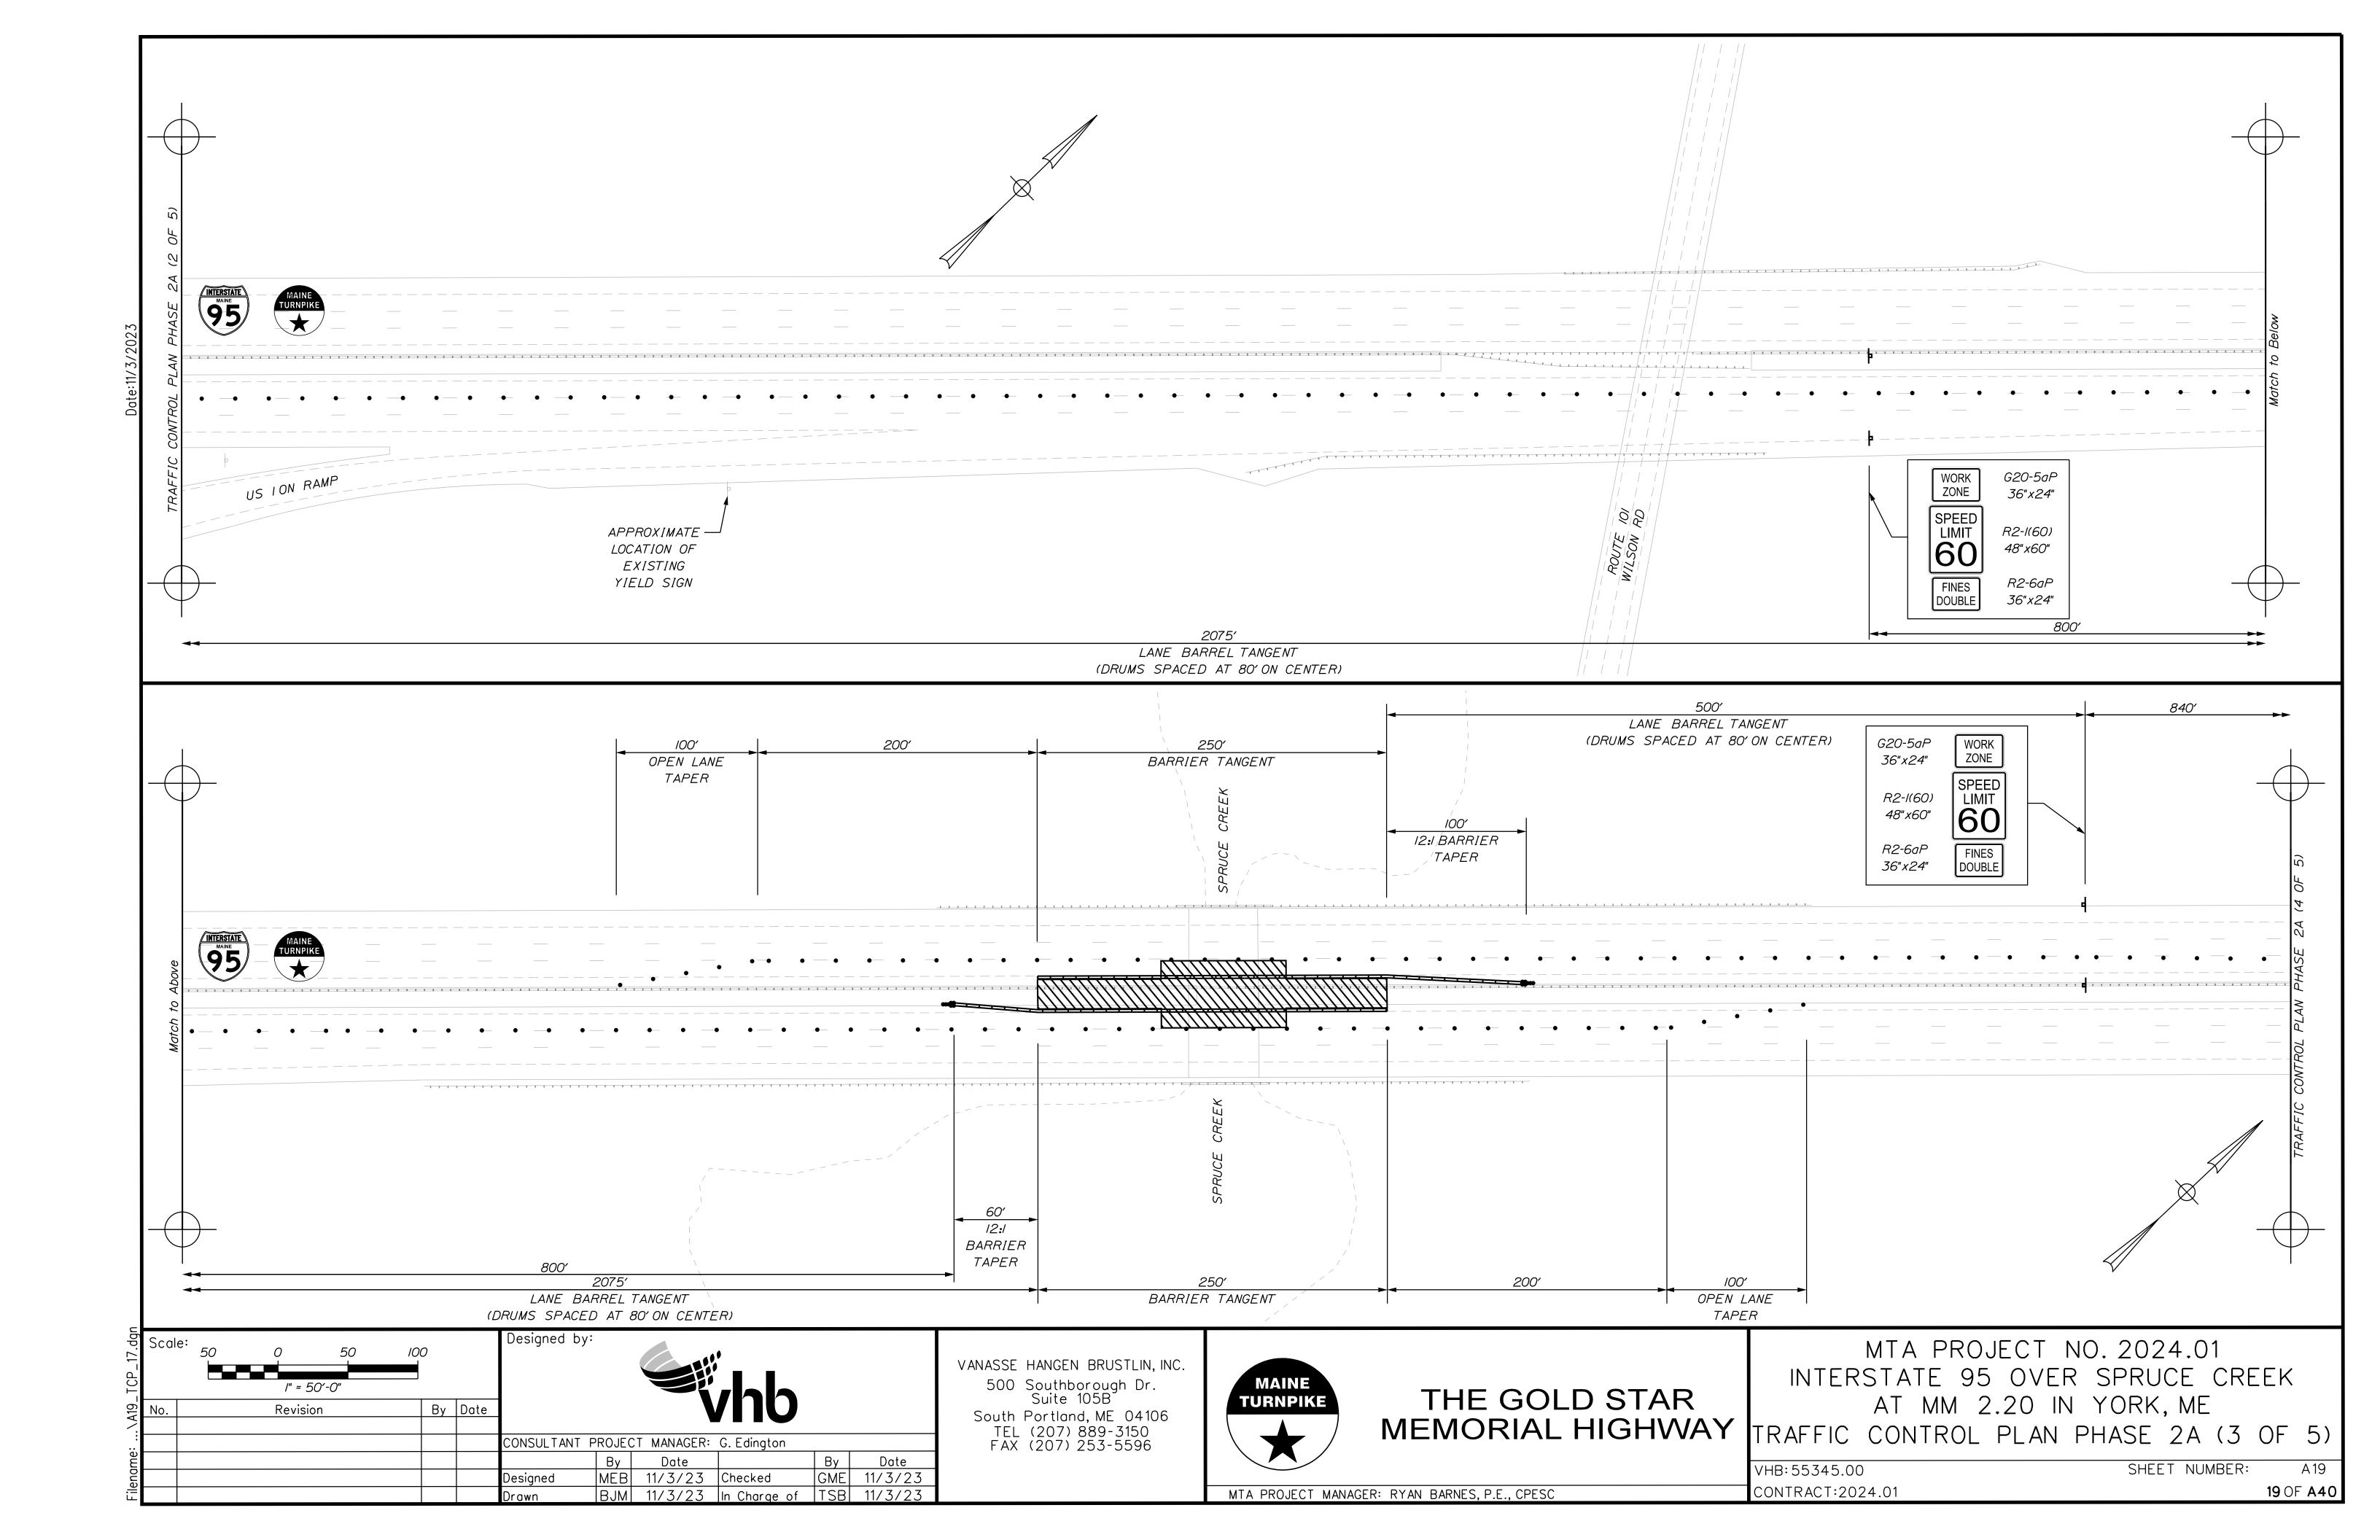


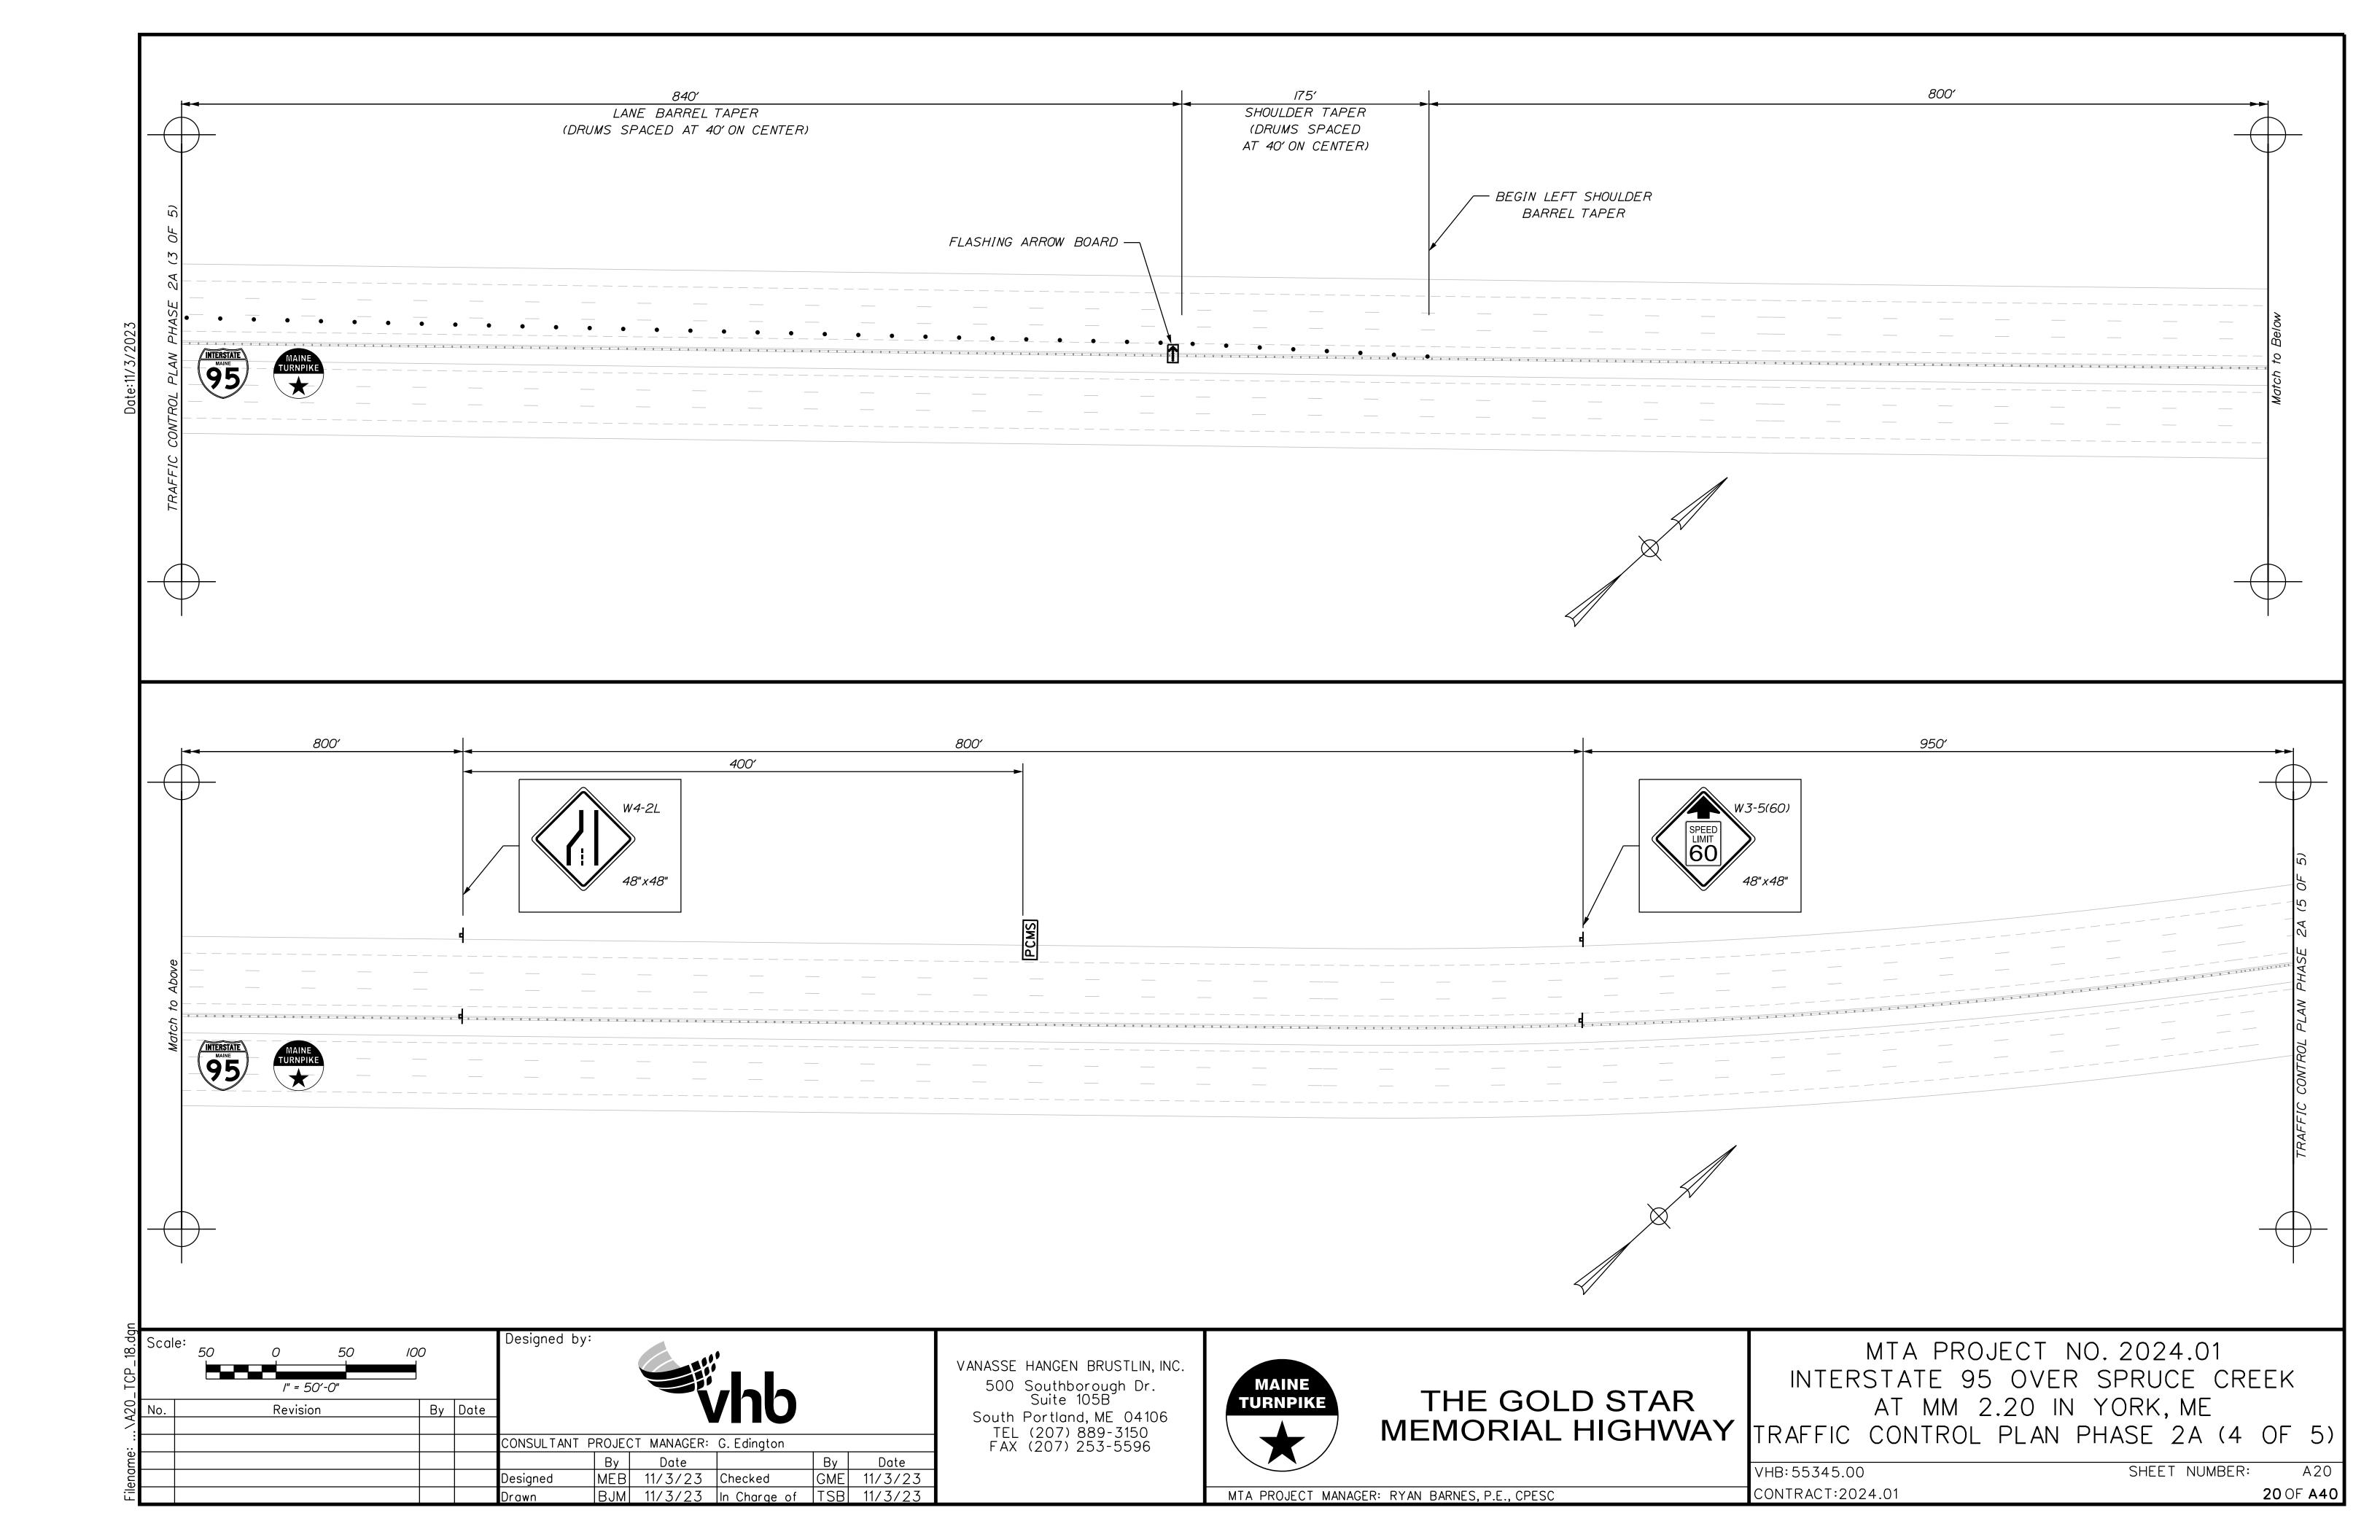


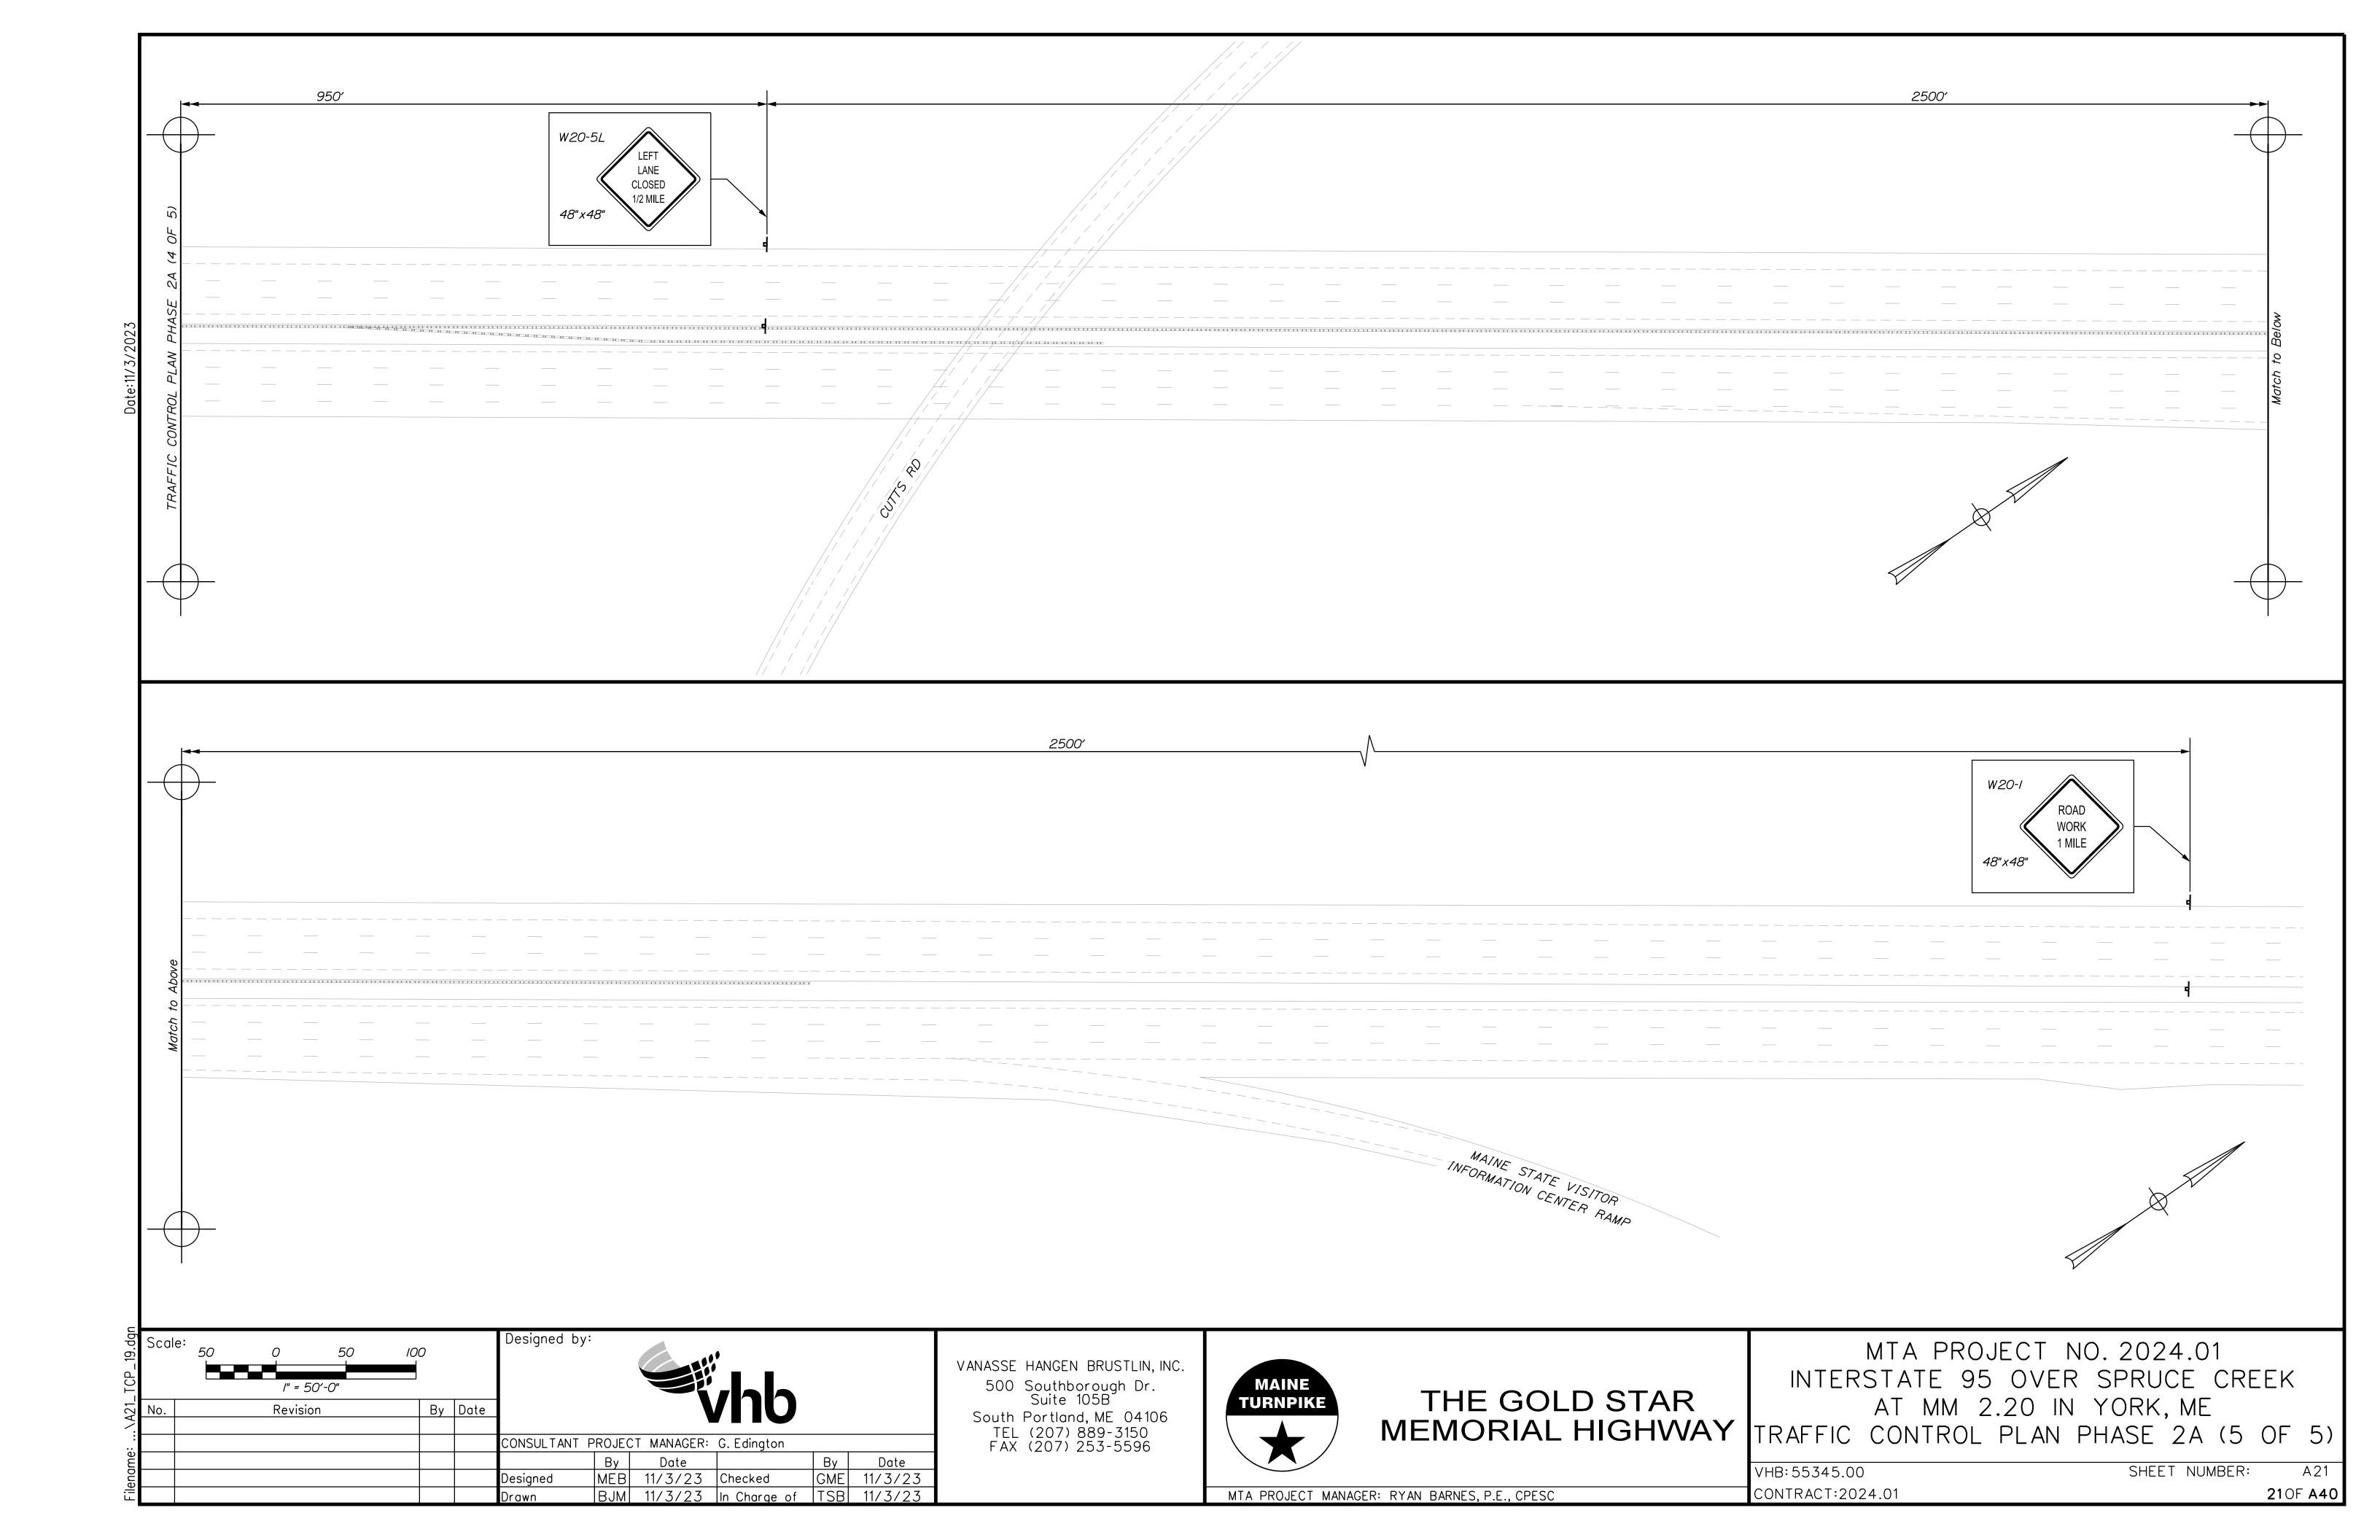


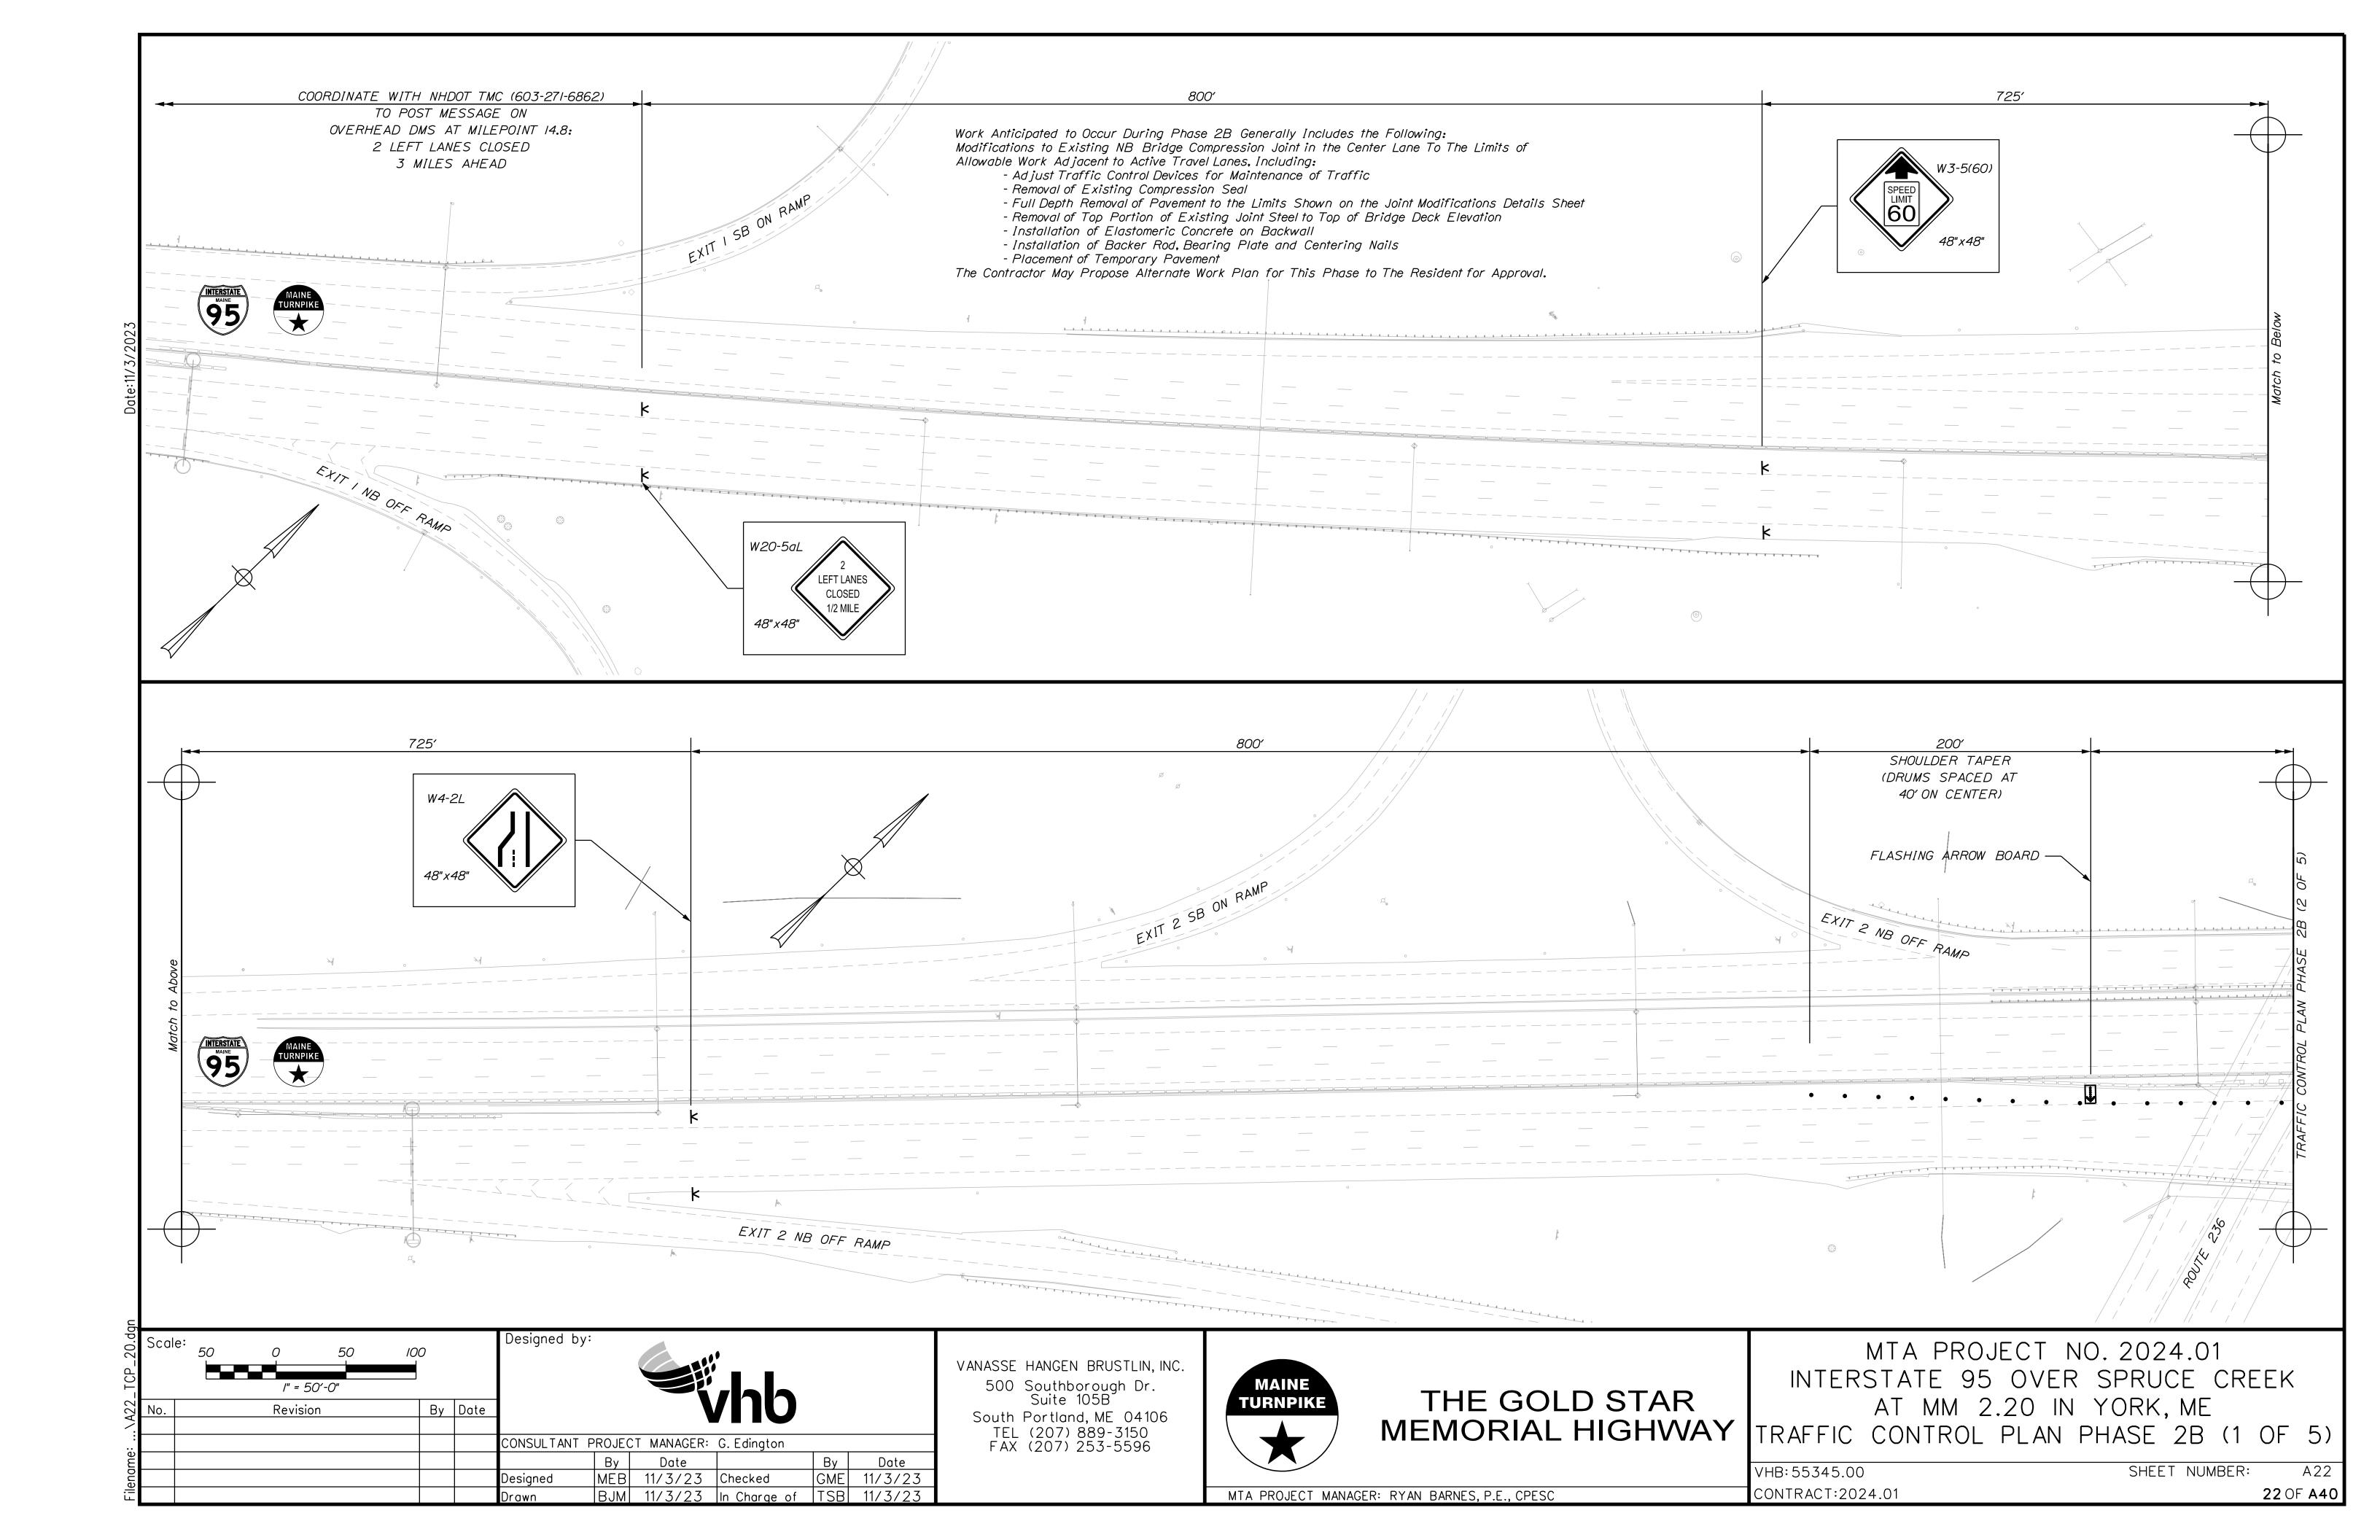


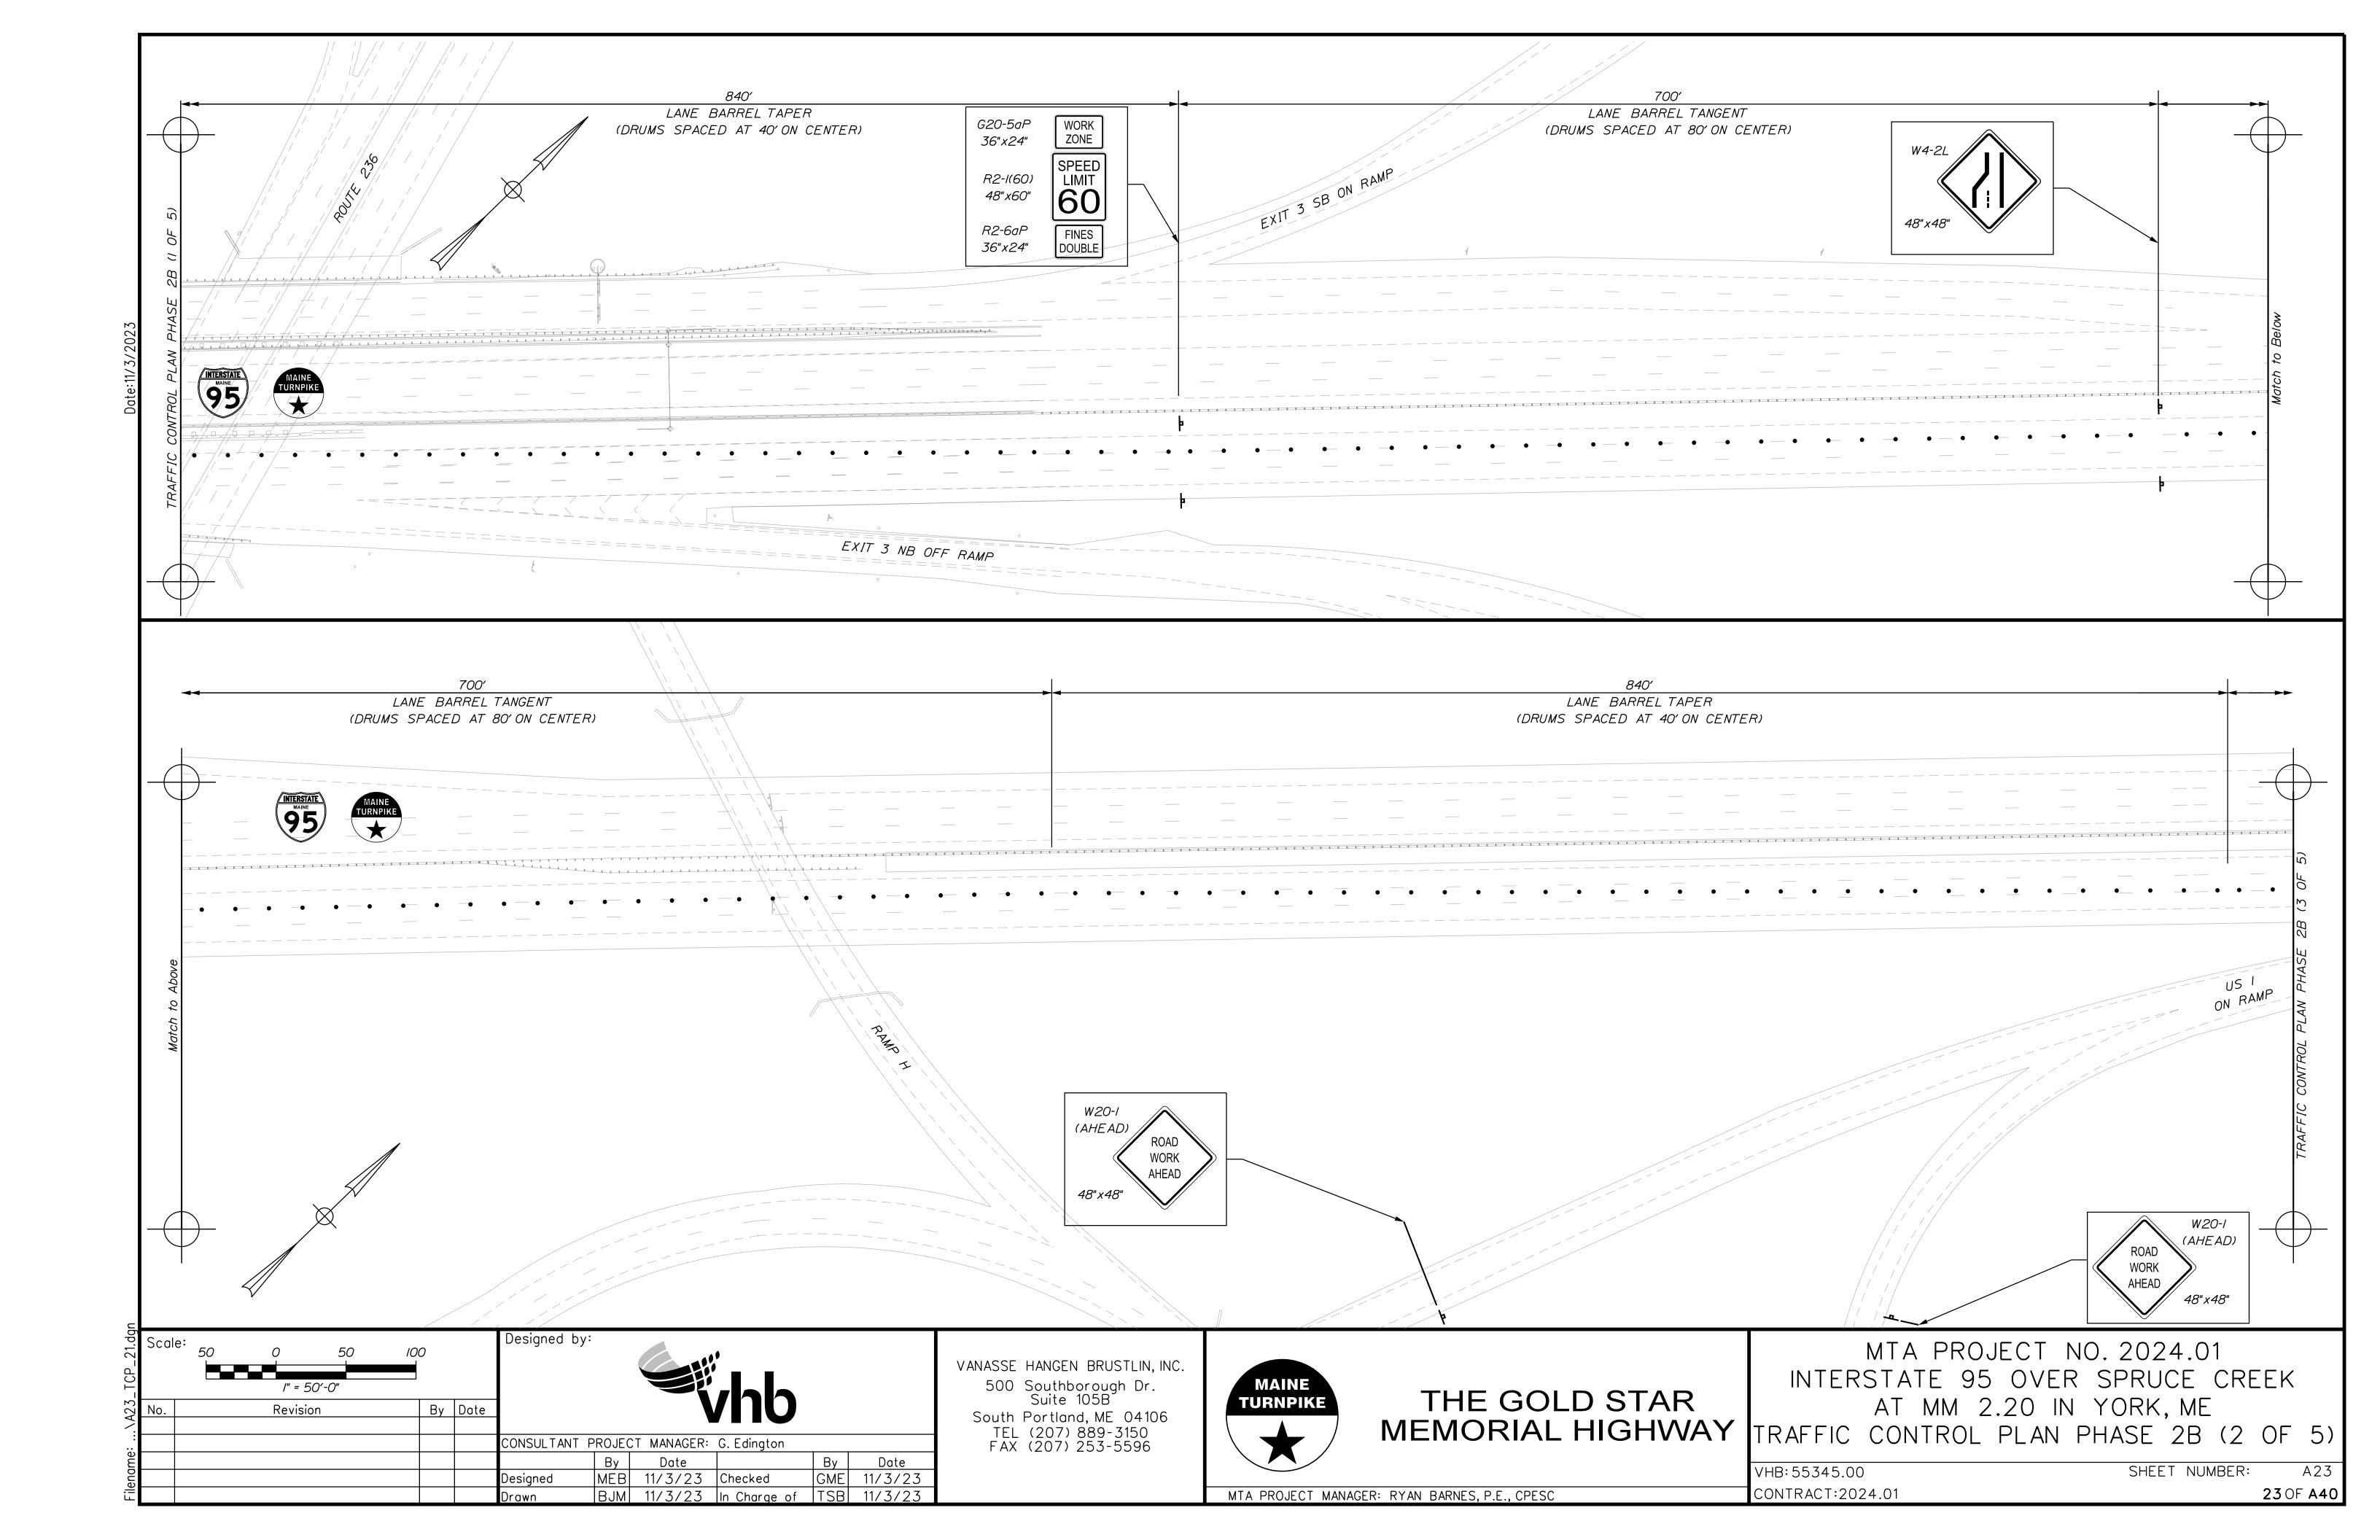


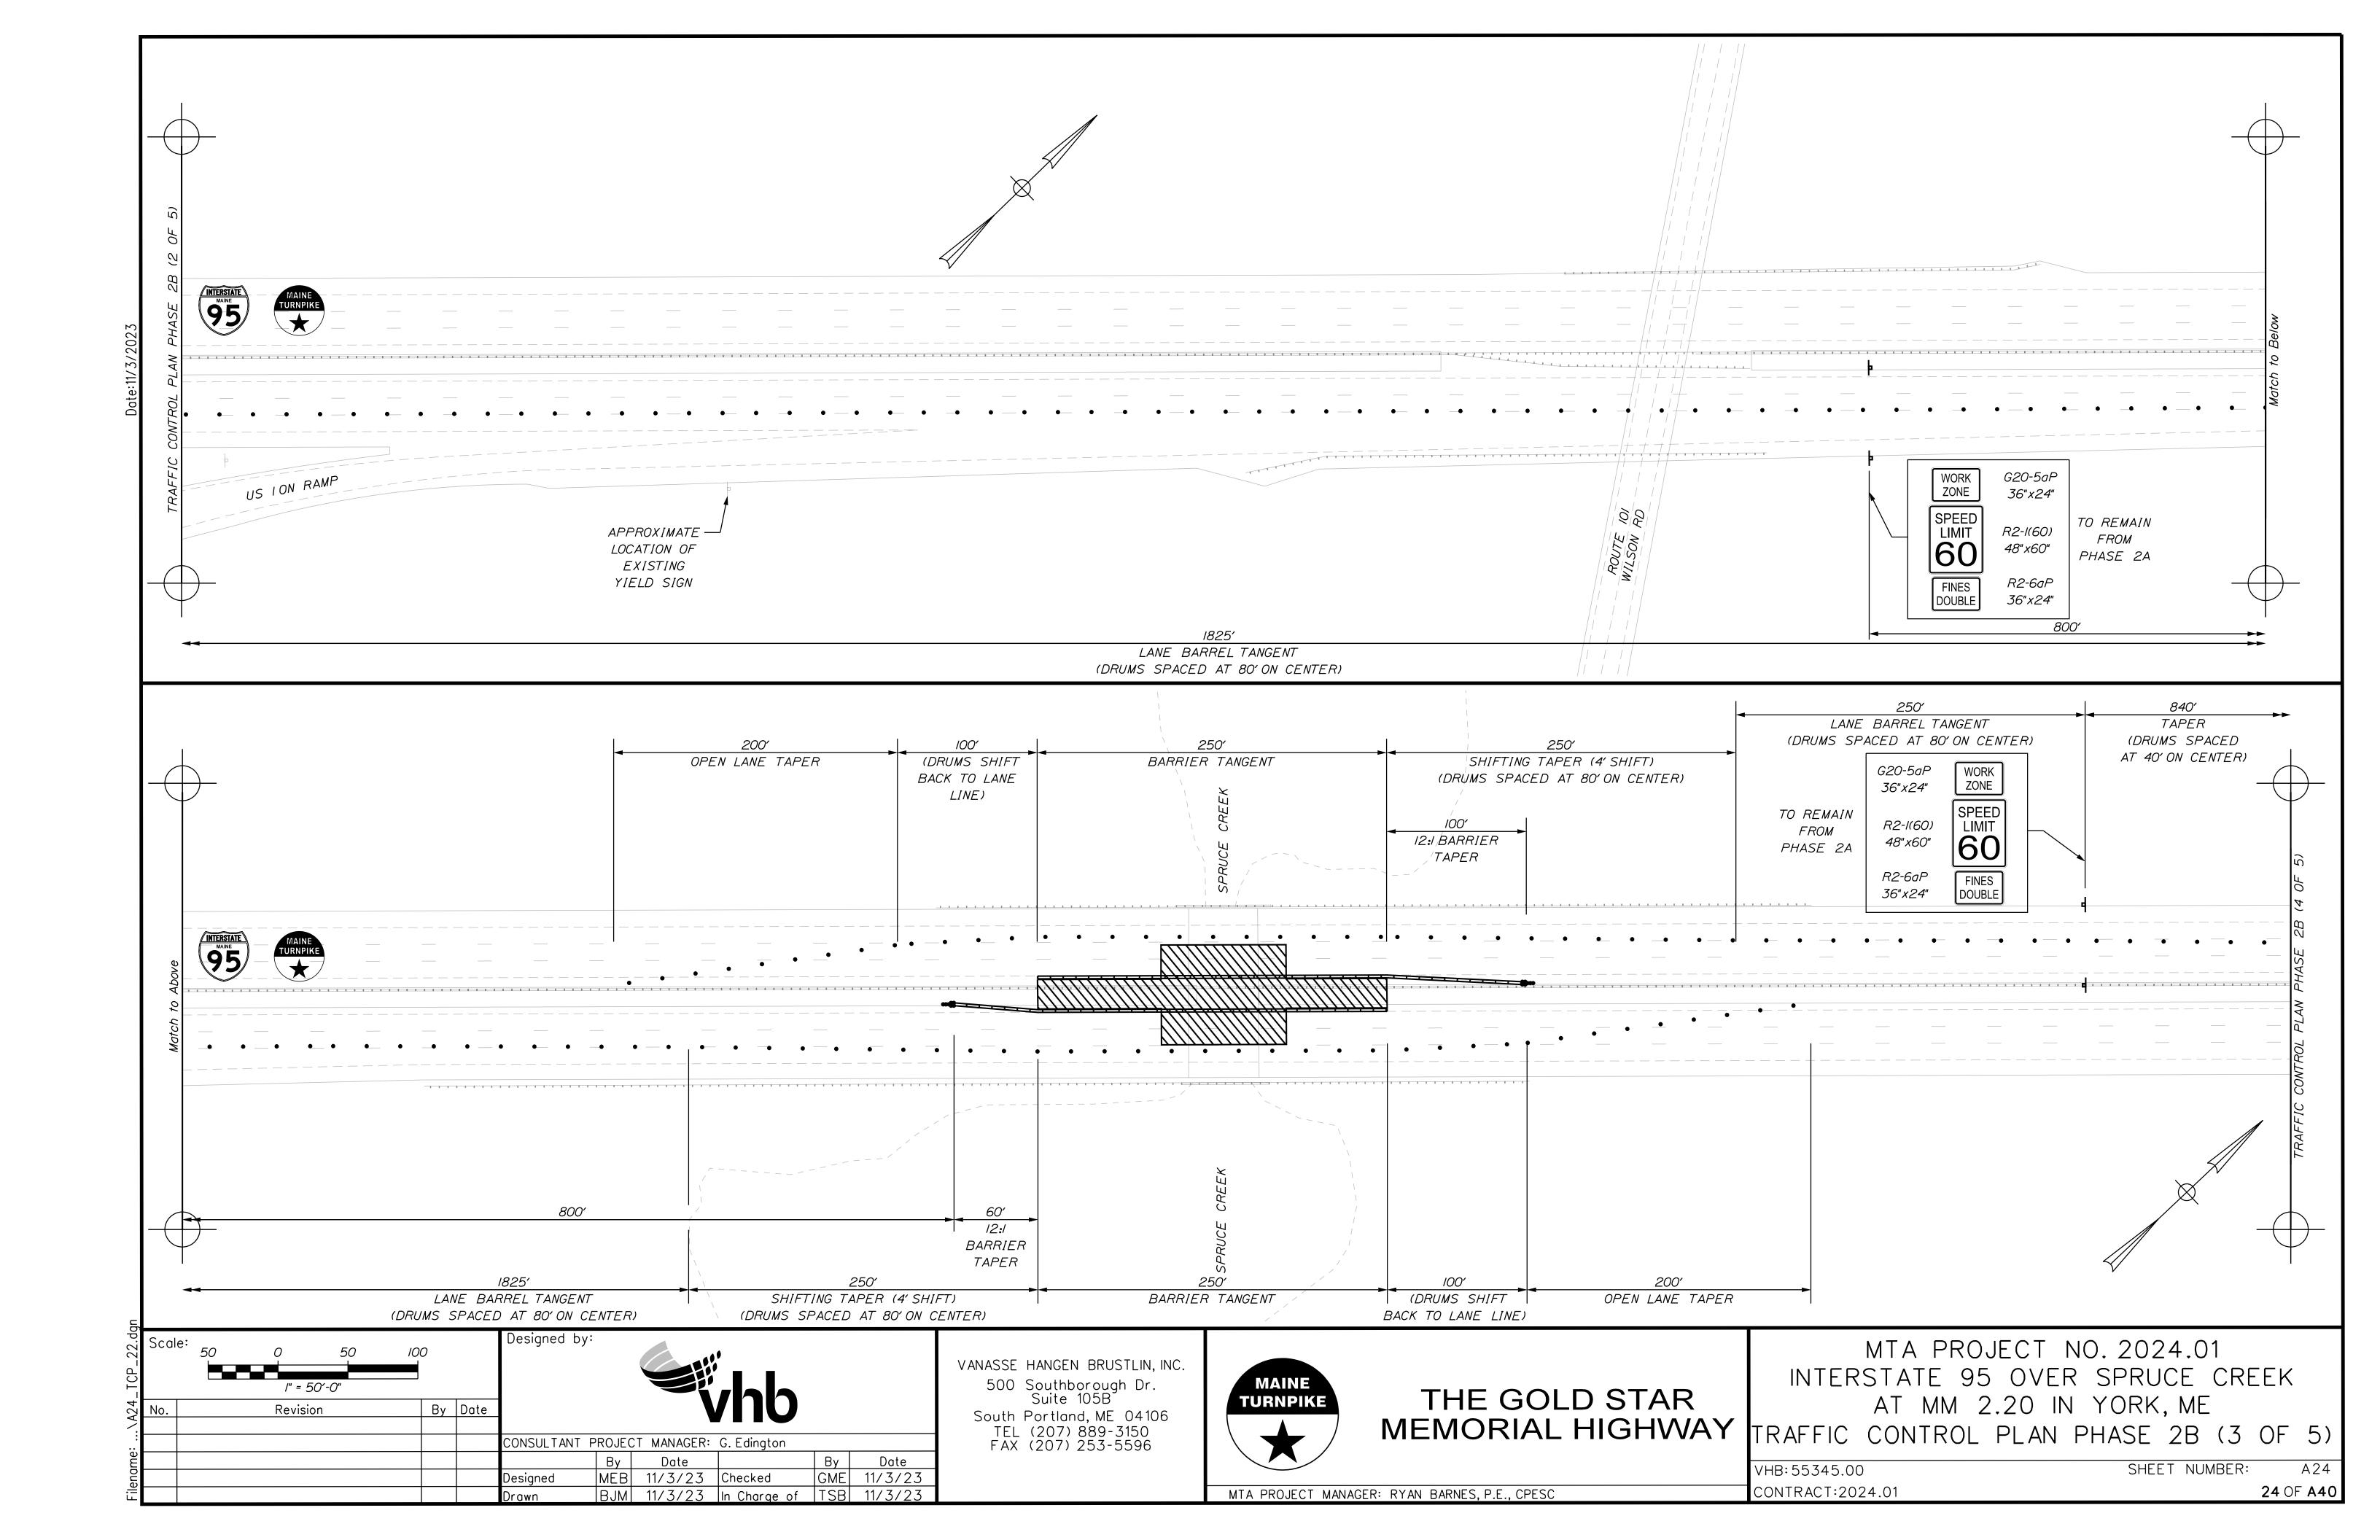

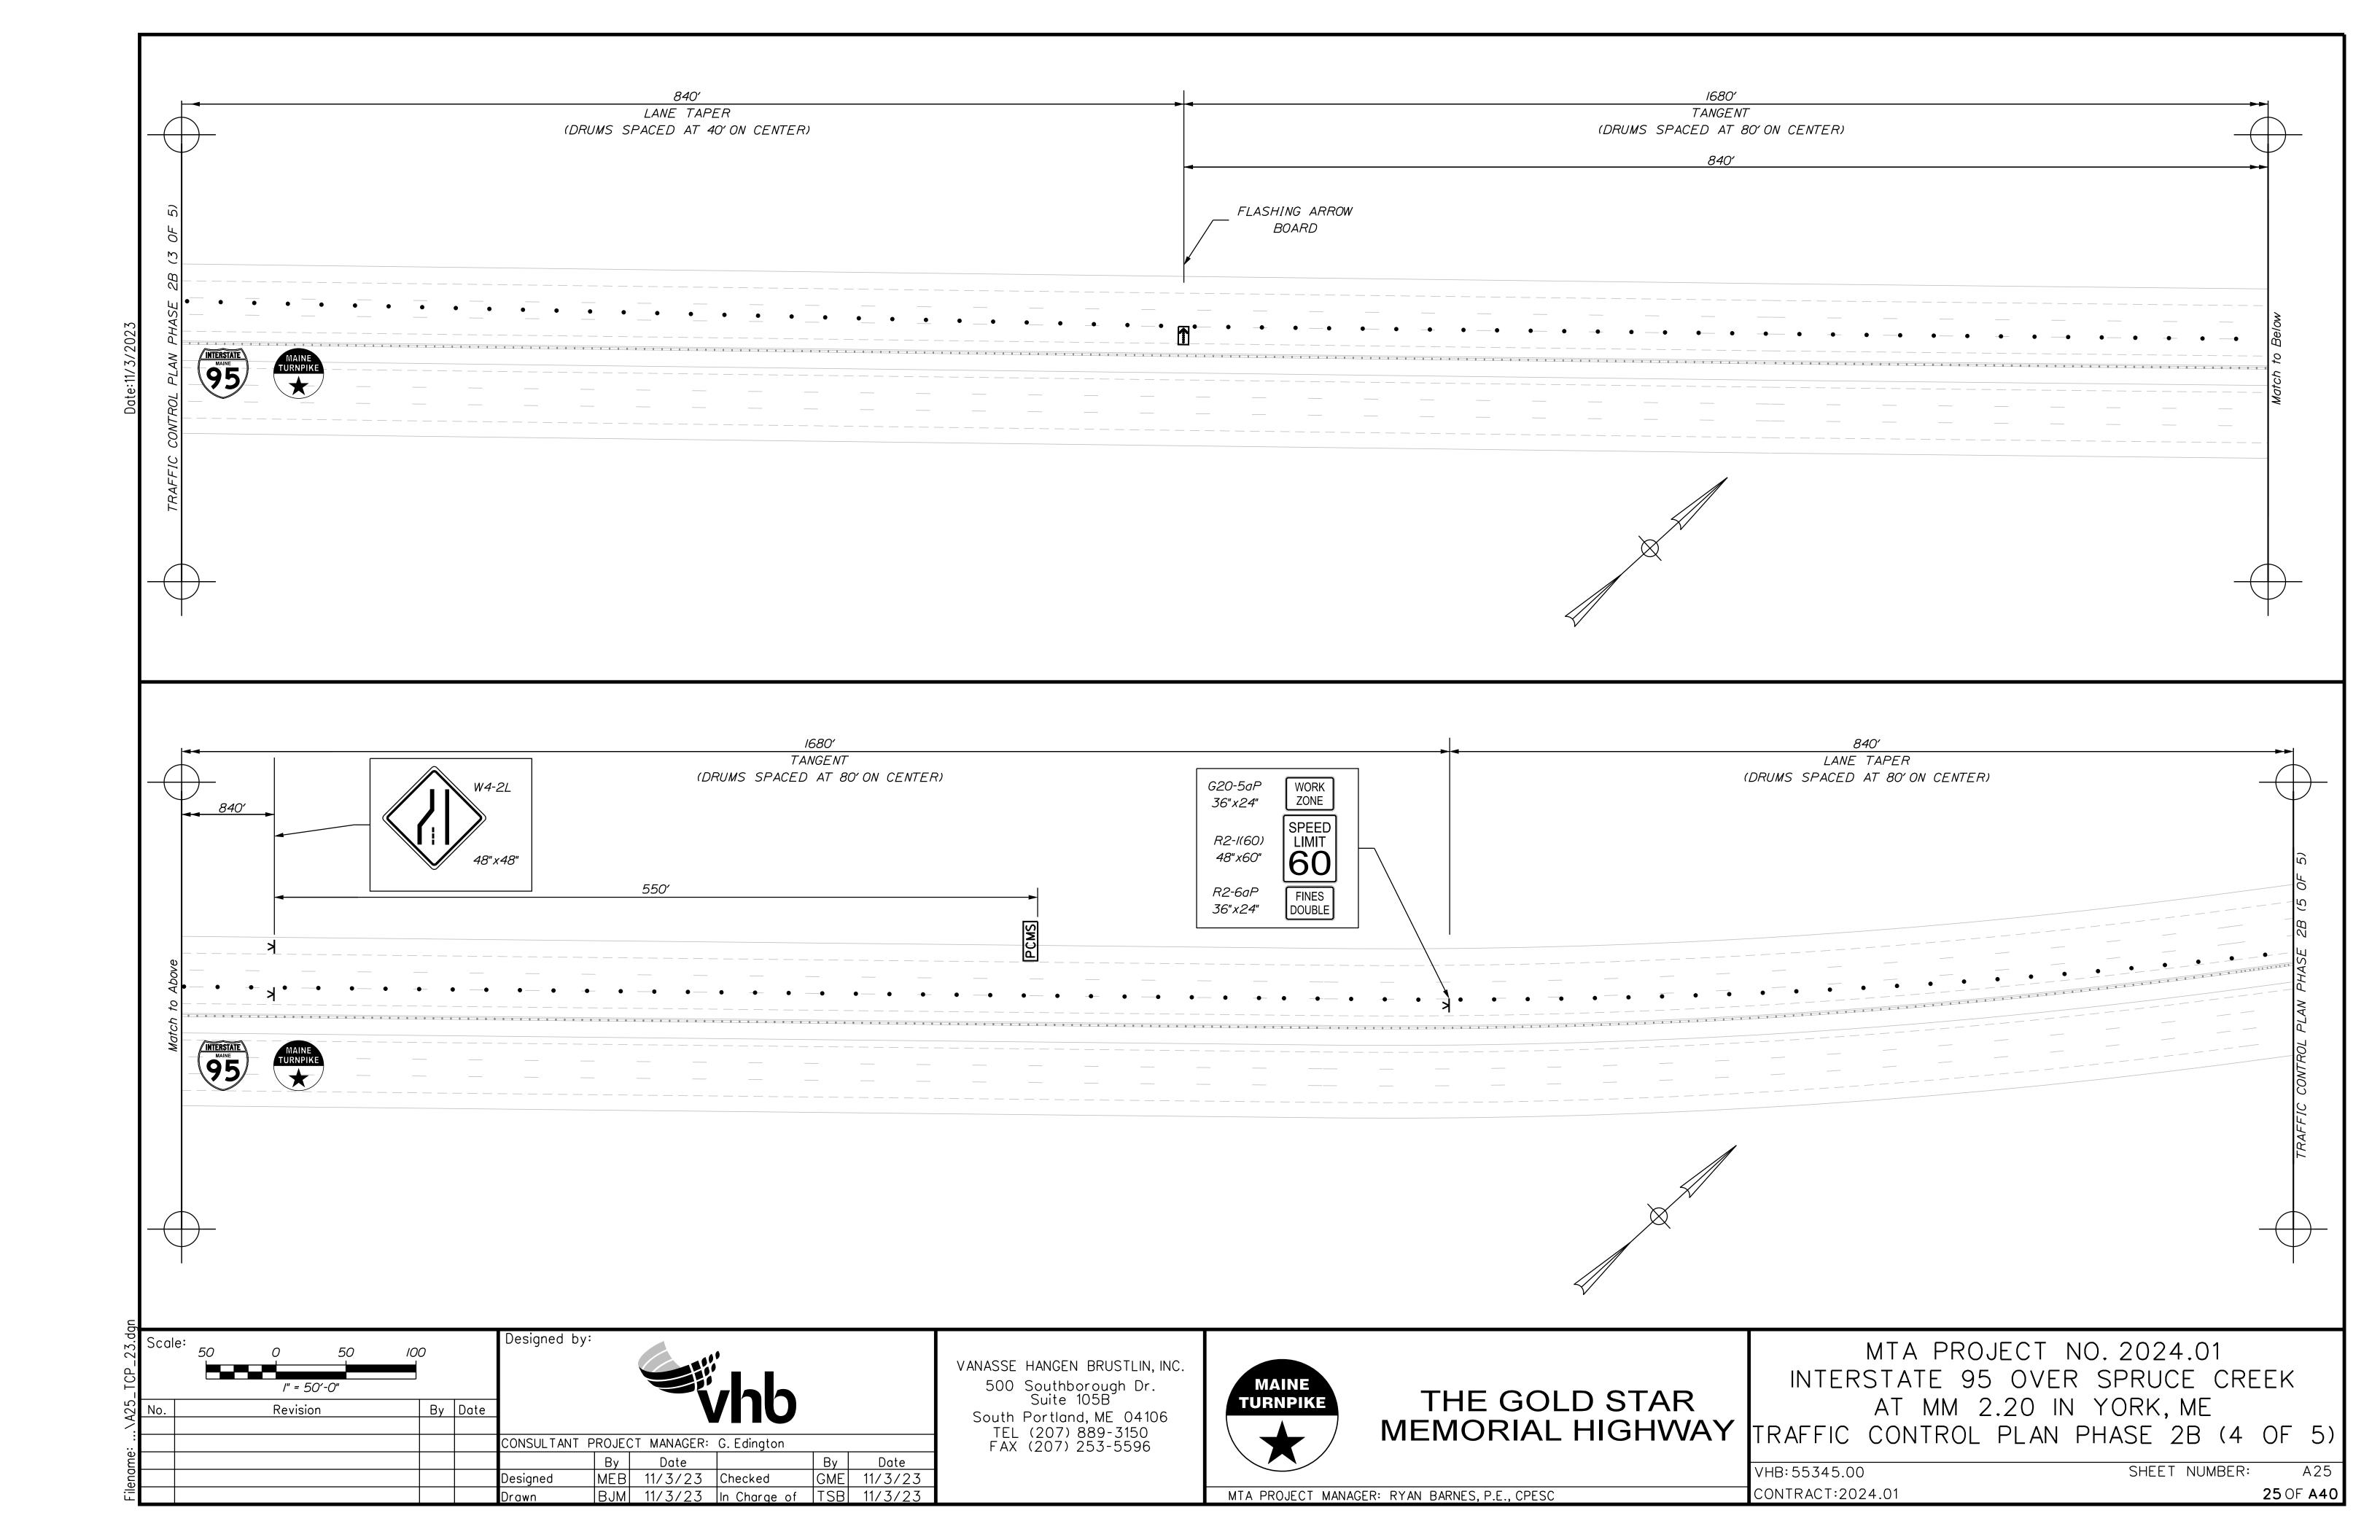

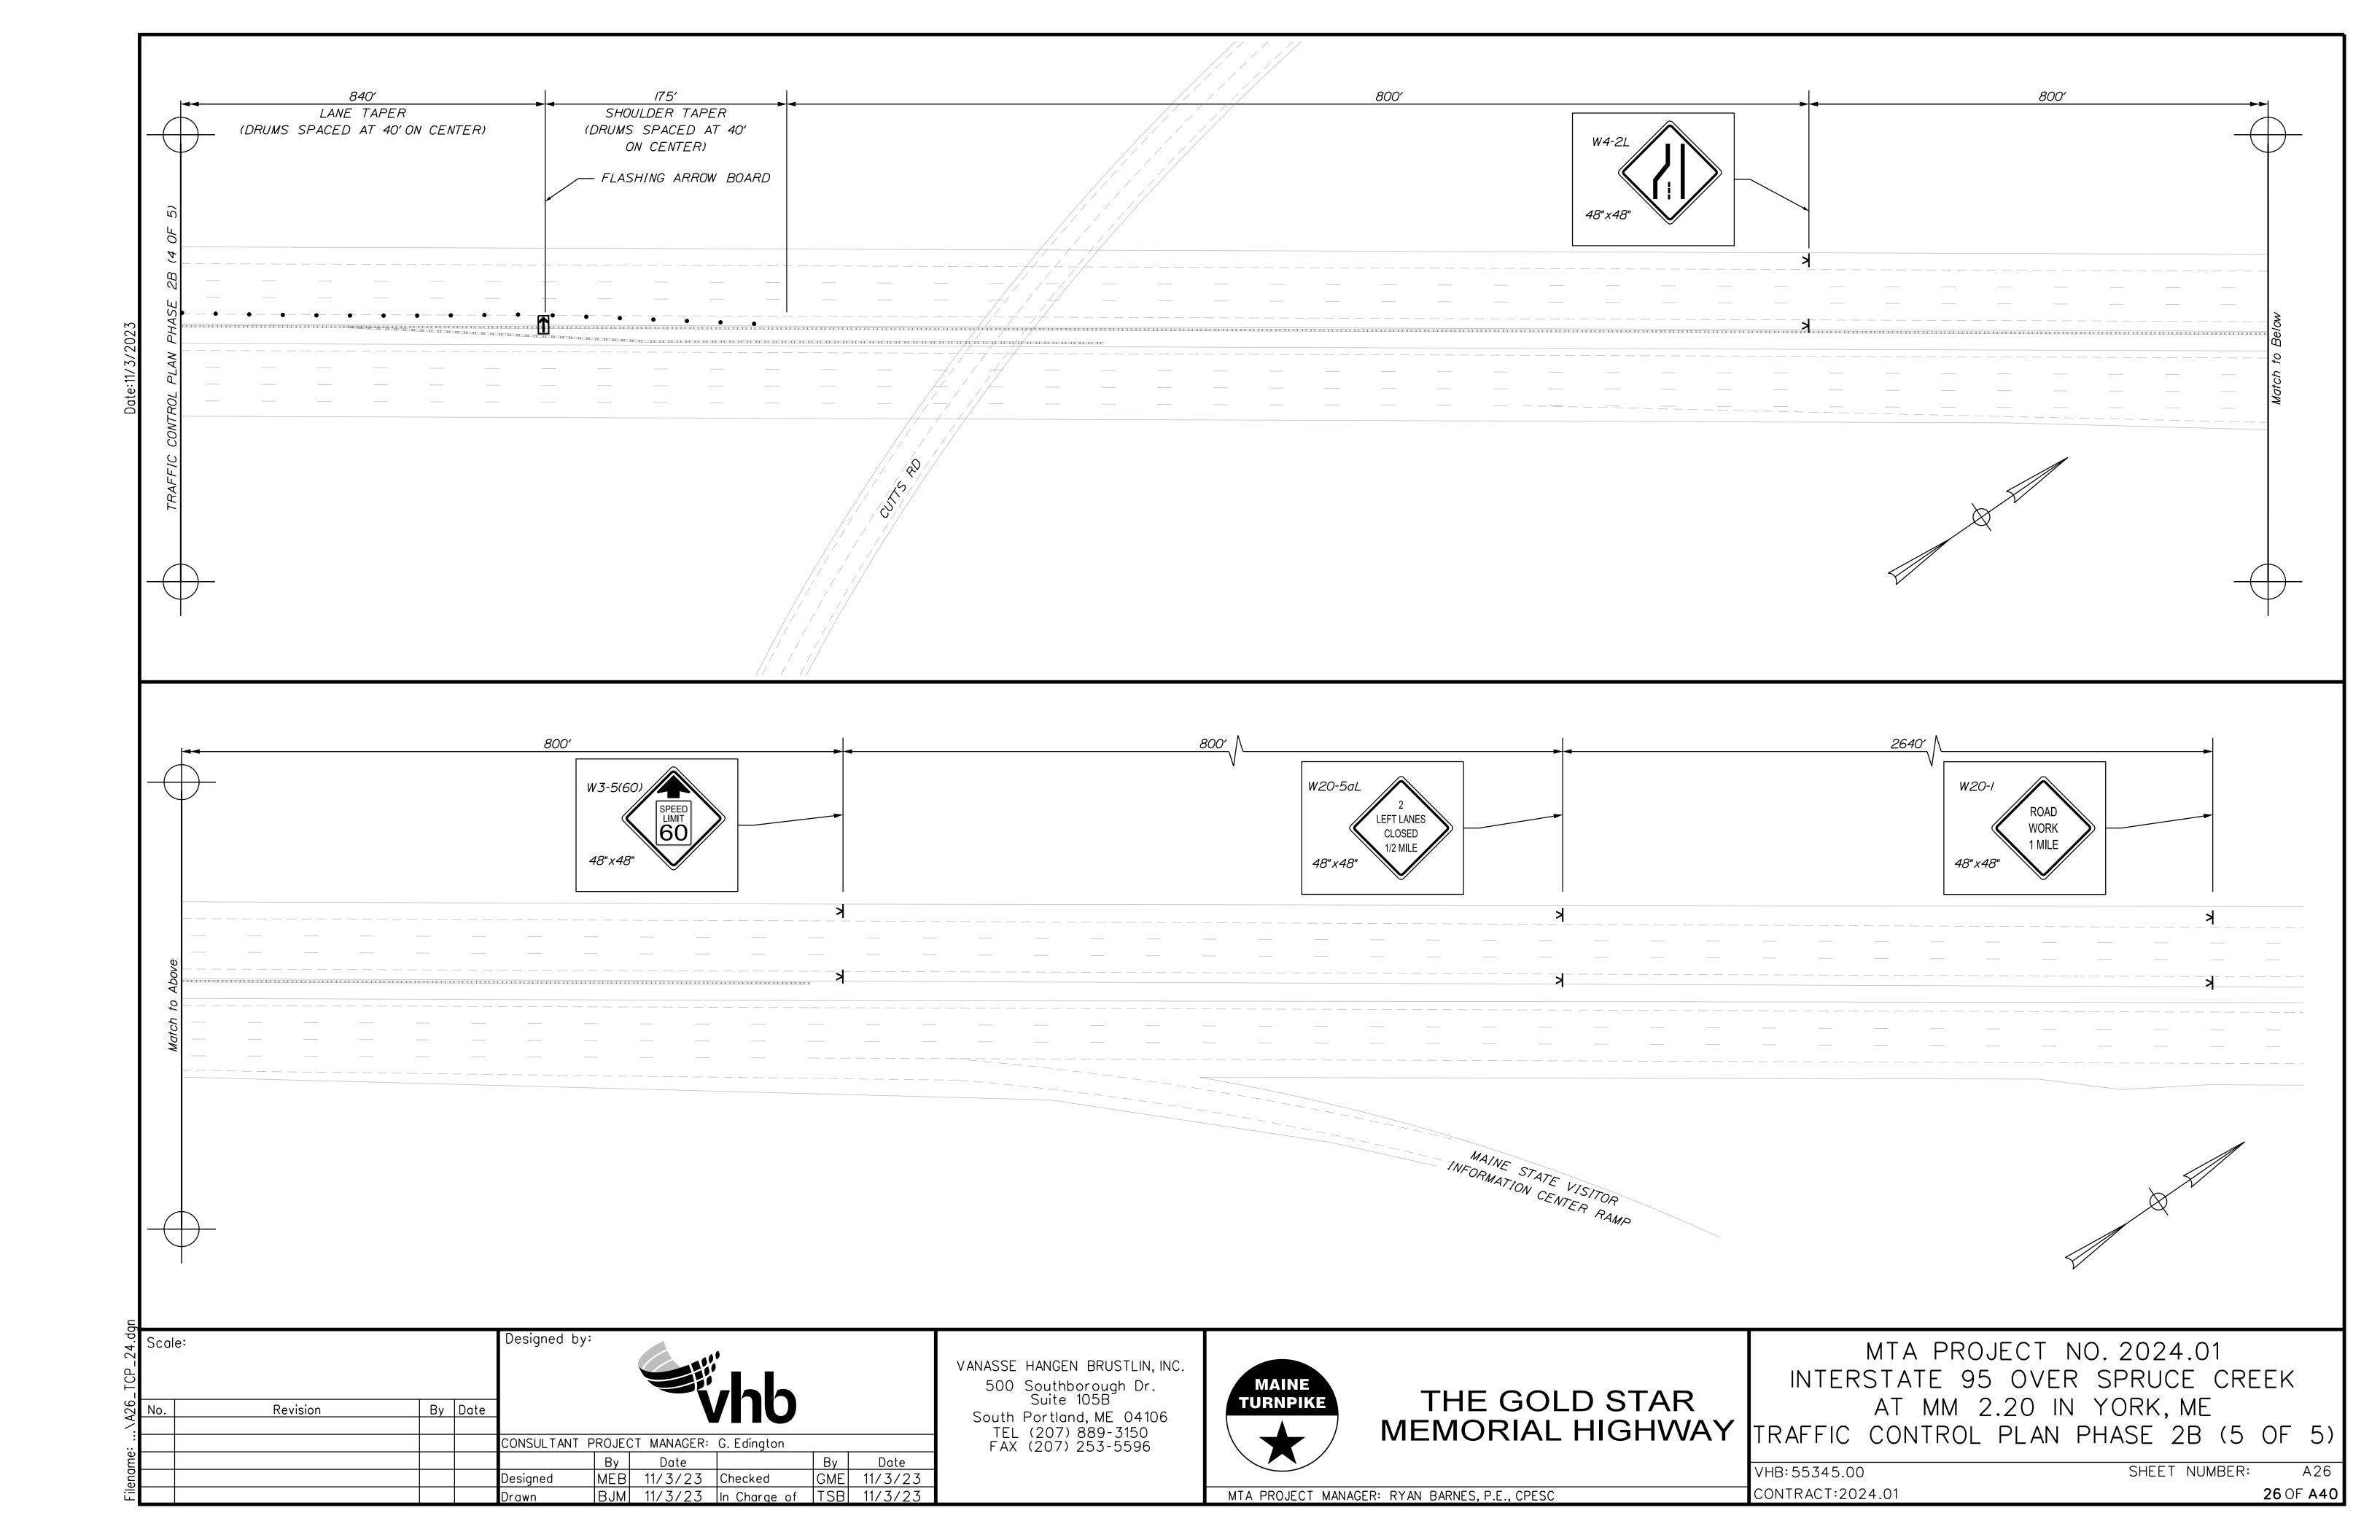

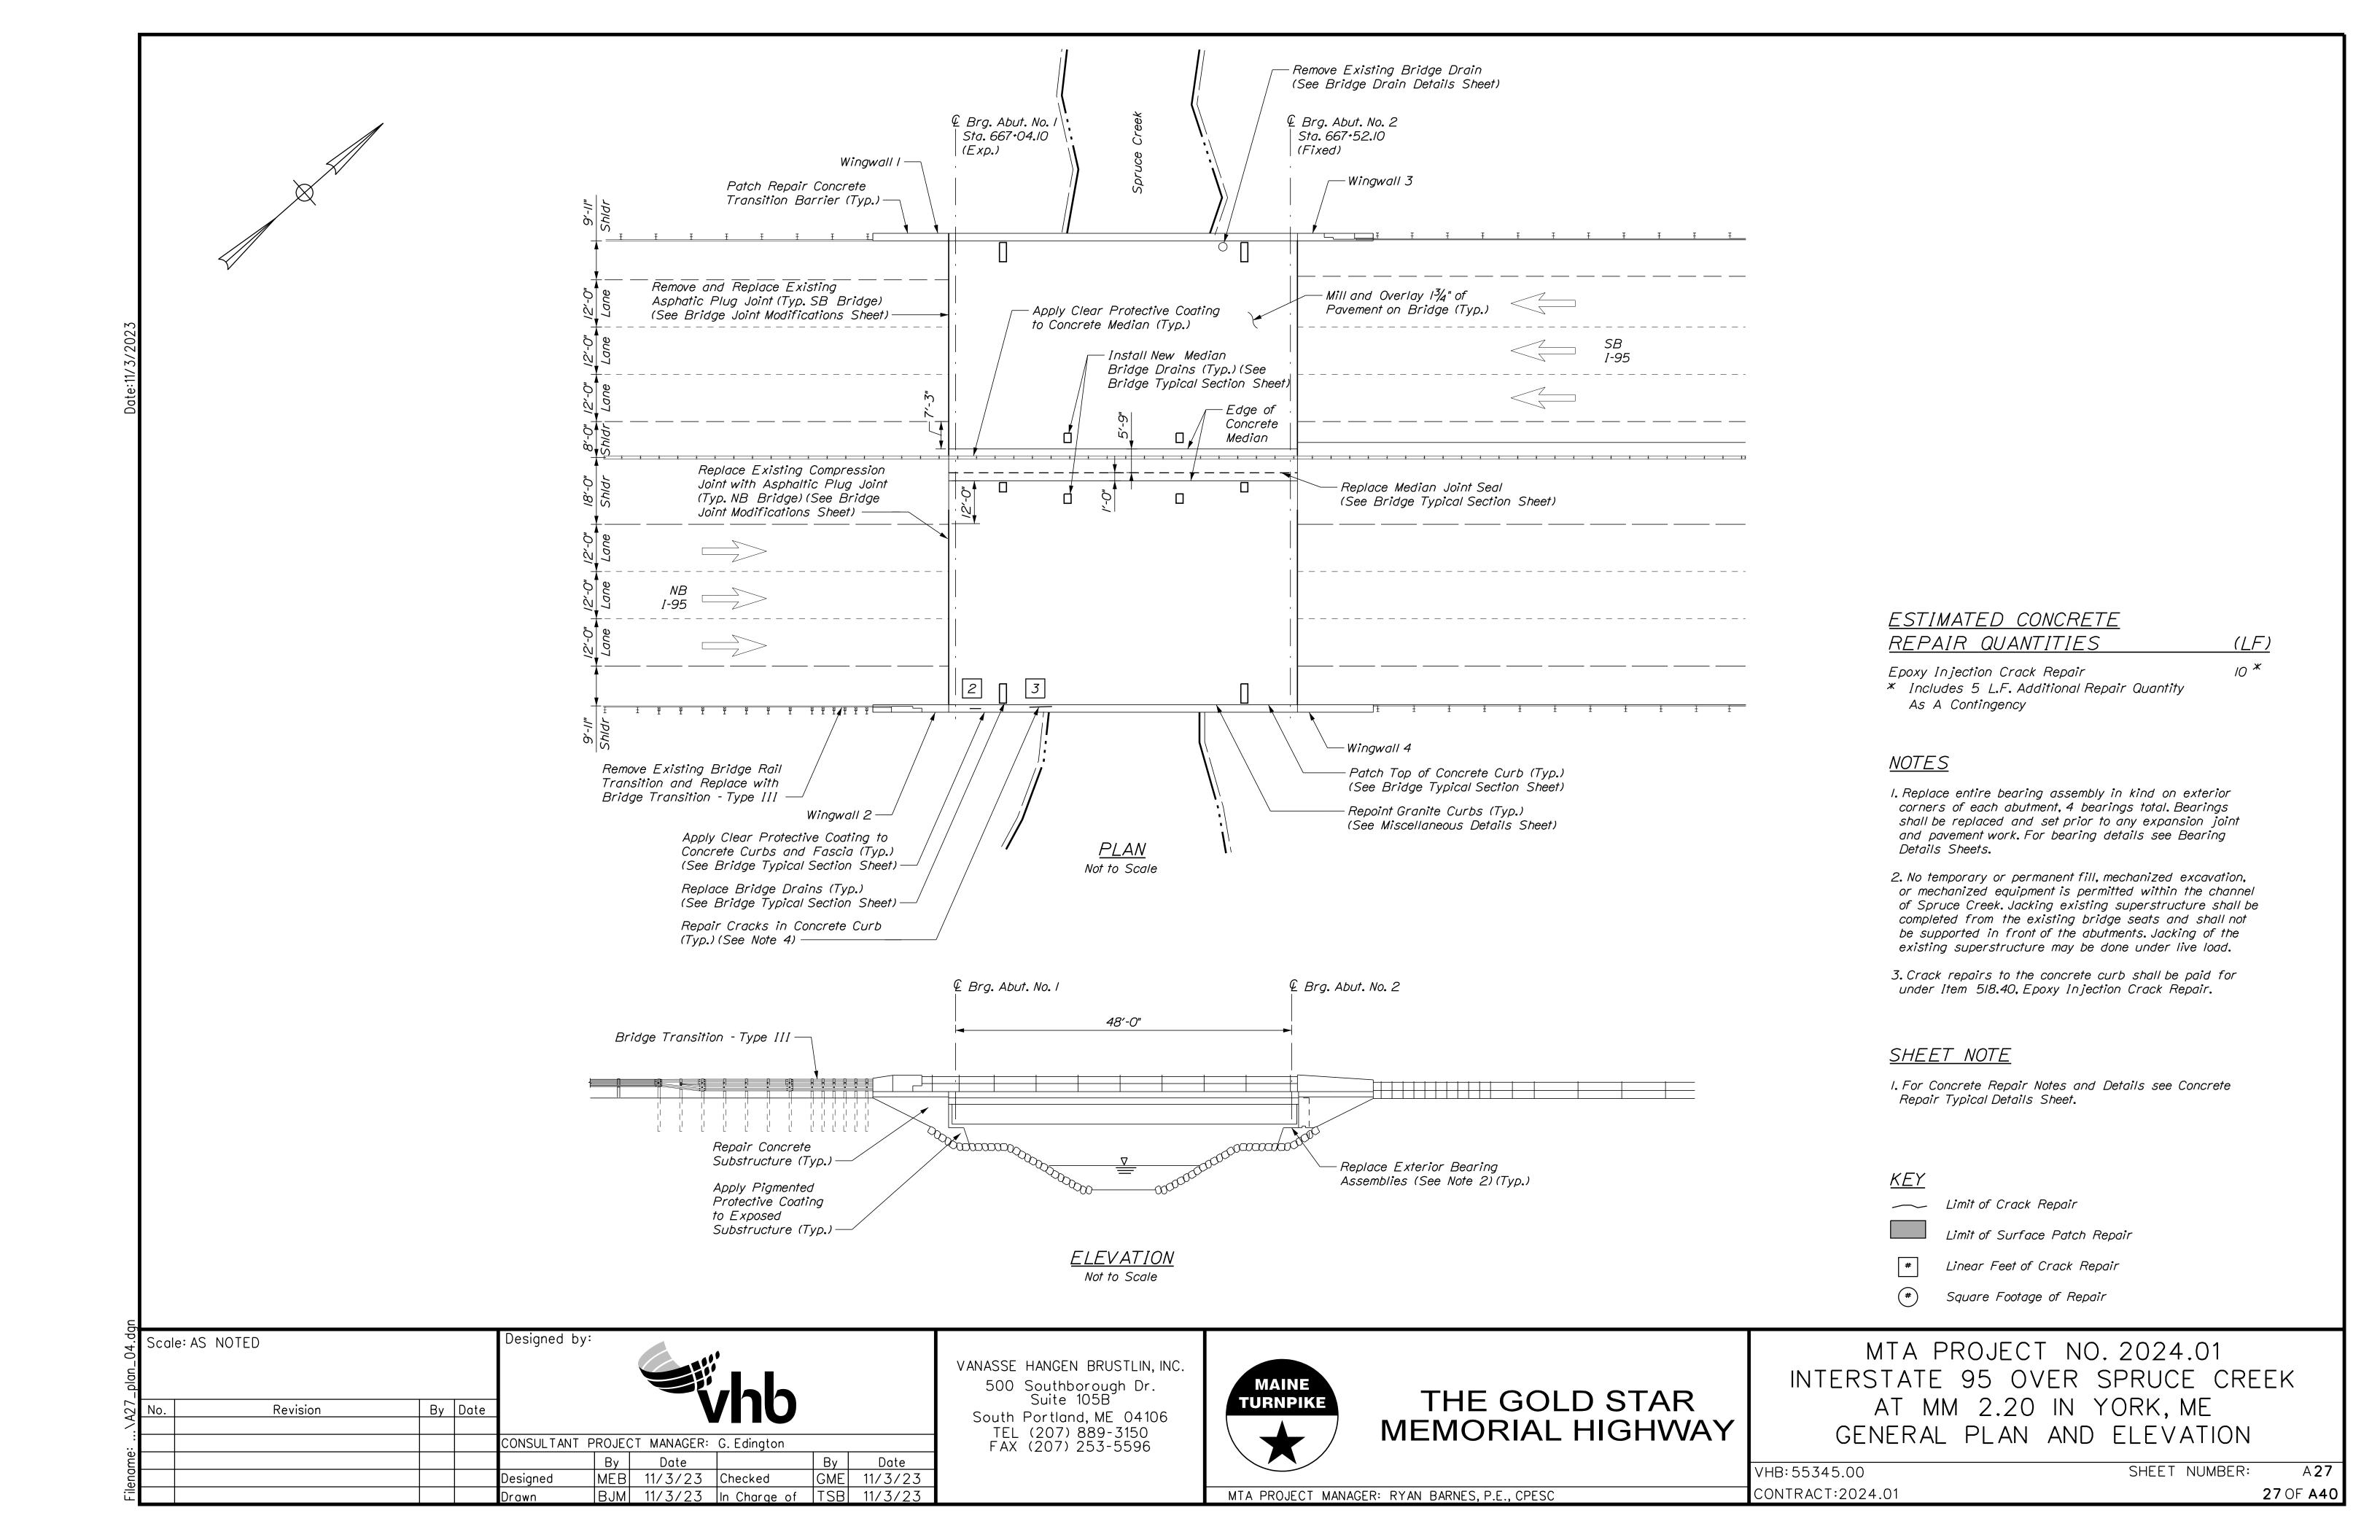

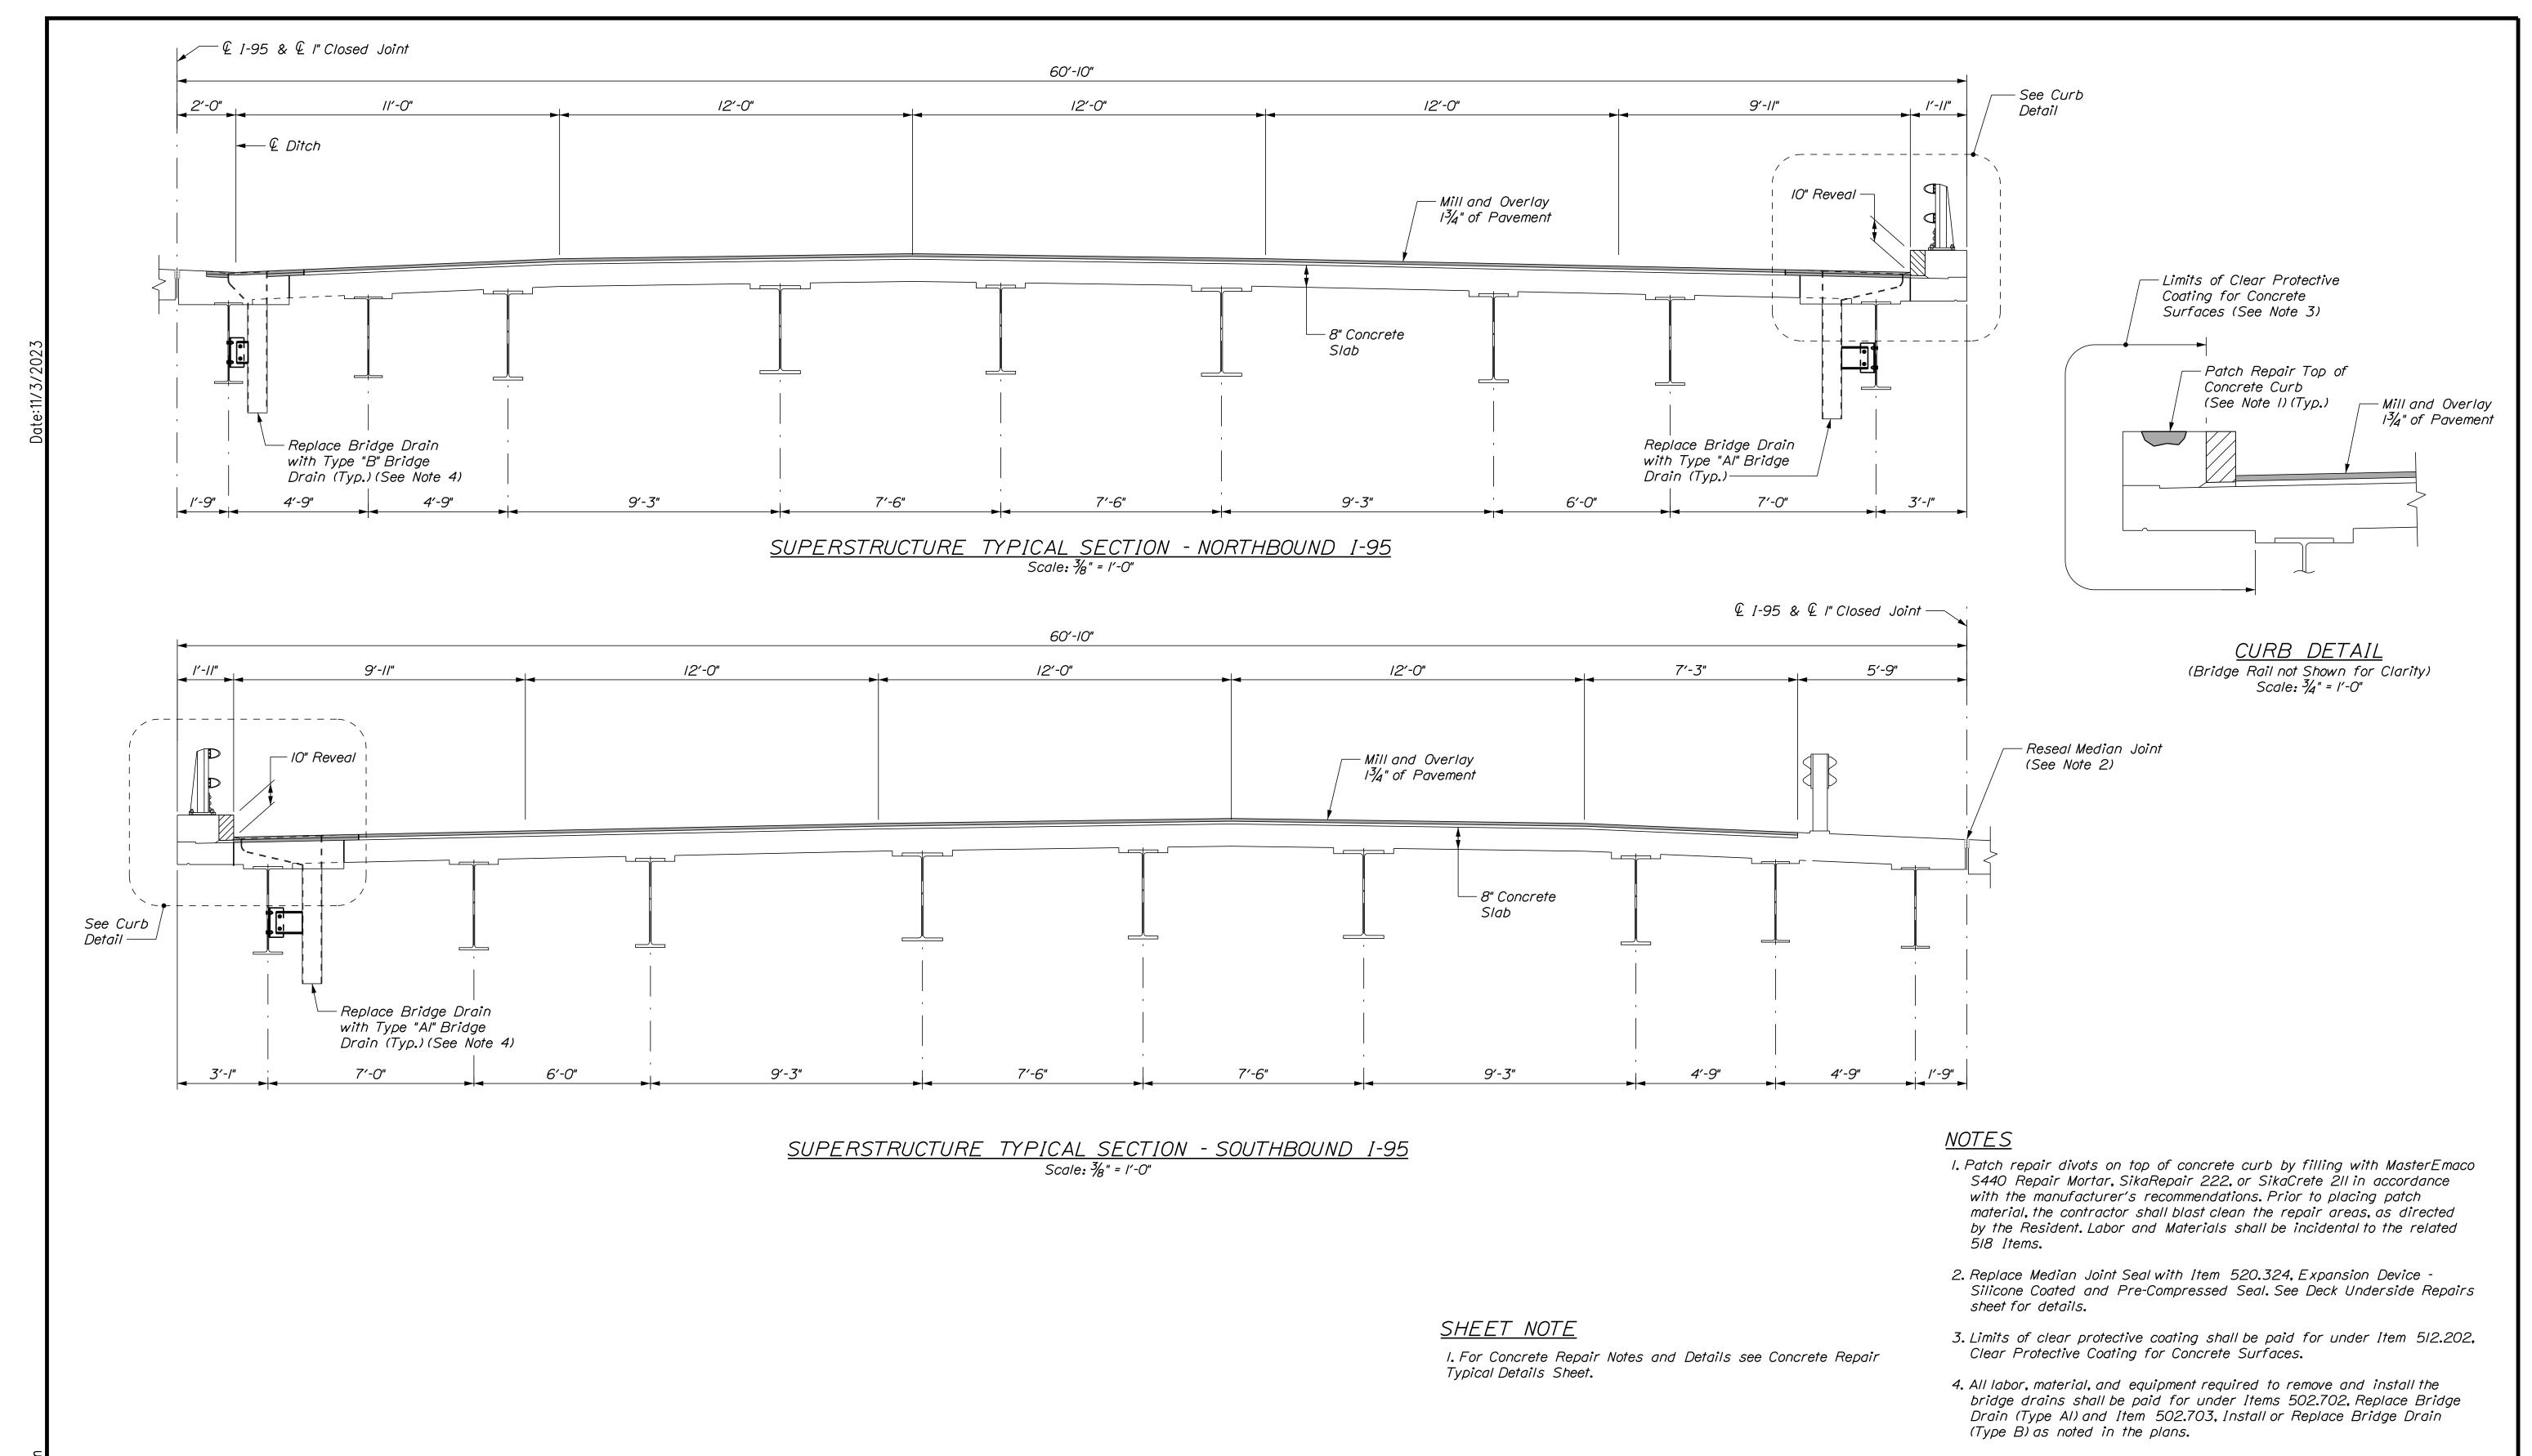

Scale: AS NOTED

Designed by:

No. Revision

By Date

CONSULTANT PROJECT MANAGER: G. Edington

By Date

By Date

Designed MEB 11/3/23 Checked GME 11/3/23


Drawn

BJM 11/3/23 In Charge of TSB 11/3/23

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Suite 105B

South Portland, ME 04106
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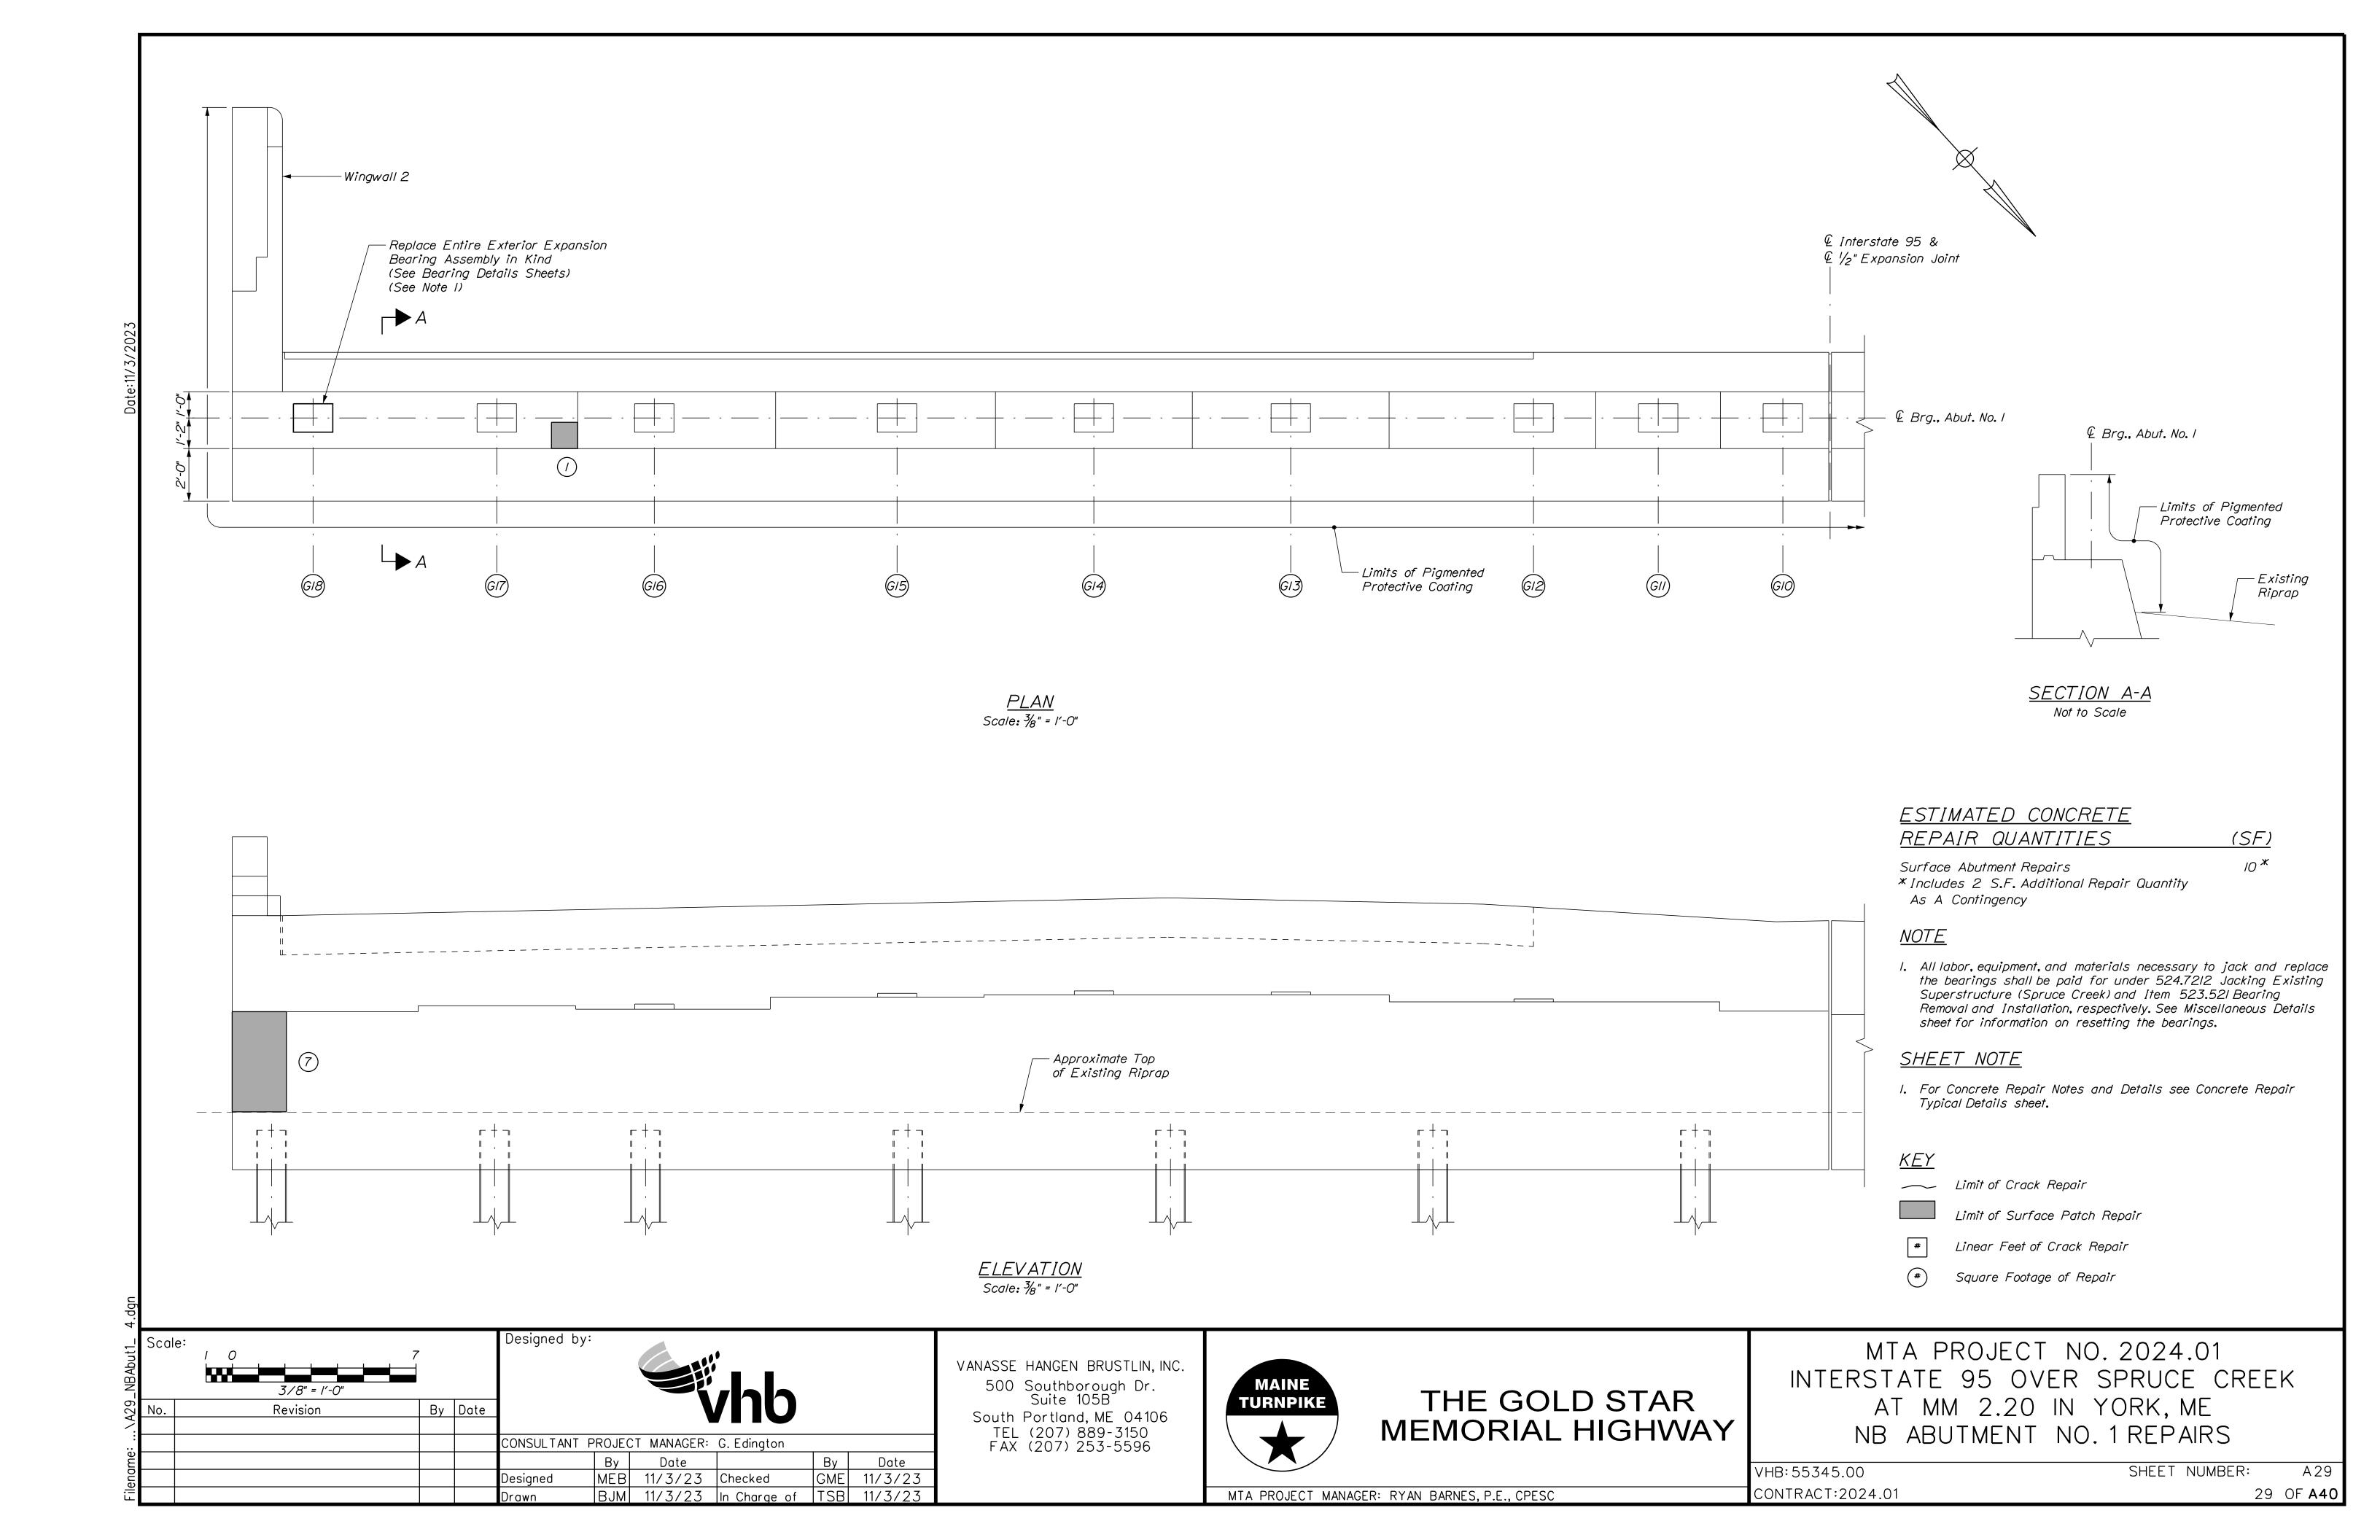



THE GOLD STAR
MEMORIAL HIGHWAY

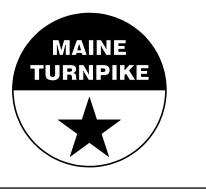
MTA PROJECT NO. 2024.01
INTERSTATE 95 OVER SPRUCE CREEK
AT MM 2.20 IN YORK, ME
BRIDGE TYPICAL SECTION


VHB: 55345.00 CONTRACT:2024.01 SHEET NUMBER: A 28 28 OF **A40**


MTA PROJECT MANAGER: RYAN BARNES, P.E., CPESC




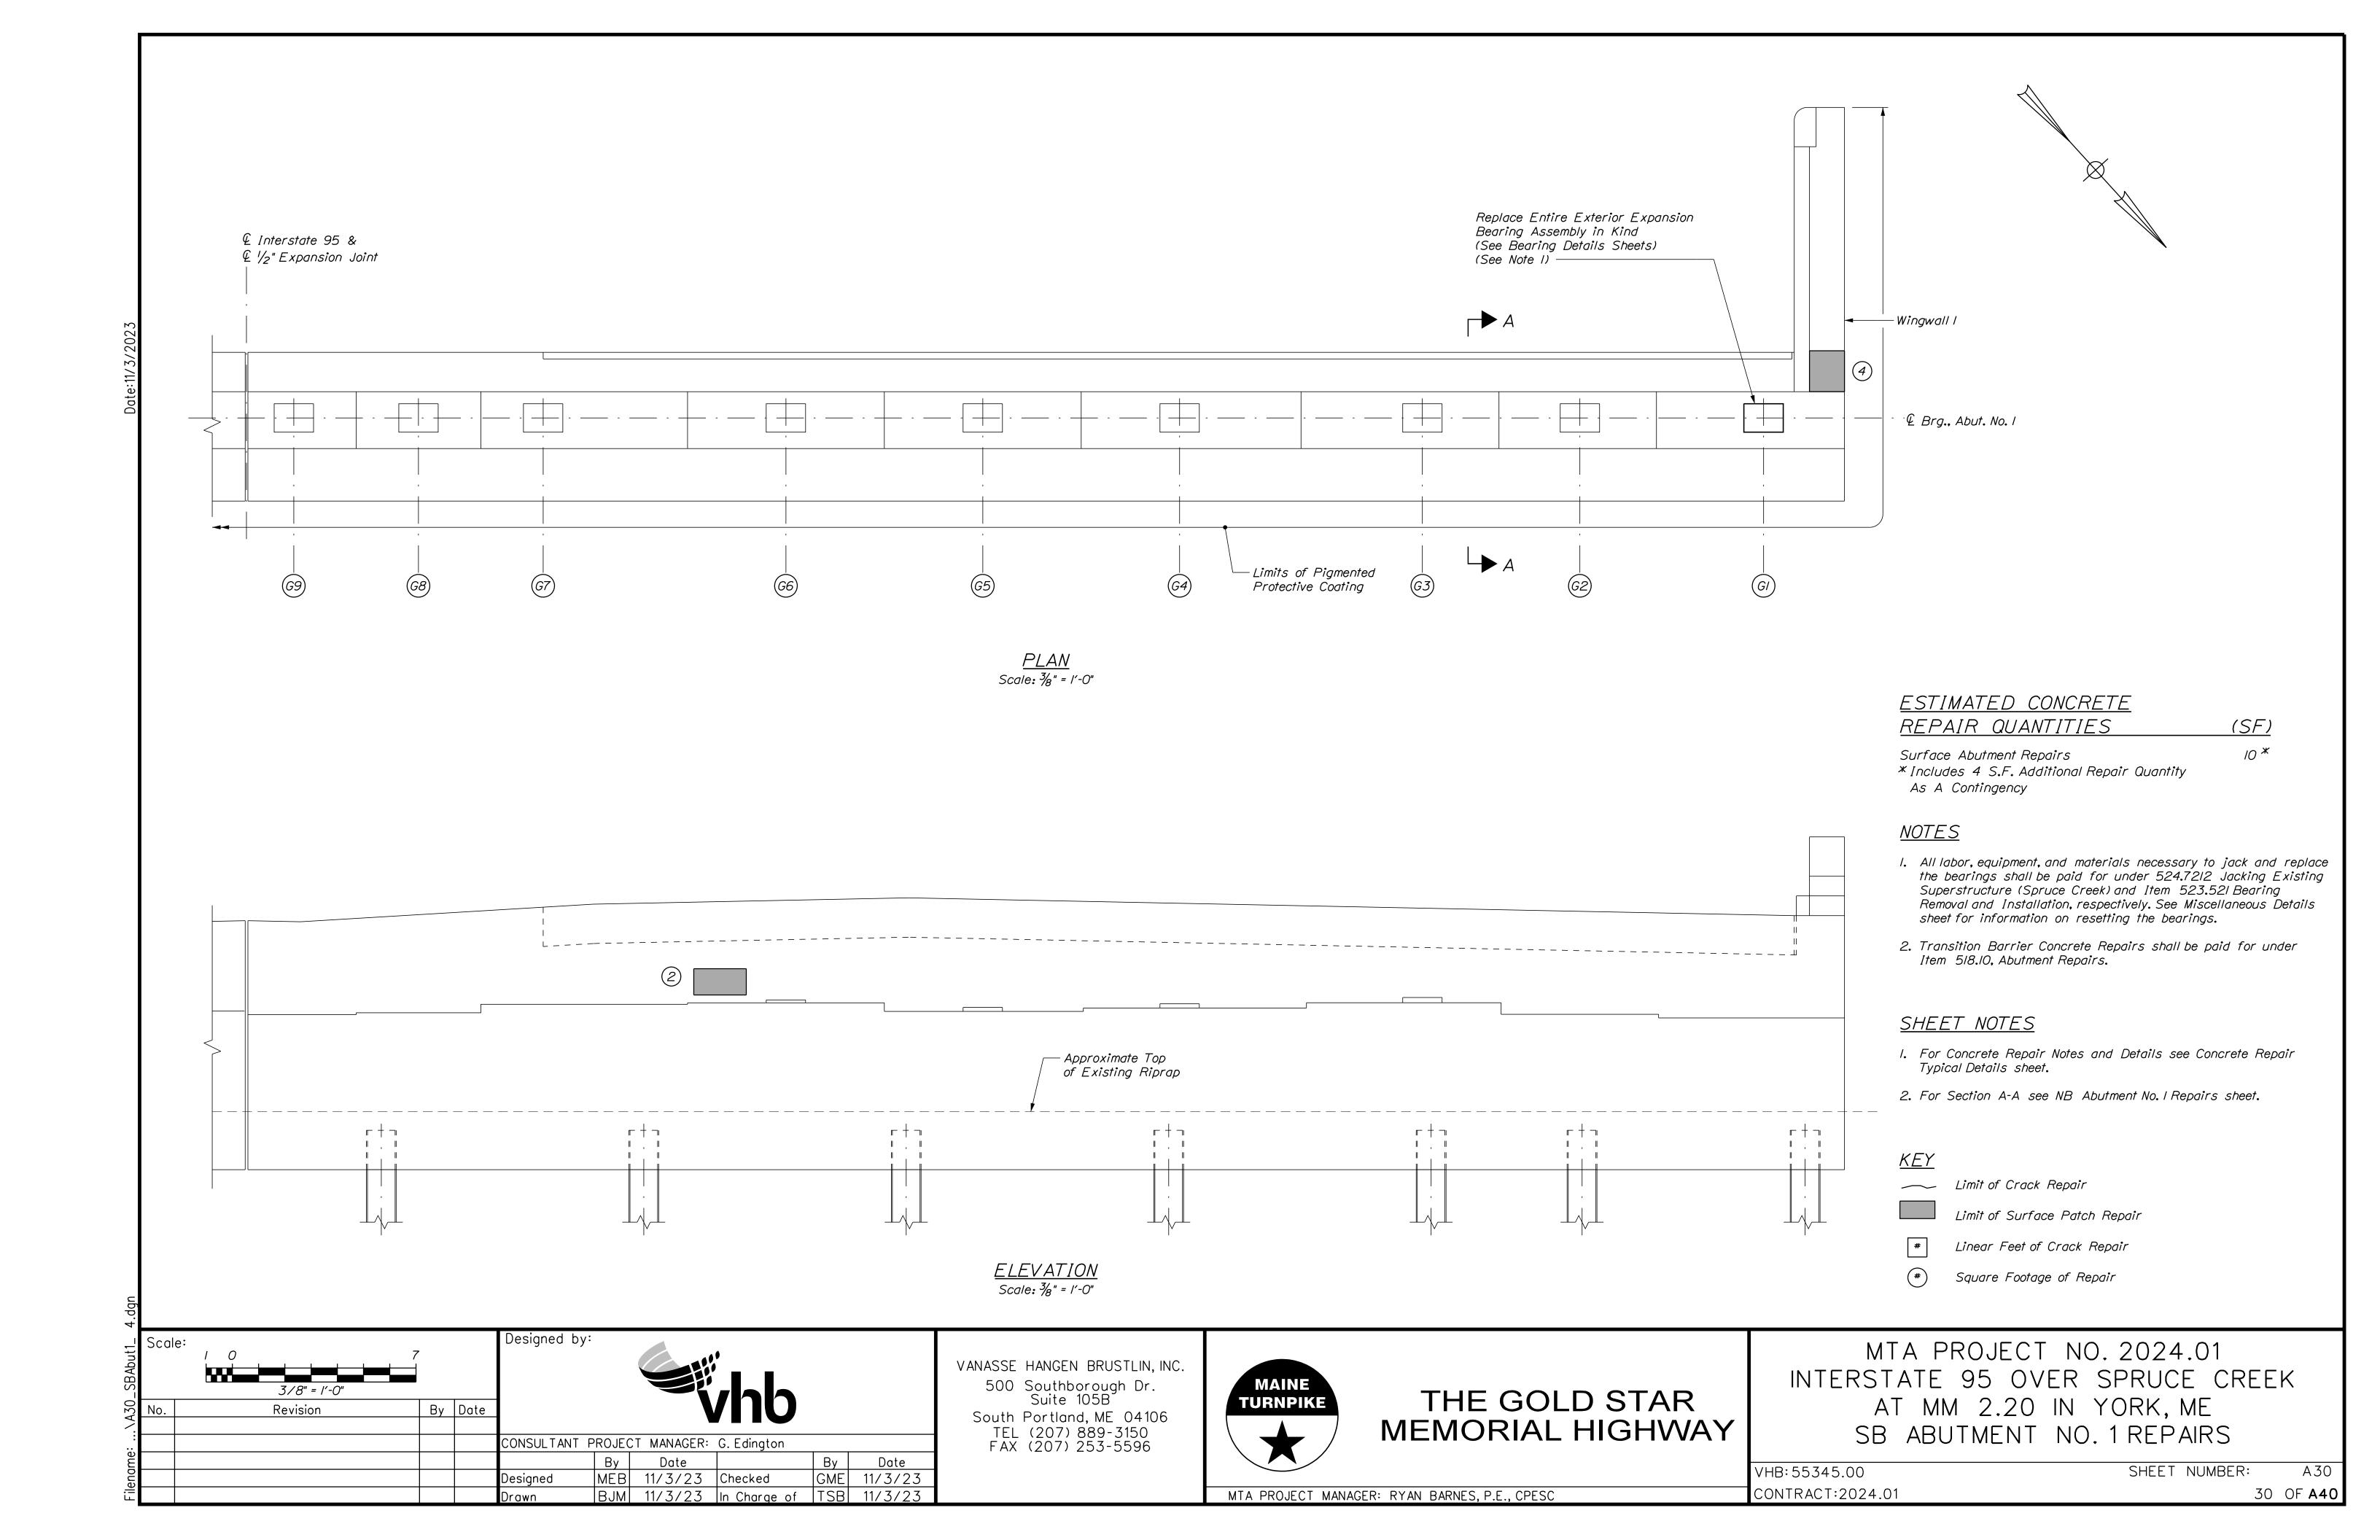

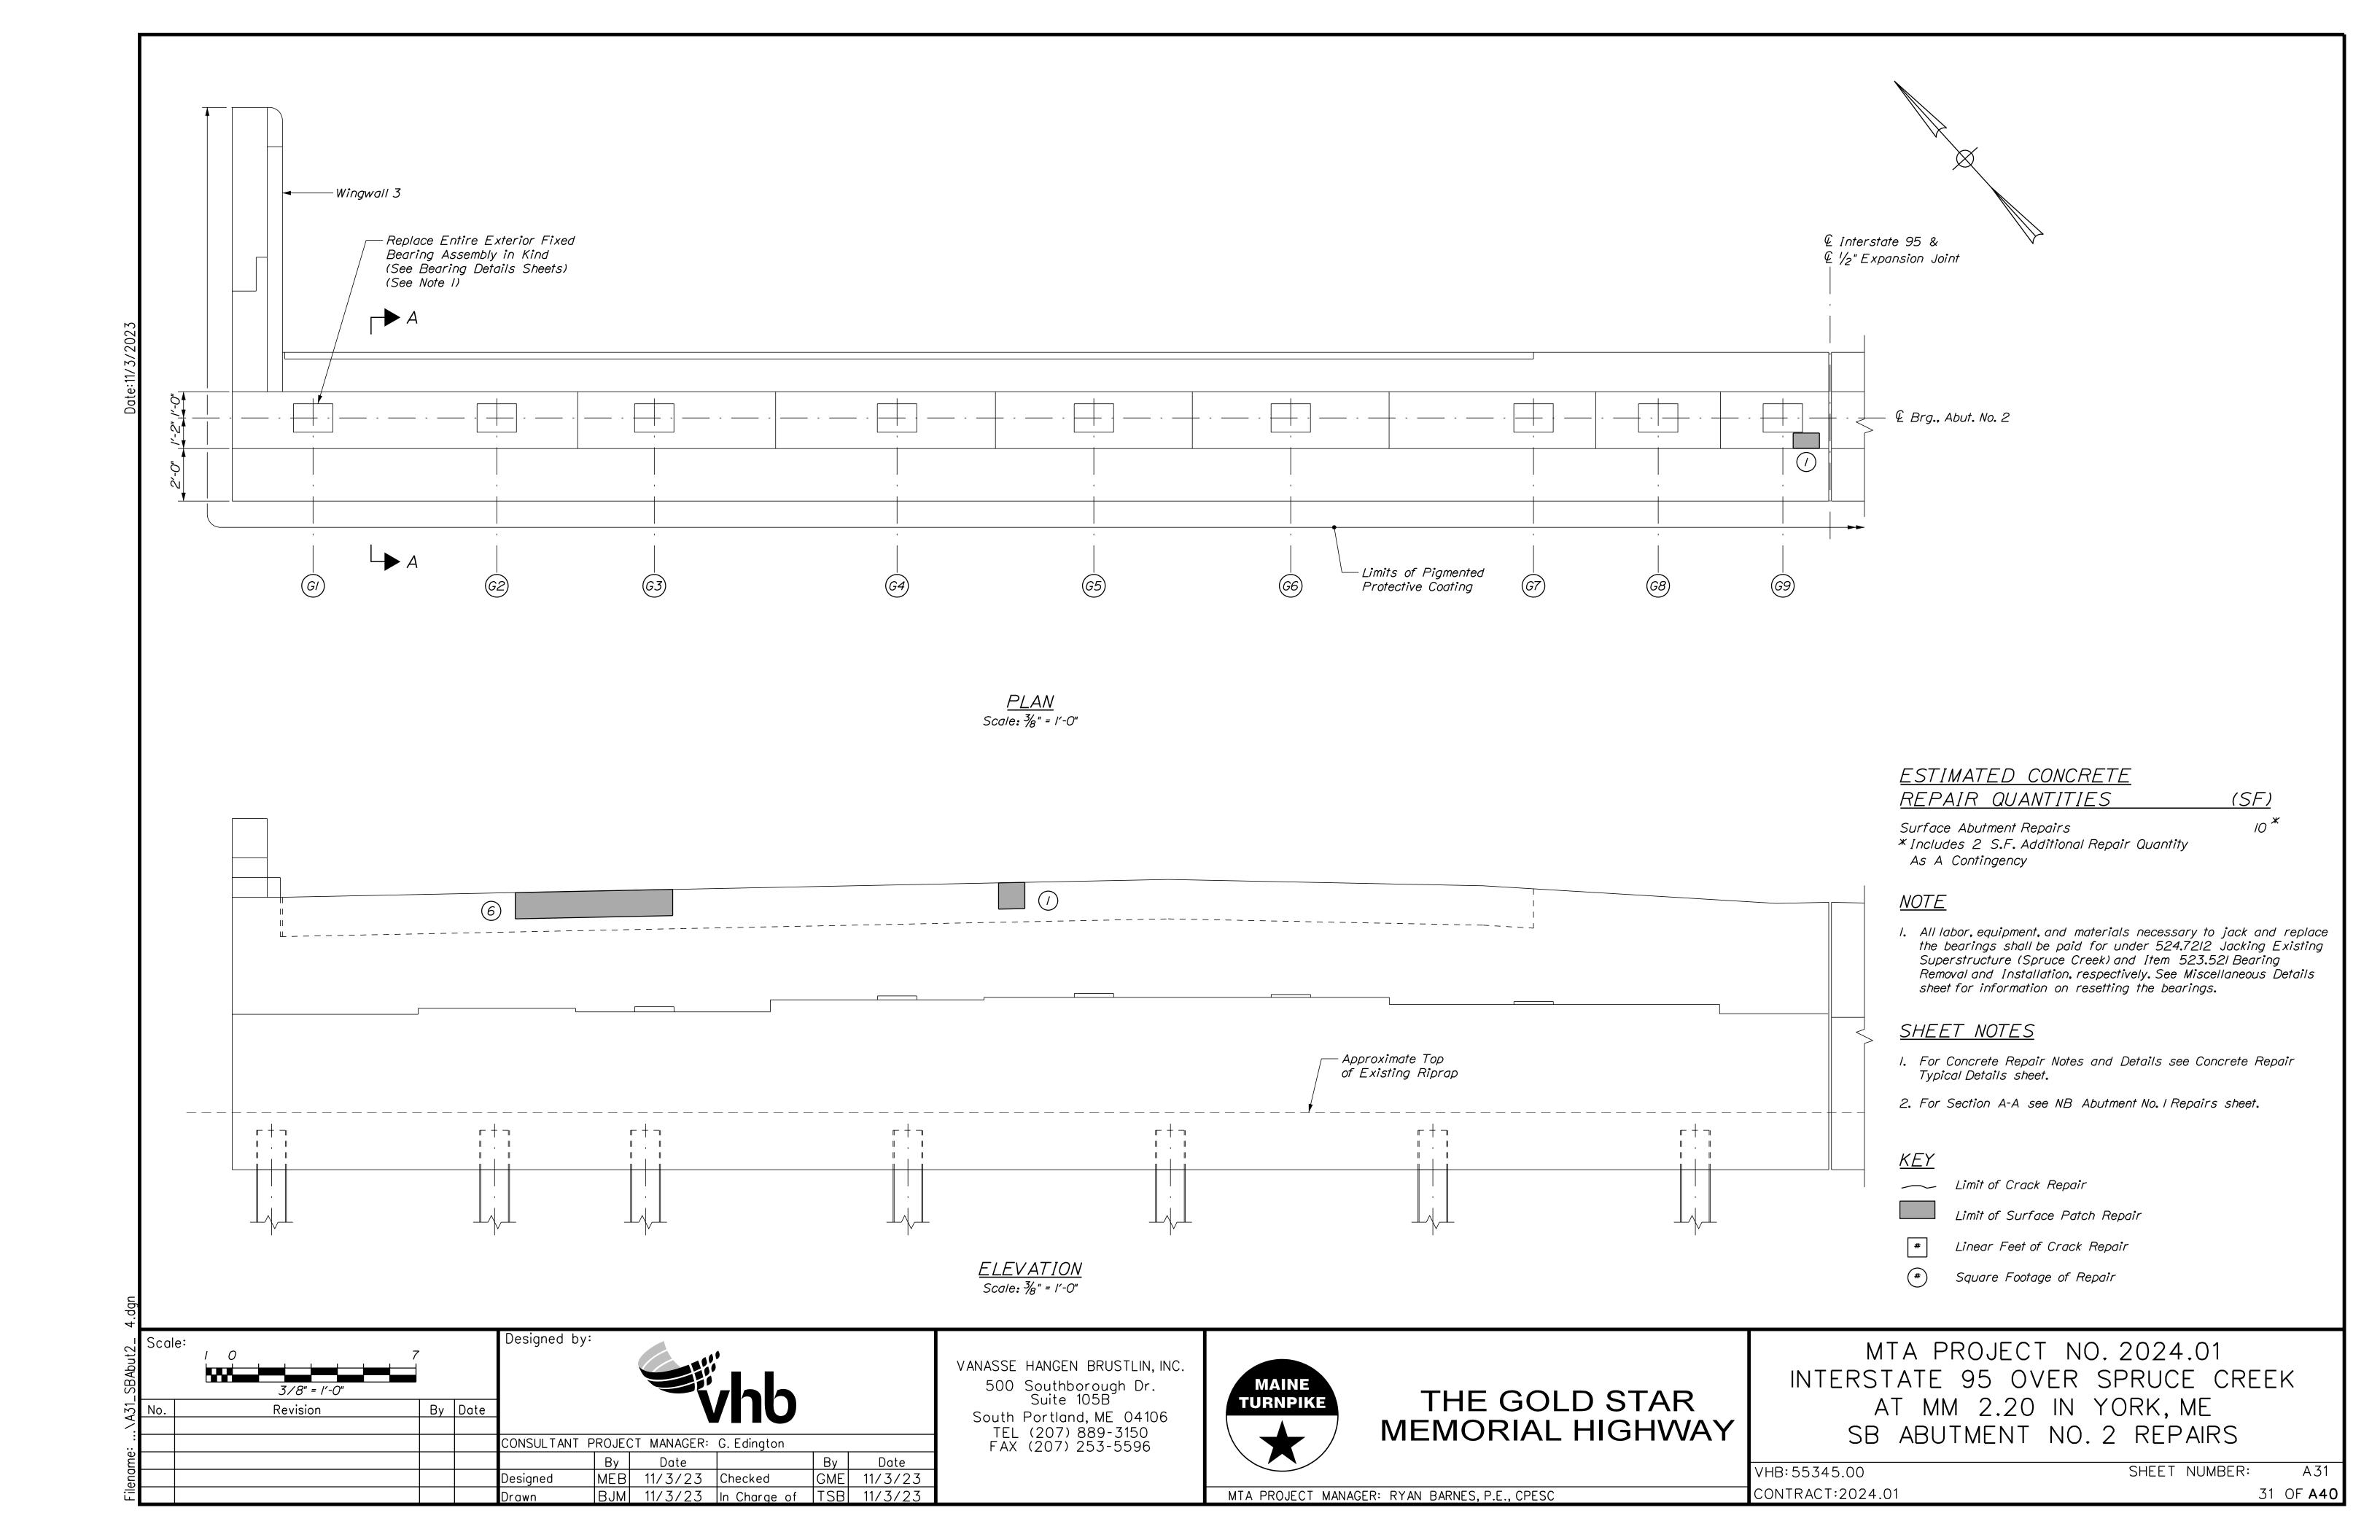

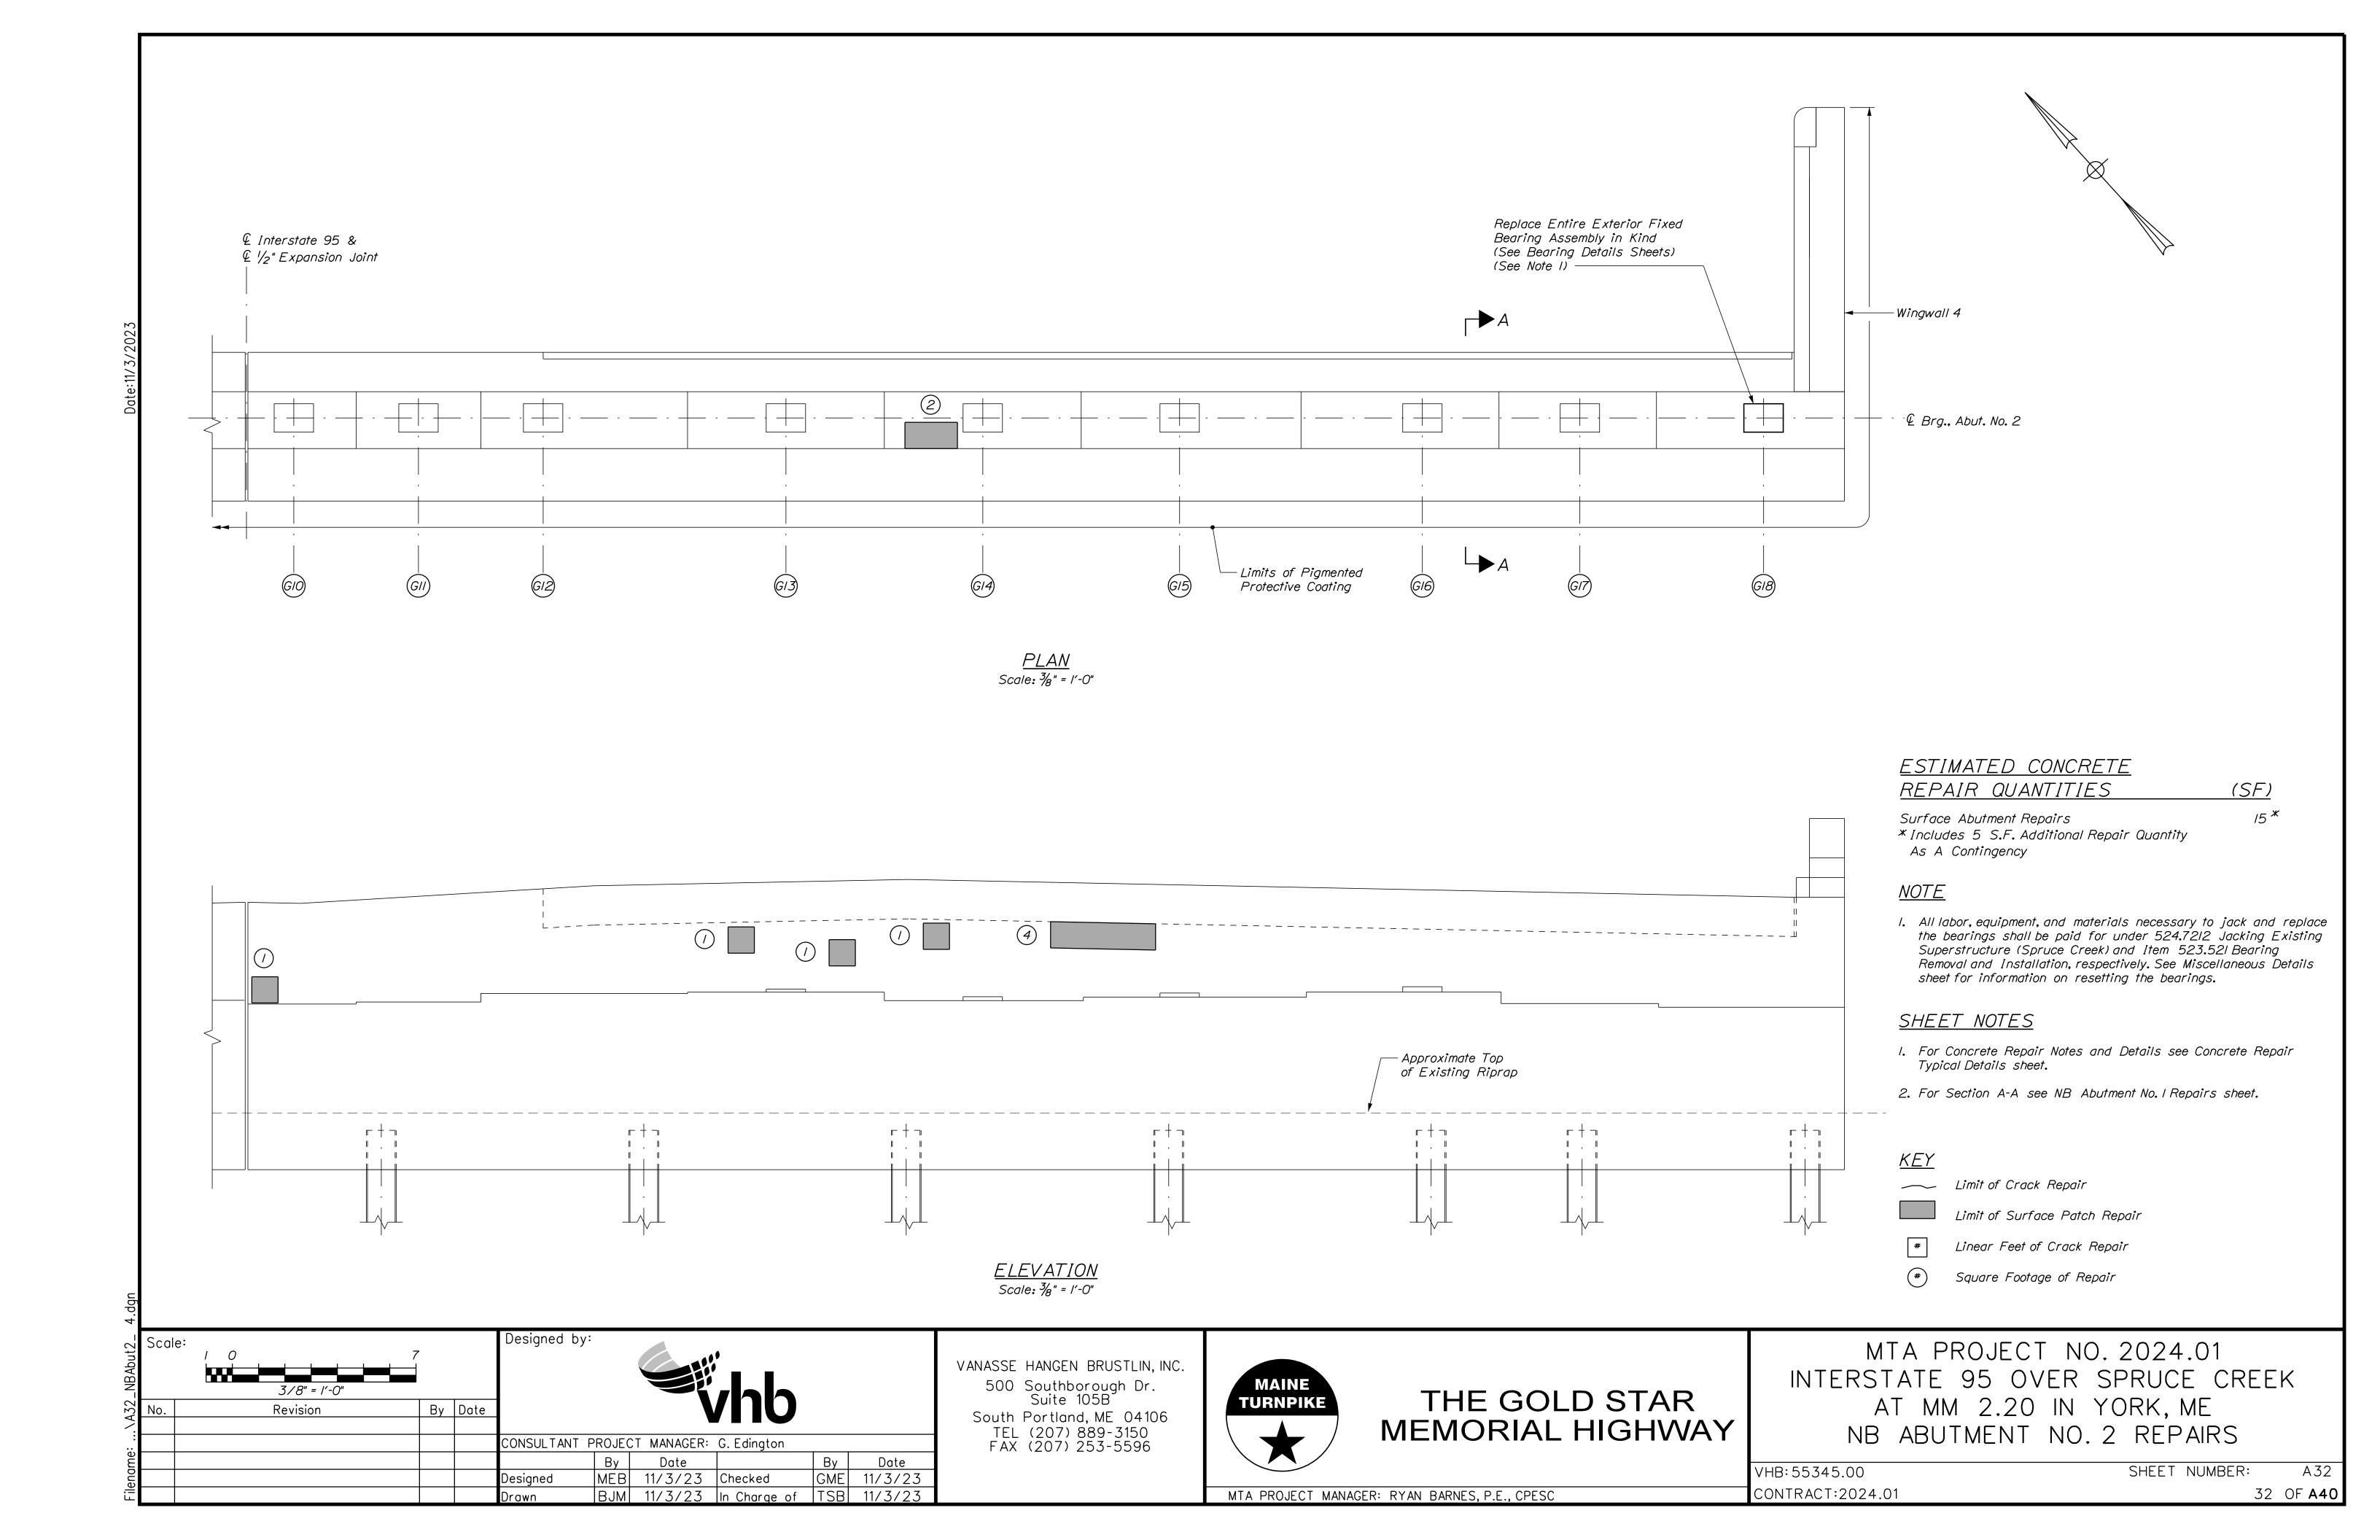

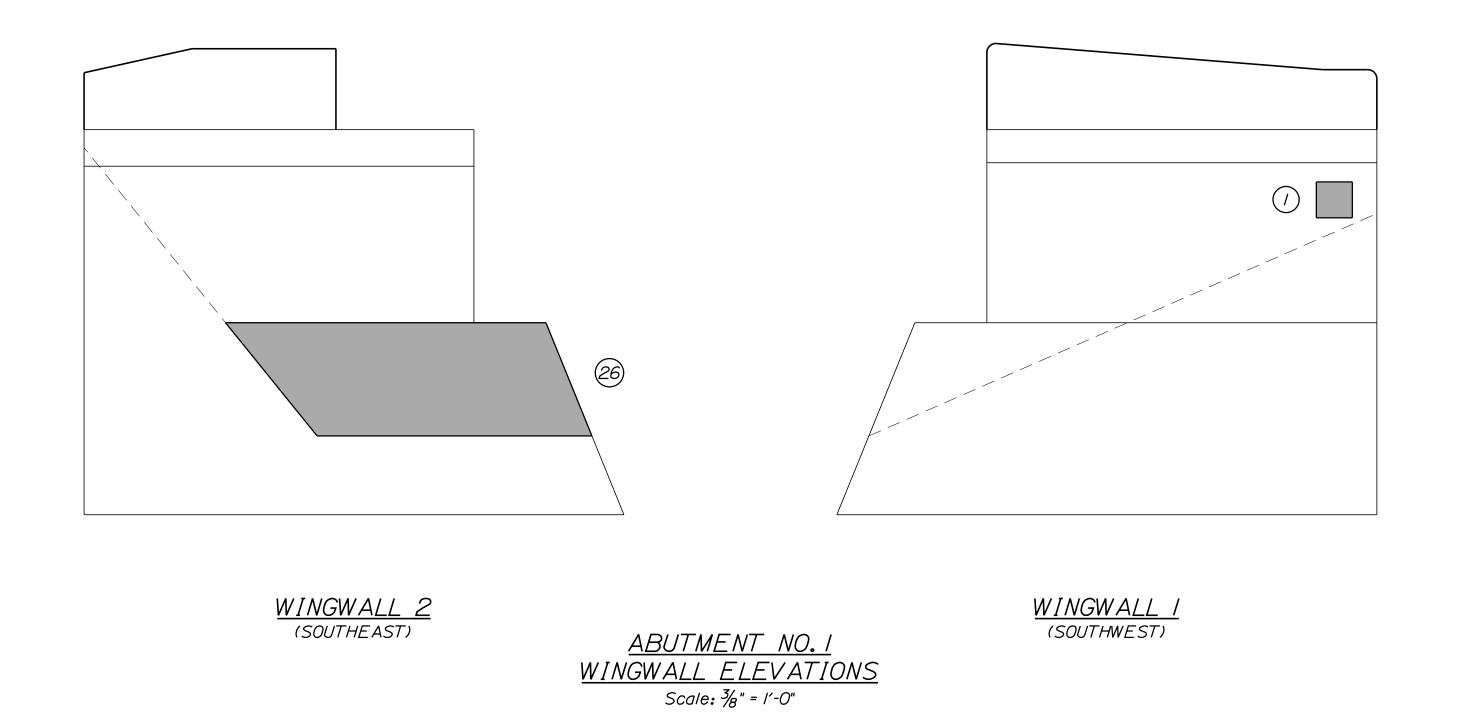

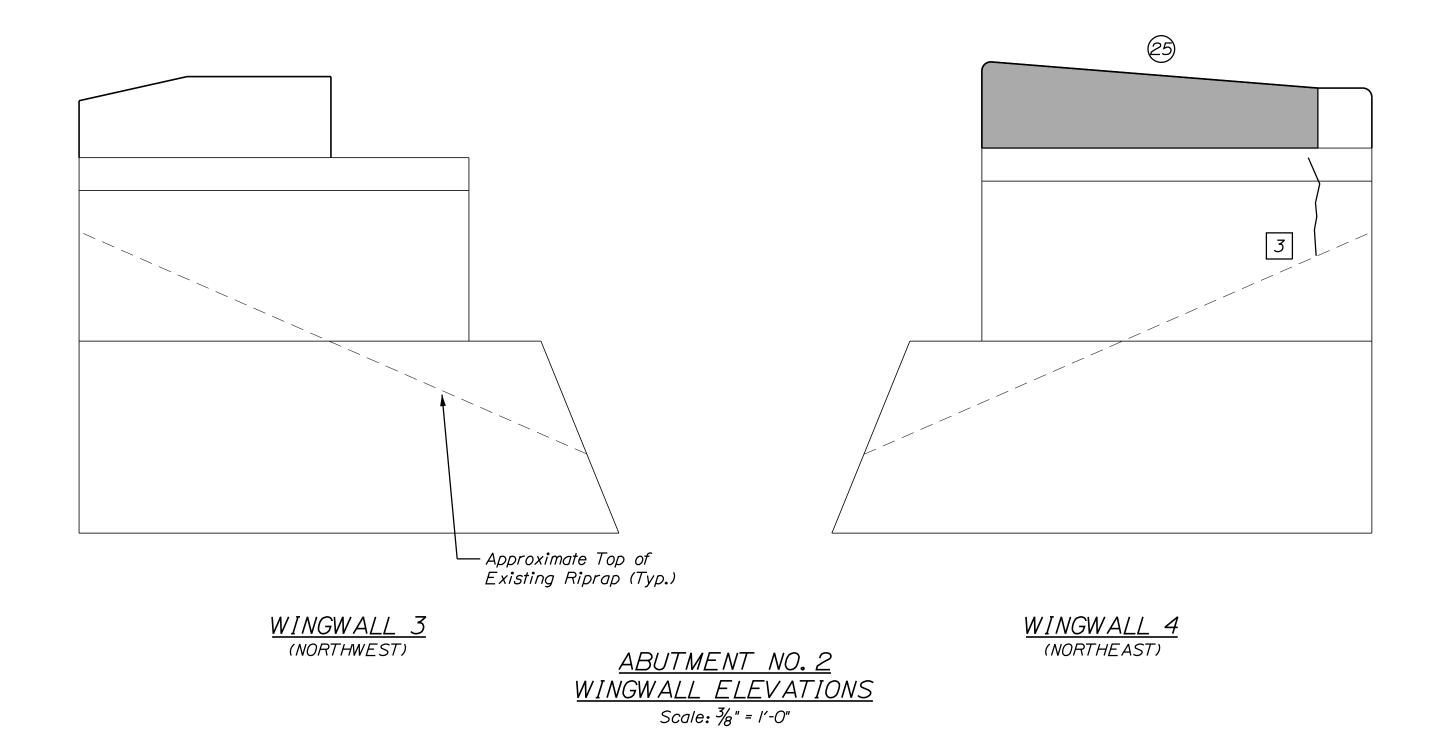

Epoxy Injection Crack Repair

***Includes 7 L.F. Additional Repair Quantity As A Contingency <u>NOTES</u> I. Wingwall and Transition Barrier Concrete Repairs shall be paid for under Item 518.10, Abutment Repairs. 2. At Wingwall 4, the 25 SF of patch repair includes both the interior and exterior faces of the transition barrier. SHEET NOTE I. For Crack and Concrete Repair Notes and Details see Concrete Repair Typical Details Sheet. <u>KEY</u> ____ Limit of Crack Repair Limit of Surface Patch Repair Linear Feet of Crack Repair Square Footage of Repair

ESTIMATED CONCRETE

* Includes 13 S.F. Additional Repair Quantity

(SF/LF)

65 *

10 **


REPAIR QUANTITIES

Surface Abutment Repairs

As A Contingency

Scale:		7		Designed b	y:				
No.	<i>3/8" = 1'-0"</i> Revision	Ву	Date	-			/hb		
				CONSULTANT	PROJEC	T MANAGER:	G. Edington		
					Ву	Date		Ву	Date
				Designed	MEB	11/3/23	Checked	GME	11/3/23
				Drawn	ВЈМ	11/3/23	In Charge of	TSB	11/3/23


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THE GOLD STAR MEMORIAL HIGHWAY

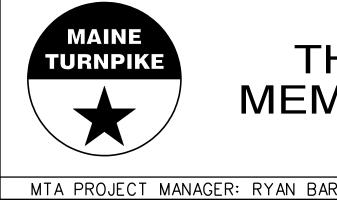MTA PROJECT NO. 2024.01 INTERSTATE 95 OVER SPRUCE CREEK AT MM 2.20 IN YORK, ME WINGWALL REPAIRS

	VHB: 55345.00	SHEET NUMBER:	A33
ARNES, P.E., CPESC	CONTRACT:2024.01	33	OF A40



- Face of Concrete

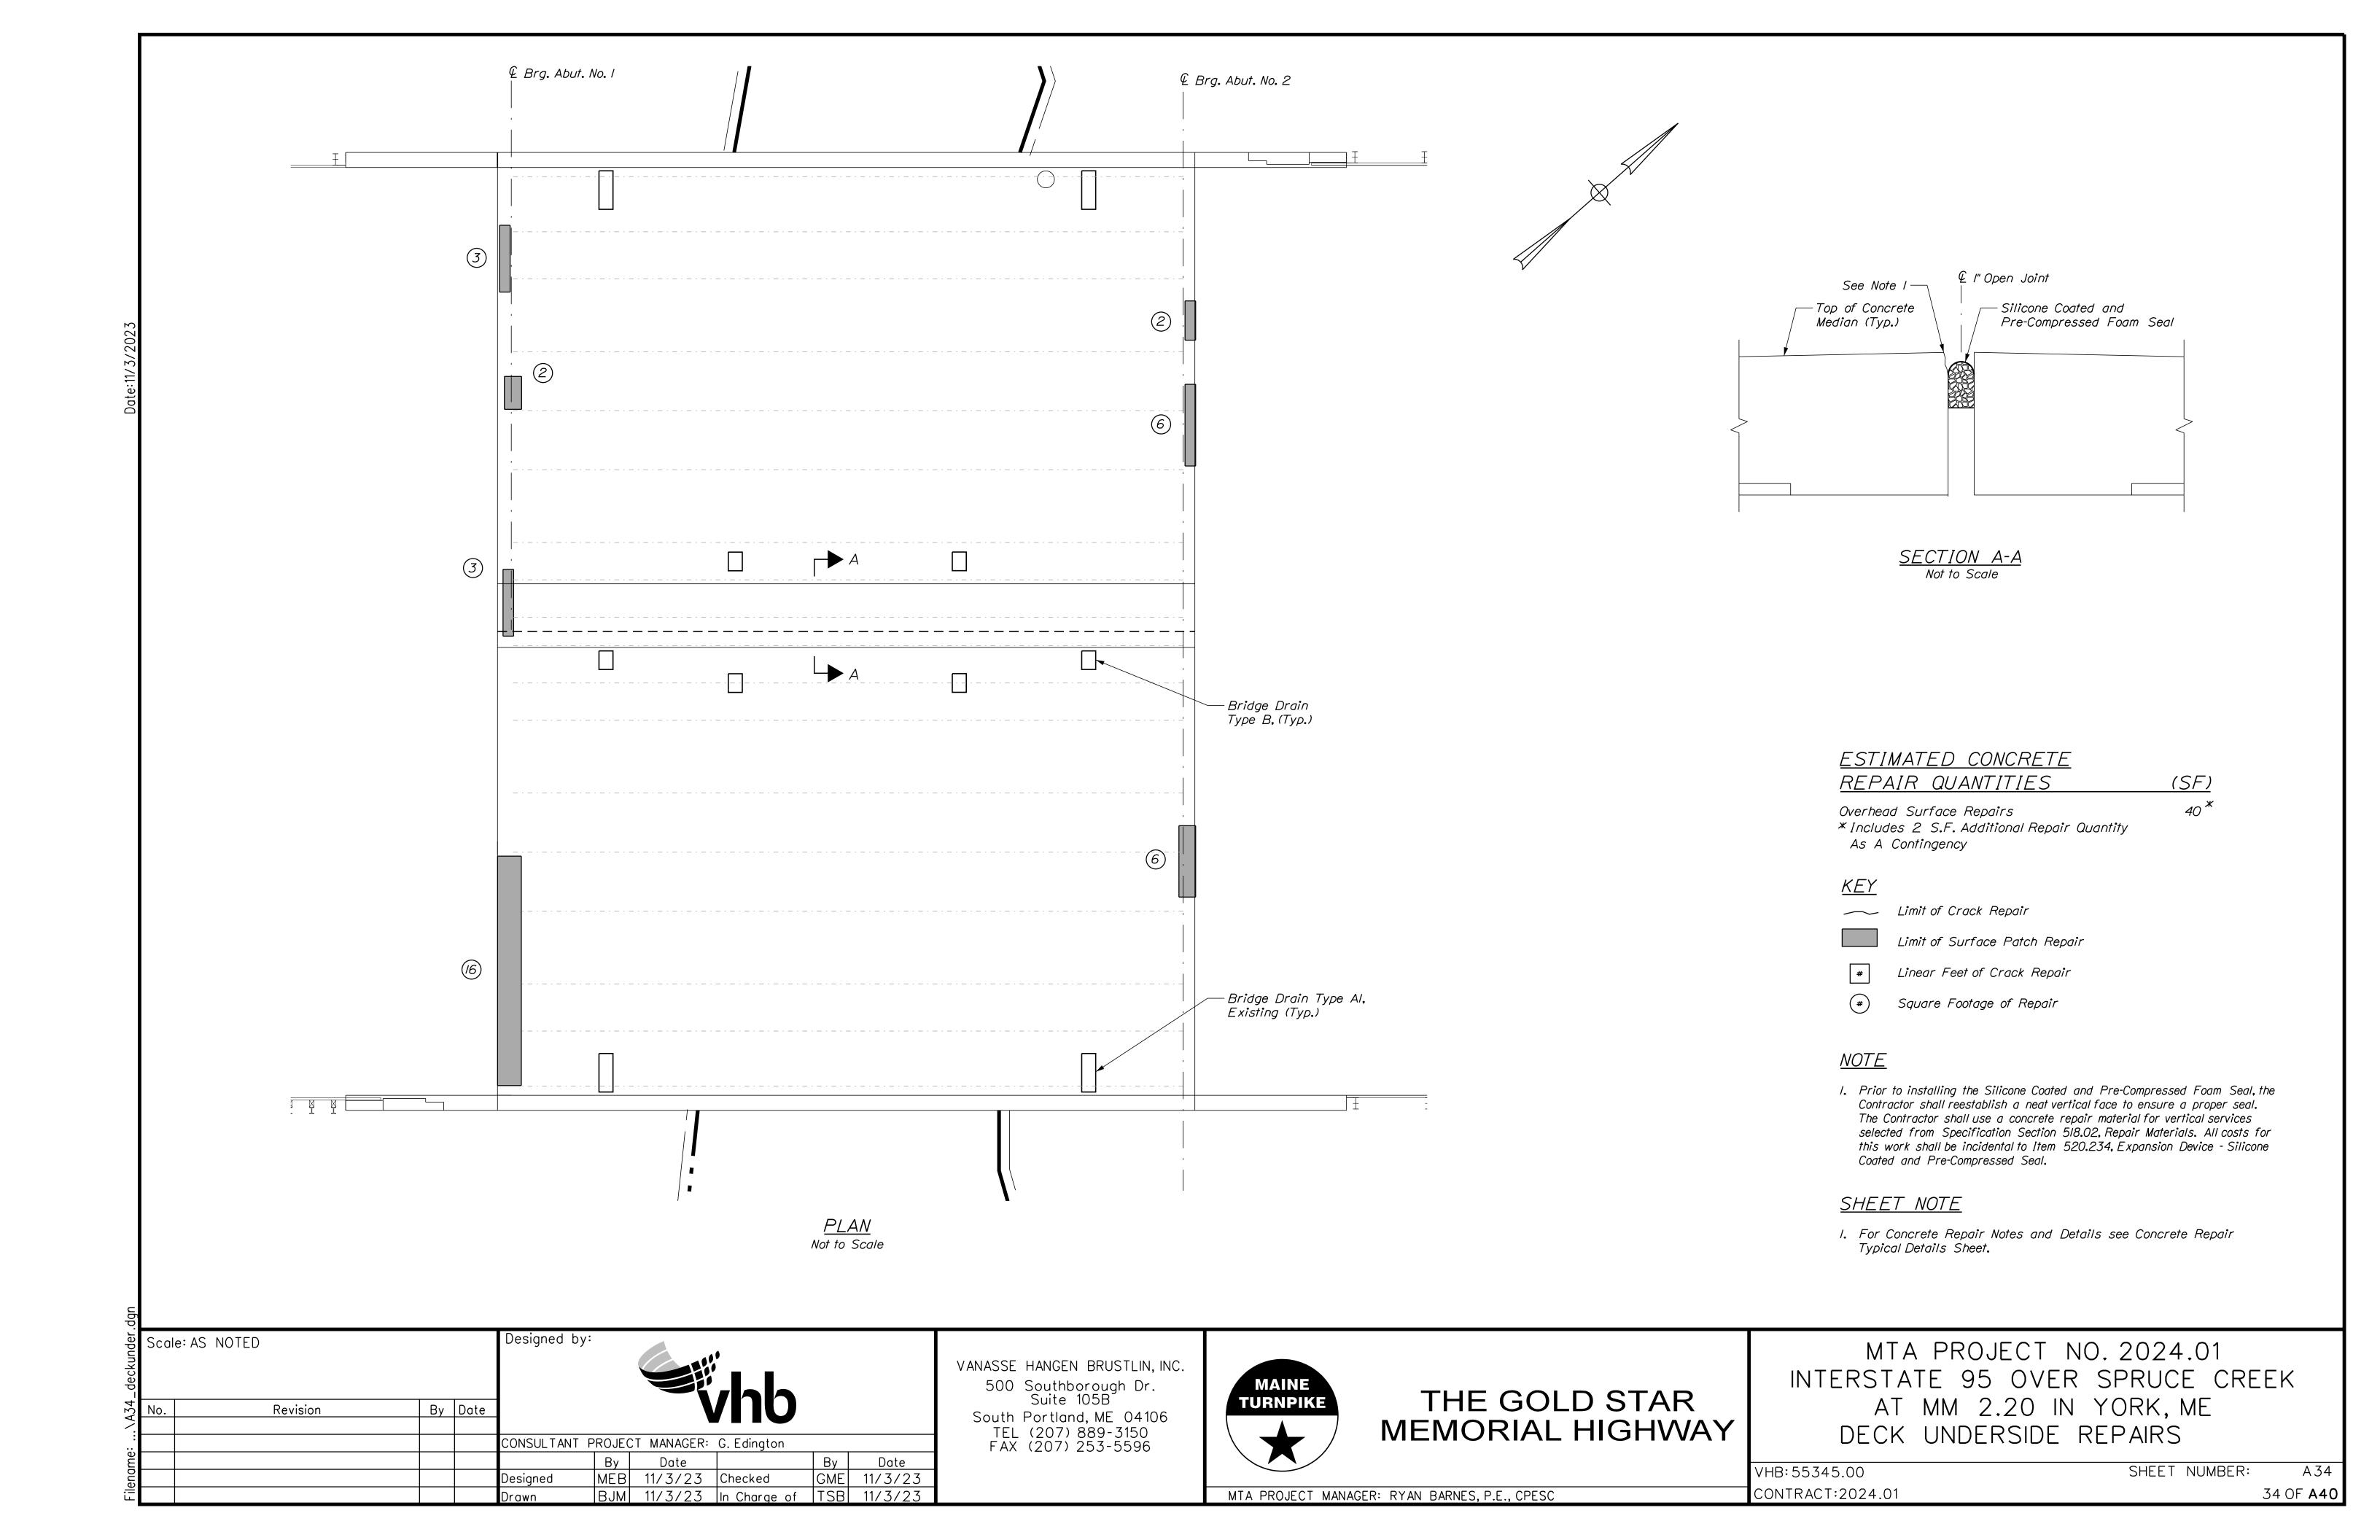- I" Min. Sawcut (Typ.)

Existing

 $(T_{VD.})$


Reinforcement

Limits of Surface Concrete Repair to Consist of Removal and Placement. Existing Reinforcement to Remain (Typ.)

TYPICAL HORIZONTAL SURFACE CONCRETE REPAIR DETAILS

△Per Supplemental .

Specification - 518 (Typ.)-

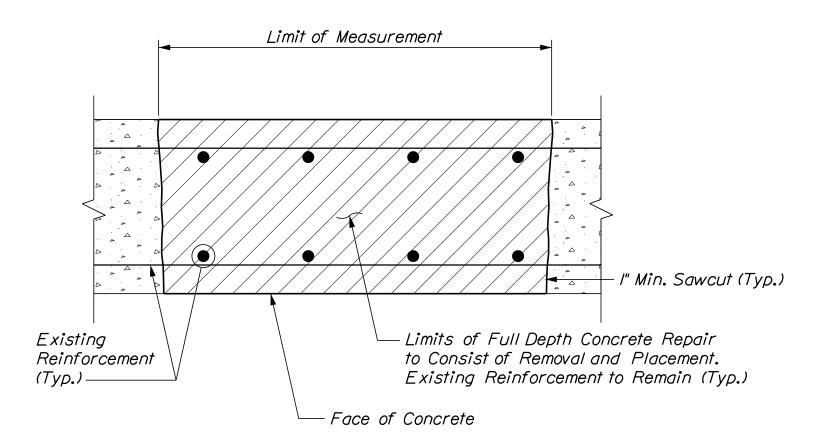

TYPICAL FULL DEPTH CONCRETE REPAIR DETAILS

CONCRETE REPAIR NOTES

- I. Repair work shall include: surface concrete repairs, epoxy in jection crack repair and providing access for inspection.
- 2. Where surface concrete repairs are specified the work shall include removal of unsound concrete and placement and curing of repair materials. Repairs shall be measured for payment under Items 518.10, Abutment Repairs and 518.70, Repair of Overhead Surfaces < 8 Inches.
- Prior to the start of any concrete repairs the Resident and the Contractor shall sound 3. all concrete surfaces and agree on the repair limits. Estimated repair quantities may increase at the Resident's discretion.
- The estimated repair quantities are based on inspections completed in April December *4.* 2020.


CONCRETE SURFACE REPAIR NOTES

- I. Perform I" deep saw cuts along limits of removal.
- 2. Chip concrete to the depth specified in Supplemental Specification 518. If the removal limits change during the demolition process the Contractor shall notify the Resident. The Resident and Contractor shall agree on the revised pay limits prior to the Contractor continuing the removal.
- 3. Prepare and patch repair areas with Class AAA modified concrete.
- 4. Perform general finishing.

EPOXY INJECTION CRACK REPAIR NOTES

- I. All crack repairs shall be completed by an individual qualified and experienced in the type of repairs proposed.
- 2. All crack repairs shall be completed in accordance with Supplemental Specification 518.
- 3. Where epoxy injection crack repair is specified the work shall include pressure injection of cracks 1/16" or more in width. Work shall be paid under Item 518.4 Epoxy Injection Crack Repair.

TYPICAL VERTICAL SURFACE CONCRETE REPAIR DETAILS

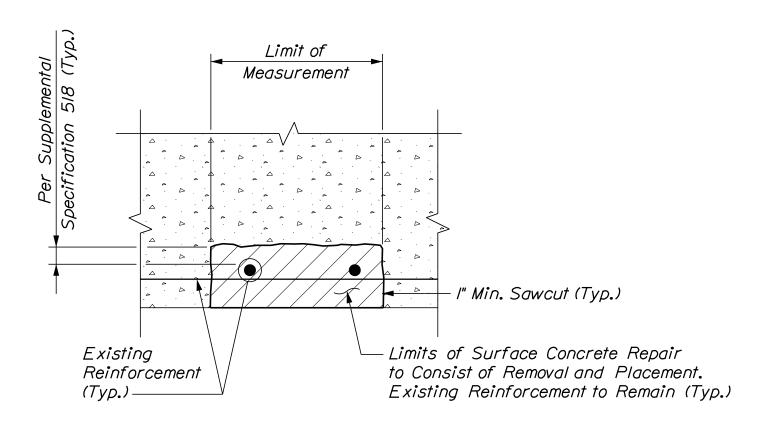

TYPICAL OVERHEAD SURFACE CONCRETE REPAIR DETAILS

ScaleNOT TO SCALE			Designed b	y:		,, 			
No.	Revision	Ву	Date	- -			/no		
				CONSULTANT	PROJEC	T MANAGER:	G. Edington		
					Ву	Date		Ву	Date
				Designed	MÉB	11/3/23	Checked	GME	11/3/2
				Drawn	ВЈМ	11/3/23	In Charge of	TSB	11/3/2

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THE GOLD STAR MEMORIAL HIGHWAY

MTA PROJECT NO. 2024.01 INTERSTATE 95 OVER SPRUCE CREEK AT MM 2.20 IN YORK, ME CONCRETE REPAIR TYPICAL DETAILS

Existing Concrete


// Proposed Concrete

<u> KEY</u>

SHEET NUMBER: VHB: 55345.00 CONTRACT:2024.01


35 OF **A40**

MTA PROJECT MANAGER: RYAN BARNES, P.E., CPESC

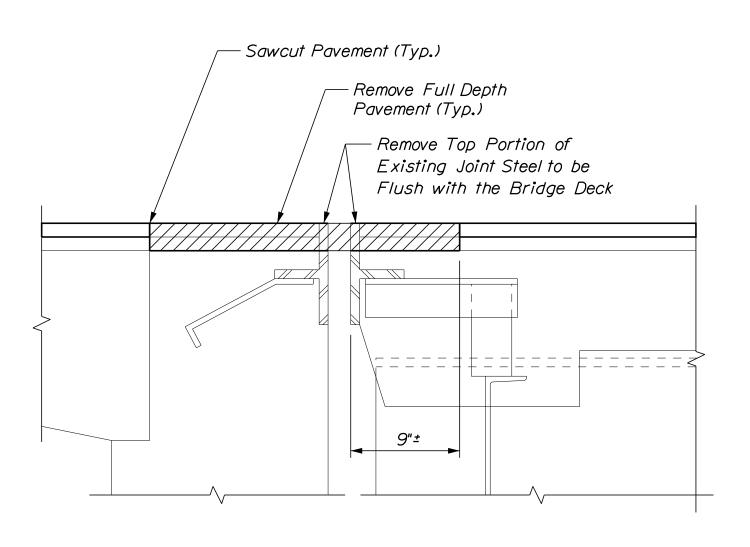


EXISTING NB BRIDGE JOINT

Not to Scale

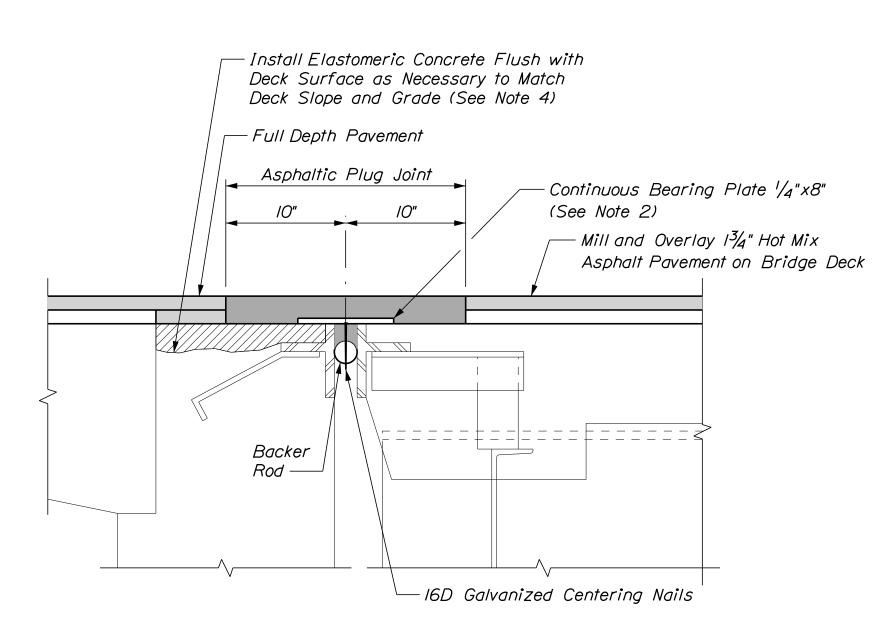


PROPOSED NB BRIDGE JOINT

Not to Scale

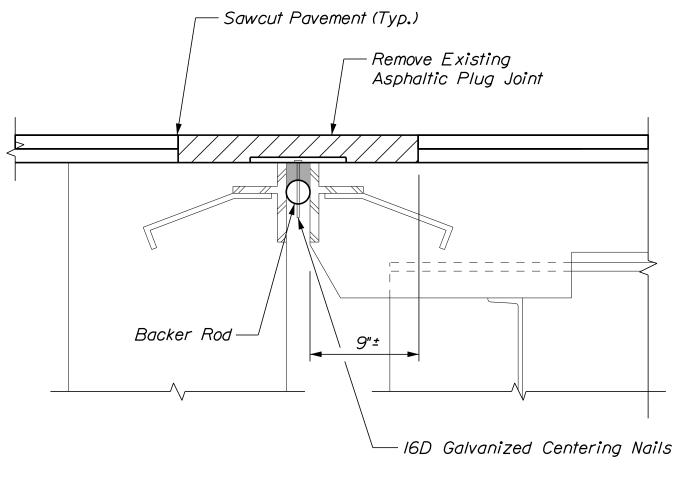

EXISTING SB BRIDGE JOINT

Not to Scale

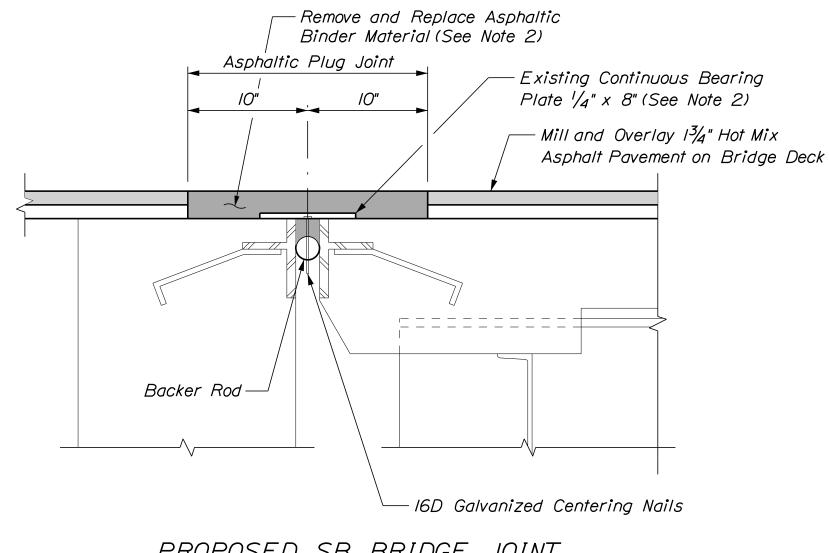

PROPOSED SB BRIDGE JOINT

Not to Scale

<u>NOTES</u>

- I. Repair concrete deck as directed by the Resident. Deck and backwall and concrete repair, if required, shall be paid for under the appropriate 518 concrete repair items.
- 2. Continuous Bearing Plate shall be incidental to Item 520.23
 Asphaltic Plug Joint (Spruce Creek NB) and (Spruce Creek SB).
- 3. See Miscellaneous Detail sheet for the joint treatment at the bridge curbs.
- 4. All work associated with the installation of Elastomeric Concrete shall be paid for under Item 518.865, Elastomeric Concrete.

SHEET NOTE


I. See Miscellaneous Details sheet for Joint Detail at Curb for the Asphaltic Plug Joint treatment at the curb.

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No.	Revision	Ву	Date				/no		
				CONSULTANT	PROJEC	T MANAGER:	G. Edington		
					Ву	Date		Ву	Date
				Designed	MÉB	11/3/23	Checked	GME	11/3/23
				Drawn	ВЈМ	11/3/23	In Charge of	TSB	11/3/23

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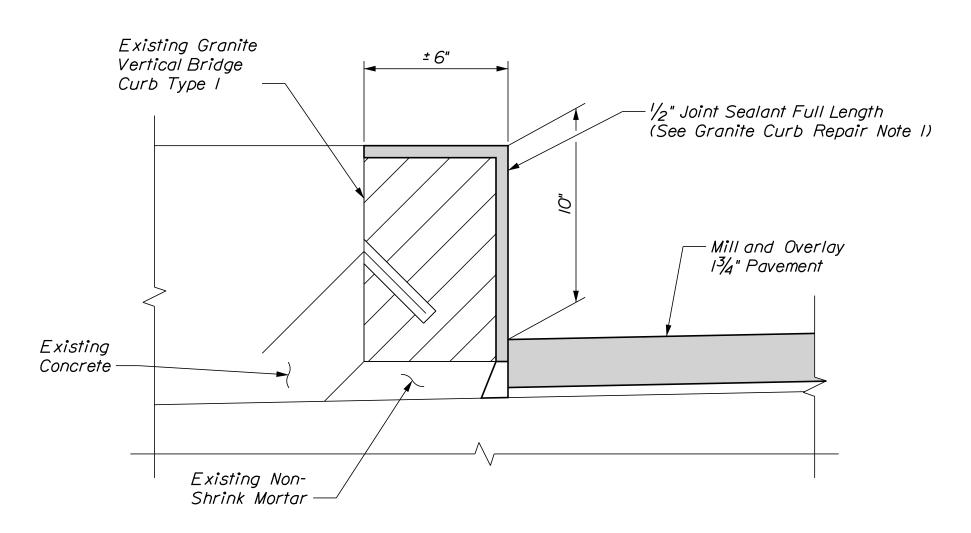
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MEMORIAL HIGHWAY

MTA PROJECT NO. 2024.01
INTERSTATE 95 OVER SPRUCE CREEK
AT MM 2.20 IN YORK, ME
BRIDGE JOINT MODIFICATIONS

VHB: 55345.00 SHEET NUMBER: A 36 CONTRACT: 2024.01 36 OF A40

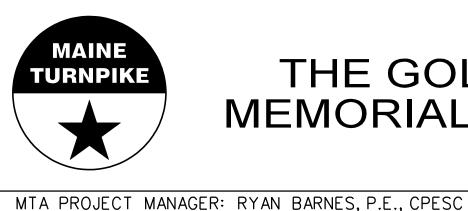JOINT NOTES

- I. Joint Detail at Curb applies to all locations which are receiving a new or replacement Asphaltic Plug Joint.
- 2. Silicone Coated and Pre-Compressed Seal shall be an emseal bridge expansion joint system (BEJS) seal. Installation shall be in accordance with manufacturer specification. Payment shall be incidental to the Asphaltic Plug Joint items.
- 3. After the installation of the asphaltic plug joint system. The bonded Silicone Coated and Pre-Compressed Seal shall be installed in the curbs as shown on the plans and as recommended by the manufacturer.



EXISTING GRANITE CURB DETAIL Scale: 3" = 1'-0"

GRANITE CURB REPAIR NOTES

I. Joint sealant shall be a material from the MaineDOT approved products list as approved by the Resident. Joint sealant shall be paid as Item 518.391, Repairing Granite Curb Joint and Bedding Mortar.

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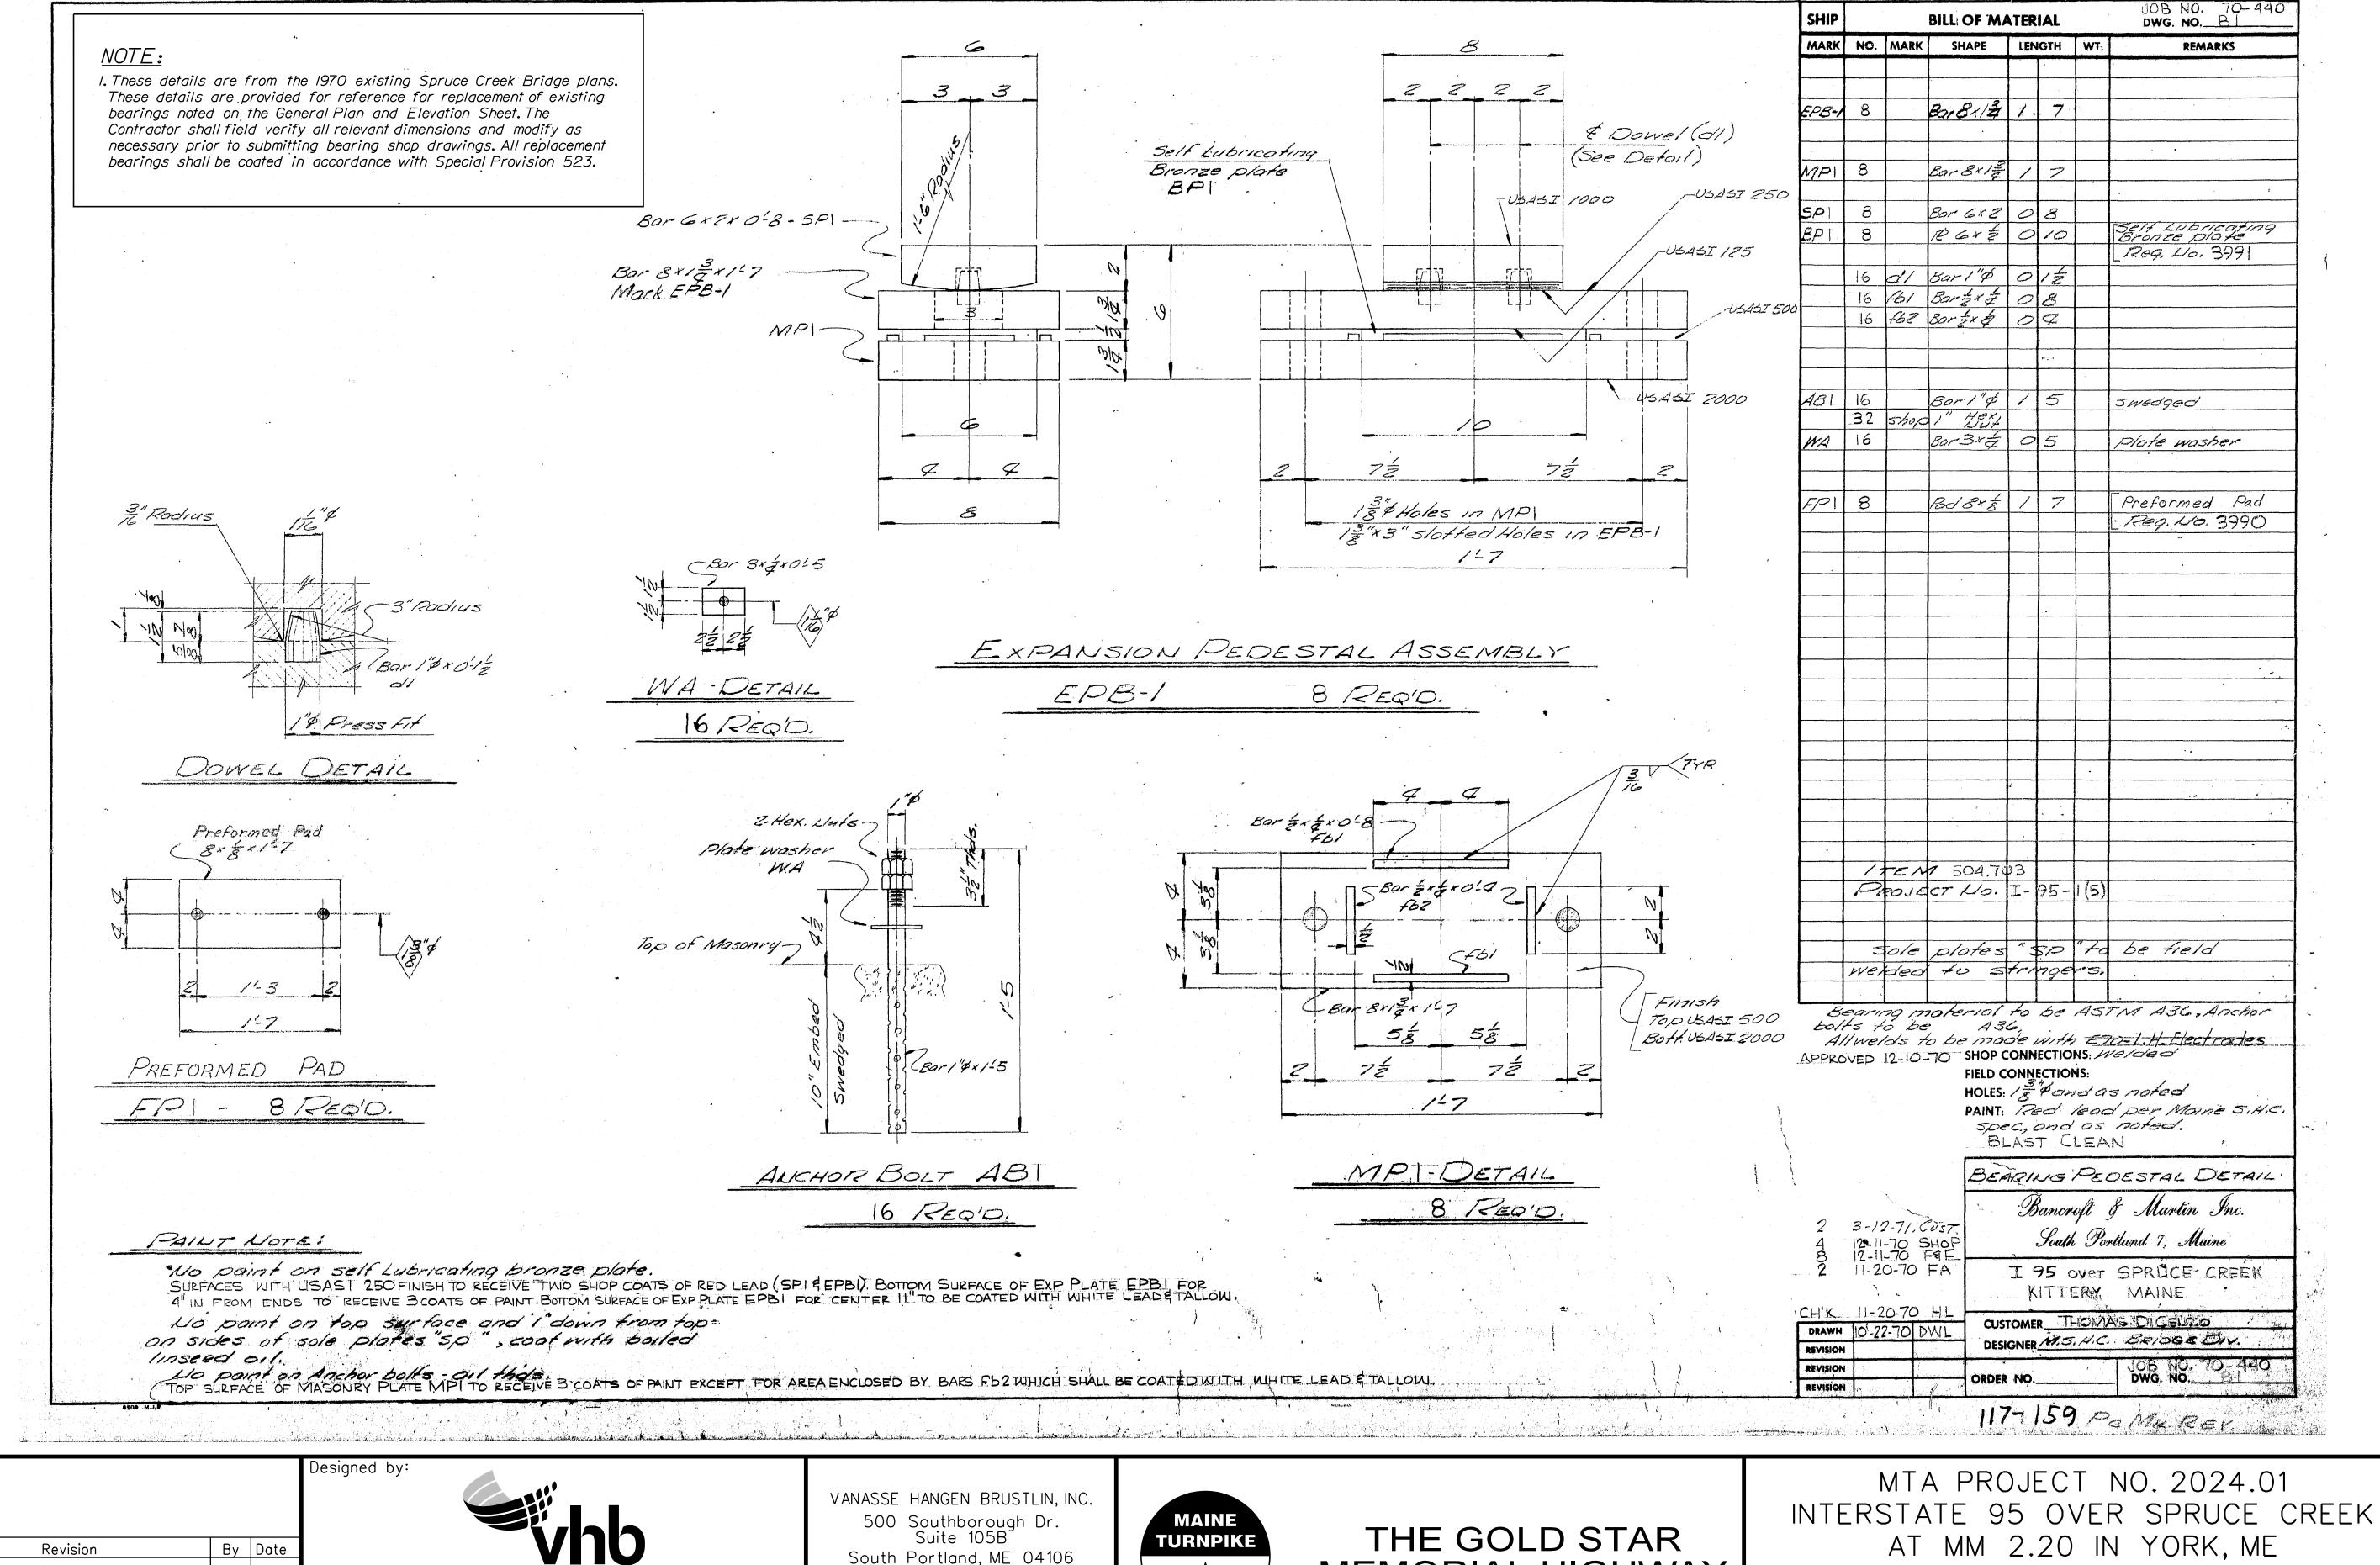
THE GOLD STAR MEMORIAL HIGHWAY

MTA PROJECT NO. 2024.01
INTERSTATE 95 OVER SPRUCE CREEK
AT MM 2.20 IN YORK, ME
MISCELLANEOUS DETAILS

A37

37 OF **A40**

VHB:55345.00 SHEET NUMBER: CONTRACT:2024.01



Scale:

CONSULTANT PROJECT MANAGER: G. Edington By Date MEB 11/3/23 GME 11/3/23 Checked Designed BJM 11/3/23 In Charge of TSB

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MEMORIAL HIGHWAY


BEARING PEDESTAL DETAILS (1 OF 2)

VHB: 55345.00 SHEET NUMBER:

CONTRACT: 2024.01

MTA PROJECT MANAGER: RYAN BARNES, P.E., CPESC

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MTA PROJECT MANAGER: RYAN BARNES, P.E., CPESC

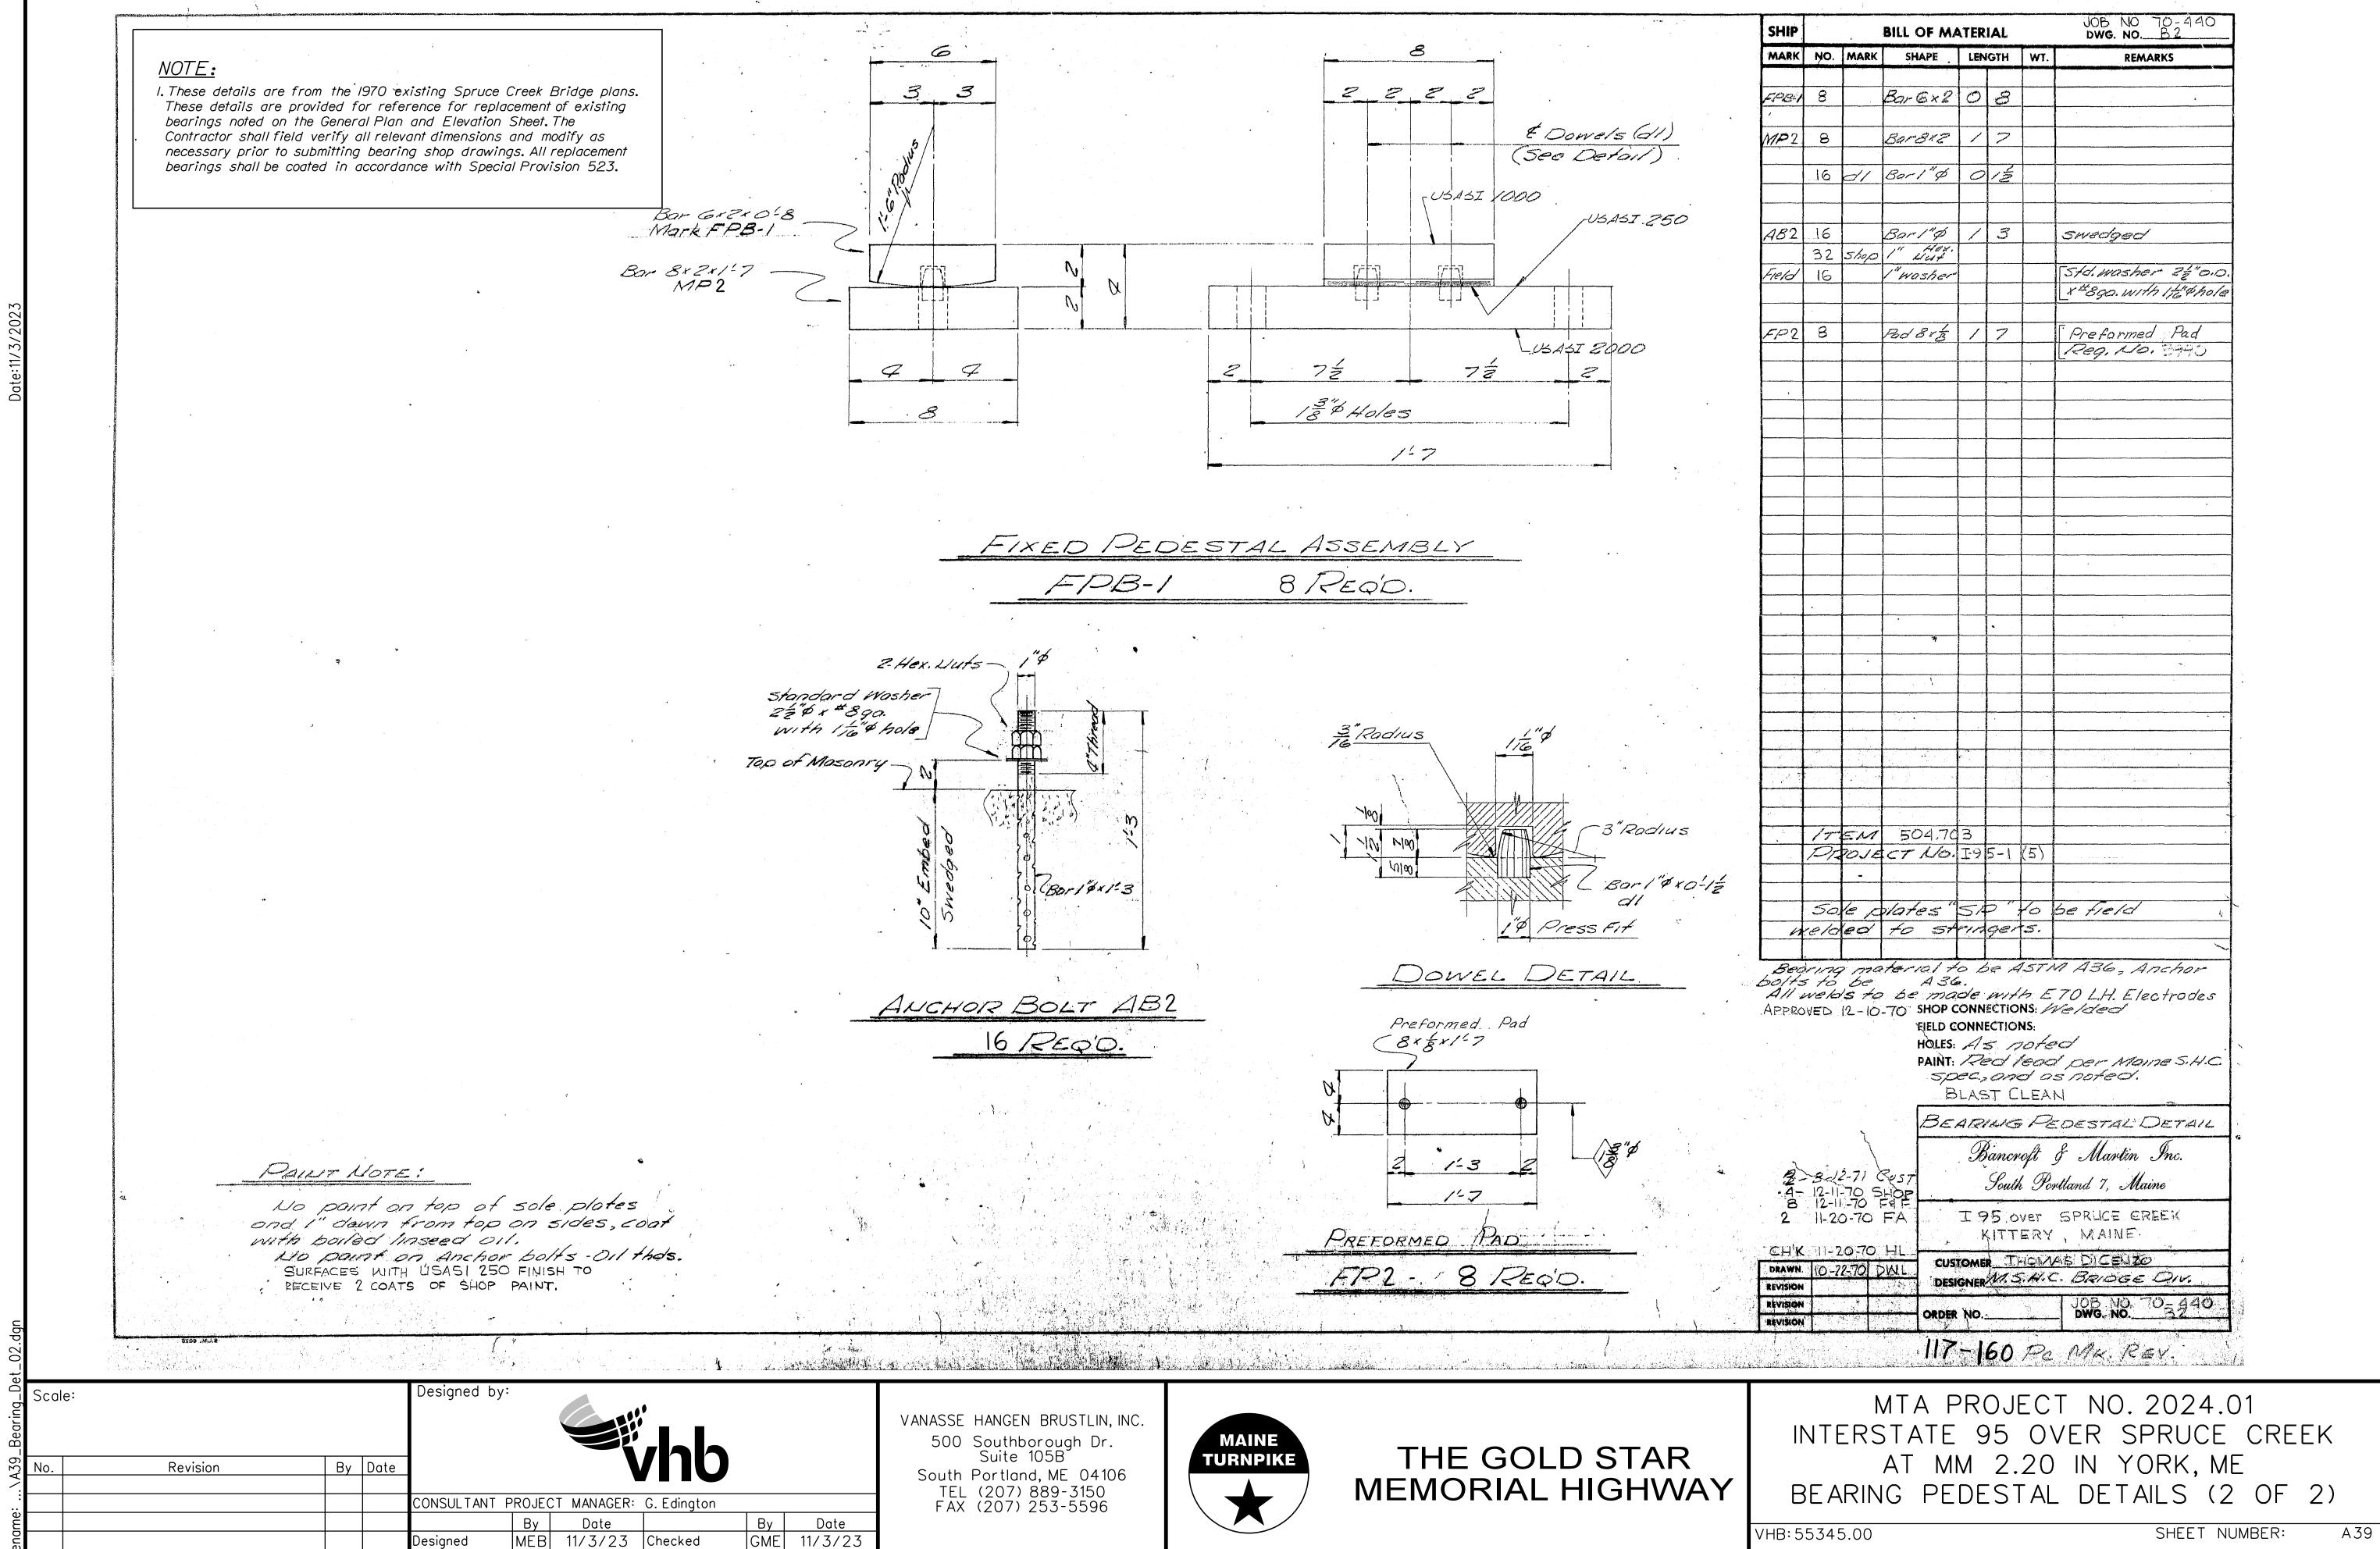BJM 11/3/23

In Charge of TSB

CONTRACT:2024.01 **39** OF **A40**

