INDEX OF SHEETS


Detour Plans (2 Sheets)

Concrete Repair Typical Details **Bridge Joint Modifications**

General Plan

General Notes and Estimated Quantities

Maintenance of Traffic Details (4 Sheets)

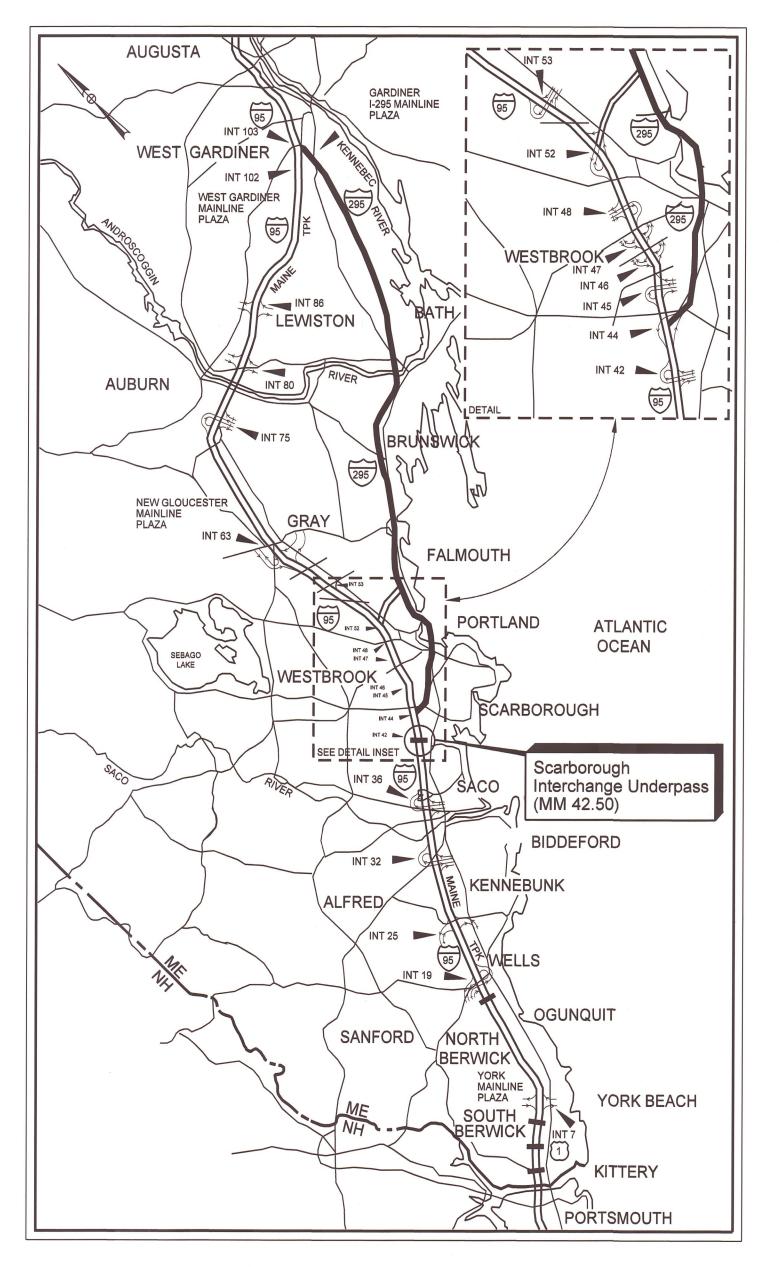

LOCATION MAP

MAINE TURNPIKE AUTHORITY

APPROVED:



MAINE TURNPIKE AUTHORITY

DANIEL E. WATHEN, CHAIR MICHAEL J. CIANCHETTE, VICE CHAIR BETTYANN SHEATS, MEMBER ANDREW J. MCLEAN, MEMBER JANE L. LINCOLN, MEMBER THOMAS J. ZUKE, MEMBER BRUCE A. VAN NOTE, EX-OFFICIO MEMBER


S. PETER MILLS, EXECUTIVE DIRECTOR

CONTRACT 2023.08

BRIDGE REPAIRS SCARBOROUGH INTERCHANGE UNDERPASS (MM 42.50)



Gordon M. Edington, P.E. Consultant Project Manager

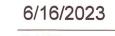



ITEM NO.

202.202 Removing Pavement Surface

518.10 Abutment Repairs

518.95 Wingwall Repairs

631.36 Foreman

652.33 Drum

652.34 Cone

659.10

652.30 Flashing Arrow

652.312 Type III Barricade

652.35 Construction Signs

403.208 Hot Mix Asphalt, 12.5 mm Nominal Maximum Size

409.15 Bituminous Tack Coat RS-I or RSIh - Applied

518.864 Elastomeric Concrete Header Repair

526.301 Temporary Concrete Barrier, Type I

631.10 Air Compressor (including operator)

Air Tool (including operator)

652.361 Maintenance of Traffic Control Devices

656.75 Temporary Soil Erosion and Water Pollution Control

652.41 Portable-Changeable Message Sign

652.45 Truck Mounted Attenuator

Mobilization

631.171 Truck - small (including operator)

631.12 All Purpose Excavator (including operator)

527.341 Work Zone Crash Cushion - TL-3

629.05 Hand Labor, Straight Time

5/5.202 Clear Protective Coating for Concrete Surfaces

ESTIMATED QUANTITIES

UNIT

TON

GAL

SY

CF

CF

LS

UNIT

HR

HR

HR

HR

HR

EΑ

EΑ

EΑ

EΑ

LS

EΑ

CD

LS

LS

QUANTITY

130

30

4

225

10

40

25

10

10

10

10

10

10

75

20

225

15

DESCRIPTION

SPECIFICATIONS

Design: AASHTO LRFD Bridge Design Specifications, 2020.

Construction: State of Maine Department of Transportation Standard Specifications, 2014 Edition, with all revisions thereto.

State of Maine Department of Transportation Standard Details for Highways and Bridges, 2020 Edition, with all revisions thereto.

AASHTO LRFD Bridge Construction Specifications, Fourth Edition

NEW MATERIALS

VANASSE HANGEN BRUSTLIN, INC.

500 Southborough Dr.

Suite 105B

South Portland, ME 04106

TEL (207) 889-3150

FAX (207) 253-5596

BASIC DESIGN STRESSES (NEW MATERIALS)

Concrete f'c = 4,500 psiReinforcing Steel fy = 60,000 psi

TRAFFIC AND DESIGN LOADING DATA

SCARBOROUGH INTERCHANGE UNDERPASS

GENERAL CONSTRUCTION NOTES

- I. All details shall be in conformance with Maine Department of Transportation (MaineDOT) 2020 Standard Details for Highways and Bridges with all updates and MaineDOT Best Management Practices for Erosion and Sediment Control, latest revision unless otherwise noted in these plans.
- 2. All work must be completed within the Right of Way.
- 3. The Contractor shall submit proposed staging area(s) to the Resident for approval prior to starting work.
- 4. Any portions of the existing bridges removed by the Contractor shall become the property of the Contractor. The steel portions of the existing bridges may be coated with a lead-based paint system. The Contractor is responsible for the containment, proper management and disposal of all lead-contaminated hazardous waste generated by the work of this project.
- 5. Copies of the As-Built plans are posted on the Maine Turnpike Authority website at www.maineturnpike.com/projects/construction-contracts. The completeness and accuracy of these plans is not guaranteed.
- 6. Chamfer all exposed new concrete edges $\frac{3}{4}$ " unless otherwise noted.
- 7. Clear protective coating for concrete surfaces shall be applied to the entire west abutment and all exposed areas of the wingwalls at the west abutment.
- 8. The Contractor shall place approach pavement to achieve a smooth transition between existing and proposed pavement.
- 9. Prior to the removal of any pavement, the Contractor shall document the location, type and color of all pavement striping and provide that information to the Resident. The Maine Turnpike Authority will place all new striping at no cost to the Contractor.

EROSION CONTROL NOTES

I. All temporary and permanent erosion control devices shall be installed in accordance with the Maine Department of Transportation Best Management Practices.

UTILITIES NOTES

- I. Existing utilities were not located for these plans. No work shall be started until the owners of the various utilities are notified by the Contractor of the proposed construction. The Contractor is also required to call Dig Safe at I-888-344-7233 at least 72 hours prior to the start of the work.
- 2. The Contractor shall contact all non-members through www.OKtoDiG.com or as otherwise required by the Maine Public Utilities Commission. All proposed excavation locations shall be marked at the time of notification. No excavation shall be permitted until the authority has located and marked it's underground utilities. The Resident Engineer shall be provided a digital copy of all Dig Safe tickets within 24 hours of their release for project notifications and 3rd party utility locater coordination.
- 3. The Contractor shall notify the Resident IO calendar days prior to submitting a utility locate request through Dig Safe so that the Resident can arrange for Maine Turnpike underground utility location. All proposed sign locations and excavation locations shall be marked at the notification time.
- 4. Contractor shall protect all existing utilities from damage during the construction as approved by the utility owners.

THE GOLD STAR
MEMORIAL HIGHWAY

SCARBOROUGH INTERCHANGE UNDERPASS

GENERAL NOTES AND
ESTIMATED QUANTITIES


VHB: 55702.00 SHEET NUMBER: 2
CONTRACT: 2023.08 2 OF 12

MTA PROJECT MANAGER: Ryan Barnes, P.E., CPESC

MAINTENANCE OF TRAFFIC GENERAL NOTES

- I. These traffic control details apply to the Exit 42 Overpass project. The Contractor is directed to use a typical layout from this project's Maintenance of Traffic Details or from the Maine Turnpike Authority Traffic Control Plans located on the MTA website at www.maineturnpike.com. See also the Special Provisions for more details on specific temporary traffic controls with time and date restrictions.
- 2. The shoulder closure along the Exit 42 southbound on-ramp is shown with temporary concrete barrier. The Contractor may use drums for the shoulder closure if no workers will be within four feet of the ramp's traveled way and no equipment will be left within the clear zone for the ramp or mainline during non-working hours.
- 3. All traffic control equipment and devices shall conform to the 2014 edition of the Maine Department of Transportation (MaineDOT) Standard Specifications, Maine Turnpike Authority (MTA) Supplemental Specifications, contract specifications and applicable traffic control standards and practices.
- 4. Any signs, equipment, or devices found to be damaged or unserviceable shall be replaced at the Contractor's expense.
- 5. Temporary lane closures will be required, with advanced approval, whenever work will occur within four feet of the I-95 traveled way. Temporary lane closures shall be removed if no work is occurring. See Special Provisions for more information including available lane closure times.
- 6. Lane closure requests shall be submitted by the Resident by Noon on the Thursday prior to the week of the proposed lane closures. The Contractor shall plan all lane closure requests accordingly.
- 7. Approach ends of temporary concrete barrier shall be placed outside of the highway clear zone (minimum 34 feet from the traveled way along I-95) or protected by temporary impact attenuators or with guardrail overlaps as approved by the Resident.
- 8. Maximum spacing for channelizing devices (drums) shall be:
 80' on center along tangents
 40' on center along tapers
- 9. Work zone speed limits shall only be permitted when temporary lane closures are in place.

	CO/V.	Text Din	nensions	GN SUMM	ZARY
Sign		(Inches) Letter Vertical Height Spacing		Size	Quantity and Color
E5-2a EXIT CLOSED		Text Dimensions Shall Conform to "Standard Highway		48" x 36"	4 - Black on Orange
G20-2	END ROAD WORK		- 2012 	48"x24"	I - Black on Orange
CS-4	EXIT CLOSED AHEAD			48" x 48"	I - Black on Orange
CS-II	NO STOPPING ON PAVEMENT			48" x 48"	I - Black on Orange
W/3-4p	ON RAMP			36"x36"	I - Black on Orange
W20-I (AHE AD)	ROAD WORK AHEAD			48" x 48"	4 - Black on Orange
W2I-5aR	RIGHT SHOULDER CLOSED 1000 FT			48" x 48"	2 - Black on Orange
W2I-5bR	RIGHT SHOULDER CLOSED	,		48" x 48"	2 - Black on Orange

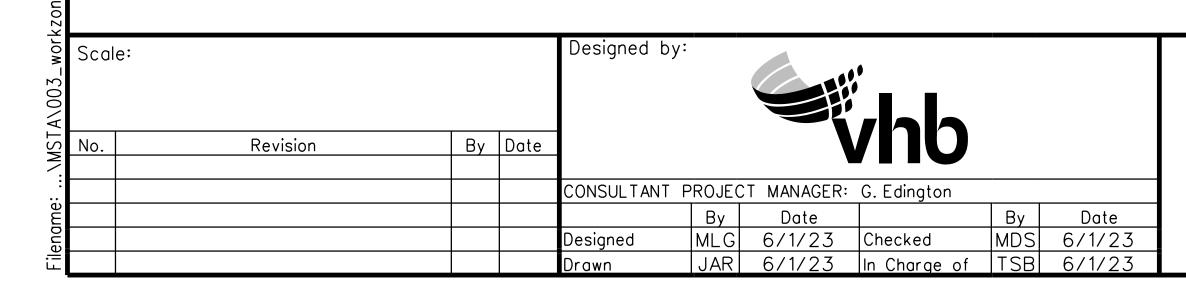

VANASSE HANGEN BRUSTLIN, INC.

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THE GOLD STAR MEMORIAL HIGHWAY

SCARBOROUGH INTERCHANGE UNDERPASS


MAINTENANCE OF TRAFFIC DETAILS

(1 OF 4)

3 OF **12**

VHB: 55702.00 SHEET NUMBER: CONTRACT: 2023.08

MTA PROJECT MANAGER: Ryan Barnes, P.E., CPESC

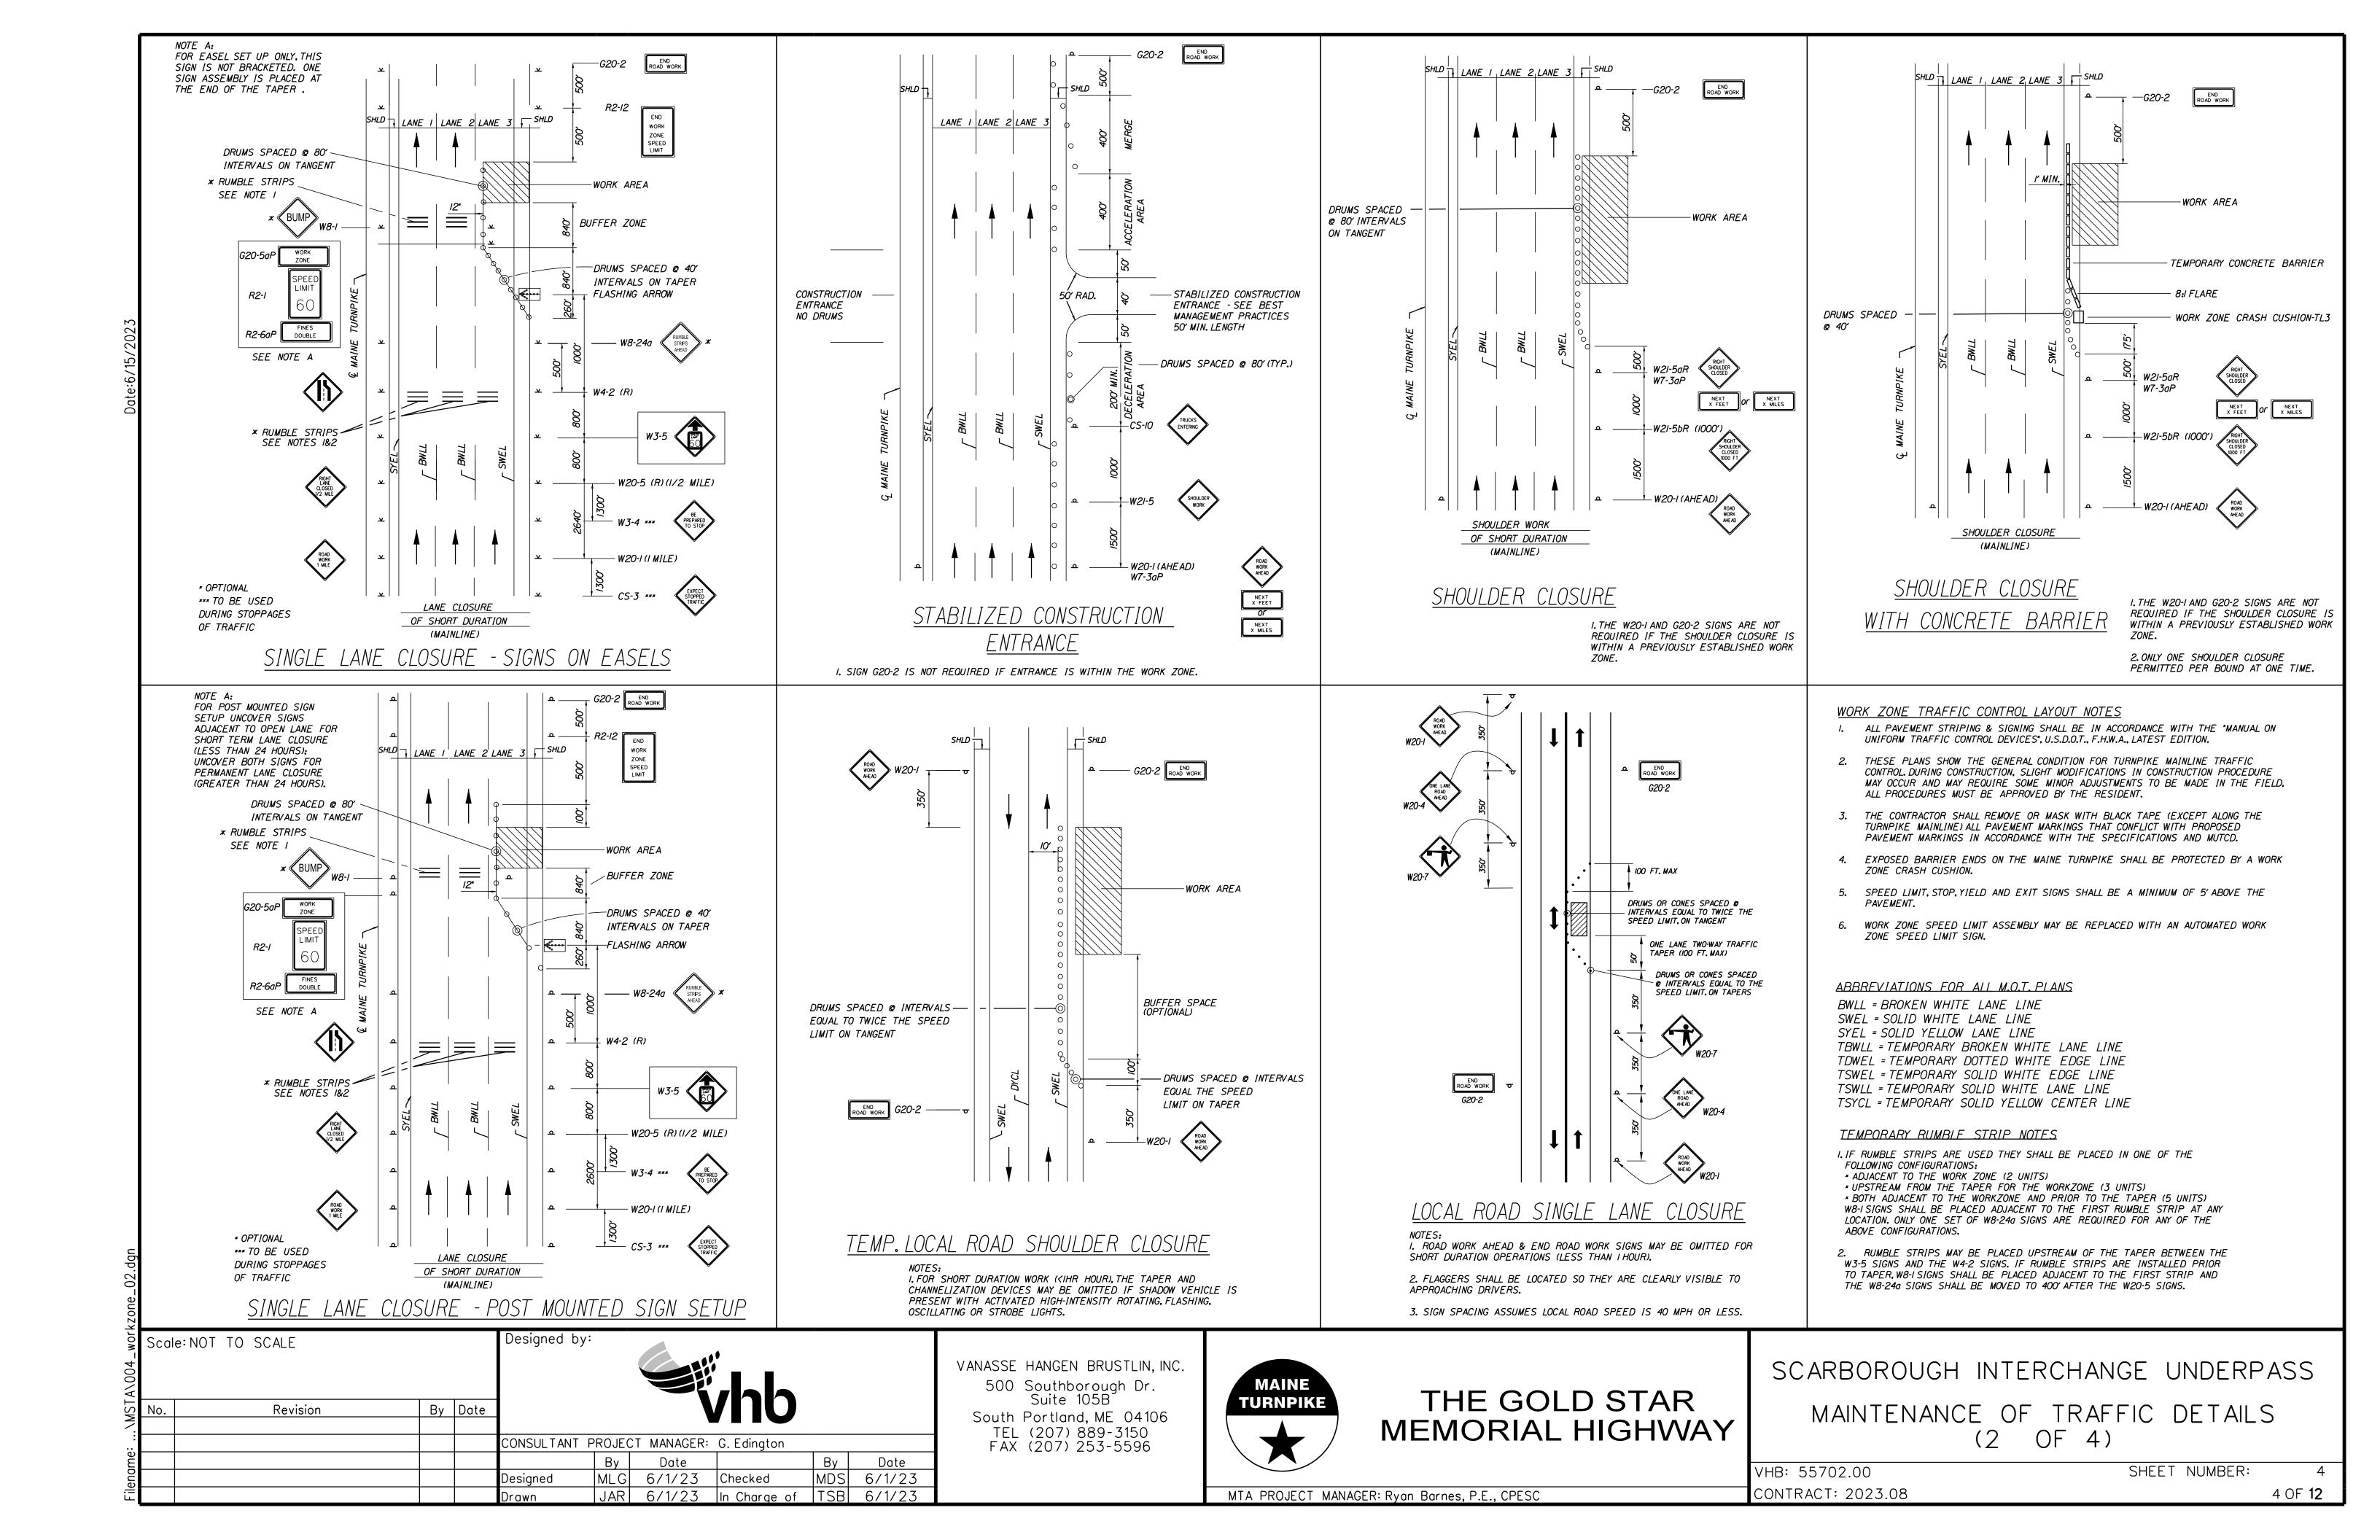



Revision By Date

CONSULTANT PROJECT MANAGER: G. Edington By Date

MLG 6/1/23 Checked

JAR 6/1/23 In Charge By Date
Checked MDS 6/1/23
In Charge of TSB 6/1/23 Designed

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South Portland, ME 04106 TEL (207) 889-3150 FAX (207) 253-5596




MTA PROJECT MANAGER: Ryan Barnes, P.E., CPESC

THE GOLD STAR MEMORIAL HIGHWAY

SCARBOROUGH INTERCHANGE UNDERPASS MAINTENANCE OF TRAFFIC DETAILS (3 OF 4)

VHB: 55702.00 CONTRACT: 2023.08

SHEET NUMBER: 5 OF **12**

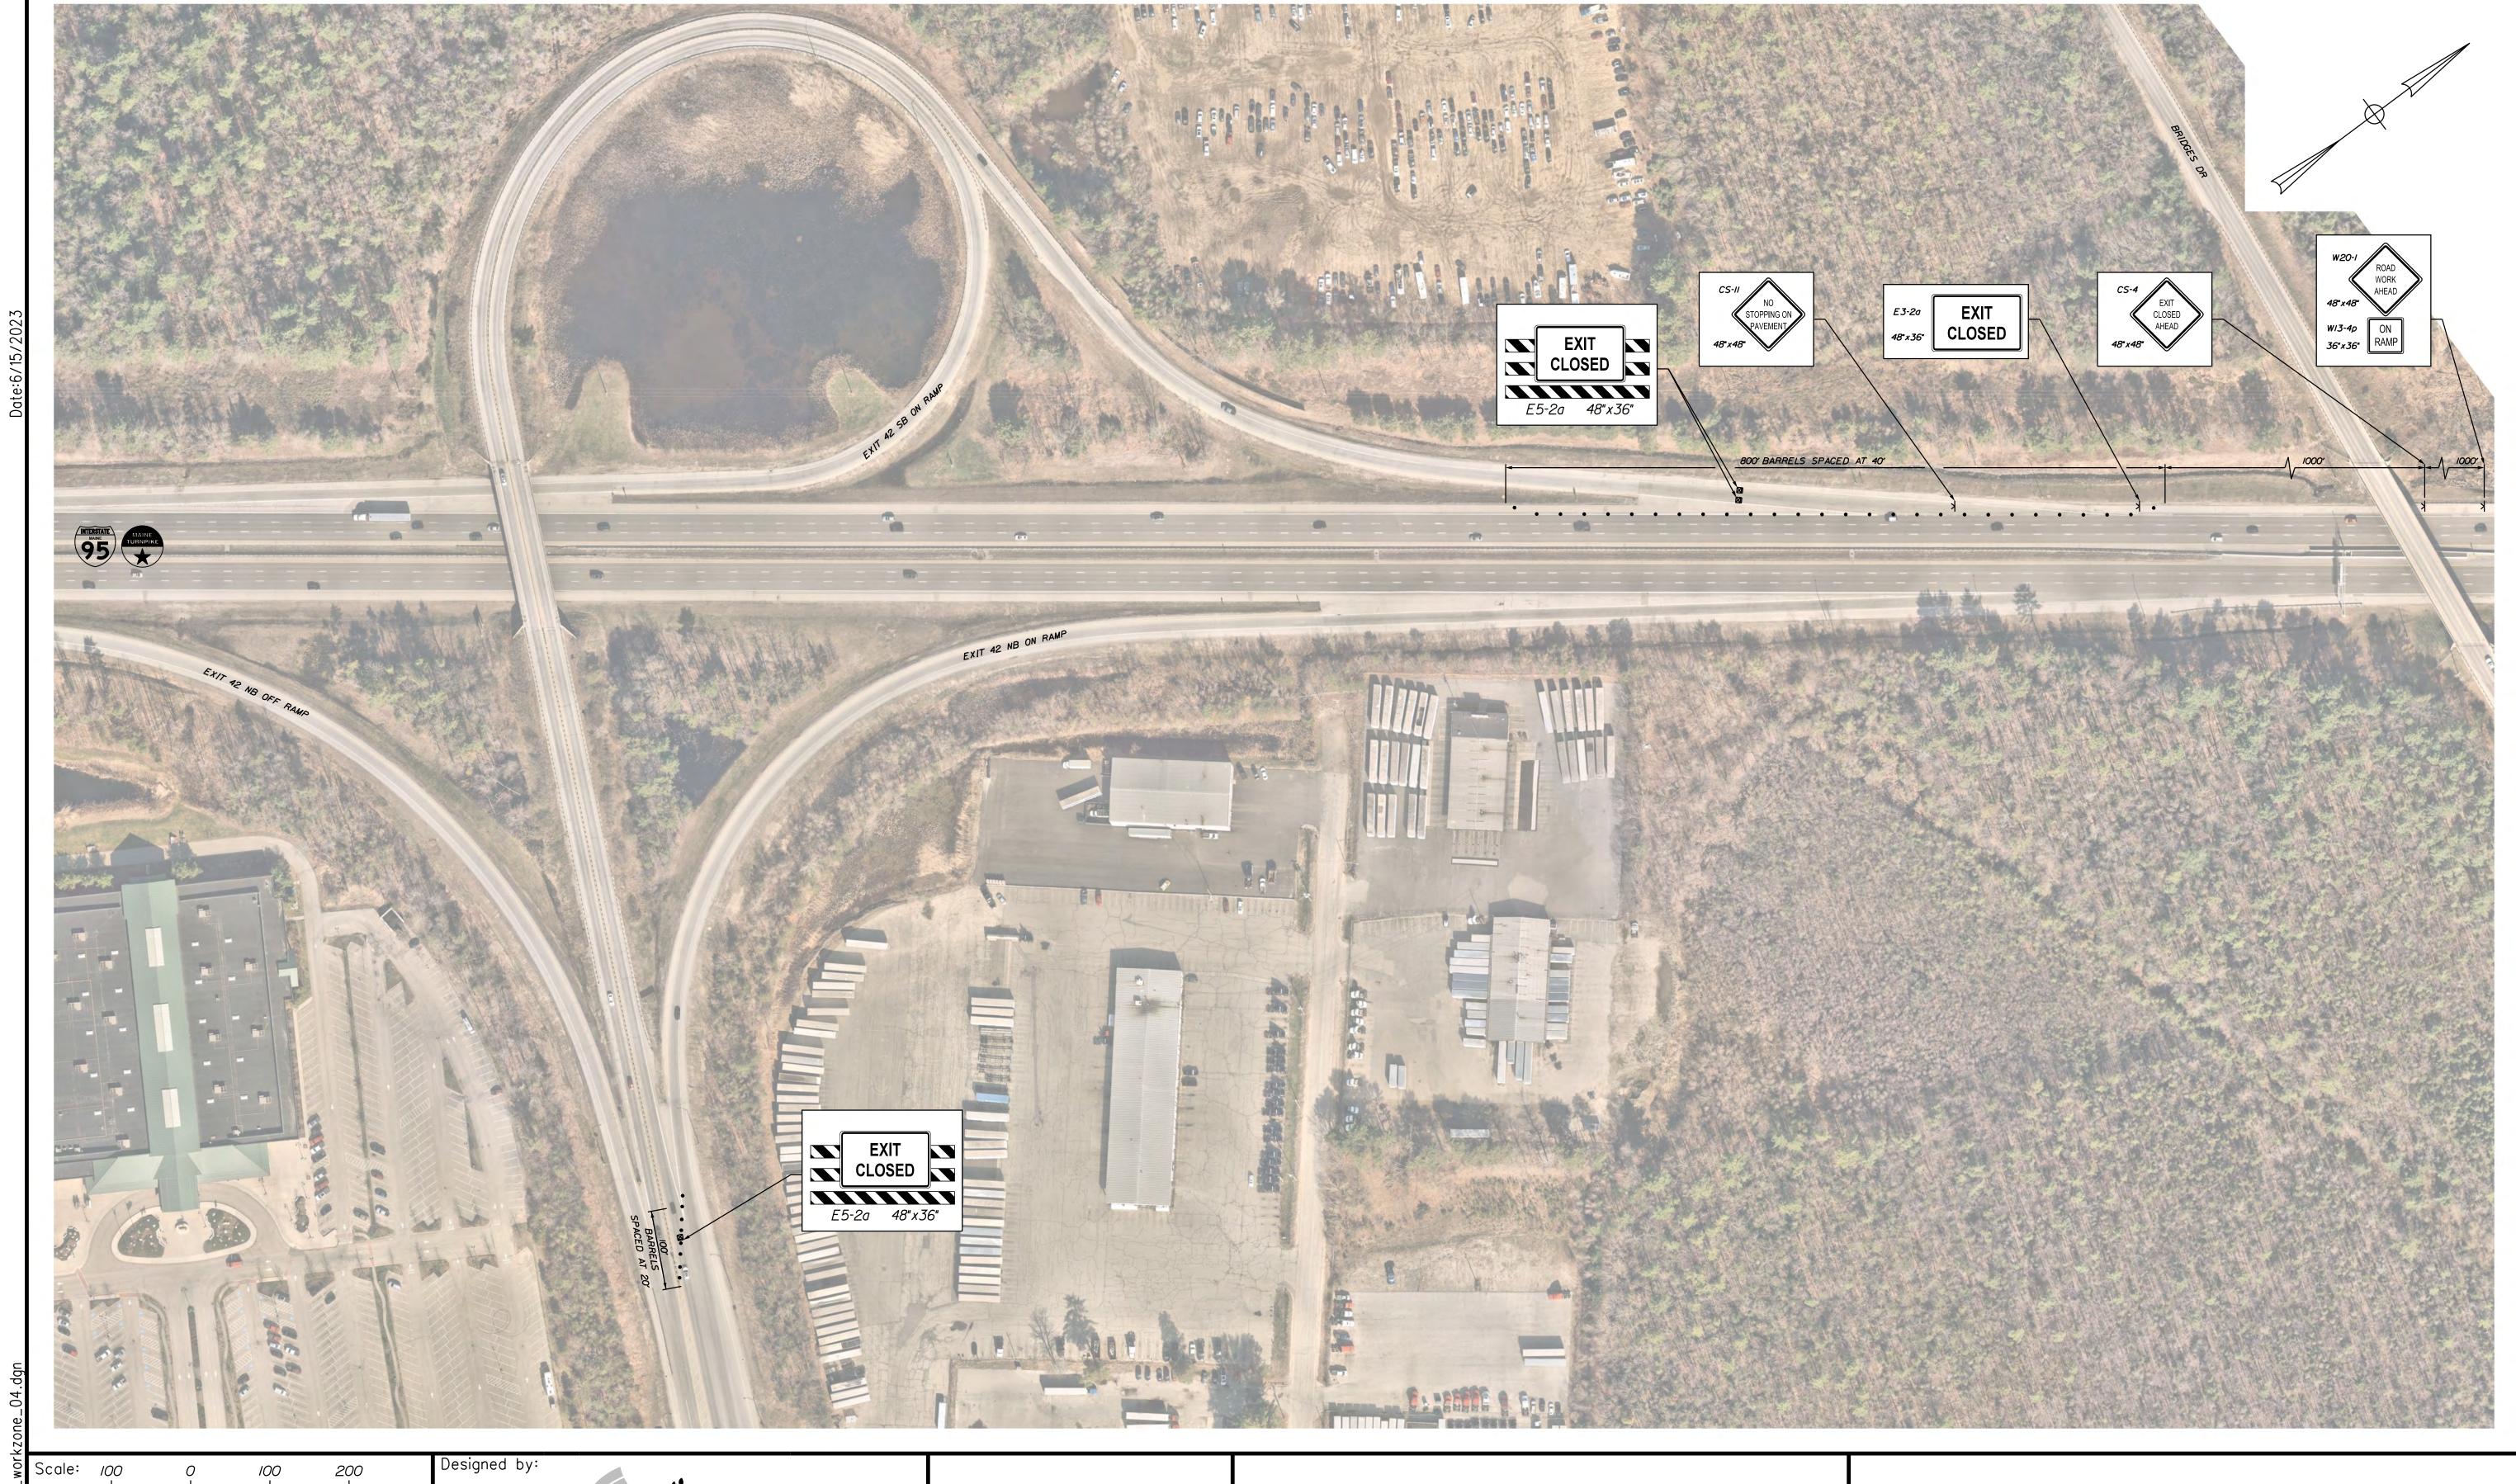

name: ...\MSTA\006_workzone_04

No. Revision By Date

CONSULTA

Designed

CONSULTANT PROJECT MANAGER: G. Edington

By Date
MLG 6/1/23
JAR 6/1/23

500 Southborough Dr. Suite 105B South Portland, ME 04106 TEL (207) 889-3150 FAX (207) 253-5596 In Charge of TSB 6/1/23

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THE GOLD STAR MEMORIAL HIGHWAY

SCARBOROUGH INTERCHANGE UNDERPASS


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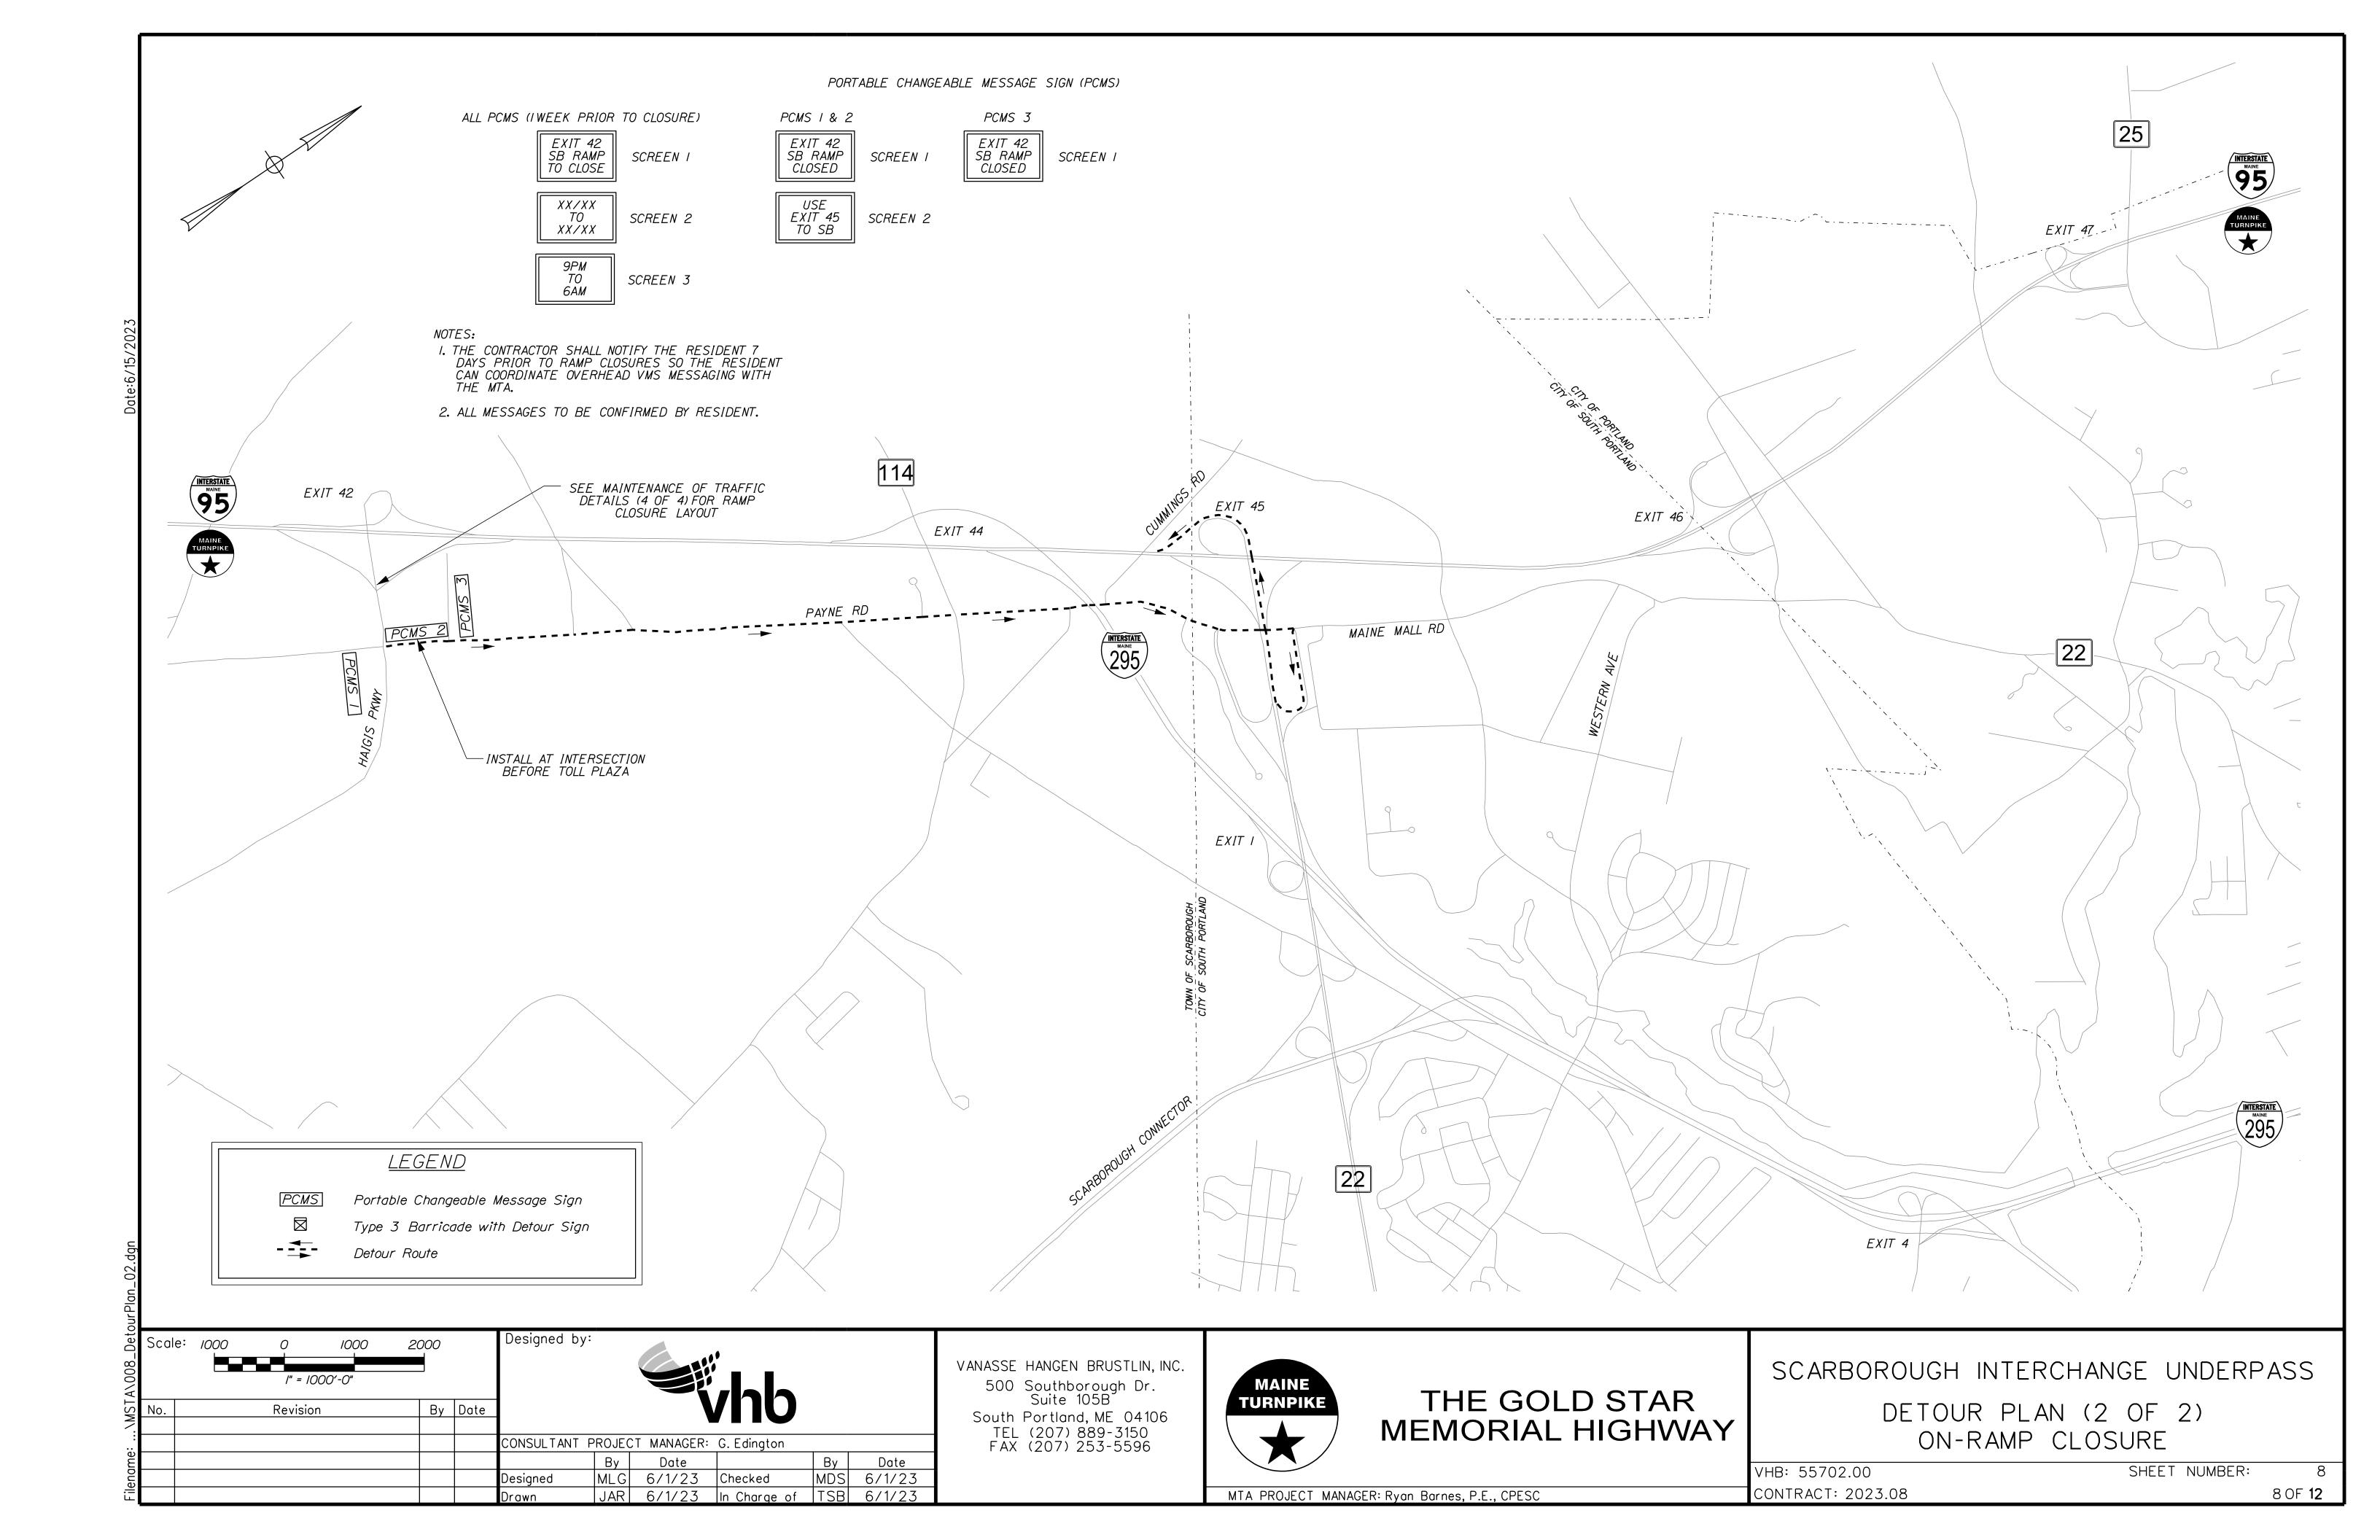
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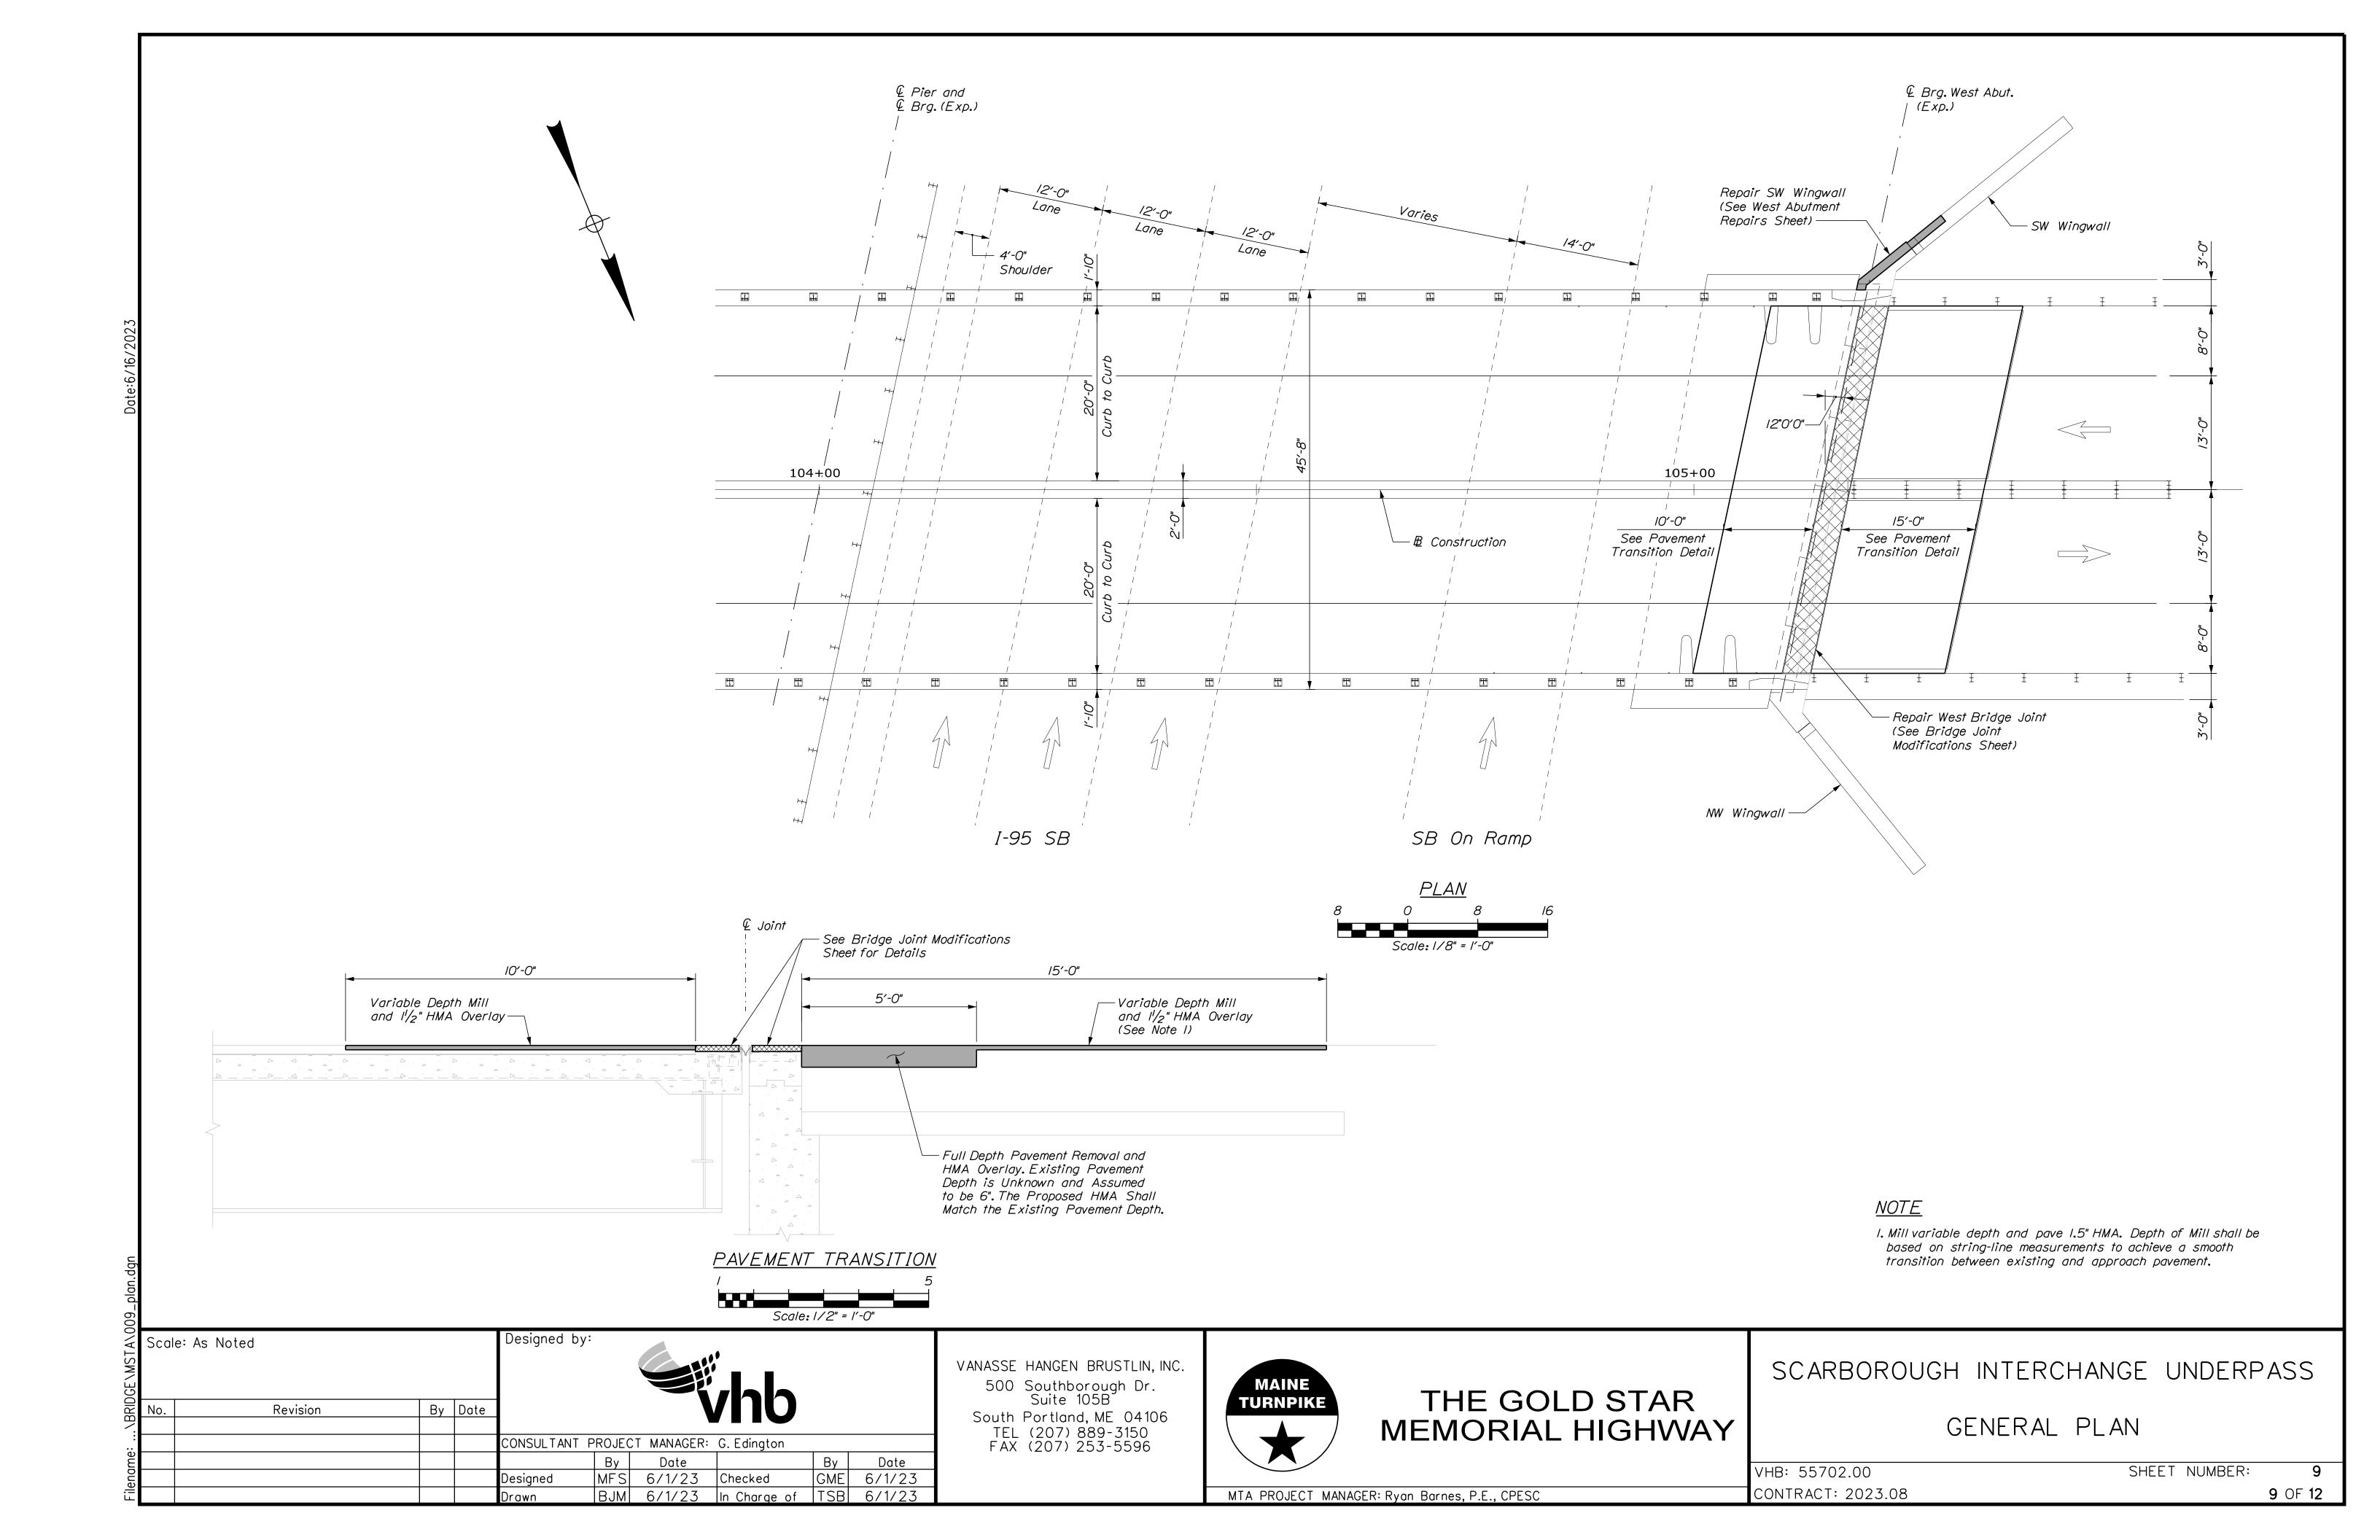
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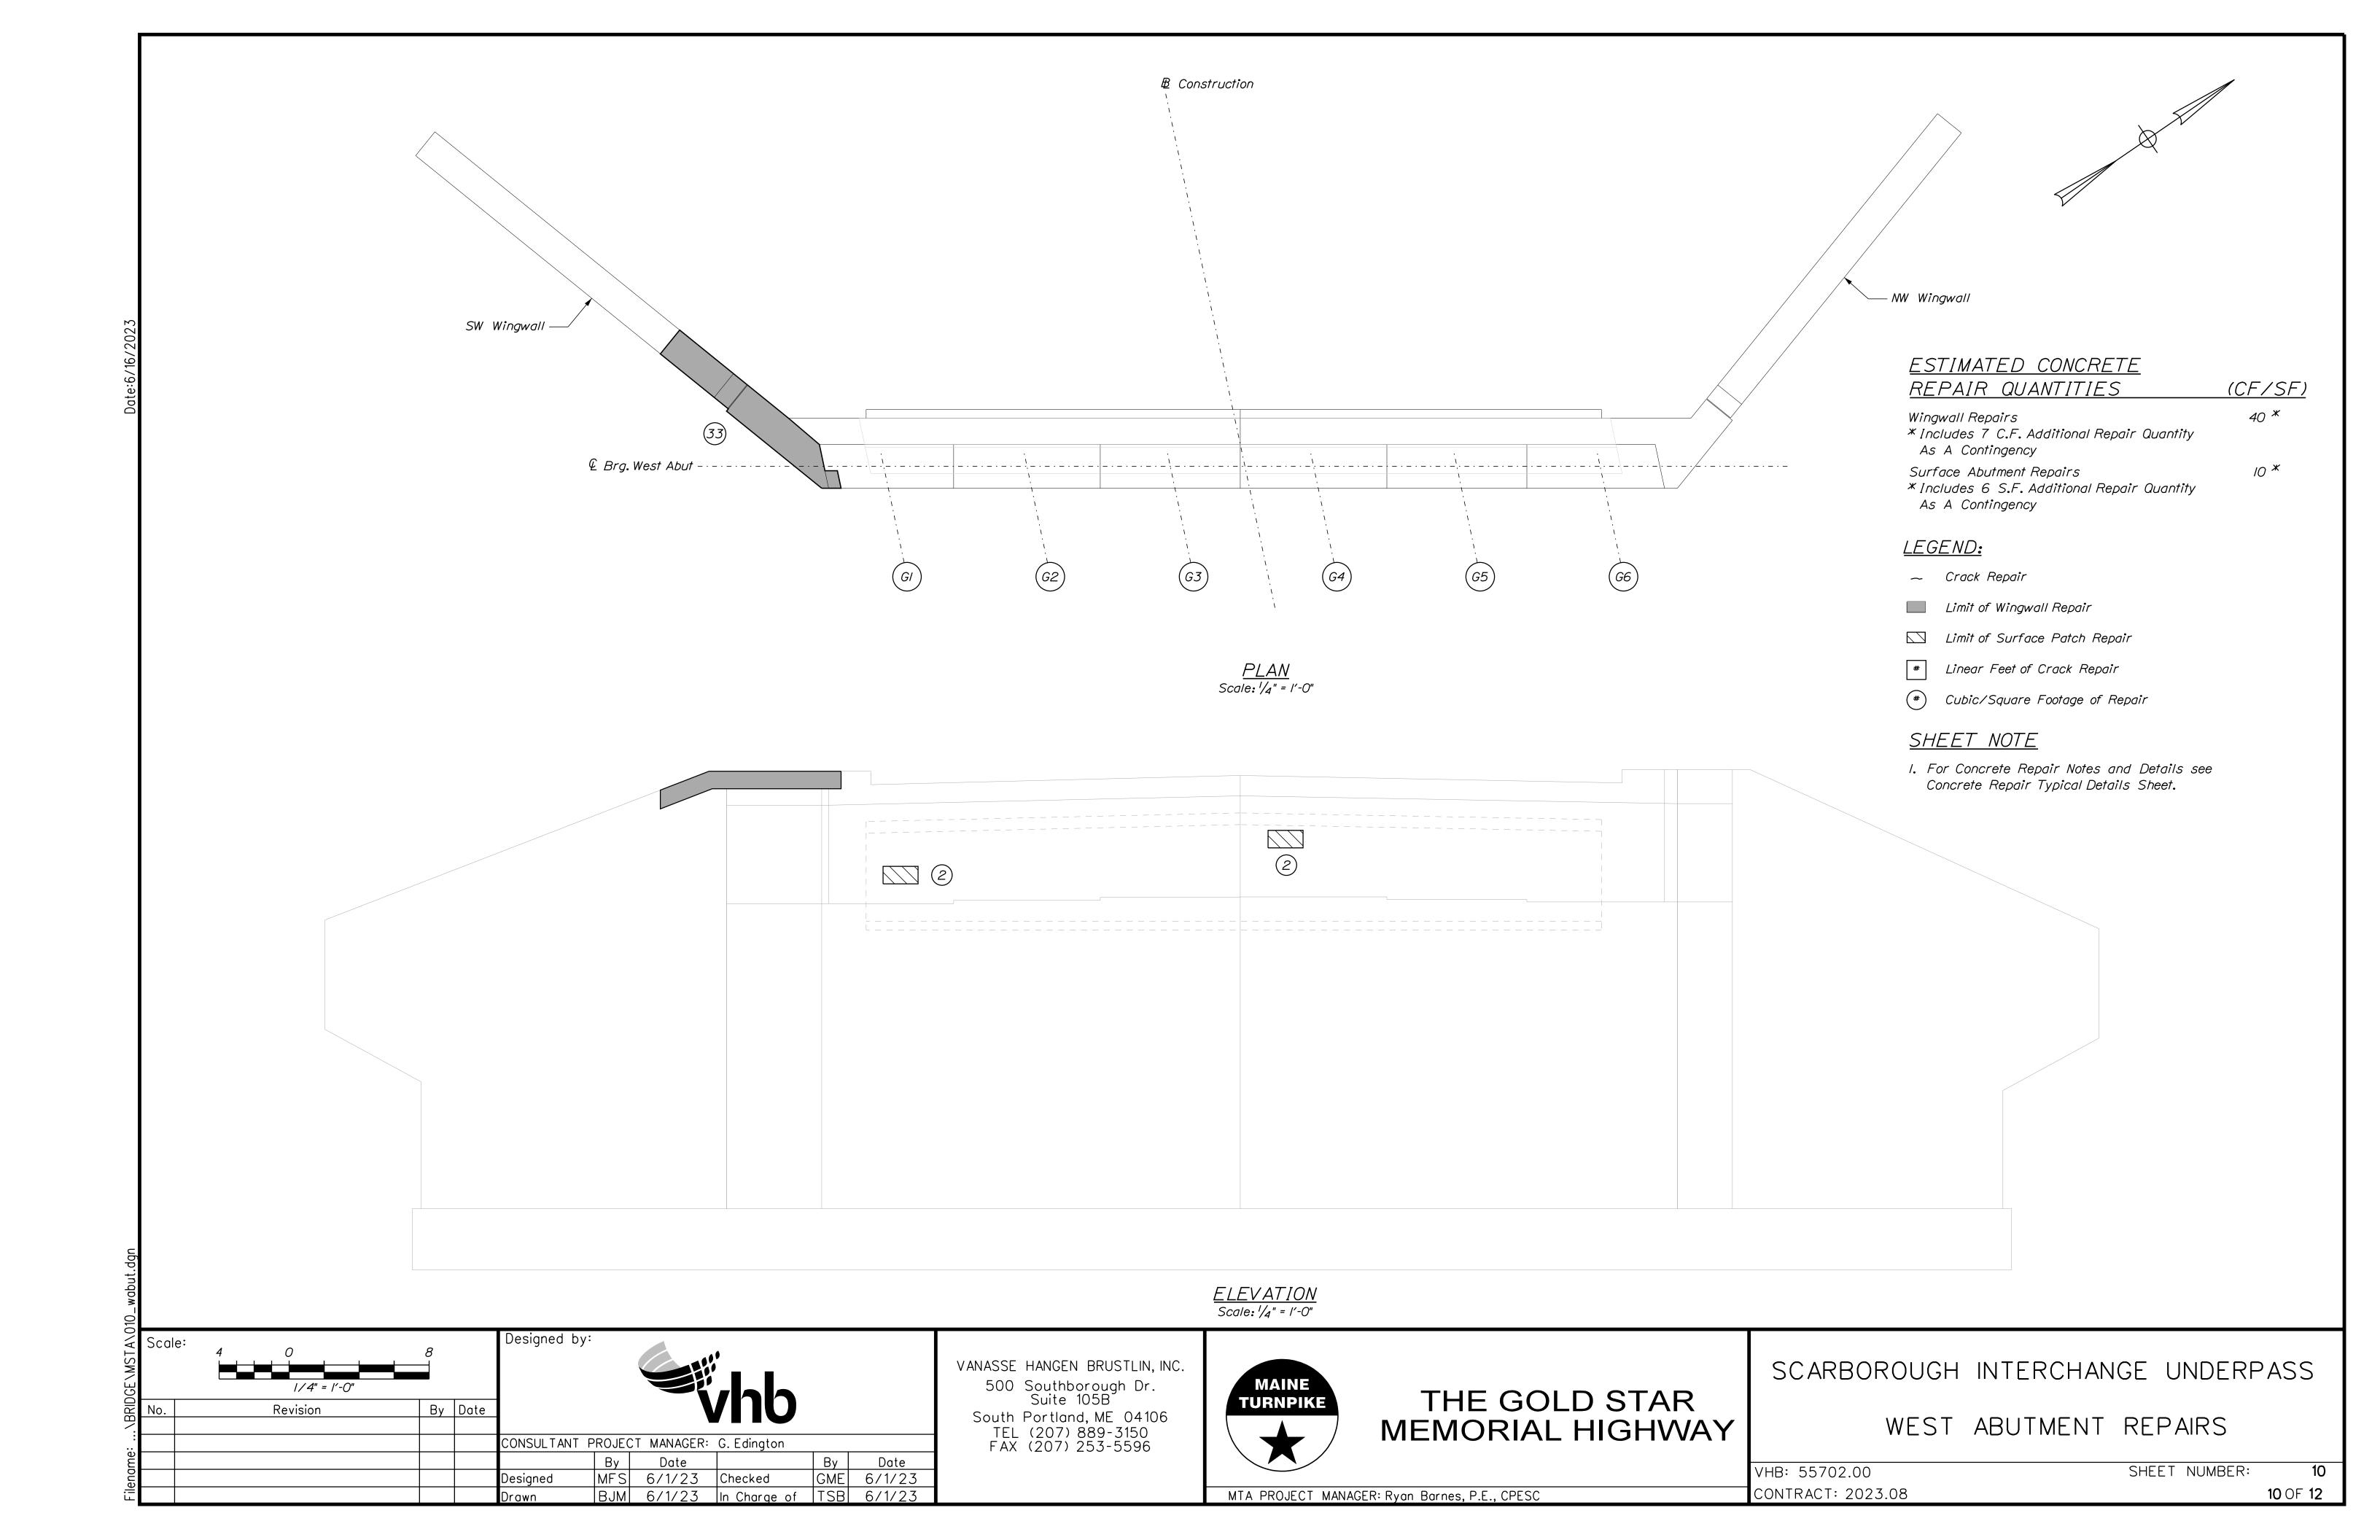
 CONTRACT: 2023.08
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MTA PROJECT MANAGER: Ryan Barnes, P.E., CPESC







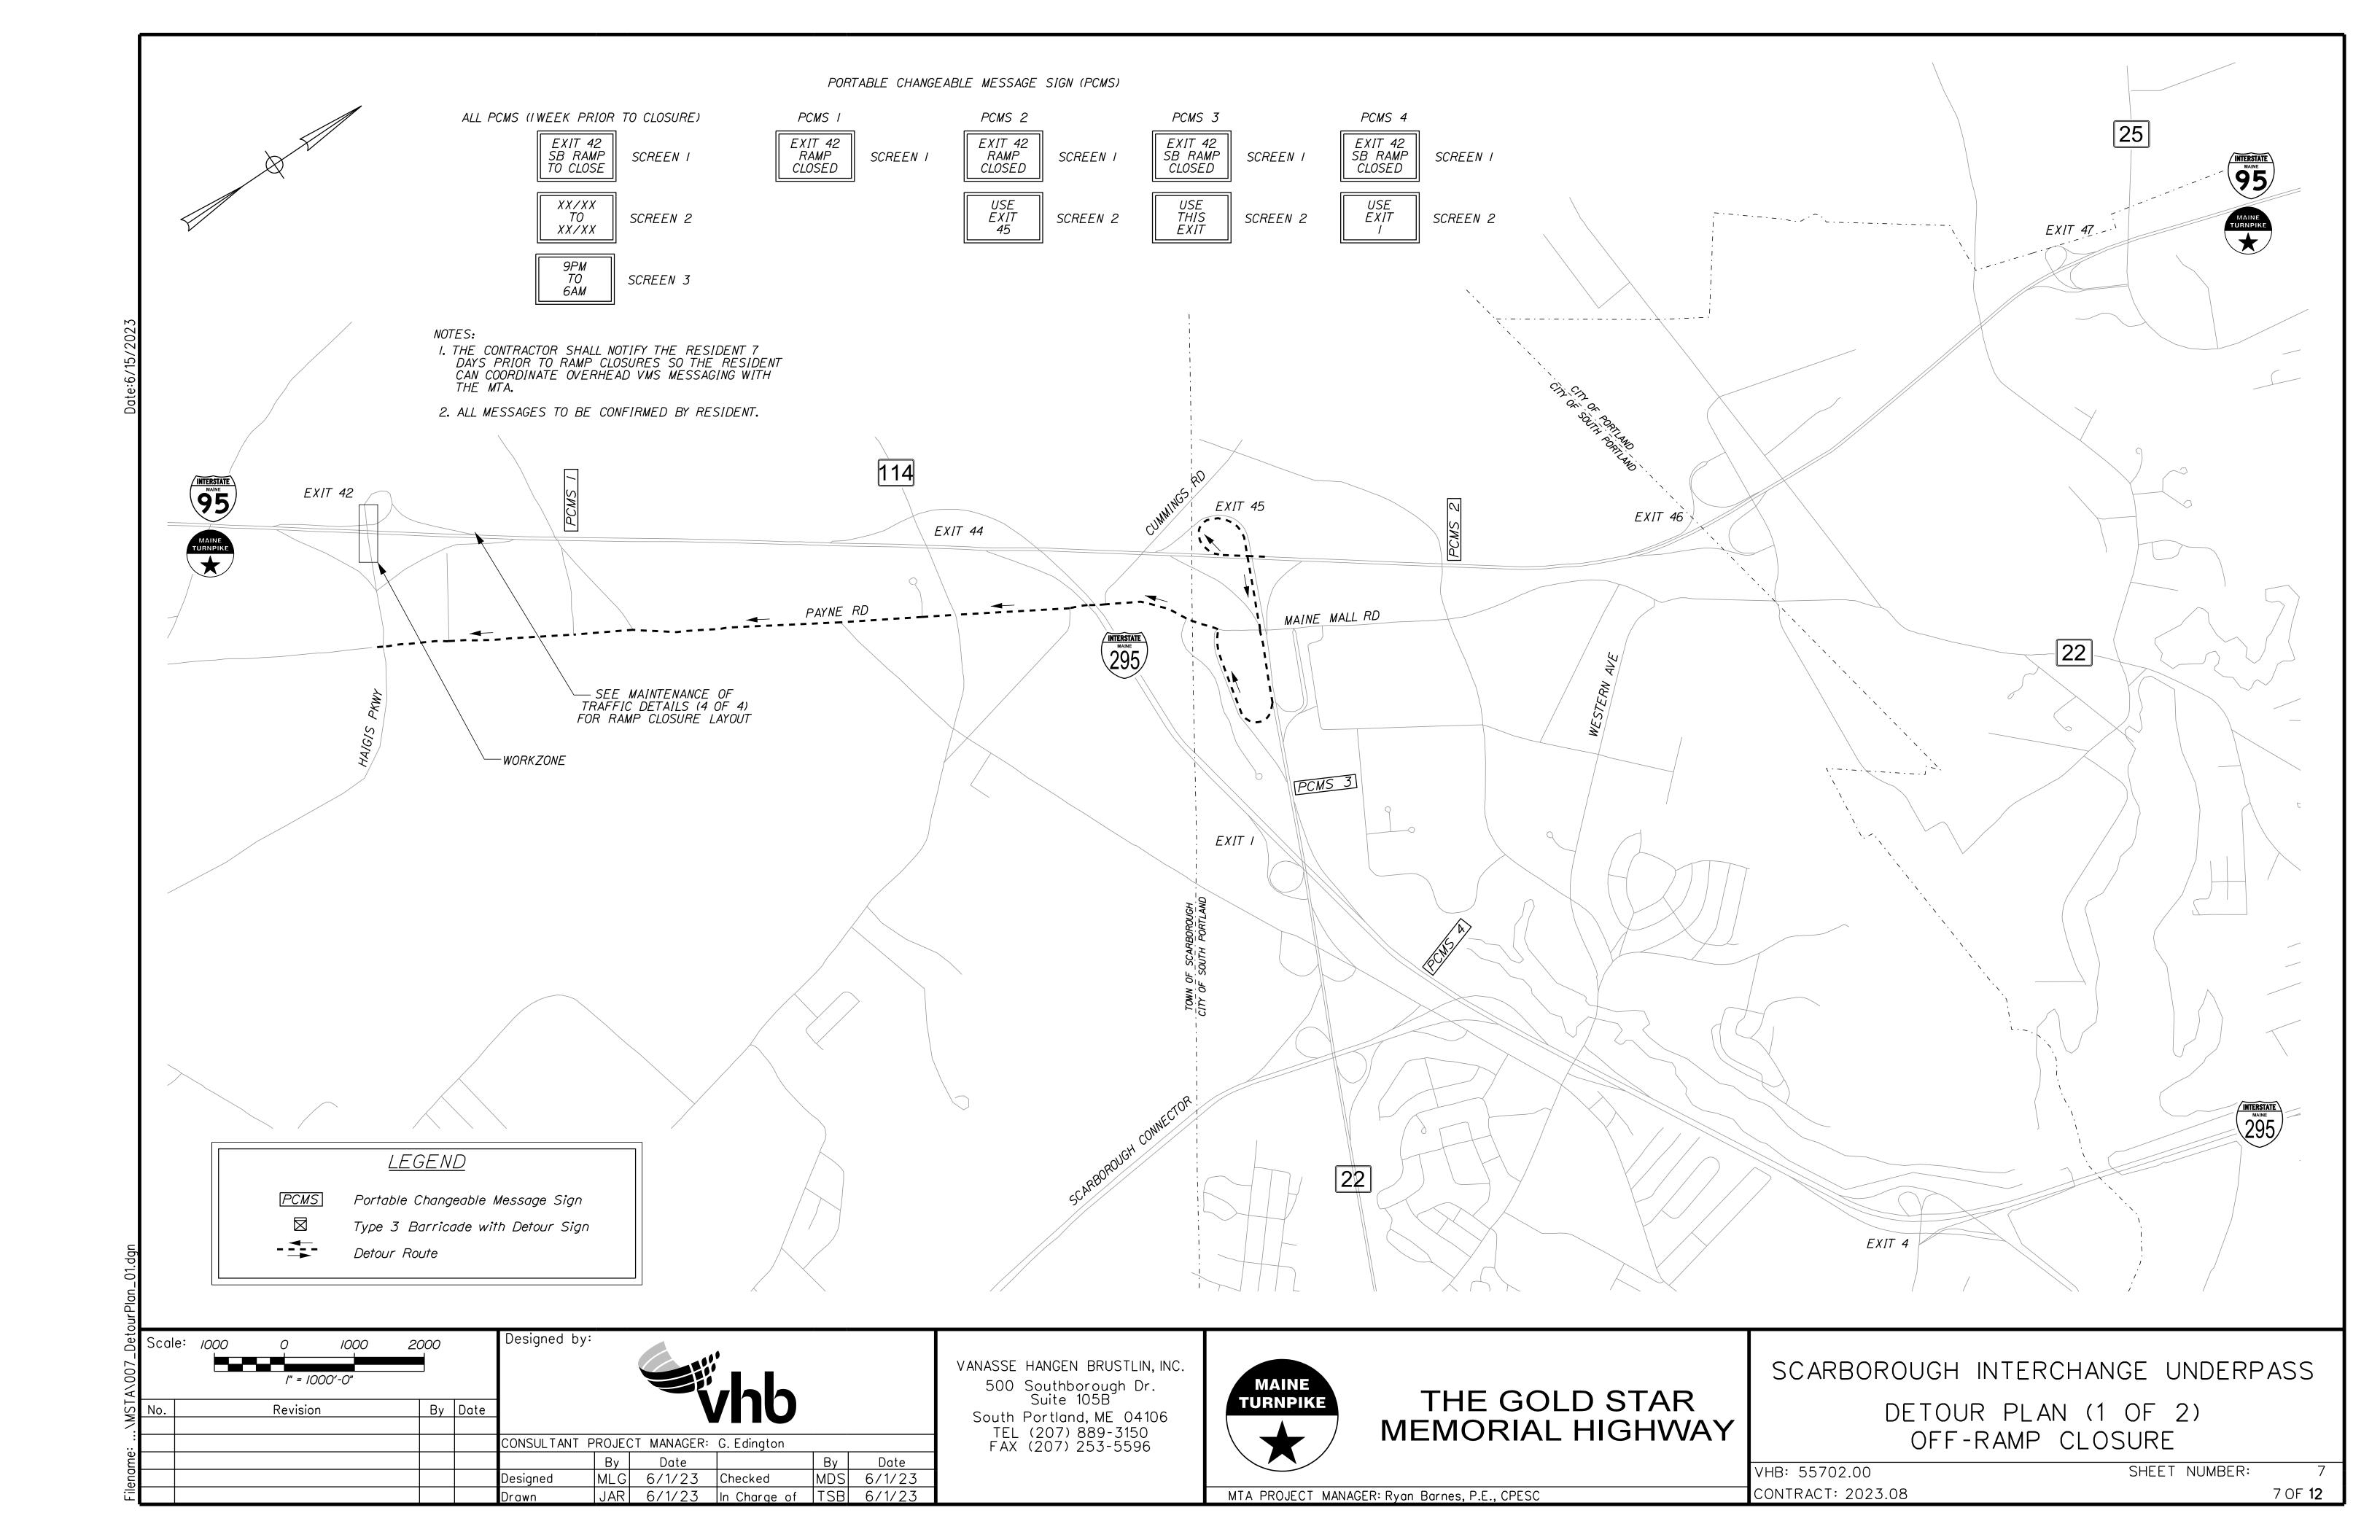

TYPICAL HORIZONTAL SURFACE CONCRETE REPAIR DETAILS

Limit of Measurement I" Min. Sawcut (Typ.) Existing - Limits of Full Depth Concrete Repair Reinforcement to Consist of Removal and Placement. Existing Reinforcement to Remain (Typ.) (Typ.) — - Face of Concrete


TYPICAL FULL DEPTH CONCRETE REPAIR DETAILS

CONCRETE REPAIR NOTES


- I. Repair work shall include: surface concrete repairs, epoxy in jection crack repair and providing access for inspection.
- 2. Where surface concrete repairs are specified the work shall include removal of unsound concrete and placement and curing of repair materials. Repairs shall be measured for payment under Item 518.10 Abutment Repairs.
- 3. Prior to the start of any concrete repairs the Resident and the Contractor shall sound all concrete surfaces and agree on the repair limits. Estimated repair quantities may increase at the Resident's discretion.
- 4. The estimated repair quantities are based on inspections completed in May 2023.

CONCRETE REPAIR PROCEDURE

- I. Perform I" deep saw cuts along limits of removal.
- 2. Chip concrete to the depth specified in Supplemental Specification 518. If the removal limits change during the demolition process the Contractor shall notify the Resident. The Resident and Contractor shall agree on the revised pay limits prior to the Contractor continuing the removal.
- 3. Prepare and patch repair areas with Class AAA modified concrete or other materials selected from the applicable non-emergency list of materials in Supplemental Specification 518.
- 4. Perform general finishing.

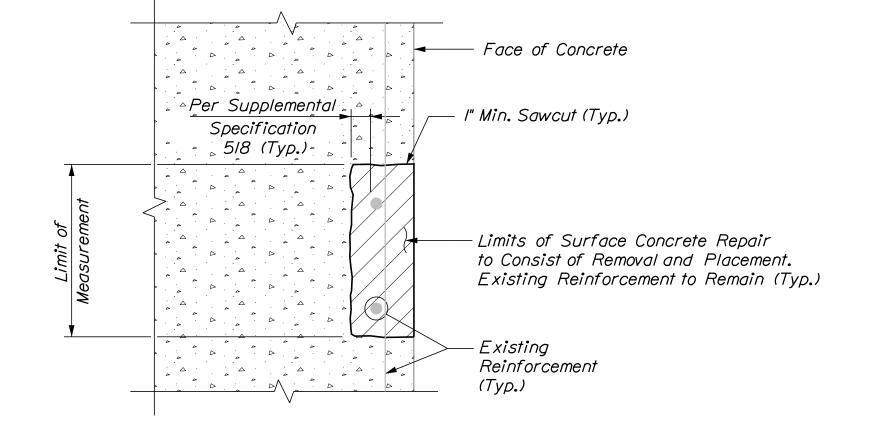

TYPICAL VERTICAL SURFACE CONCRETE REPAIR DETAILS

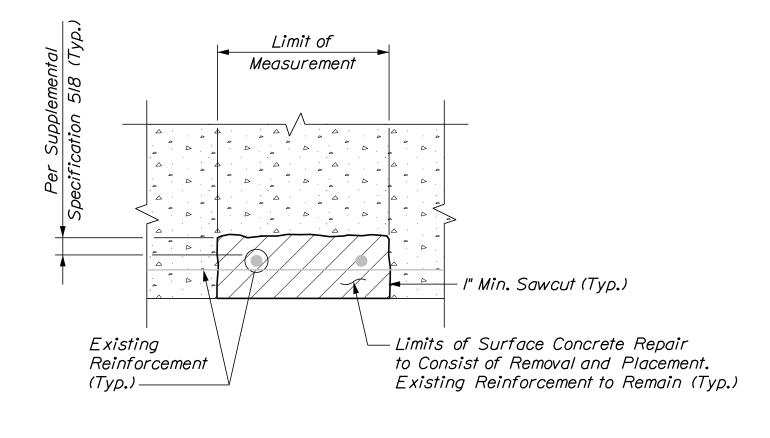

TYPICAL OVERHEAD SURFACE CONCRETE REPAIR DETAILS

Designed by: Scale: NOT TO SCALE By Date Revision CONSULTANT PROJECT MANAGER: G. Edington Ву Date GME 6/1/23 6/1/23 Checked Designed In Charge of TSB BJM 6/1/23 6/1/23

<u>KEY</u>

Existing Concrete

// Proposed Concrete

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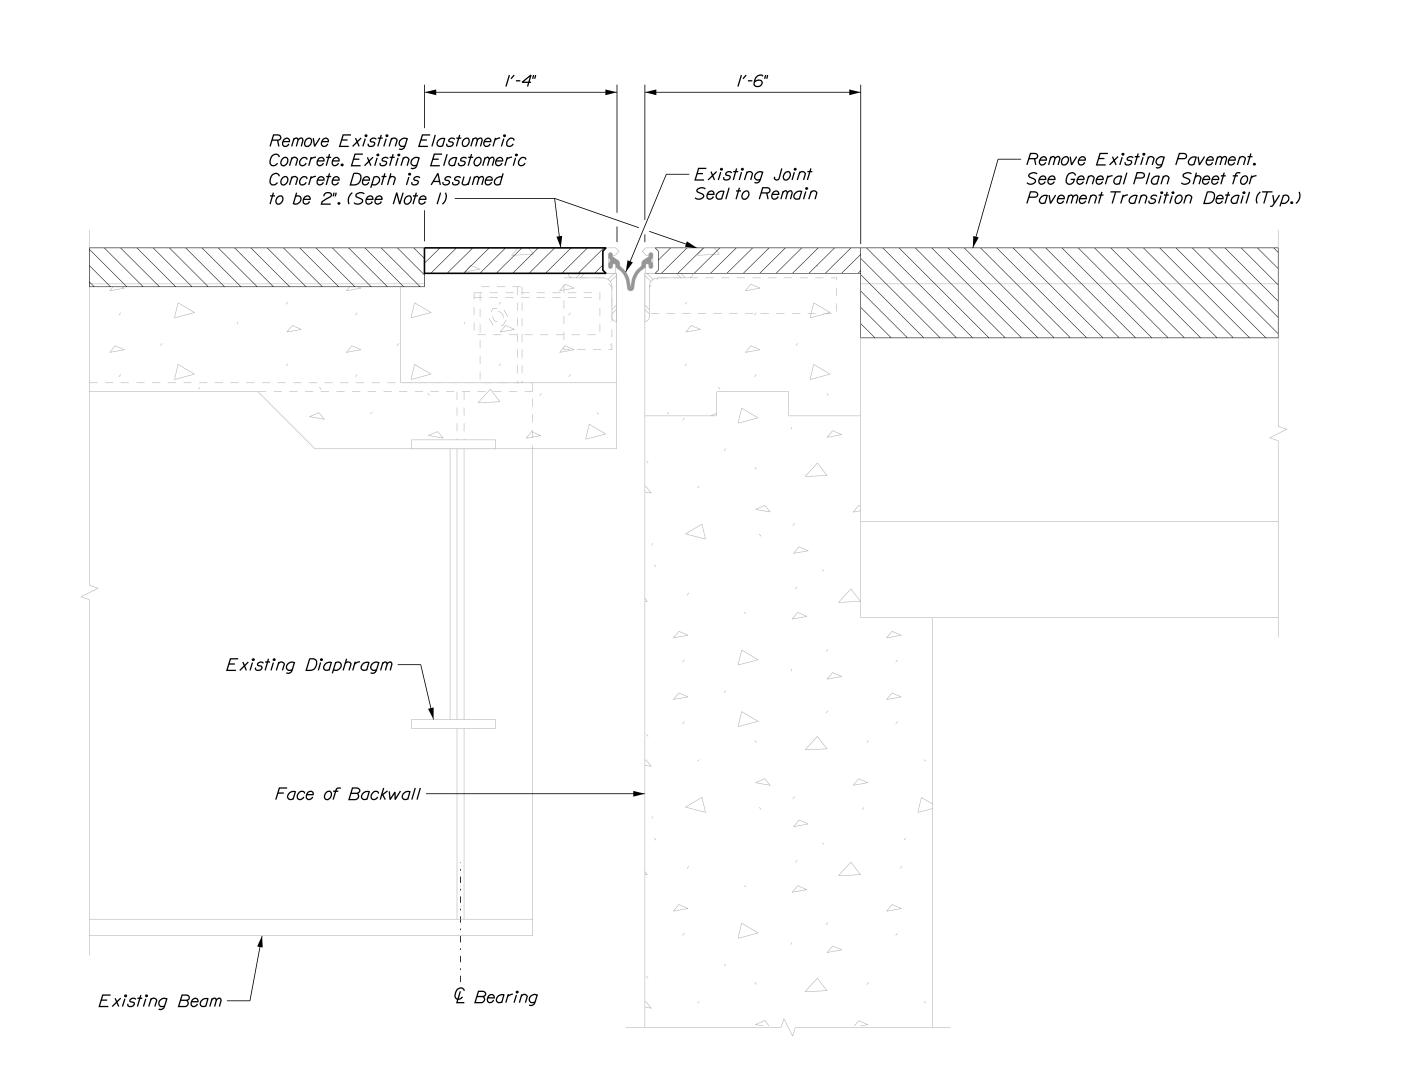


THE GOLD STAR MEMORIAL HIGHWAY SCARBOROUGH INTERCHANGE UNDERPASS CONCRETE REPAIR TYPICAL DETAILS

VHB: 55702.00 SHEET NUMBER: CONTRACT: 2023.08

MTA PROJECT MANAGER: Ryan Barnes, P.E., CPESC

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EXISTING JOINT

Not to Scale

Install 2" Elastomeric Concrete See General Plan Sheet — See General Plan Sheet Header. (See Note I) (Typ.) for Pavement Transition Detail for Pavement Transition Detail — Butt Joint (Typ.) — Repair Top of Backwall (See Note 2) **€** Bearing

/'-6**"**

PROPOSED JOINT Not to Scale

BRIDGE JOINT MODIFICATION (West Abutment)

<u>NOTES</u>

- I. Remove and place new elastomeric concrete header to the width and depth of the existing header. All labor, equipment, and materials necessary for removing the existing and installing the proposed elastomeric concrete shall be paid under Item 518.864, Elastomeric Concrete Header Repair.
- 2. Prior to placing the elastomeric concrete, the Contractor shall remove any areas of deteriorated concrete at the top of the backwall and prepare the concrete surface in accordance with Supplemental Specification Section 518 and as directed by the Resident. Once the area has been prepared, the Contractor shall place elastomeric concrete to fill the repair area. All costs for removing existing deteriorated concrete and preparing the concrete surface shall be incidental to Item 518.864, Elastomeric Concrete Header Repair.

Designed by: Scale: NOT TO SCALE By Date Revision CONSULTANT PROJECT MANAGER: G. Edington Ву Date Date MFS 6/1/23 Checked GME 6/1/23 Designed BJM 6/1/23 In Charge of TSB 6/1/23

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THE GOLD STAR MEMORIAL HIGHWAY SCARBOROUGH INTERCHANGE UNDERPASS

BRIDGE JOINT MODIFICATIONS

SHEET NUMBER: VHB: 55702.00

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