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General and Construction Notes

Details (2 Sheets)

General Plans (2 Sheets)


Cross Sections (16 Sheets)

Fencing Details

Estimated Quantities and Earthwork Summary

Maintenance of Traffic Details (2 Sheets)

Disturbance Impact Plans (2 Sheets)

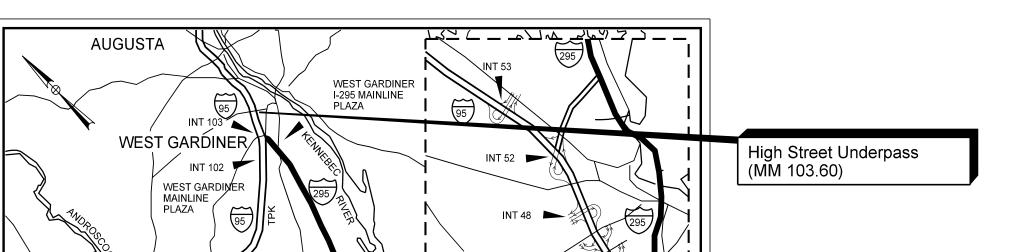




# MAINE TURNPIKE AUTHORITY

DANIEL E. WATHEN, CHAIR MICHAEL J. CIANCHETTE, VICE CHAIR BETTYANN SHEATS, MEMBER ANDREW MCLEAN, MEMBER JANE L. LINCOLN, MEMBER THOMAS J. ZUKE, MEMBER BRUCE A. VAN NOTE, EX-OFFICIO MEMBER

S. PETER MILLS, EXECUTIVE DIRECTOR

**CONTRACT 2023.04** 

**EMERGENCY VEHICLE RAMPS HIGH STREET (MM 103.60)** 

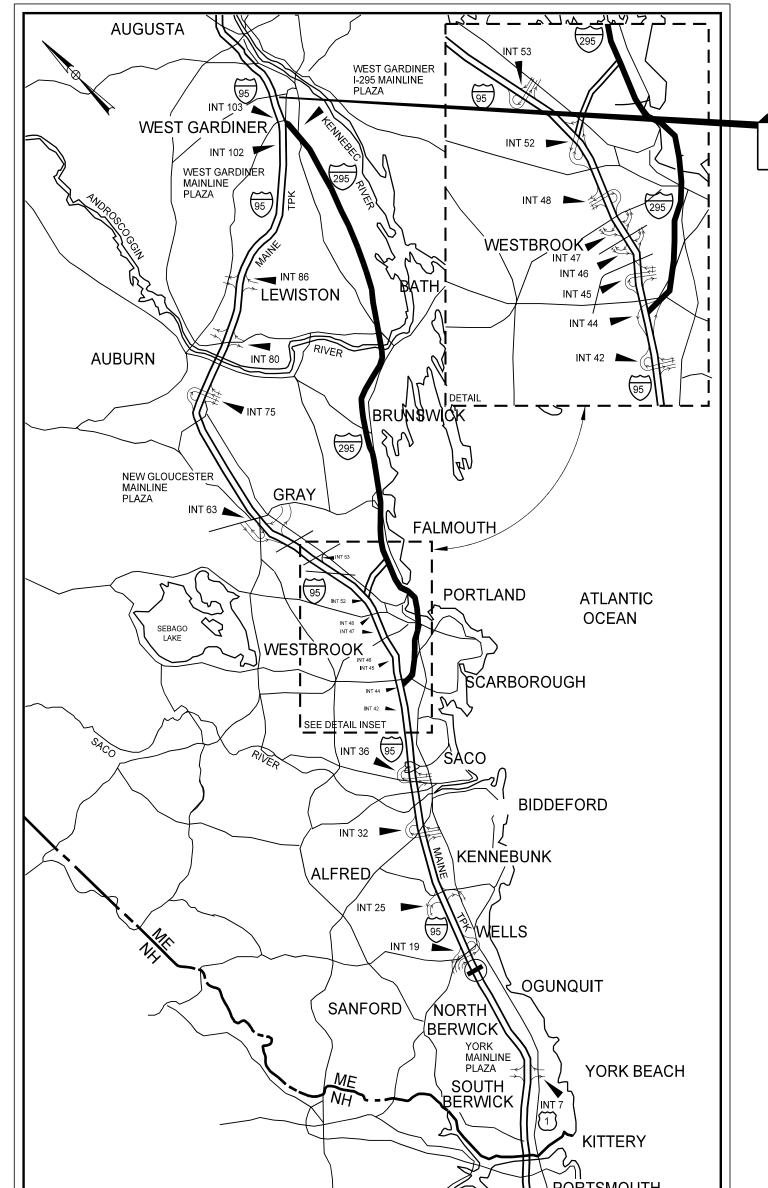


**LOCATION MAP** 

APPROVED:

MAINE TURNPIKE AUTHORITY



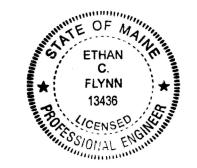



Ethan C. Flynn, P.E. Consultant Project Manager

6/21/2023 DATE

	ESTIMATED QUANTITIES		
			Oughtity
ITEM NO.	DESCRIPTION	UNIT	Quantity Total
201.11	Clearing	AC	0 <b>.</b> 56
201.11	Removing Single Tree Top Only	EA	2
201.24	Removing Stump	EA	2
203.2	Common Excavation	CY	2,700
203.24	Common Borrow	CY	3.500
203.25	Granular Borrow	CY	625
304.1	Aggregate Subbase Course-Gravel	CY	1,540
304.14	Aggregate Base Course - Type A	CY	430
403.207	Hot Mix Asphalt, 19.0 mm Nominal Maximum Size (Base)	TON	300
403.208	Hot Mix Asphalt, 12.5 mm Nominal Maximum Size (Surface)	TON	186
409.15	Bituminous Tack Coat RS-I or RSIh - Applied	GAL	87
419.3	Sawing Bituminous Pavement	LF	800
603.159	12 inch Culvert Pipe Option III	LF	10
603.179	IB inch Culvert Pipe Option III	LF	43
603.199	24 inch Culvert Pipe Option III	LF	110
604.169	Remove Catch Basin	EA	1
604.246	Catch Basin Type F5	EA	,
606.1301	31" W-Beam Guardrail, Mid-Way Splice - Single Faced	LF	225
606.1304	31" W-Beam Guardrail, Mid-Way Splice - Over 15' Radius	LF	225
606./305	31" W-Beam Guardrail, Mid-Way Splice - Flared Terminal	EA	1
606.1351	31" W-Beam Guardrail, Mid-Way Splice - Terminal End - Anchored End	EA	6
606.353	Reflectorized Flexible Guardrail Marker	EA	6
606.3561	Delineator Post - Remove and Reset	EA	6
607.17	Chain Link Fence - 6 foot	LF	200
607.32	Bracing Assembly Type I - Metal Posts	EA	4
607.33	Bracing Assembly Type II - Metal Posts	EA	5
609.31	Curb Type 3	LF	50
6/0.08	Plain Riprap	CY	10
610.181	Temporary Stone Check Dam	CY	20
6/3.3/9	Erosion Control Blanket	SY	1,280
6/5.07	Loam	CY	450
618.14	Seeding Method Number 2	UNIT	37
619.1201	Mulch - Plan Quantity	UNIT	37
619.1202	Temporary Mulch	LS	1
620.58	Erosion Control Geotextile	SY	55
629.05	Hand Labor, Straight Time	HR	30
631.12	All Purpose Excavator (including operator)	HR	30
<i>631.</i> 171	Truck - small (including operator)	HR	60
<i>631.32</i>	Culvert Cleaner (including operator)	HR	8
<i>631.36</i>	Foreperson	HR	16
645,271	Regulatory, Warning, Confirmation and Route Assembly Sign, Type I	SF	67
652.361	Maintenance of Traffic Control Devices	LS	1
<i>652.38</i>	Flaggers	HR	100
<i>656.</i> 5	Baled Hay, in place	EΑ	30
656.632	30 inch Temporary Silt Fence	LF	I <b>,</b> 840
659./	Mobilization	LS	1
827.37	Electrical Conduit Trenching	LF	35

<sup>\*</sup> Quantities are Estimated Only

Scale:				Designed b	y:			h	
No.	Revision	Ву	Date	-			VII	U	
				CONSULTANT	PROJEC	CT MANAGER:	E. Flynn		
ב					Ву	Date		Ву	Date
				Designed	BMD	6/21/23	Checked	ECF	6/21/2
				Drawn	AHS	6/21/23	In Charge of	AG	6/21/2

VANASSE HANGEN BRUSTLIN, INC. 500 Southborough Dr. Suite 105B South Portland, ME 04106 TEL (207) 889-3150 FAX (207) 253-5596

HIGH STREET EMERGENCY VEHICLE RAMPS ESTIMATED QUANTITIES AND EARTHWORK SUMMARY

SHEET NUMBER: HB: 55639.00 NTRACT: 2023.04 2 OF 31

NORTHBOUND EVR EARTHWORK SUMMARY

1,237

259

259

1,223 259

259

259

259

637

259

2,594

169

342

342 x 1.00 =

 $708 \times 0.90 =$ 

 $149 \times 0.90 =$ 

259 x 1.00 =

1,755

1,741

1,755

1,047

1,741

844

943

3,105

943

794

149

3,105

2,971

2,629

COMMON EXCAVATION FOR ESTIMATE

**FILL FOR BORROW CALCULATIONS** 

(1) TOTAL COMMON EXCAVATION

**GRUBBING IN CUT** 

**GRUBBING IN FILL** 

(2) TOTAL DEDUCTIONS

MUCK EXCAVATION

GRANULAR BORROW =

TOTAL AVAIL. NON-ROCK EXCAV.

(4)TOTAL AVAILABLE EXCAVATION

**COMMON EXCAVATION FOR ESTIMATE** 

FILL FOR BORROW CALCULATIONS

(1) TOTAL COMMON EXCAVATION

GRUBBING IN CUT

**GRUBBING IN FILL** 

MUCK EXCAVATION

GRANULAR BORROW =

TOTAL AVAIL. NON-ROCK EXCAV.

(4)TOTAL AVAILABLE EXCAVATION

COMMON FILL (FROM CROSS SECTIONS)

COMMON FILL (FROM CROSS SECTIONS)

GRUBBING IN FILL

GRUBBING IN FILL

TOTAL FILL

(3)TOTAL FILL

**GRUBBING IN FILL** 

GRUBBING IN FILL

TOTAL FILL

(3)TOTAL FILL

MUCK EXCAVATION

**DEDUCTIONS**:

(2) TOTAL DEDUCTIONS

MUCK EXCAVATION

MUCK EXCAVATION

**DEDUCTIONS**:

MUCK EXCAVATION

COMMON EXCAVATION (FROM CROSS SECTIONS)

TOTAL COMMON EXCAVATION (for estimate)

AVAILABLE COMMON EXCAVATION FOR BORROW CALCULATIONS

TOTAL AVAILABLE COMMON EXCAVATION (1) MINUS (2)

BORROW NEEDED = TOTAL FILL MINUS TOTAL AVAILABLE EXCAVATION

SOUTHBOUND EVR EARTHWORK SUMMARY

COMMON BORROW NEEDED = BORROW NEEDED MINUS GRANULAR BORROW

COMPUTATION OF GRANULAR BORROW FOR ESTIMATE

COMPUTATION FOR COMMON BORROW FOR ESTIMATE

GRANULAR BORROW TO REPLACE MUCK

COMMON EXCAVATION (FROM CROSS SECTIONS)

TOTAL COMMON EXCAVATION (for estimate)

**AVAILABLE COMMON EXCAVATION FOR BORROW CALCULATIONS** 

TOTAL AVAILABLE COMMON EXCAVATION (1) MINUS (2)

COMPUTATION OF GRANULAR BORROW FOR ESTIMATE

COMPUTATION FOR COMMON BORROW FOR ESTIMATE

GRANULAR BORROW TO REPLACE MUCK

GRANULAR BORROW TO REPLACE MUCK

	BORROW NEEDED = TOTAL FILL MINU GRANULAR BORROW TO REPLACE M COMMON BORROW NEEDED = BORROW NE	1UCK
MAINE TURNPIKE	THE GOLD STAR MEMORIAL HIGHWAY	HIGH EMERGENCY Y ESTIMATED AND EARTHW
MTA PROJECT MANAG	ER: Ryan Barnes, PE	VHB: 55639.00 CONTRACT: 2023.04

- I. ALL WORK SHALL BE IN CONFORMANCE WITH MAINE DEPARTMENT OF TRANSPORTATION (MAINEDOT) 2020 STANDARD DETAILS AND 2014 STANDARD SPECIFICATIONS WITH ALL UPDATES, AND MAINEDOT BEST MANAGEMENT PRACTICES FOR EROSION AND SEDIMENT CONTROL LATEST REVISION UNLESS OTHERWISE NOTED IN THESE PLANS.
- 2. DURING CONSTRUCTION, TRAFFIC WILL BE MAINTAINED AS SHOWN IN THE PLANS AND AS REQUIRED IN THE SPECIAL PROVISIONS.
- 3. ALL EXISTING DELINEATOR AND MILE MARKER POSTS WITHIN LIMITS OF DISTURBANCE SHALL BE REMOVED AND RESET UPON COMPLETION OF THE CONTRACT. PAYMENT WILL BE MADE UNDER ITEM 606.3561.
- 4. EXISTING ROW FENCE AND EXISTING CHAIN LINK
  FENCE AND GATES WITHIN THE LIMITS OF WORK, AS SHOWN
  ON THE PLANS OR AS DIRECTED BY THE RESIDENT, SHALL
  BE REMOVED AND DISPOSED. THIS WORK SHALL BE
  INCIDENTAL TO THE PROPOSED FENCE ITEMS. PROPOSED
  CHAIN LINK FENCE AND PIPE ENTRY GATE SHALL BE
  INSTALLED CONTINUOUSLY WITH NO GAPS. IF REQUIRED,
  CONNECTION FOR PROPOSED FENCE TO EXISTING FENCE
  SHALL BE INCIDENTAL TO THE CONTRACT.
- 5. THE PROPOSED ELEVATIONS ARE BASED ON THE NAVD 88 DATUM.
- 6. THE CONTRACTOR SHALL TAKE ALL PRECAUTIONS
  NECESSARY TO AVOID IMPACTS BEYOND WHAT IS SHOWN IN
  THESE PLANS TO DELINEATED WETLAND AREAS.
- 7. ALL WORK MUST BE COMPLETED WITHIN THE RIGHT OF WAY SHOWN IN THESE PLANS.
- 8. THE CONTRACTOR SHALL SUBMIT PROPOSED STAGING AREA(S) AND FIELD TRAILER LOCATION TO THE RESIDENT FOR APPROVAL PRIOR TO STARTING WORK.
- 9. THE CONTRACTOR SHALL PLACE APPROACH PAVEMENT AT ALL LOCATIONS TO ACHIEVE A SMOOTH TRANSITION BETWEEN EXISTING AND PROPOSED PAVEMENT.
- IO. FOLLOWING THE COMPLETION OF WORK THE CONTRACTOR SHALL PROVIDE THE AUTHORITY THREE HARD COPIES OF ALL O&M MANUALS ASSOCIATED WITH THE PROJECT AND ONE LINKED, TABBED, AND SEARCHABLE PDF DOCUMENT CONTAINING ALL O&M MANUALS IN A SINGLE FILE.
- II. FOLLOWING THE COMPLETION OF WORK THE CONTRACTOR SHALL PROVIDE ONE HARD COPY AND ONE LINKED, TABBED, AND SEARCHABLE PDF DOCUMENT OF ALL APPROVED SUBMITTALS ASSOCIATED WITH THE PROJECT ORGANIZED BY WORK CATEGORY.

## DRAINAGE

- I. NO EXISTING DRAINAGE SHALL BE ABANDONED, REMOVED OR PLUGGED WITHOUT PRIOR APPROVAL OF THE RESIDENT.
- 2. INLETS AND OUTLETS OF ALL CULVERTS SHALL BE RIPRAPPED UNLESS OTHERWISE NOTED ON THE PLANS OR DIRECTED BY THE RESIDENT.
- 3. ALL DITCH ELEVATIONS AND OFFSETS SHOWN ON THE CROSS SECTIONS ARE FOR THE FINISHED DITCH FLOW LINE.
- 4. IF FOUNDATION MATERIAL IS REQUIRED UNDER CULVERTS, IT SHALL MEET THE REQUIREMENTS FOR GRANULAR BORROW UNDERWATER BACKFILL AS SPECIFIED IN STANDARD SPECIFICATION 703.19 AND BE PAID FOR AS 203.25 GRANULAR BORROW.

### EARTHWORK

- I. THE CLEARING LIMITS SHALL BE 10' BEYOND AND PARALLEL TO CONSTRUCTION SLOPE LINES OR AS SHOWN ON THE PLANS. THE ACTUAL CLEARING LINES SHALL BE ESTABLISHED IN THE FIELD BY THE CONTRACTOR AND SHALL BE APPROVED BY THE RESIDENT PRIOR TO ANY CLEARING TAKING PLACE. ALL CLEARING SHALL BE DONE WITHIN THE ROW.
- 2. THE NORMAL GRUBBING WIDTH IN THE FILLS SHALL BE VARIABLE LEFT OR RIGHT, WHEN SUBGRADE IS LESS THAN 5' ABOVE OLD GROUND. THE GRUBBING DEPTH HAS BEEN ESTIMATED AS 12".
- 3. MUCK EXCAVATION HAS BEEN ESTIMATED IN ALL WETLAND AREAS AT A 2' DEPTH. THE CONTRACTOR SHALL CONFIRM WITH THE RESIDENT THE ACTUAL LIMITS AND DEPTH BEFORE PLACING ANY AGGREGATE.
- 4. WASTE MATERIALS SHALL BE DISPOSED OFF THE PROJECT SITE, IN ACCORDANCE WITH CHAPTER 404, DEPARTMENT OF ENVIRONMENTAL PROTECTION SOLID WASTE MANAGEMENT RULES.
- 5. EXCAVATIONS ACCOMPLISHED AS PART OF THIS PROJECT SHALL BE CONSTRUCTED IN ACCORDANCE WITH OSHA SUBPART P OF 29 CFR PART 1926.650-652 (CONSTRUCTION STANDARDS FOR EXCAVATION).
- 6. THE CONTRACTOR SHALL MINIMIZE SLOPE DISTURBANCES WHERE POSSIBLE, AS DIRECTED BY THE RESIDENT.
- 7. GRANULAR BORROW USED TO BACKFILL MUCK EXCAVATION, IN LOW WET AREAS I' ABOVE WATER LEVEL, OR OLD GROUND SHALL MEET REQUIREMENTS FOR GRANULAR BORROW MATERIAL FOR UNDERWATER BACKFILL AS SPECIFIED IN STANDARD SPECIFICATION 703.19 AND BE PAID FOR AS 203.25 GRANULAR BORROW.

#### **GUARDRAIL**

- I. COMPOSITE OFFSET BLOCKS SHALL BE USED WITH GUARDRAIL.
- 2. AT THE END OF EACH WORK DAY, ALL GUARDRAIL WITHIN WORK AREAS ACCESSIBLE TO TRAFFIC SHALL HAVE AN APPROVED CRASHWORTHY END TREATMENT.
- 3. CONNECTIONS FOR PROPOSED GUARDRAIL TO EXISTING GUARDRAIL SHALL BE INCIDENTAL TO THE PROPOSED GUARDRAIL ITEMS.
- 4. ALL EXISTING GUARDRAIL REMOVED AND NOT RESUSED ON THE PROJECT WILL BECOME THE PROPERTY OF THE CONTRACTOR. REMOVAL AND DISPOSAL SHALL BE CONSIDERED INCIDENTAL TO THE GUARDRAIL ITEMS.
- 5. POST HOLES FROM GUARDRAIL REMOVED OR RESET SHALL BE FILLED AND COMPACTED WITH GRANULAR BORROW AND PAVEMENT TO MATCH SURROUNDING PAVEMENT THICKNESS.

## EROSION CONTROL

- I. THE ANTICIPATED EROSION CONTROL DEVICES ARE SHOWN ON THE PLANS. THE CONTRACTOR SHALL PROPOSE ACTUAL TYPE AND LOCATION OF DEVICES FOR APPROVAL BY THE RESIDENT. ADDITIONAL DEVICES MAY BE PROPOSED BY THE CONTRACTOR TO IMPLEMENT ADDITIONAL MEASURES. ANY ADDITIONAL MEASURES APPROVED BY THE RESIDENT WILL BE MEASURED FOR PAYMENT.
- 2.4" LOAM HAS BEEN ESTIMATED FOR 100% OF THE DISTURBED AREA UNLESS OTHERWISE SPECIFIED ON THE PLANS. ACTUAL PLACEMENT OF THE LOAM SHALL BE AS DESIGNATED BY THE RESIDENT.
- 3. ALL SLOPES SHALL BE SEEDED WITH SEEDING METHOD #2.
- 4. TEMPORARY SEED SHALL BE APPLIED TO ALL DISTURBED AREAS THAT WILL NOT BE COMPLETED WITHIN 30 DAYS.

- 5. ALL TEMPORARY AND PERMANENT EROSION CONTROL DEVICES SHALL BE INSTALLED IN ACCORDANCE WITH THE MAINE DEPARTMENT OF TRANSPORTATION BEST MANAGEMENT PRACTICES.
- 6. TEMPORARY STONE CHECK DAMS SHALL BE INSTALLED IN ACCORDANCE WITH THE MAINE DEPARTMENT OF TRANSPORTATION BEST MANAGEMENT PRACTICES. STONE CHECK DAMS SHALL BE SPACED APPROXIMATELY 100 FEET FOR DITCH GRADES LESS THAN 3% AND SPACED APPROXIMATELY 50 FEET FOR DITCH GRADES STEEPER THAN 5%. SEE MAINEDOT BEST MANAGEMENT PRACTICES FOR FURTHER DETAILS.
- 7. EROSION CONTROL BLANKET, ITEM 613.319 SHALL BE INSTALLED ON 2:1 SLOPES FROM THE TOP TO TOE OF SLOPE. LOAM AND SEED SHALL BE PLACED PRIOR TO THE INSTALLATION OF THE EROSION CONTROL BLANKET. LIMITS OF THE EROSION CONTROL BLANKET IN DITCHES SHALL BE 6'WIDE OR AS DESIGNATED BY THE RESIDENT.

#### UTILITY

- I. EXISTING UTILITIES ON THESE PLANS WERE COMPILED FROM FIELD SURVEY AND VARIOUS OTHER SOURCES.

  LOCATIONS ARE NOT GUARANTEED TO BE ACCURATE NOR IS IT GUARANTEED THAT ALL UTILITIES ARE SHOWN. NO SEPARATE OR ADDITIONAL COMPENSATION WILL BE ALLOWED TO THE CONTRACTOR DUE TO ANY VARIANCE BETWEEN THE DATA SHOWN ON THE PLANS AND THE ACTUAL FIELD CONDITIONS ENCOUNTERED. NO WORK SHALL BE STARTED UNTIL THE OWNERS OF THE VARIOUS UTILITIES ARE NOTIFIED BY THE CONTRACTOR OF THE PROPOSED CONSTRUCTION. THE CONTRACTOR SHALL CONTACT DIG SAFE (I-888-DIG-SAFE OR 8II) AT LEAST 72 HOURS PRIOR TO STARTING WORK.
- 2. THE CONTRACTOR SHALL CONTACT ALL NON-MEMBERS THROUGH WWW.OKTODIG.COM OR AS OTHERWISE REQUIRED BY THE MAINE PUBLIC UTILITIES COMMISSION. ALL PROPOSED EXCAVATION LOCATIONS SHALL BE MARKED AT THE TIME OF NOTIFICATION. NO EXCAVATION SHALL BE PERMITTED UNTIL THE AUTHORITY HAS LOCATED AND MARKED ITS UNDERGROUND UTILITIES. THE RESIDENT SHALL BE PROVIDED A DIGITAL COPY OF ALL DIG SAFE TICKETS WITHIN 24 HOURS OF THEIR RELEASE FOR PROJECT NOTIFICATIONS AND THIRD PARTY UTILITY LOCATOR COORDINATION.
- 3. THE CONTRACTOR SHALL NOTIFY THE RESIDENT 10 CALENDAR DAYS PRIOR TO SUBMITTING A UTILITY LOCATE REQUEST THROUGH DIG SAFE SO THAT THE RESIDENT CAN ARRANGE FOR MAINE TURNPIKE UNDERGROUND UTILITY LOCATION. ALL PROPOSED SIGN LOCATIONS AND EXCAVATION LOCATIONS SHALL BE MARKED AT THE NOTIFICATION TIME.
- 4. THE UTILITIES INVOLVED IN THIS CONTRACT ARE:

  CENTRAL MAINE POWER (CMP)

  CONSOLIDATED COMMUNICATIONS

  CHARTER COMMUNICATIONS. INC.
- 5. GRADING AROUND UTILITY POLES AND GUY WIRES, EXISTING OR PROPOSED, SHALL BE DONE BY HAND.
- 6. CONTRACTOR SHALL PROTECT ALL NEW AND EXISTING UTILITIES FROM DAMAGE DURING THE CONSTRUCTION AS APPROVED BY THE UTILITY OWNERS.

#### <u>ITEM 603.159 - 12" CULVERT PIPE OPTION III</u> HDPE ONLY

<u>LOCATION</u>	QUANTITY (LF)
HIGH ST SB EVR	
20+19 TO 20+29 LT	10

#### <u>ITEM 603.179 - 18" CULVERT PIPE OPTION III</u> HDPE ONLY

<u>LOCATION</u>	QUANTITY (LF
HIGH ST NB EVR	
14+64	<b>⊿</b> ₹

#### <u>ITEM 603.199 - 24" CULVERT PIPE OPTION III</u> HDPE ONLY

LOCATION	QUANTITY (LF)
HIGH ST SB EVR	
2I+38	<i>62</i>
22+00	48

#### ITEM 604.169 - REMOVE CATCH BASIN

<u>LOCATION</u>	QUANTITY (EA)
HIGH ST SB EVR	
20+12, 5,0' RT	/

#### ITEM 604.246 - CATCH BASIN TYPE F5

<u>LOCATION</u>	QUANTITY (EA)
HIGH ST SB EVR	
20+19, 25,6' LT	/

#### <u>ITEM 606.1301 - 31" W-BEAM GUARDRAIL,</u> MID-WAY SPLICE - SINGLE FACED

<u>OFFSET</u>	QUANTITY (L
RT	<i>34.</i> 5
LT	50
LT RT	25 25
LT RT	50 37 <b>.</b> 5
	RT LT LT RT LT

#### <u>ITEM 606.1304 - 31" W-BEAM GUARDRAIL</u>, MID-WAY SPLICE - OVER 15' RADIUS

STATION TO STATION	<u>OFFSET</u>	<u>RADIUS</u>	QUANTITY (LF
HIGH ST SB EVR			
20+12 TO 20+37	RT	20	<i>37.</i> 5
20+22 TO 20+64	LT	<i>2</i> 5	50
20+37 TO 2I+04	RT	60	100
20+64 TO 2I+02	LT	<i>40</i>	<i>37.</i> 5

#### <u>ITEM 606.1305 - 31" W-BEAM GUARDRAIL,</u> <u>MID-WAY SPLICE FLARED TERMINAL</u>

<u>STATION</u>	<u>OFFSET</u>	<u>QUANTITY (EA)</u>
HIGH ST NB EVR		
14+82 TO 14+85	RT	1

#### <u>ITEM 606.1351 - W-BEAM GUARDRAIL, MID-WAY SPLICE</u> TERMINAL END - ANCHORED END

<u>STATION</u>	<u>OFFSET</u>	QUANTITY (EA)
HIGH ST SB EVR		
21+29 TO 21+41	RT	1
21+27 TO 21+39	LT	1
21+43 TO 21+53	RT	1
21+44 TO 21+53	LT	1
22+02 TO 22+14	LT	1
22+02 TO 22+14	RT	1

#### <u> ITEM 606.353 - REFLECTORIZED FLEXIBLE GUARDRAI MARKER</u>

<u>STATION</u>	<u>OFFSET</u>	QUANTITY (L
HIGH ST NB EVR	DT	2
14+82 HIGH ST SB EVR	RT	2
22+14	LT	2
22+14	RT	2

#### ITEM 607.17 - CHAIN LINK FENCE - 6 FOOT

<u>STAT.</u>	<u>ION TO STATION</u>	<u>OFFSET</u>	QUANTITY (LF)
HIGH	ST NB EVR		
12+20	TO 12+80	RT	90
12+20	TO 12+83	LT	60
HIGH	ST SB EVR		
21+94	TO 22+14	RT	20
<i>22</i> +03	3 TO 22+14	LT	<i>30</i>

#### ITEM 609.31 - CURB TYPE 3

<u>LOCATION</u>	QUANTITY (LF)
HIGH ST SB EVR	
20+12 TO 20+22 LT	50

#### <u> ITEM 610.08 - PLAIN RIPRAP</u>

<u>STATION</u>	<u>OFFSET</u>	<u>QUANTITY (CY)</u>
HIGH ST NB EVR		
<i>12+50</i>	RT	<i>4.</i> 2
<i>14</i> +64	LT	1.0
<i>14</i> +64	RT	O <b>.</b> 8
HIGH ST SB EVR		
20+29	LT	0 <b>.</b> 5
<i>2I+34</i>	RT	<i>0.8</i>
21+40	LT	1 <b>.</b> 9
<i>21</i> +76	RT	1.0
22+07	LT	1.4

#### ITEM 610.181 - TEMPORARY STONE CHECK DAM

STATION	<u>OFFSET</u>	QUANTITY (C)
H!GH ST NB EVR 12+05 TO 14+60	RT	10.0
12+40 TO 14+60	LT	10.0

## ITEM 613.319 - EROSION CONTROL BLANKET

STATION TO STATION	<u>OFFSET</u>	QUANTITY (S
HIGH ST NB EVR		
12+05 TO 14+60	RT	<i>2</i> 76
12+40 TO 14+60	LT	<i>302</i>
HIGH ST SB EVR		
20+12 TO 21+25	RT	<i>397</i>
20+12 TO 21+25	LT	<i>162</i>

## <u>ITEM 620.58 - EROSION CONTROL GEOTEXTILE</u>

<u>S</u>	<u>TATION</u>	<u>OFFSET</u>	QUANTITY (SY)
$\overline{H}$	IGH ST NB EVR		
12	2+50	RT	10
/4	1+64	LT	7
14	1+64	RT	6
Н	IGH ST SB EVR		
2	0+29	LT	4
2	<i>l+34</i>	RT	5
2	<i>l+40</i>	LT	//
2	I <del>-</del> 76	RT	7
2	<i>2+0</i> 7	LT	5


## ITEM 656.632 - 30" TEMPORARY SILT FENCE

STATION TO STATION	<u>OFFSET</u>	QUANTITY (LF)
HIGH ST NB EVR		
0+13 TO 14+89	LT	656
0+18 TO 10+50	RT	<i>53</i>
2+81 TO 14+82	RT	<i>22</i> 5
HIGH ST SB EVR		
20+12 TO 23+02	RT	<i>526</i>
20+12 TO 23+02	LT	<i>328</i>

Scale:				Designed b	y:				
No.	Revision	Ву	Date	-			Vn	U	
				CONSULTANT	PROJEC	CT MANAGER:	E. Flynn		
					Ву	Date		Ву	Date
				Designed	BMD	6/21/23	Checked	ECF	6/21/23
				Drawn	AHS	6/21/23	In Charge of	AG	6/21/23

VANASSE HANGEN BRUSTLIN, INC.
500 Southborough Dr.
Suite 105B
South Portland, ME 04106

South Portland, ME 04106 TEL (207) 889-3150 FAX (207) 253-5596

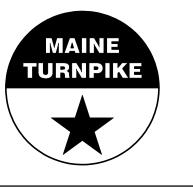

MTA PROJECT MANAGER: Ryan Barnes, PE

THE GOLD STAR MEMORIAL HIGHWAY HIGH STREET
EMERGENCY VEHICLE RAMPS
GENERAL AND CONSTRUCTION NOTES

VHB: 55639.00 SHEET NUMBER: 3
CONTRACT: 2023.04 3 OF 31

- I. These traffic control details apply to the construction of the High Street Emergency Vehicle Ramps (EVR) at the High Street Underpass at mile marker 103.6 in West Gardiner. The Contractor is directed to use a typical layout from this project's Maintenance of Traffic Details or from the Maine Turnpike Authority Traffic Control Plans located on the MTA website at
- www.maineturnpike.com/Projects/Construction-Related-Documents.aspx. See also the Special Provisions for more details on specific temporary traffic controls with time and date restrictions.
- 2. All traffic control equipment and devices shall conform to the 2014 edition of the Maine Department of Transportation (MaineDOT) Standard Specifications, Maine Turnpike Authority (MTA) Supplemental Specifications, contract specifications and applicable traffic control standards and practices.
- 3. Any signs, equipment, or devices found to be damaged or unserviceable shall be replaced at the Contractor's expense.
- 4. Temporary lane closures will be required, with advanced approval, whenever work will occur within four feet of the I-95 traveled way. Temporary lane closures shall be removed if no work is occurring. See Special Provisions for more information.
- 5. Lane closure requests shall be submitted by the Resident by Noon on the Thursday prior to the week of the proposed lane closures. The Contractor shall plan all lane closure requests accordingly.
- 6. If the Contractor's approved traffic control plan requires a northbound lane closure for the EVR construction, the Contractor shall provide a traffic control plan that includes a lane closure on the Turnpike northbound mainline and the I-295 (Exit 103) on-ramp in accordance with the details in the MTA Traffic Control Plan details, Appendix C.
- 7. In the event that lane closure(s) begin to cause back-ups in through traffic of more than five minutes, the Contractor shall deploy the additional signs as indicated in the single lane closure set-up details.
- 8. Approach ends of temporary concrete barrier shall be placed outside of the highway clear zone (minimum 34 feet from the traveled way along I-95) or protected by temporary impact attenuators or with guardrail overlaps as approved by the Resident.
- 9. Maximum spacing for channelizing devices (drums) shall be:
  - 80' on center along tangents
  - 40' on center along tapers
- 10. Work Zone Speed Limits shall only be permitted when temporary lane closures are in place.

## ABBREVIATIONS FOR ALL WORK ZONE PLANS

BWLL = BROKEN WHITE LANE LINE SWEL = SOLID WHITE EDGE LINE SYEL = SOLID YELLOW EDGE LINE

## MAINTENANCE OF TRAFFIC DETAILS

CONSTRUCTION SIGN SUMMARY						
	Sign	Text Dimensions (Inches)  Letter Vertical Height Spacing		Size	Quantity and Color	
CS-3	EXPECT STOPPED TRAFFIC	7" 7" 7"	4" 4"	48"×48"	4 - Black on Orange	
CS-10	TRUCKS	Text Dimensions Shall Conform to "Standard Highway		48" x 48"	I - Black on Orange	
G20-2	END ROAD WORK	Signs"	- 2012 	48"x24"	4 - Black on Orange	
G20-2	END ROAD WORK			36"x/8"	2 - Black on Orange	
G20-5aP	WORK ZONE			36"x24"	4 - Black on Orange	
R2-I(60)	SPEED LIMIT 60			48"x60"	4 - Black on White	
R2-6aP	FINES DOUBLE			36"x24"	4 - Black on White	
R2-I2	END WORK ZONE SPEED LIMIT			36"x54"	4 - Black on White	
W3-4	BE PREPARED TO STOP			48" x 48"	4 - Black on Orange	
W3-5(60)	SPEED LIMIT 60			48"×48"	4 - Black on Orange	
W4-2R				48"×48"	4 - Black on Orange	
W7-3aP	NEXT X FEET or NEXT X MILES	,		36" x 30"	I - Black on Orange	

## MAINTENANCE OF TRAFFIC DETAILS

	CONSTRUCTION SIGN SUMMARY					
			Text Dimensions (Inches)			
5			Vertical Spacing	Size	Quantity and Color	
W8-/	BUMP	Text Dimensions Shall Conform to "Standard Highway		48" x 48"	4 - Black on Orange	
W8-24a	RUMBLE STRIP AHEAD	Signs"	- 2012	48" x 48"	4 - Black on Orange	
W20-1	ROAD WORK 1 MILE			48" x 48"	4 - Black on Orange	
W20-I (AHE AD)	ROAD WORK AHEAD			48" x 48"	2 - Black on Orange	
W20-I (AHE AD)	ROAD WORK AHEAD			36"x36"	2 - Black on Orange	
W20-4	ONE LANE ROAD AHEAD			36"x36"	2 - Black on Orange	
W20-5R	RIGHT LANE CLOSED 1/2 MILE			48" x 48"	4 - Black on Orange	
W20-7				36" x 36"	2 - Black on Orange	
W2I-5	SHOULDER			48" x 48"	I - Black on Orange	
W2I-5aR	RIGHT SHOULDER CLOSED 1000 FT			48" x 48"	2 - Black on Orange	
W2I-5bR	RIGHT SHOULDER CLOSED	•		48" x 48"	2 - Black on Orange	

VANASSE HANGEN BRUSTLIN, INC.

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South Portland, ME 04106
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FAX (207) 253-5596





# THE GOLD STAR MEMORIAL HIGHWAY


HIGH STREET
EMERGENCY VEHICLE RAMPS

MAINTENANCE OF TRAFFIC DETAILS (1 OF 2)

VHB: 55639.00 SHEET NUMBER: 4
CONTRACT: 2023.04 4 OF **31** 

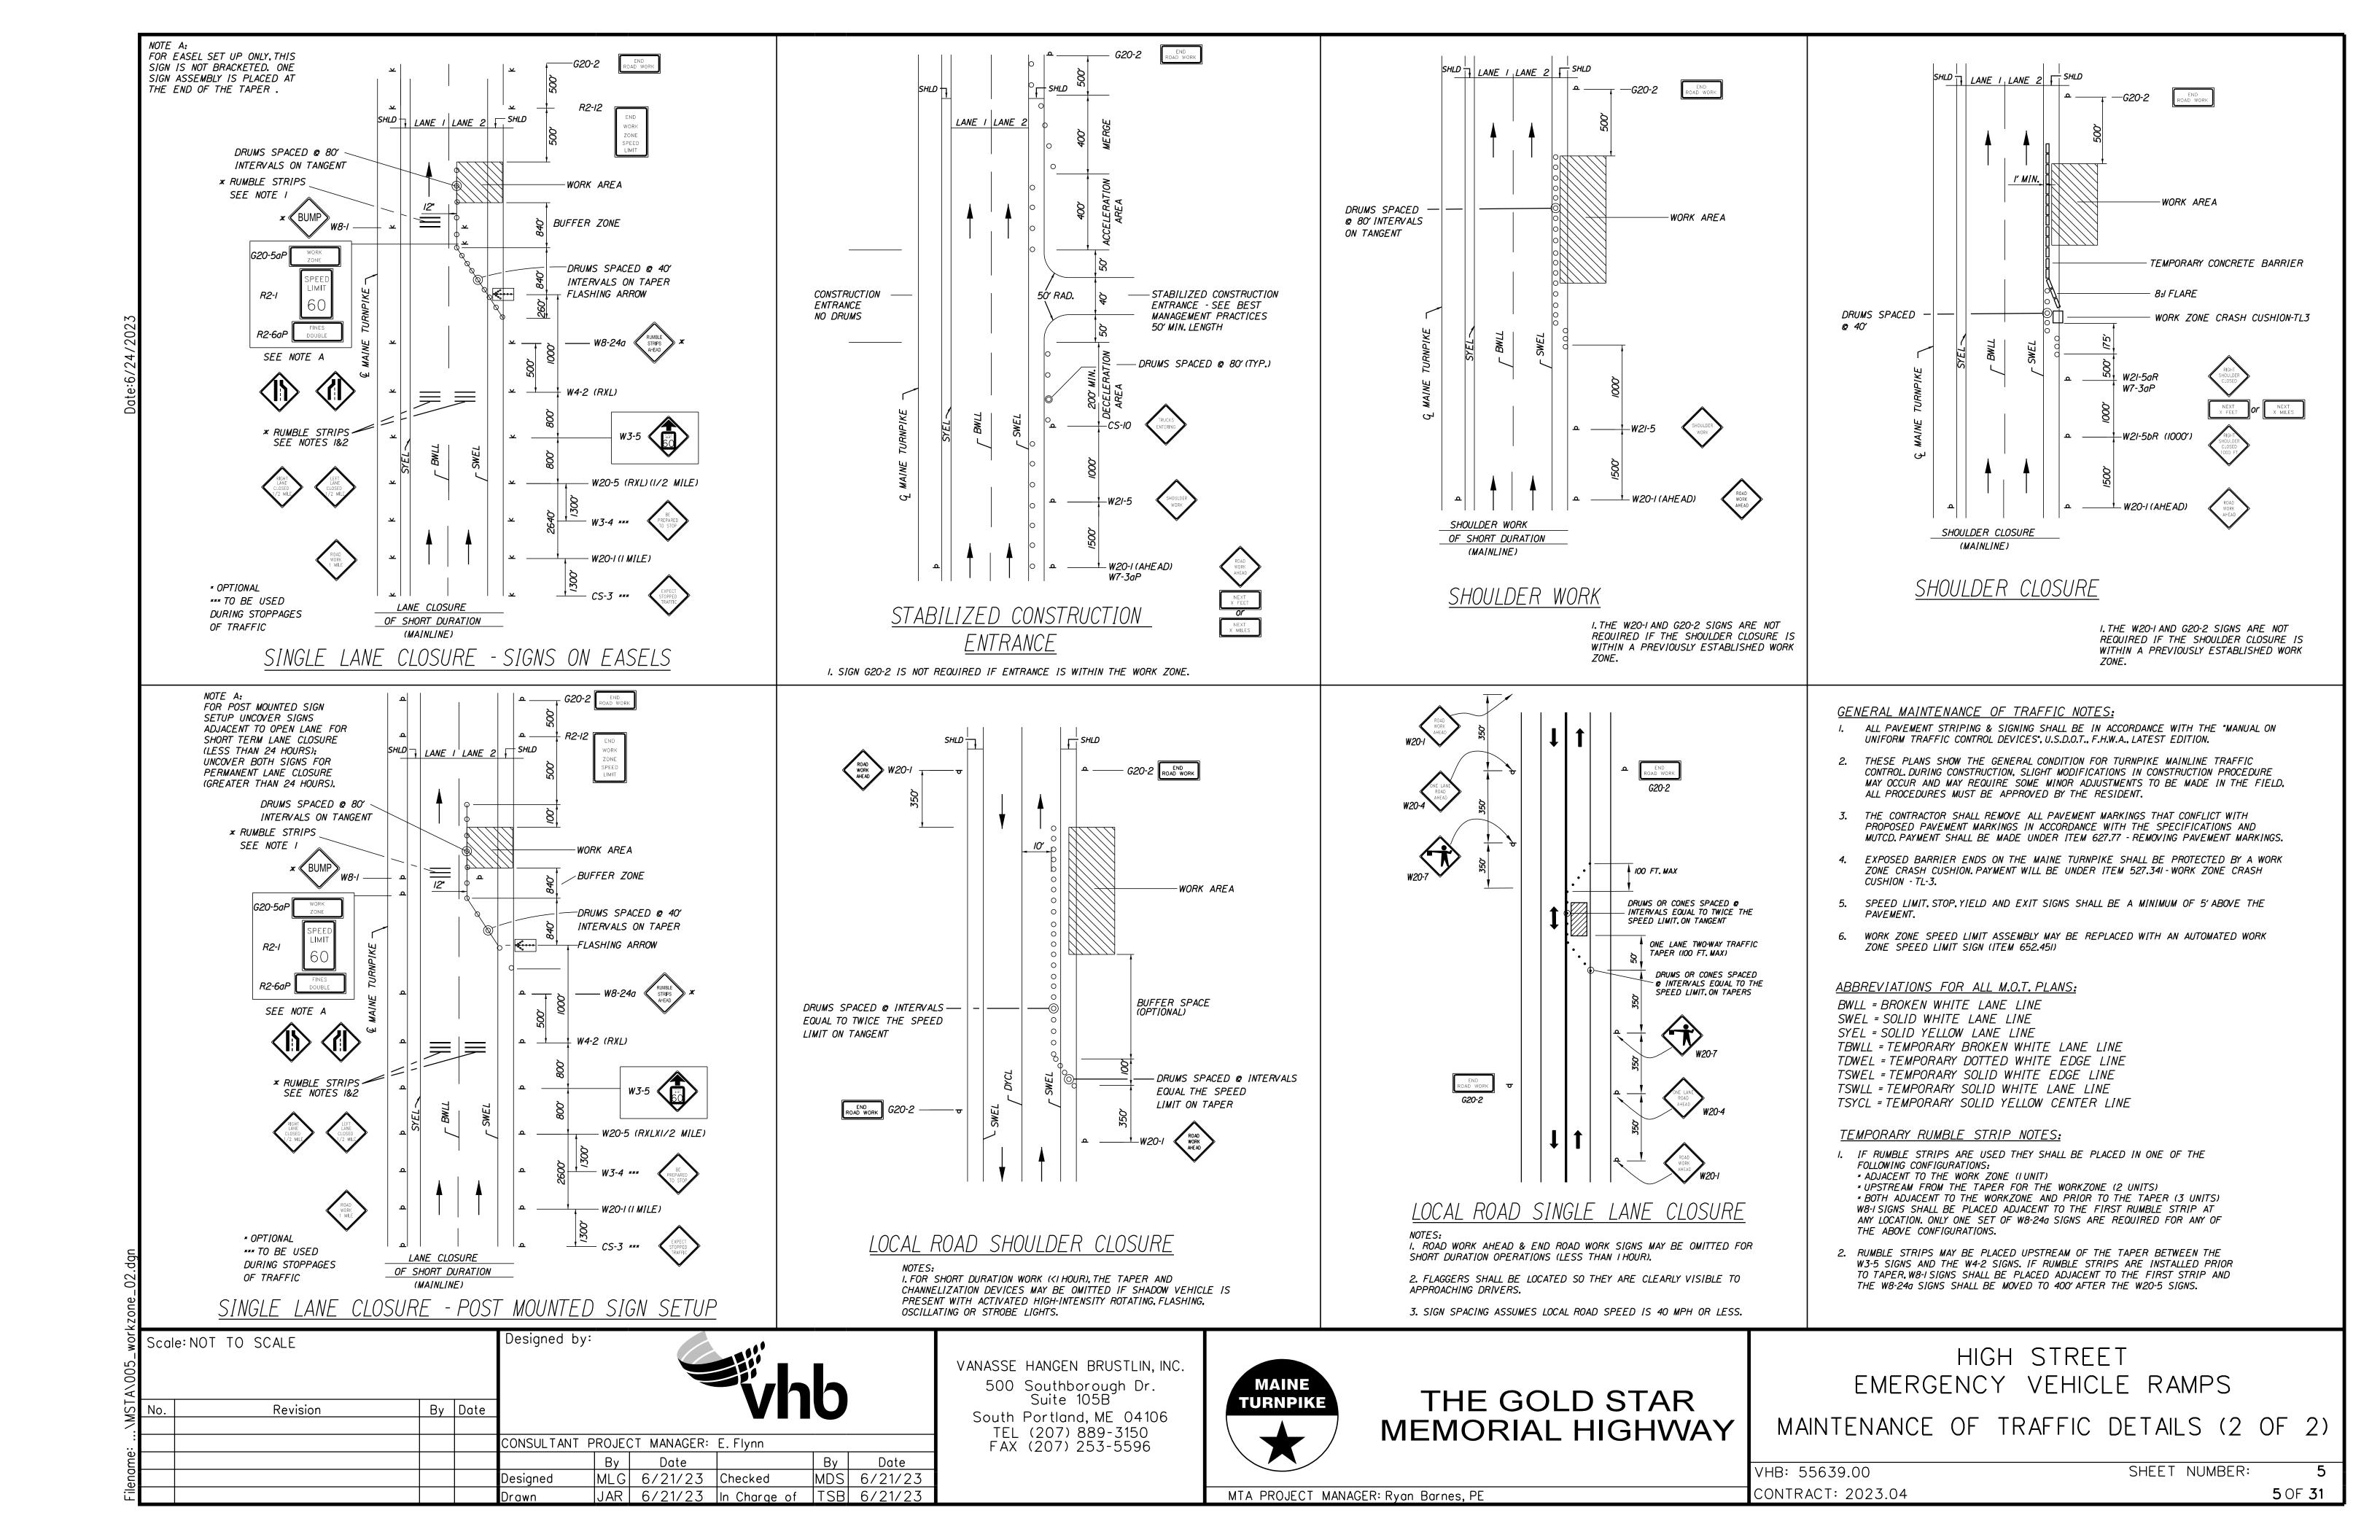

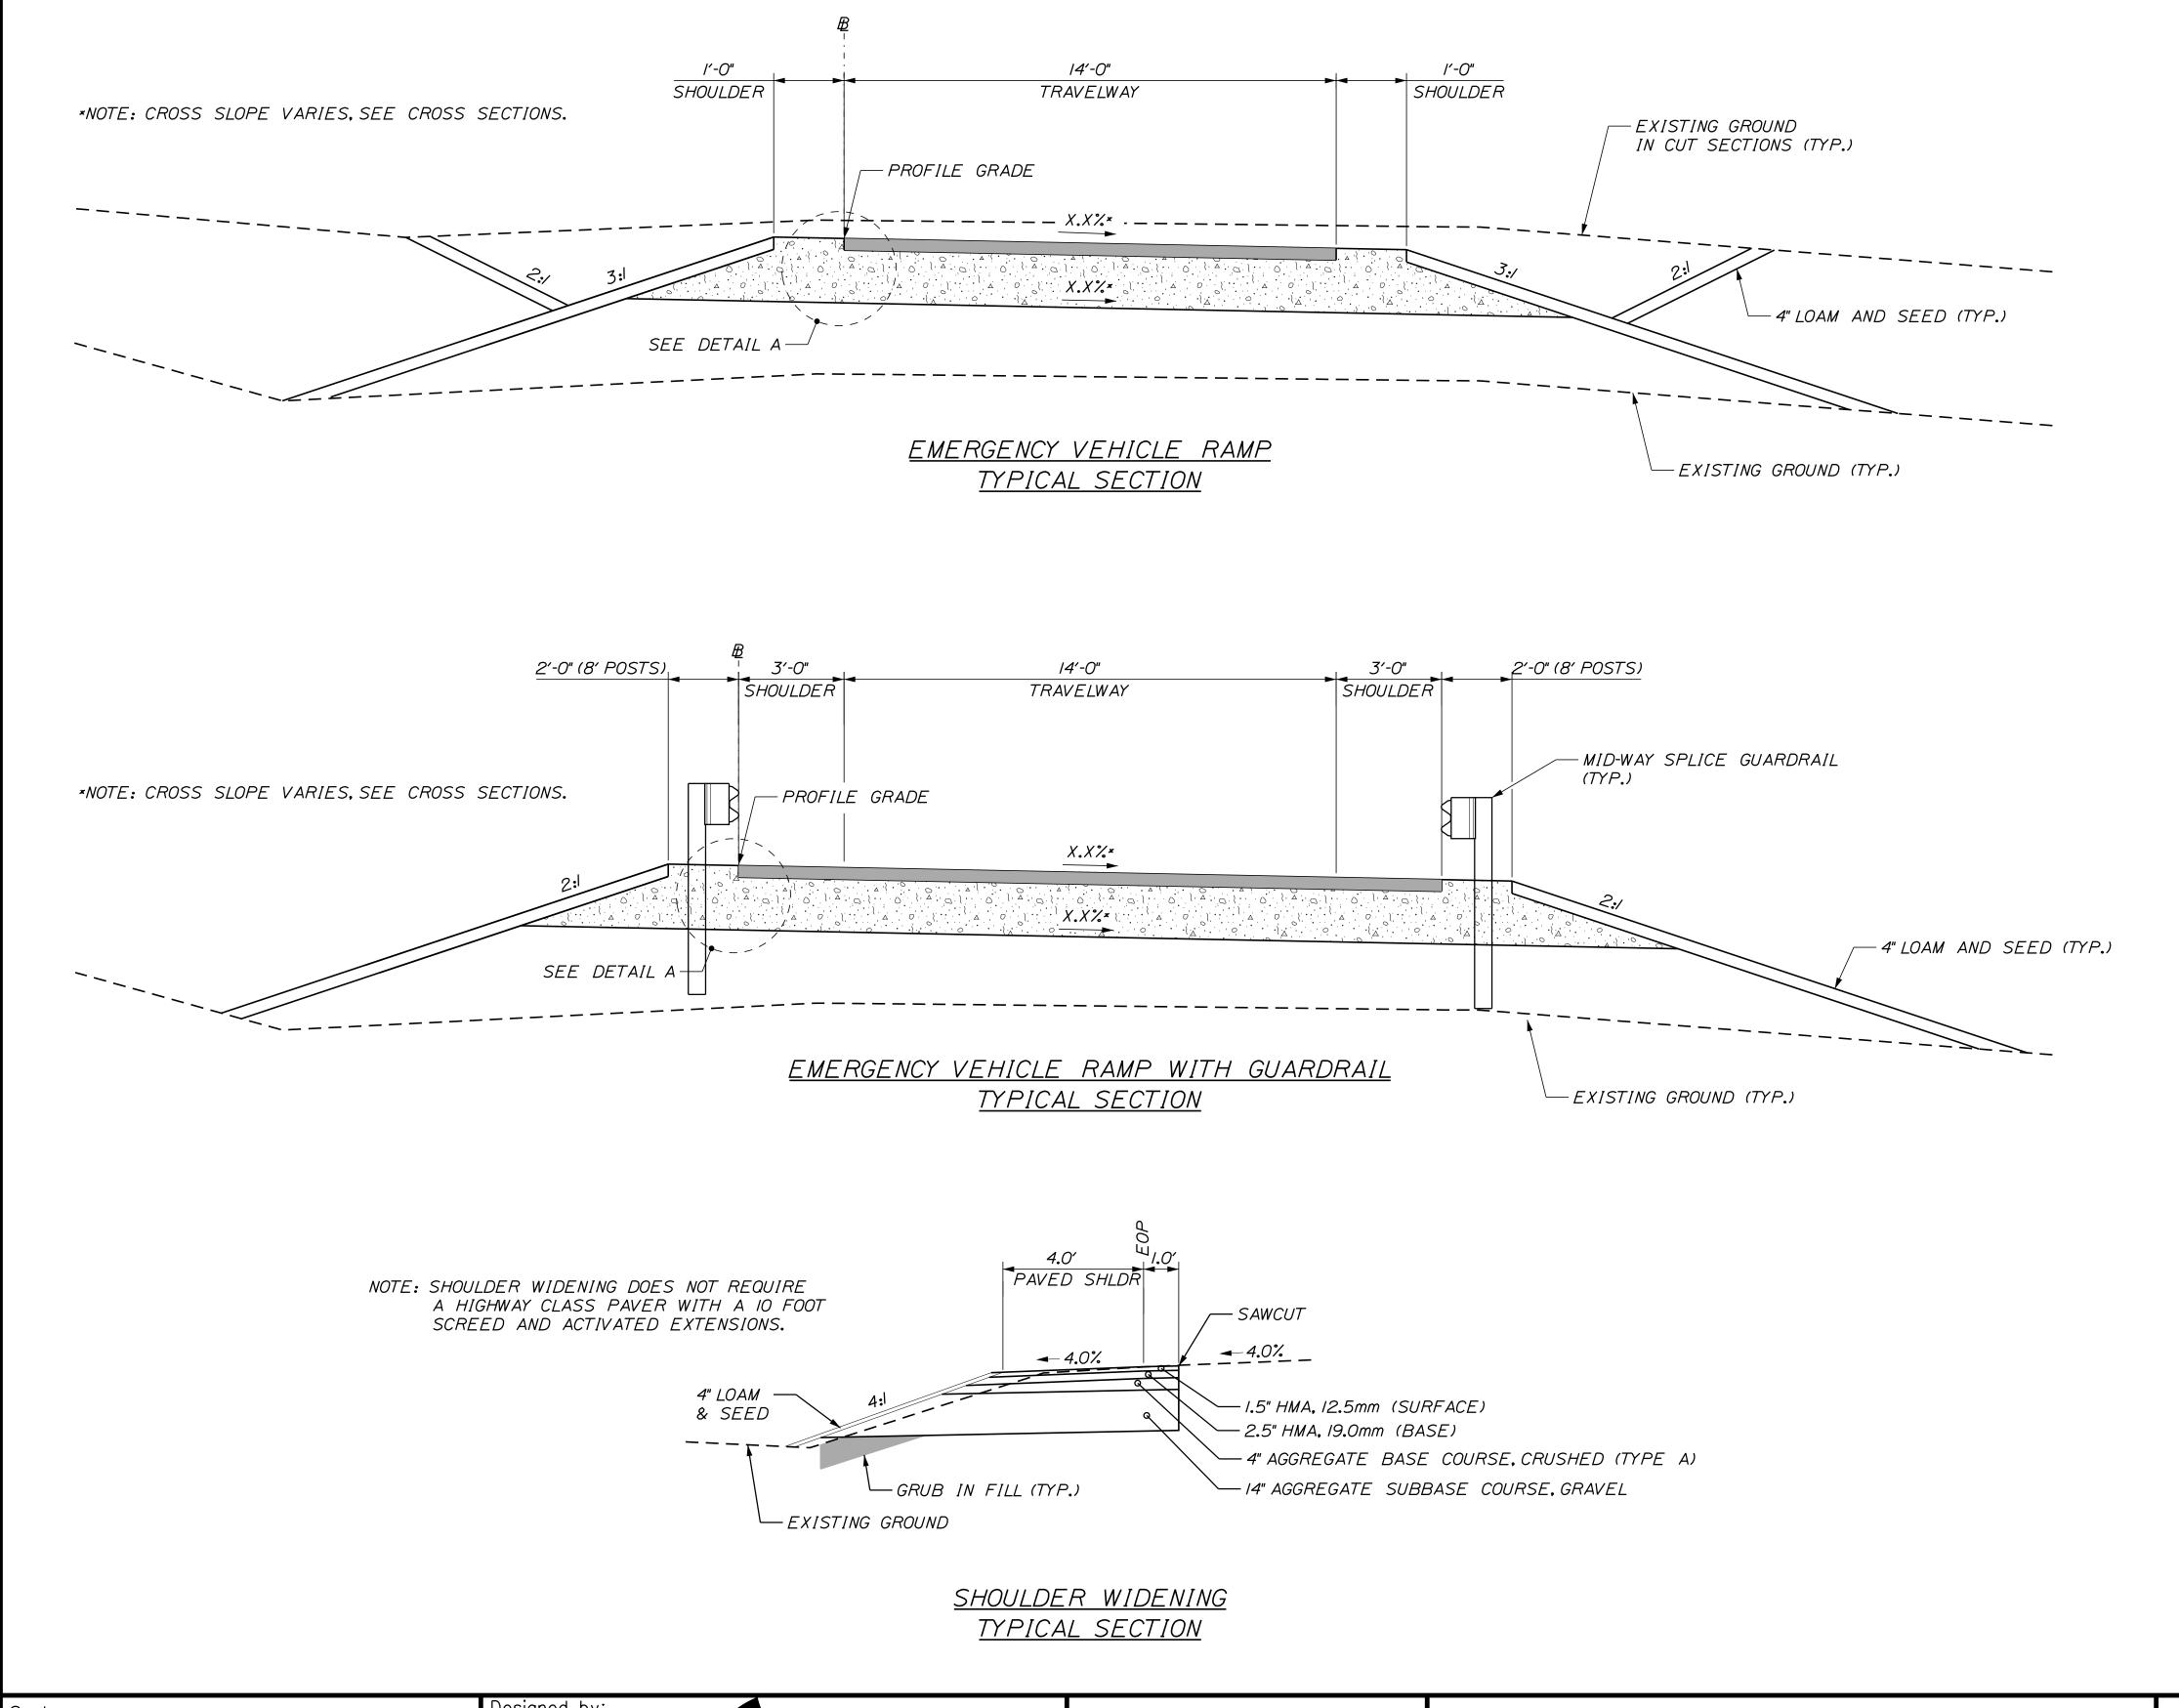

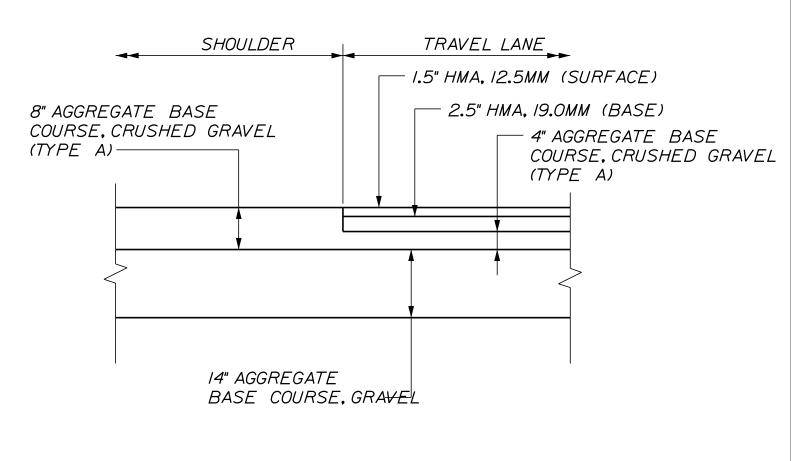

# TYPICAL ACCESS ROAD SECTION NOTES

I. THE PAVEMENT, BASE, AND SUBBASE DEPTHS AS SHOWN ON PLANS ARE INTENDED TO BE NOMINAL.

DETAIL A NOT TO SCALE

- 2. ALL NECESSARY PAVEMENT CUTTING SHALL BE SAWCUT AND DONE IN SUCH A MANNER AS TO LEAVE A CLEAN VERTICAL FACE. PAYMENT SHALL BE UNDER ITEM 419.3 - SAWING BITUMINOUS PAVEMENT.
- 3. BITUMINOUS TACK COAT IS REQUIRED BETWEEN ALL LIFTS OF PAVEMENT, OR AS DIRECTED BY THE RESIDENT.

Designed by: NOT TO SCALE By Date Revision CONSULTANT PROJECT MANAGER: E.Flynn By Date ECF 6/21/23 BMD 6/21/23 Checked Designed AHS 6/21/23 In Charge of AG 6/21/23

VANASSE HANGEN BRUSTLIN, INC. 500 Southborough Dr. Suite 105B South Portland, ME 04106

TEL (207) 889-3150 FAX (207) 253-5596



THE GOLD STAR MEMORIAL HIGHWAY

HIGH STREET EMERGENCY VEHICLE RAMPS TYPICAL ROADWAY SECTIONS

SHEET NUMBER: VHB: 55639.00 CONTRACT: 2023.04

MTA PROJECT MANAGER: Ryan Barnes, PE

6 OF 31

## DIMENSIONS FOR SLOPE OF 2:1

D	A (FT)	B (FT)	C (FT)	E (FT)	F (FT)	G (FT)	STONE DEPTH (FT)	STONE (CY)
12"	1.00	4.00	3.00	2.00	6.00	1.00	0.50	0.43
<i>15</i> "	1.00	<i>4.</i> 50	<b>3.3</b> 7	2.25	6.75	1.63	0.50	0.57
18"	1.00	5.00	<i>3.</i> 75	2.50	7.50	2.25	0.50	0.70
24"	1.00	6.00	<b>4.</b> 50	3.00	9.00	<i>3.50</i>	0.50	1.04
30"	1.00	7.00	5.25	3.50	10.50	<b>4.</b> 75	0.50	1.44

## DIMENSIONS FOR SLOPE OF 4:1


D	A (FT)	B (FT)	C (FT)	E (FT)	F (FT)	G (FT)	STONE DEPTH (FT)	
12"	1.00	8.00	6.00	2.00	6.00	0.00	0.50	0.73
15"	1.00	9.00	<b>6.</b> 75	2.25	<b>6.</b> 75	0.00	0.50	0.93
18"	1.00	10.00	7.50	2.50	7.50	0.00	0.50	1.13
24"	1.00	12.00	9.00	3.00	9.00	0.00	0.50	1.62
30"	1.00	14.00	10.50	<i>3.50</i>	10.50	0.00	0.50	2.19

## DIMENSIONS FOR SLOPE OF 6:1


D	A (FT)	B (FT)	C (FT)	E (FT)	F (FT)	G (FT)	STONE DEPTH (FT)	STONE (CY)
12"	0.50	9.00	7.50	1.50	4.50	0.00	0.50	0.77
15"	0.50	10.50	<b>8.</b> 75	1.75	5.50	0.00	0.50	0.98
18"	0.50	12.00	10.00	2.00	6.50	0.00	0.50	1.19
24"	0.50	15.00	12.50	2.50	8.00	0.00	0.50	1.81
30"	0.50	18.00	15.00	3.00	9.50	0.00	0.50	<b>2.</b> 57


## NOTES:

- I. THE DIMENSIONS SHOWN ARE APPROXIMATE AND MAY BE MODIFIED BY THE RESIDENT.
- 2. STONE QUANTITIES ARE FOR ONE END OF THE PIPE.

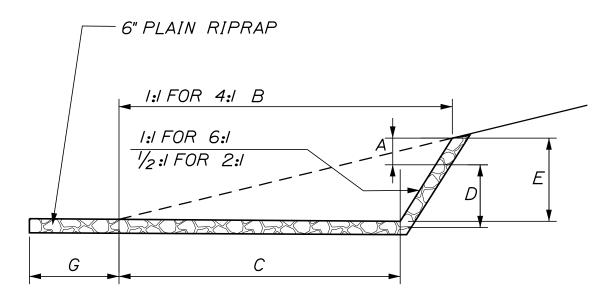


## <u>SECTION B-B</u>

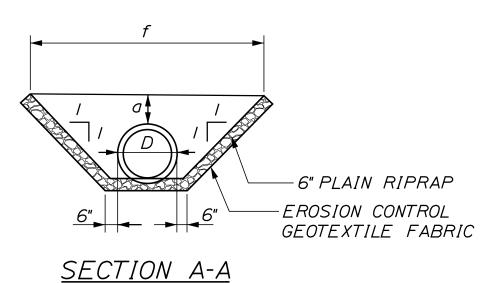

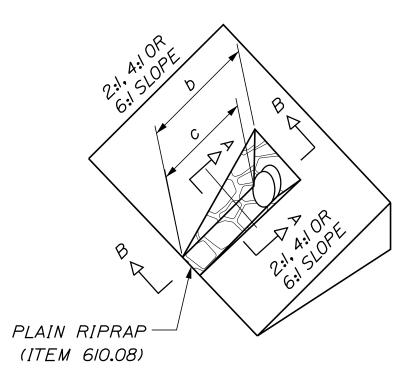

ROADWAY CULVERT END SLOPE TREATMENT
NOT TO SCALE


		SIG	SN SUM	MARY			
	Cina		mensions hes)	6:	Overatity and Calar		
	Sign	Letter Height	Vertical Spacing	- Size	Quantity and Color		
RI-I	STOP	Shall C	mensions Conform andard way	36"x36"	4 - WHITE ON RED		
R5-II	AUTHORIZED VEHICLES ONLY	Signs"	- 2012	30"x24"	6 - BLACK ON WHITE		
R6-IR	ONE WAY			36"x12"	2 - BLACK ON WHITE		

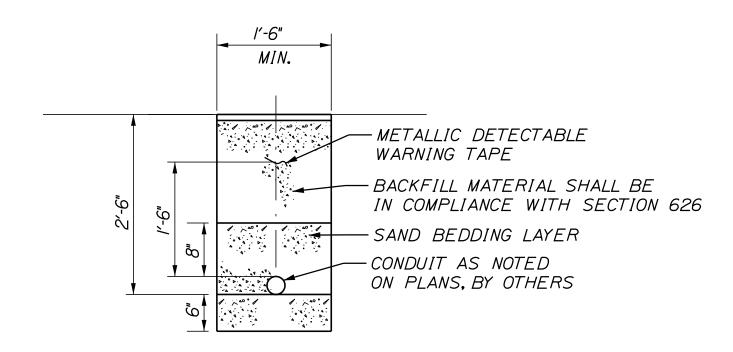

TRENCH CROSS SECTION
NOT TO SCALE

Scale:				Designed b	y:			h	
No.	Revision	Ву	Date	1			VII	U	
				CONSULTANT	PROJEC	CT MANAGER:	E. Flynn		
					Ву	Date		Ву	Date
				Designed	BMD	6/21/23	Checked	ECF	6/21/23
				Drawn	AHS	6/21/23	In Charge of	AG	6/21/23

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TEL (207) 889-3150
FAX (207) 253-5596

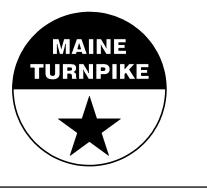


THE GOLD STAR
MEMORIAL HIGHWAY

HIGH STREET
EMERGENCY VEHICLE RAMPS
DETAILS (1 OF 2)

VHB: 55639.00 SHEET NUMBER: 7


MTA PROJECT MANAGER: Ryan Barnes, PE

7 OF 31

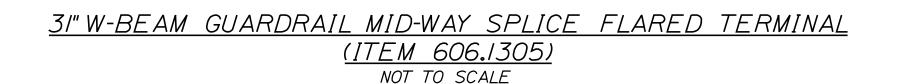


## GENERAL GUARDRAIL INSTALLATION NOTES:


- I. THE CONTRACTOR SHALL FOLLOW ALL MANUFACTURER'S INSTALLATION INSTRUCTIONS FOR THE INSTALLATION OF ALL GUARDRAIL COMPONENTS TO BE INSTALLED. THE CONTRACTOR SHALL NOTIFY THE RESIDENT ENGINEER OF ANY CONFLICTS OR IRREGULARITIES BETWEEN THE MANUFACTURER'S INSTALLATION INSTRUCTIONS AND THE CONTRACT DOCUMENTS.
- 2. THE CONTRACTOR IS REQUIRED TO HAVE AN APPROVED CRASH END TREATMENT ON ALL GUARDRAIL ENDS PRIOR TO THE REMOVAL OF ANY MOT FEATURES.
- 3. GUARDRAIL MID-WAY SPLICE HEIGHT SHALL BE 31". GUARDRAIL HEIGHT SHALL BE MEASURED FROM GROUND ELEVATION ADJACENT TO EACH POST.
- 4. THE CONTRACTOR SHALL REMOVE AND DISPOSE OF ALL CUT BOLTS, DISCARD PARTS, TRASH, PAVEMENT DEBRIS, ETC., AFTER COMPLETING THE GUARDRAIL INSTALLATION.
- 5. CONNECTION FOR PROPOSED RAIL TO EXISTING RAIL SHALL BE INCIDENTAL TO THE PROPOSED GUARDRAIL ITEMS.
- 6. TERMINAL UNIT SHALL BE MFLEAT AND MASH CERTIFIED AS MANUFACTURED BY ROAD SYSTEMS INC.

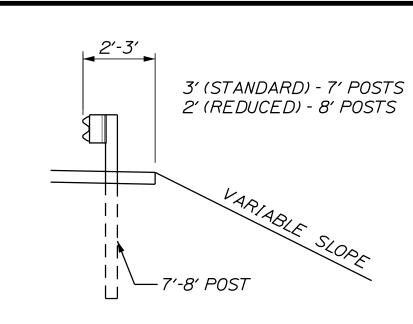

## CROSS SECTION

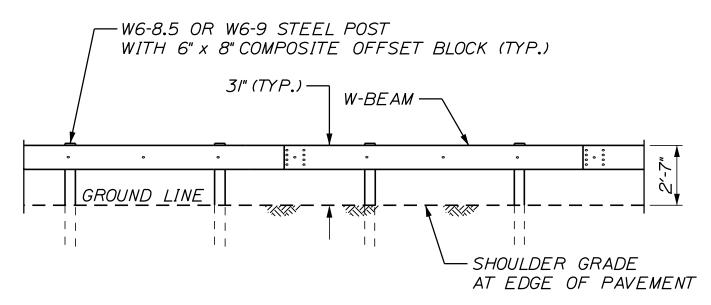

## **ELEVATION**

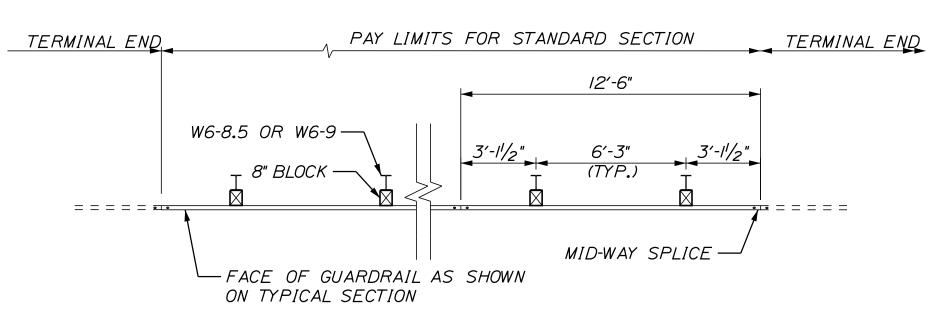

## <u>PLAN - SINGLE FACED</u>

31" W-BEAM GUARDRAIL - MID-WAY SPLICE (8' STEEL POST, 8" OFFSET BLOCKS, SINGLE FACED) (ITEM 606.1301)

NOT TO SCALE

PAY LIMIT PAY LIMIT TERMINAL PAY LIMIT TERMINAL END - ANCHORED END MIDWAY SPLICE FLEXIBLE NOTE: THIS DETAIL MODIFIES THE SEW31 DELINEATOR POST\_\_\_ DRAWING SUCH THAT W-BEAM DOES NOT EXTEND BEYOND THE LAST 6′-3" GUARDRAIL POST. THE RWM140 W-BEAM PANEL SHALL HAVE A LENGTH OF 9'-41/2" MEASURED FROM THE CENTER OF THE MIDWAY SPLICE TO THE CENTER OF THE LAST GUARDRAIL POST. -STEEL TUBE FOUNDATION

TERMINAL END - ANCHORED END - 31" W-BEAM GUARDRAIL (ITEM 606.1351) NOT TO SCALE

Designed by: Scale: NOT TO SCALE By Date Revision CONSULTANT PROJECT MANAGER: E. Flynn By Date Date BMD 6/21/23 | Checked ECF 6/21/23 Designed AHS 6/21/23 In Charge of AG 6/21/23

VANASSE HANGEN BRUSTLIN, INC. 500 Southborough Dr. Suite 105B South Portland, ME 04106 TEL (207) 889-3150


FAX (207) 253-5596




THE GOLD STAR MEMORIAL HIGHWAY

HIGH STREET EMERGENCY VEHICLE RAMPS DETAILS (2 OF 2)

SHEET NUMBER: VHB: 55639.00 CONTRACT: 2023.04 8 OF 31

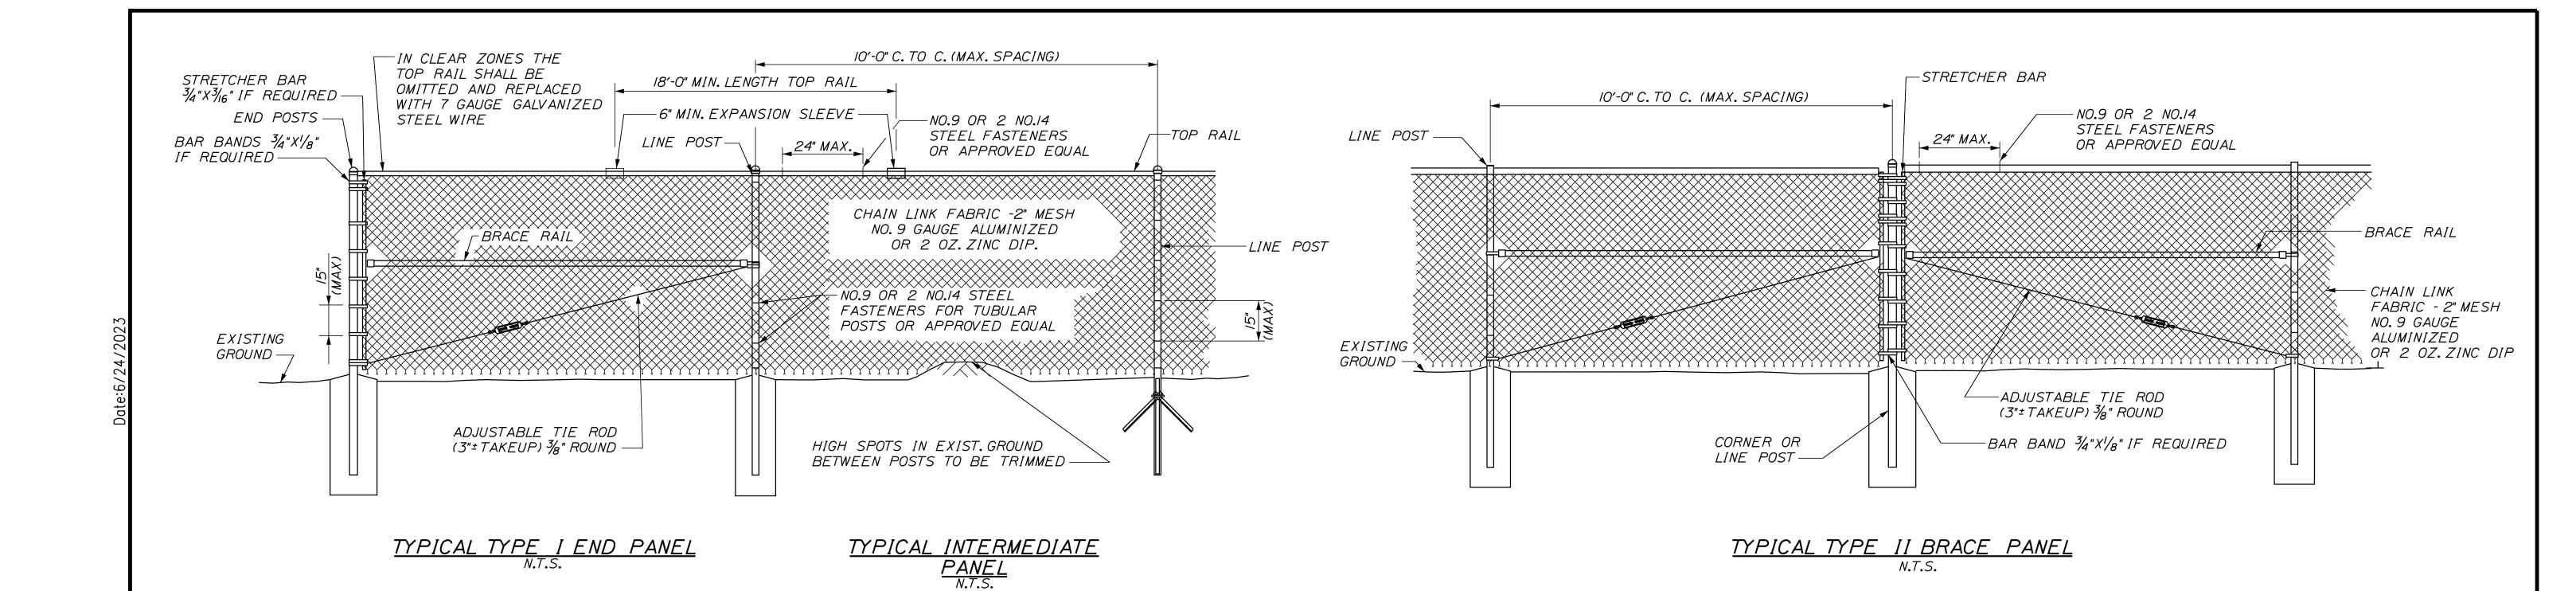

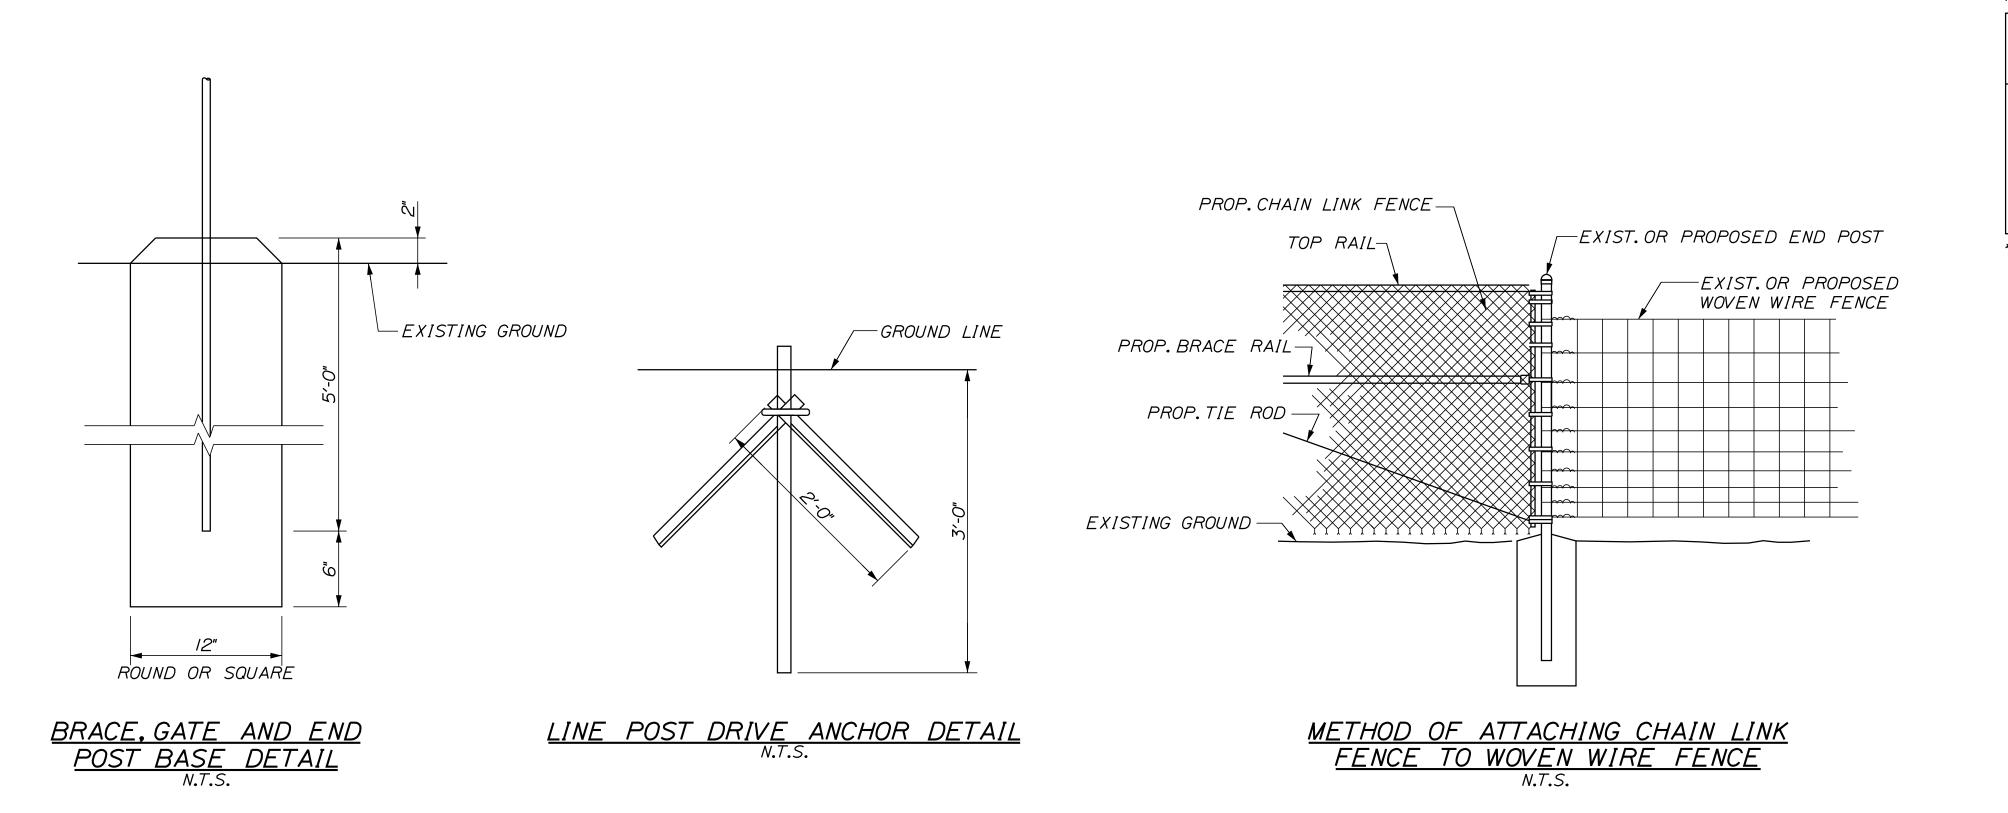

BENDING MOMENTS BASED ON GRADE I

ISCHEDULE 40 STEEL	L)		
CHAIN LINK FENCE	SHAPE	NOMINAL SIZE (INCHES)	BENDING MOMENT* (LBSIN.)
END & CORNER POSTS	φ	2 I.D.	14,025
LINE POSTS	$\phi$	I-1/2 I.D.	8,150
TOP & BRACE RAILS	φ	I-1/4 I.D.	5,875

\* MATERIAL FOR GRADE 2 END, CORNER & LINE POSTS AND TOP & BRACE RAILS MUST MEET OR EXCEED BENDING MOMENTS FOR GRADE I STEEL AS NOTED ABOVE.

## <u>NOTES</u>

- I. BRACE PANELS SHALL BE INSTALLED WHERE THE CHANGE IN GRADE BETWEEN ANY THREE POSTS EXCEEDS 15 PERCENT.
- 2. NO ADDITIONAL PAYMENT WILL BE MADE FOR LONGER POSTS NECESSITATED BY LARGE GRADE DIFFERENTIAL.
- 3. TYPE I BRACING WILL BE USED AT FENCE ENDS. TYPE II BRACING WILL BE USED AT CORNER POSTS.
- 4. WHEN LEDGE IS ENCOUNTERED, STEEL POSTS SHALL BE SET AND GROUTED 12" DEEP UNLESS THE POSTS PENETRATE THE GROUND TO THE DEPTH INDICATED ON THE DRAWINGS.
- 5. CONCRETE FOR POST FOUNDATION SHALL BE CLASS B.
- 6. BRACE, GATE AND END POSTS SHALL BE SET IN CONCRETE.
- 7. CHAIN LINK FENCE SHALL BE INSTALLED WITH BARBS DOWN.
- 8. ALL COMPONENTS OF CHAIN LINK FENCE SHALL BE IN ACCORDANCE WITH AASHTO MI81.

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No.	Revision	Ву	Date	1			VII	U	
				CONSULTANT	PROJEC	T MANAGER:	E. Flynn		
					Ву	Date		Ву	Date
				Designed	BMD	6/21/23	Checked	EĆF	6/21/2
				Drawn	AHS	6/21/23	In Charge of	AG	6/21/2

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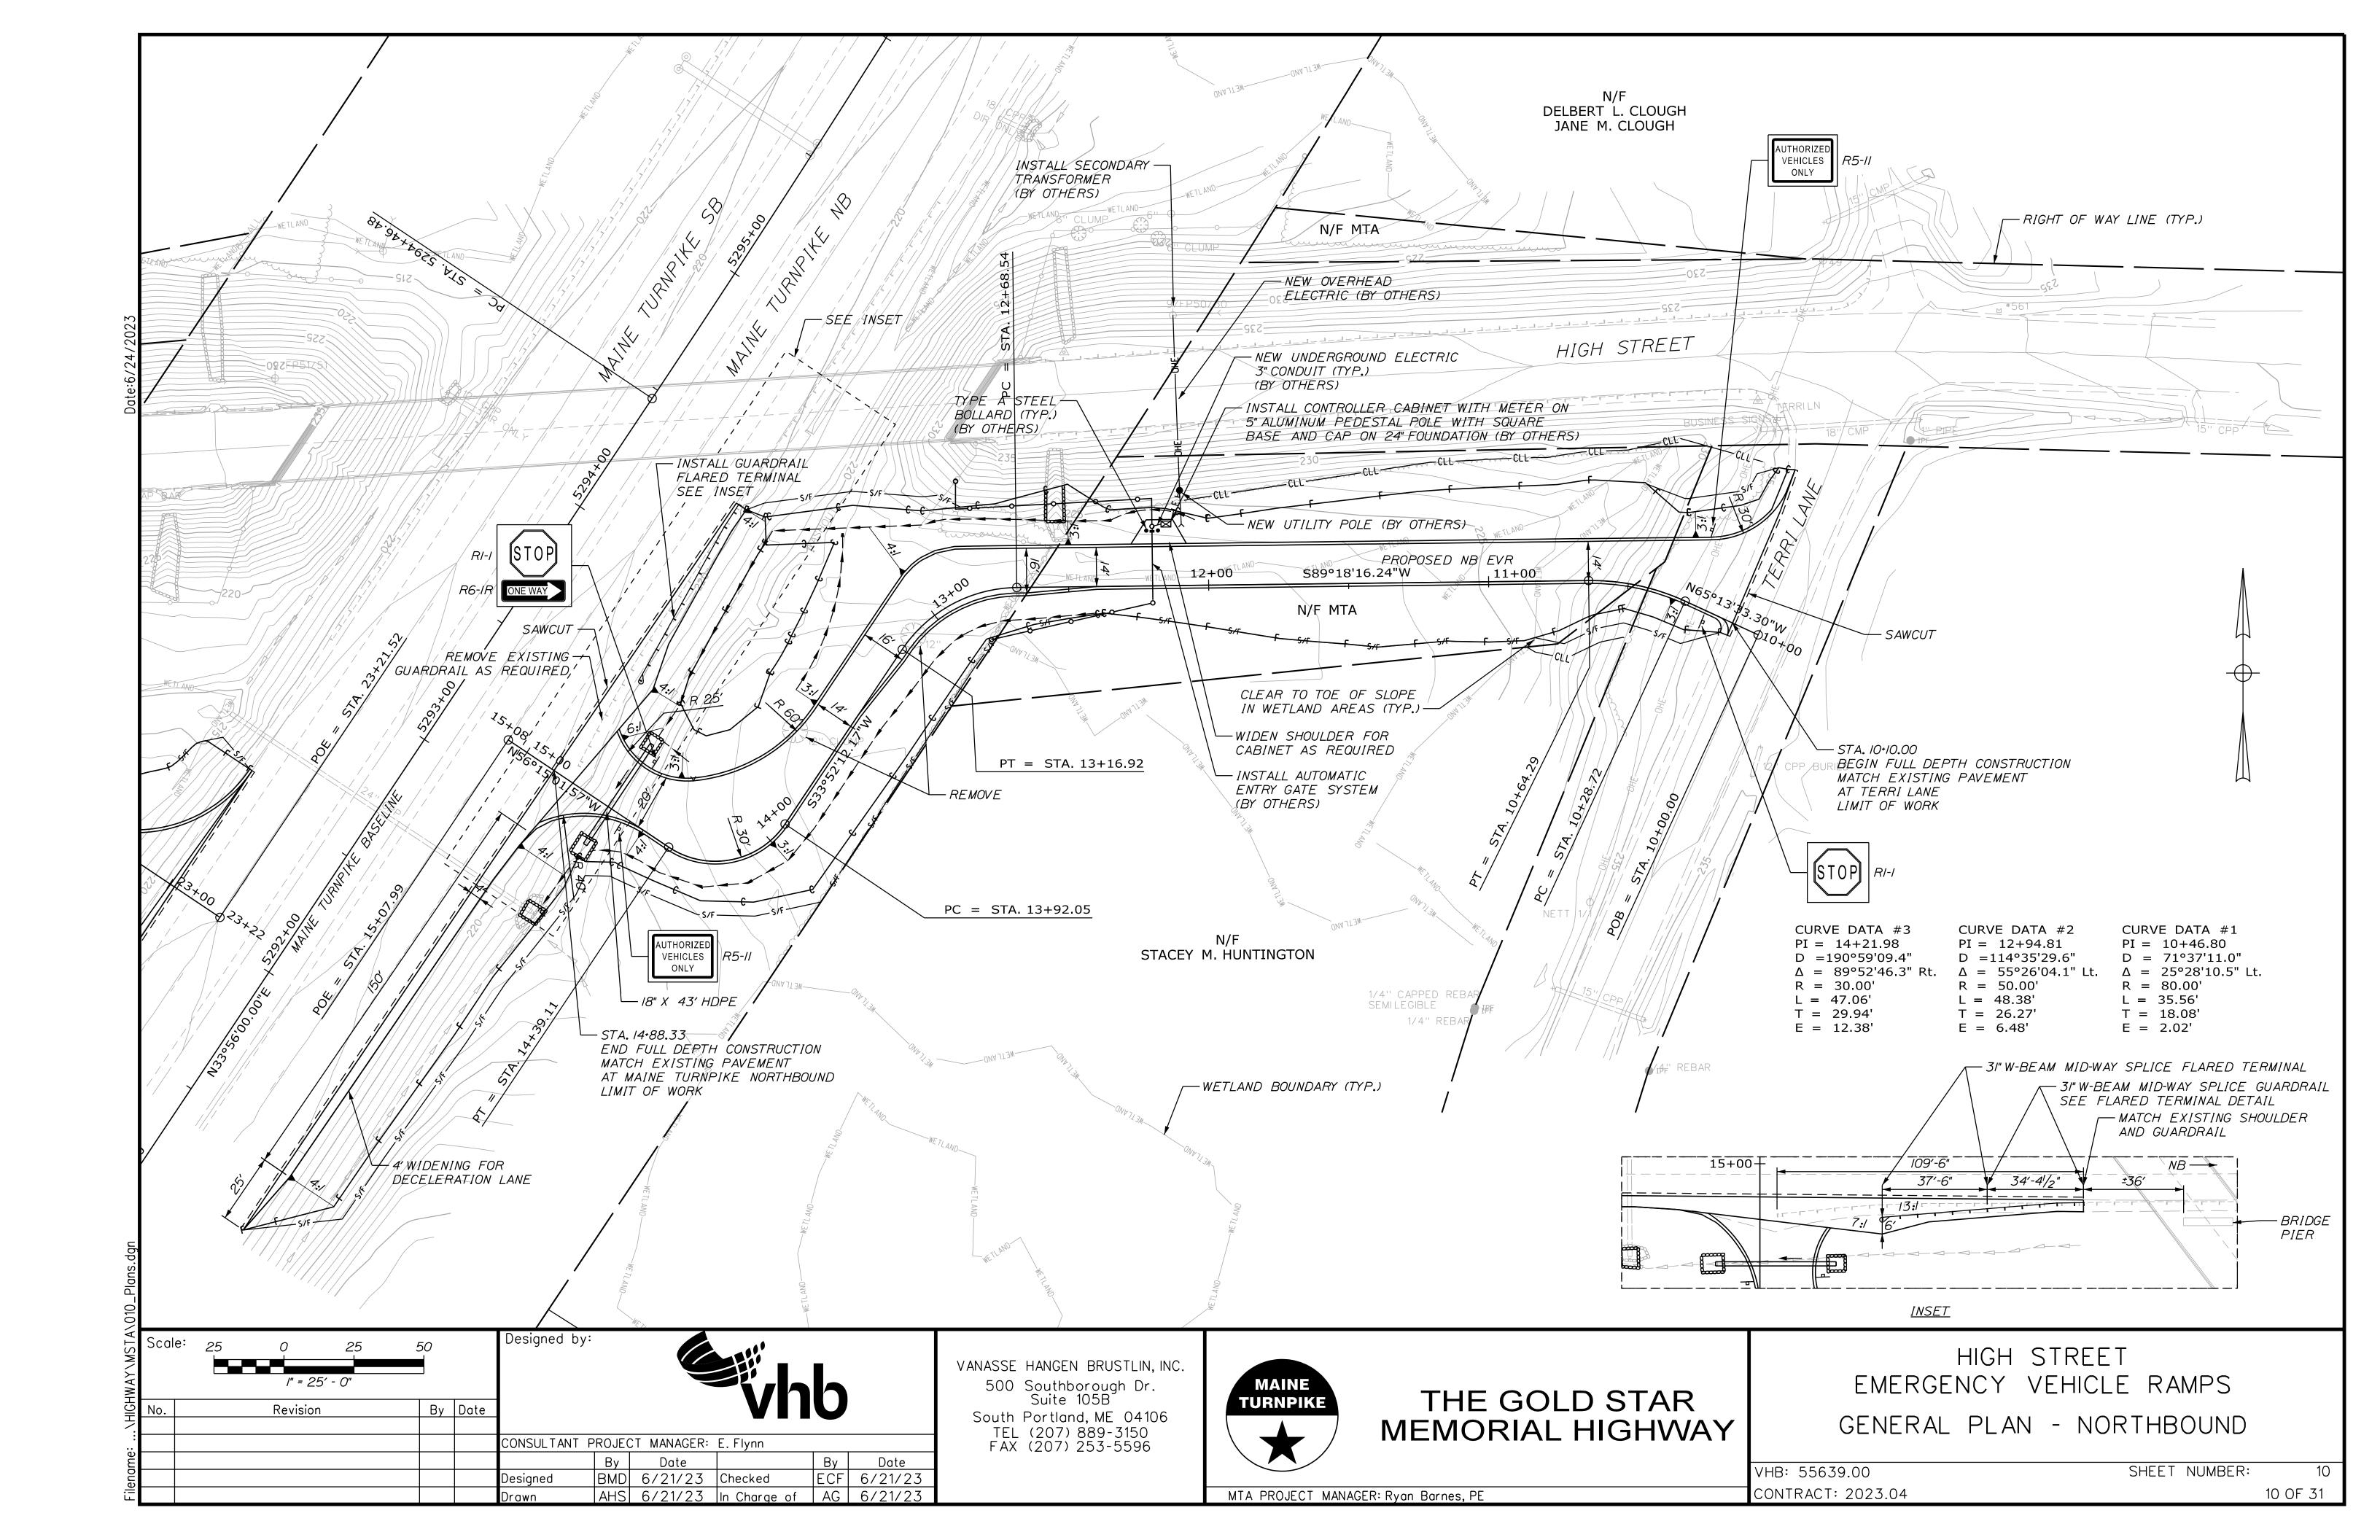
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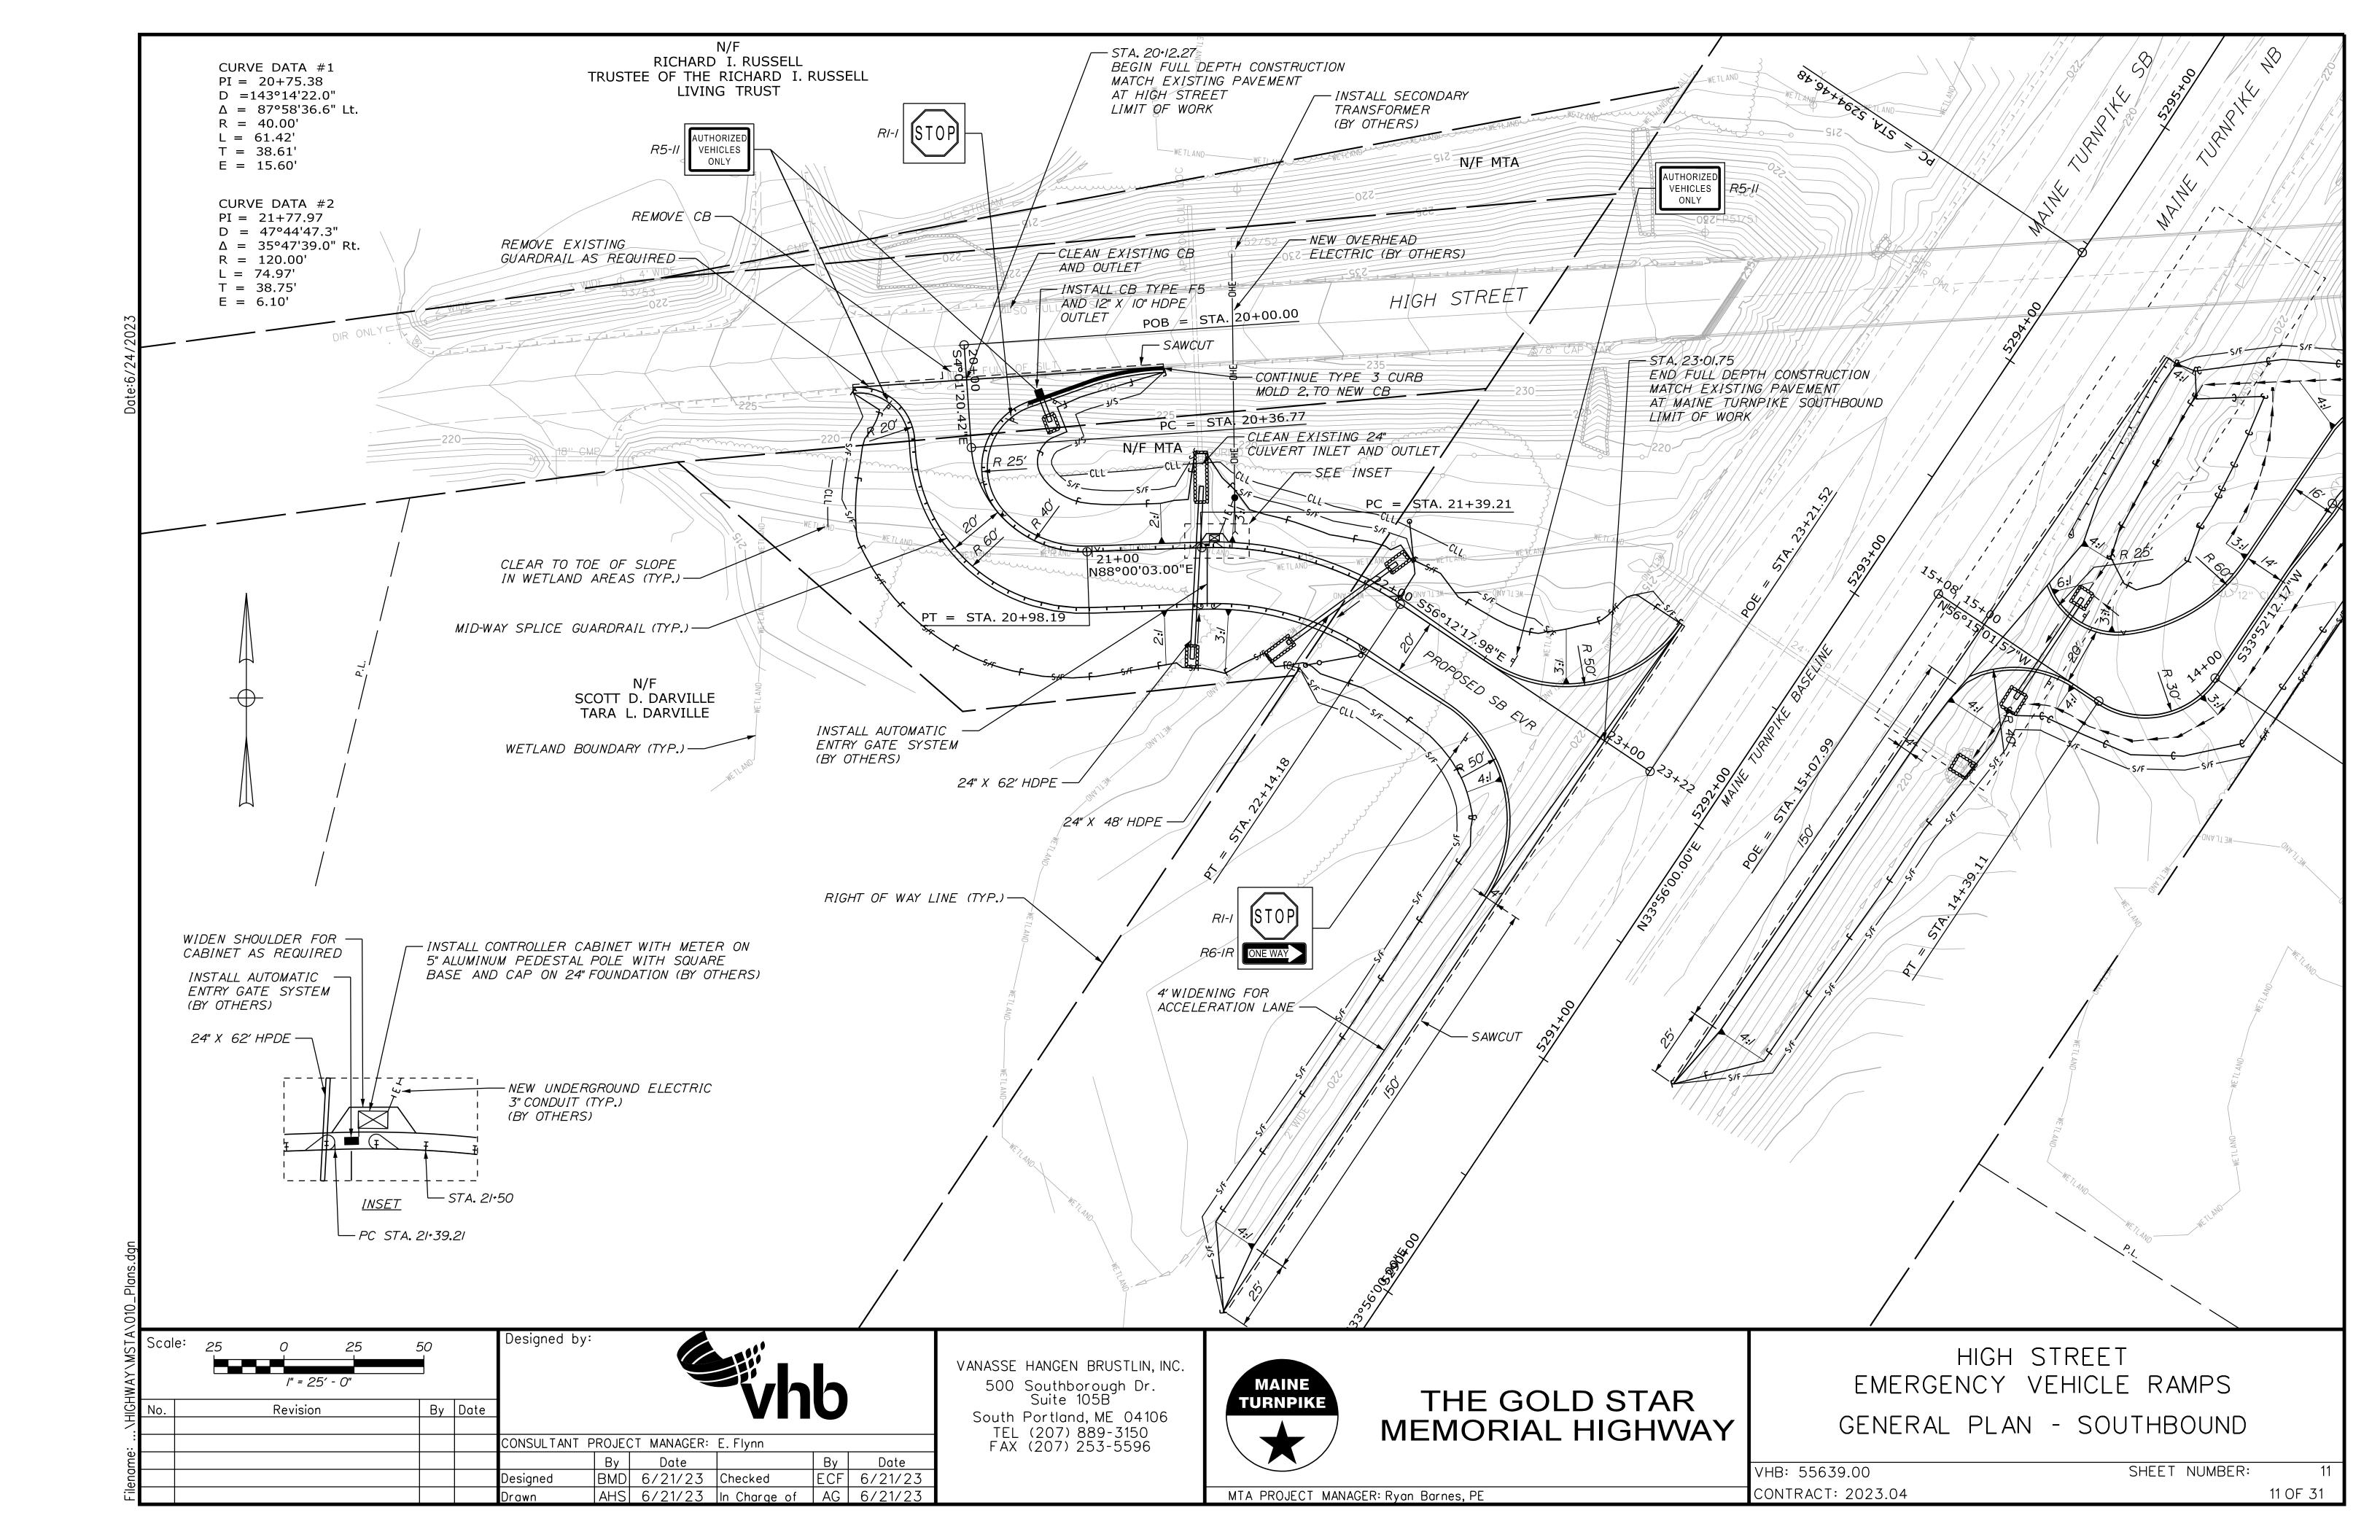



THE GOLD STAR
MEMORIAL HIGHWAY

HIGH STREET
EMERGENCY VEHICLE RAMPS
FENCING DETAILS

VHB: 55639.00 SHEET NUMBER: 9
CONTRACT: 2023.04 9 OF 31






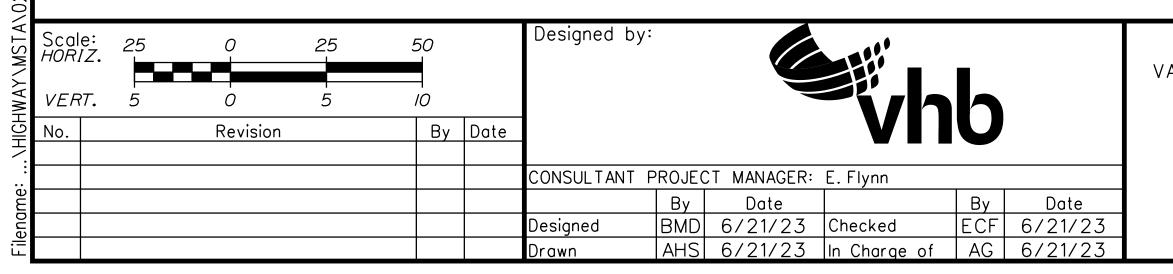

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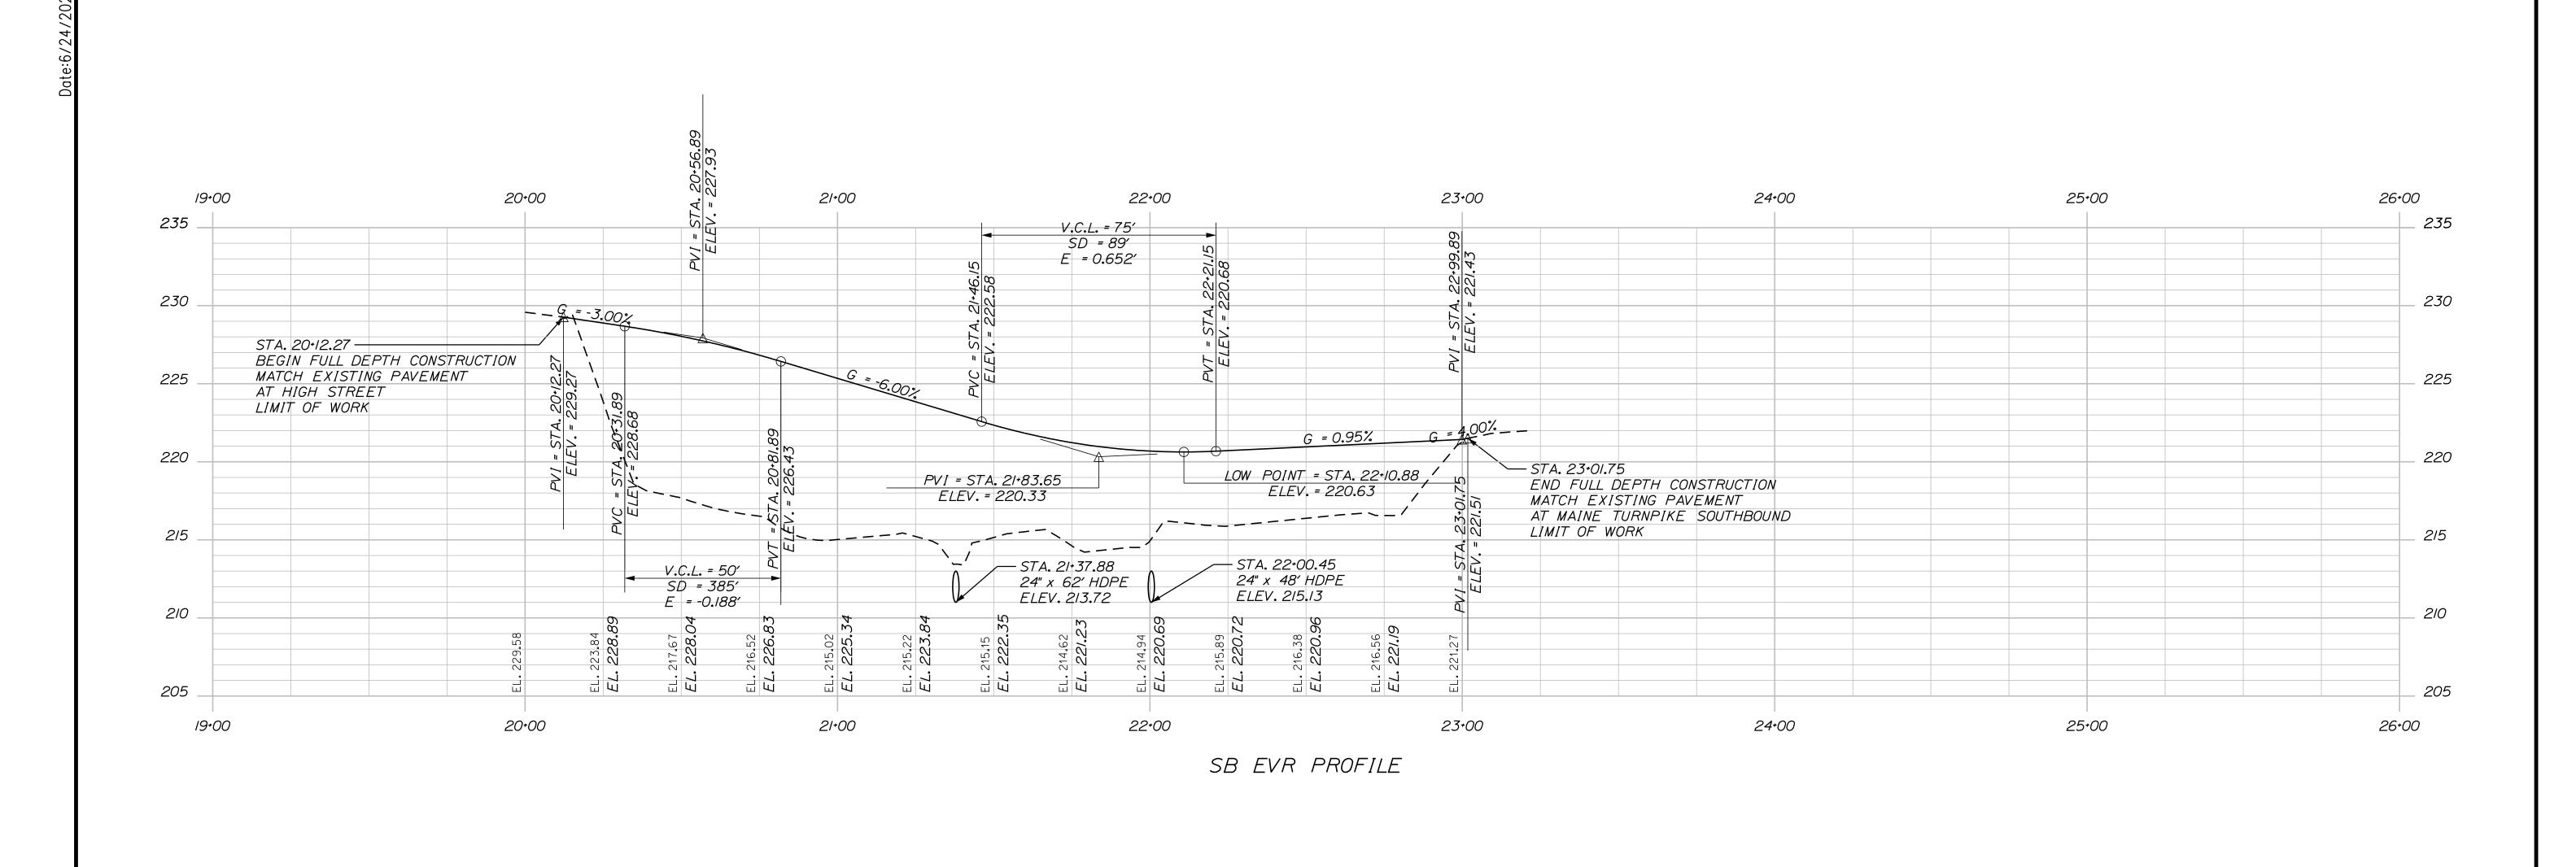
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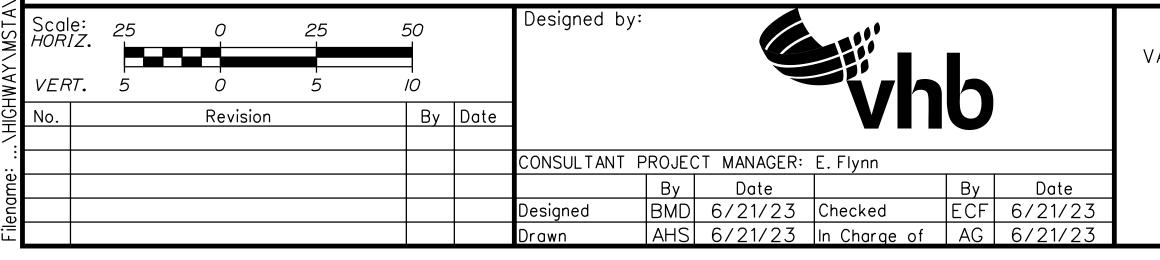


THE GOLD STAR
MEMORIAL HIGHWAY

HIGH STREET
EMERGENCY VEHICLE RAMPS
PROFILE - NORTHBOUND

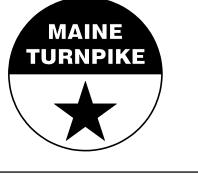VHB: 55639.00 SHEET NUMBER: 12 CONTRACT: 2023.04 12 OF 31





VANASSE HANGEN BRUSTLIN, INC.

500 Southborough Dr.
Suite 105B


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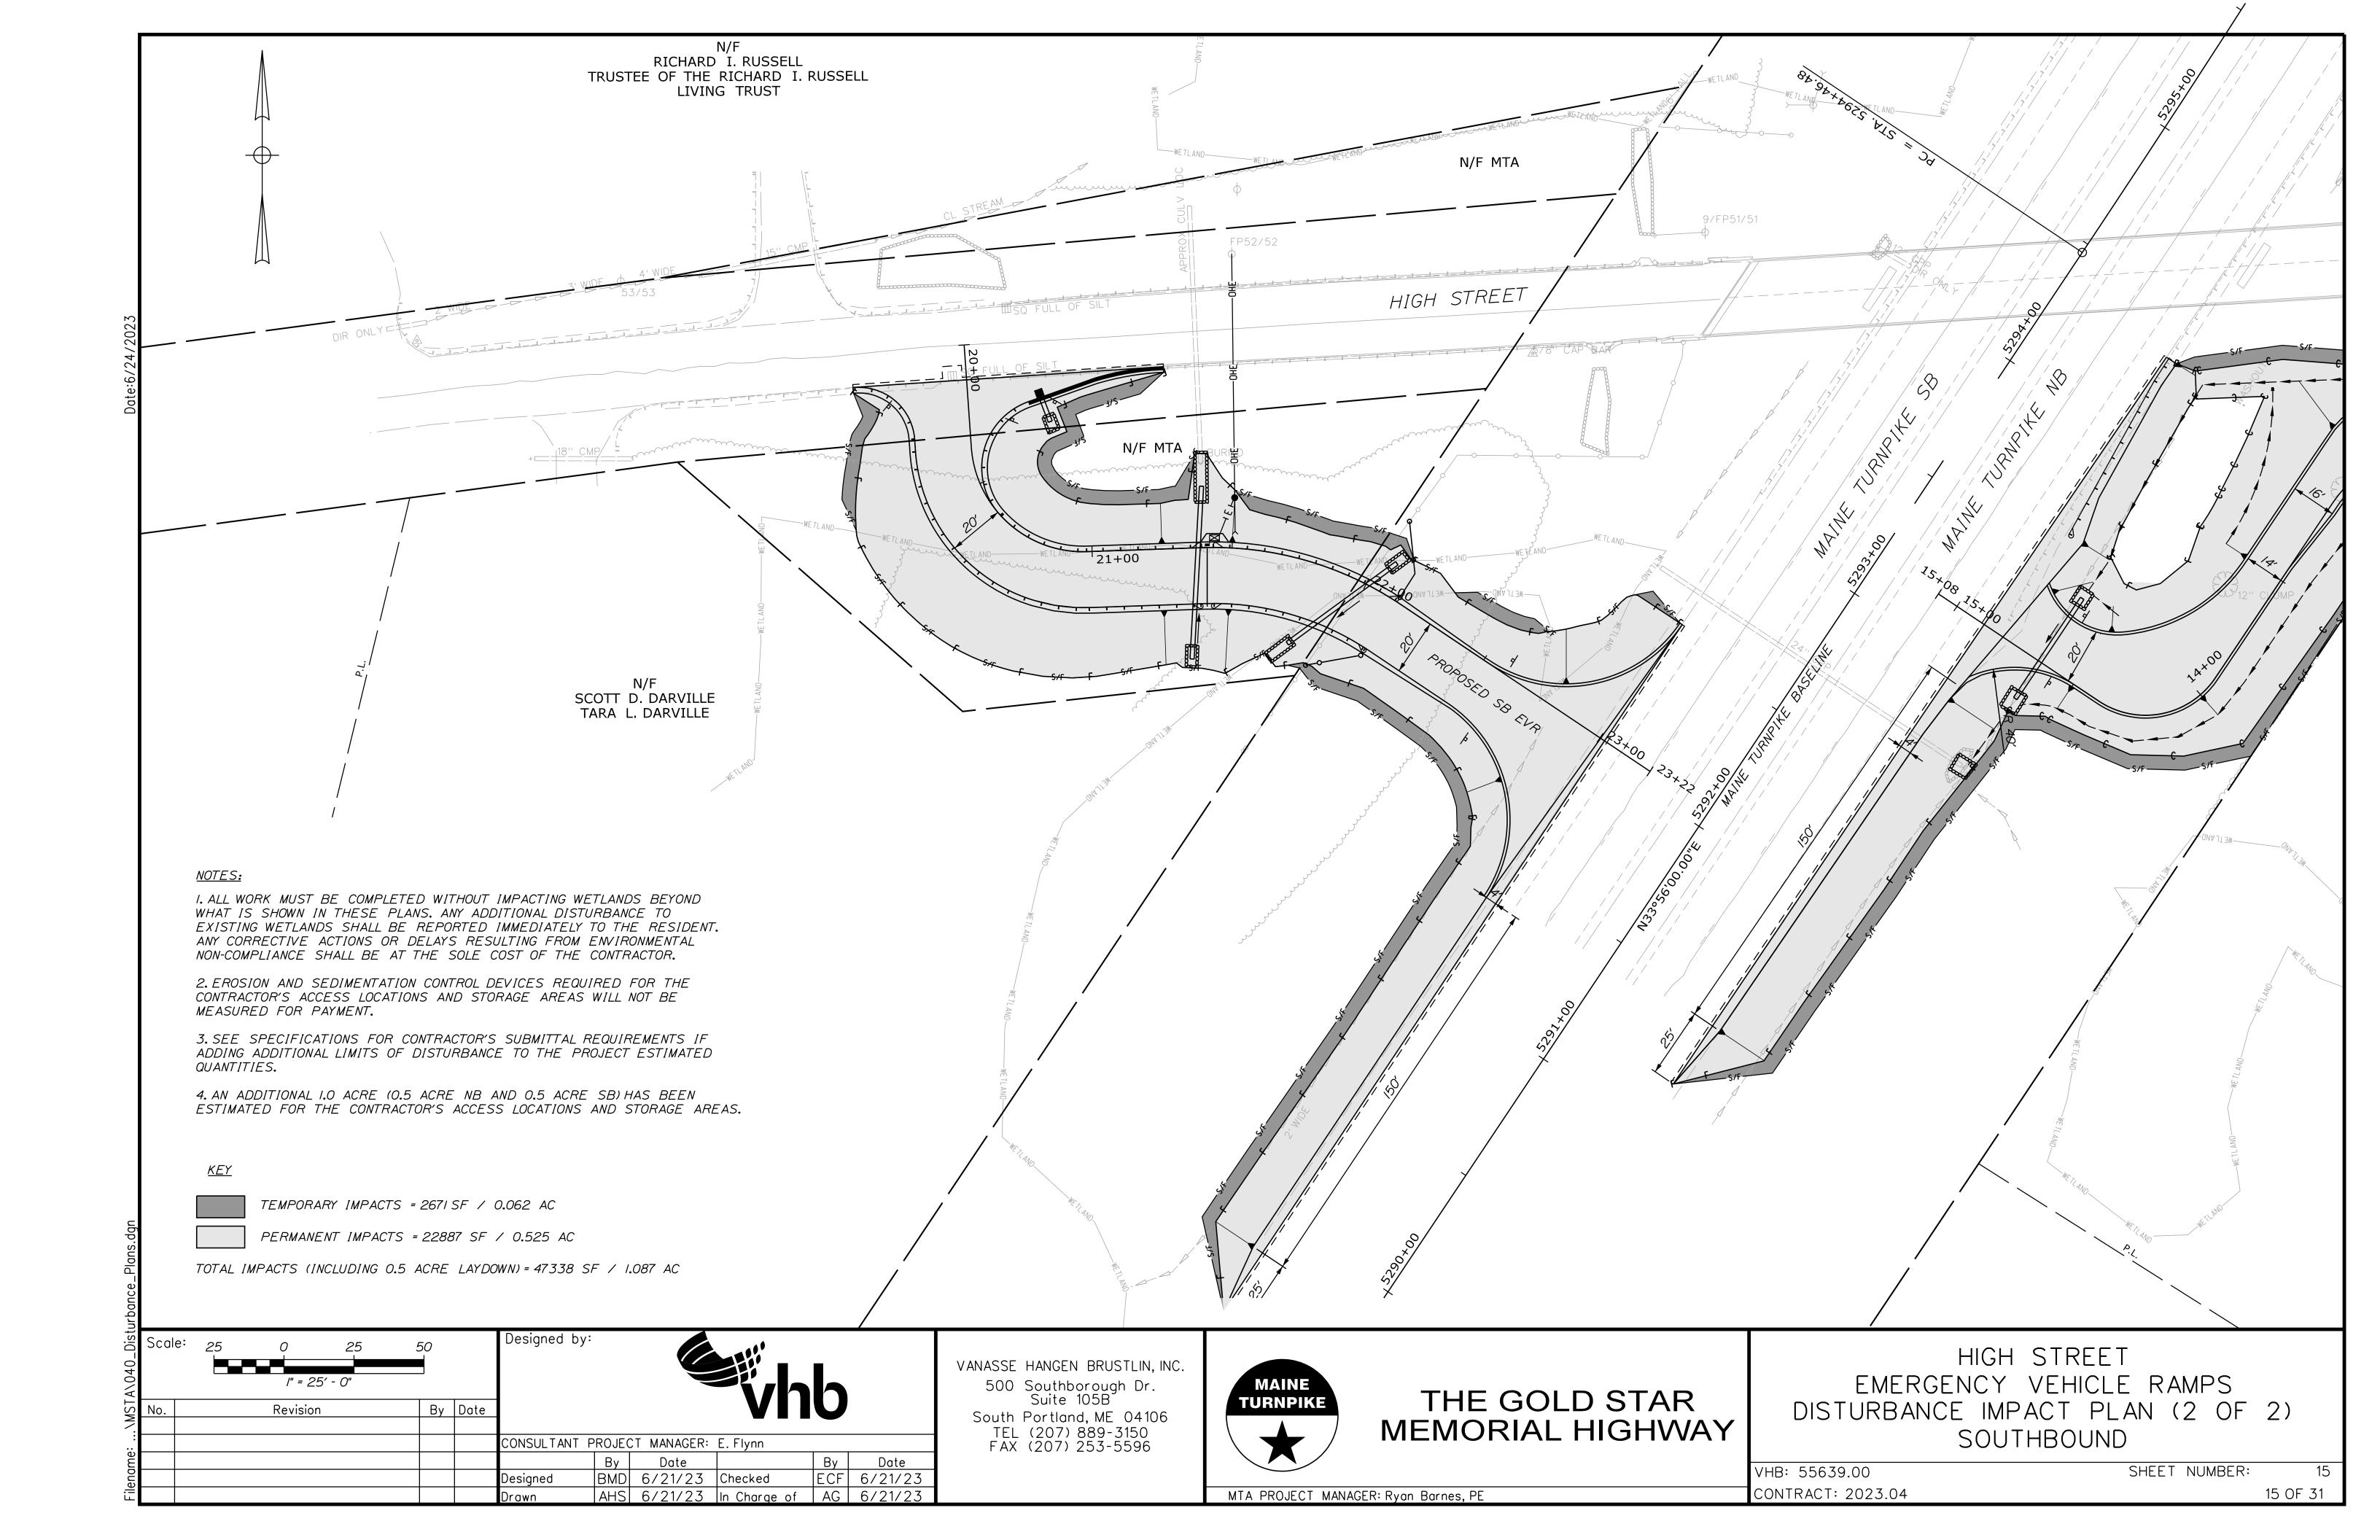



THE GOLD STAR
MEMORIAL HIGHWAY

HIGH STREET
EMERGENCY VEHICLE RAMPS
PROFILE - SOUTHBOUND

VHB: 55639.00 SHEET NUMBER: 13 CONTRACT: 2023.04 13 OF 31



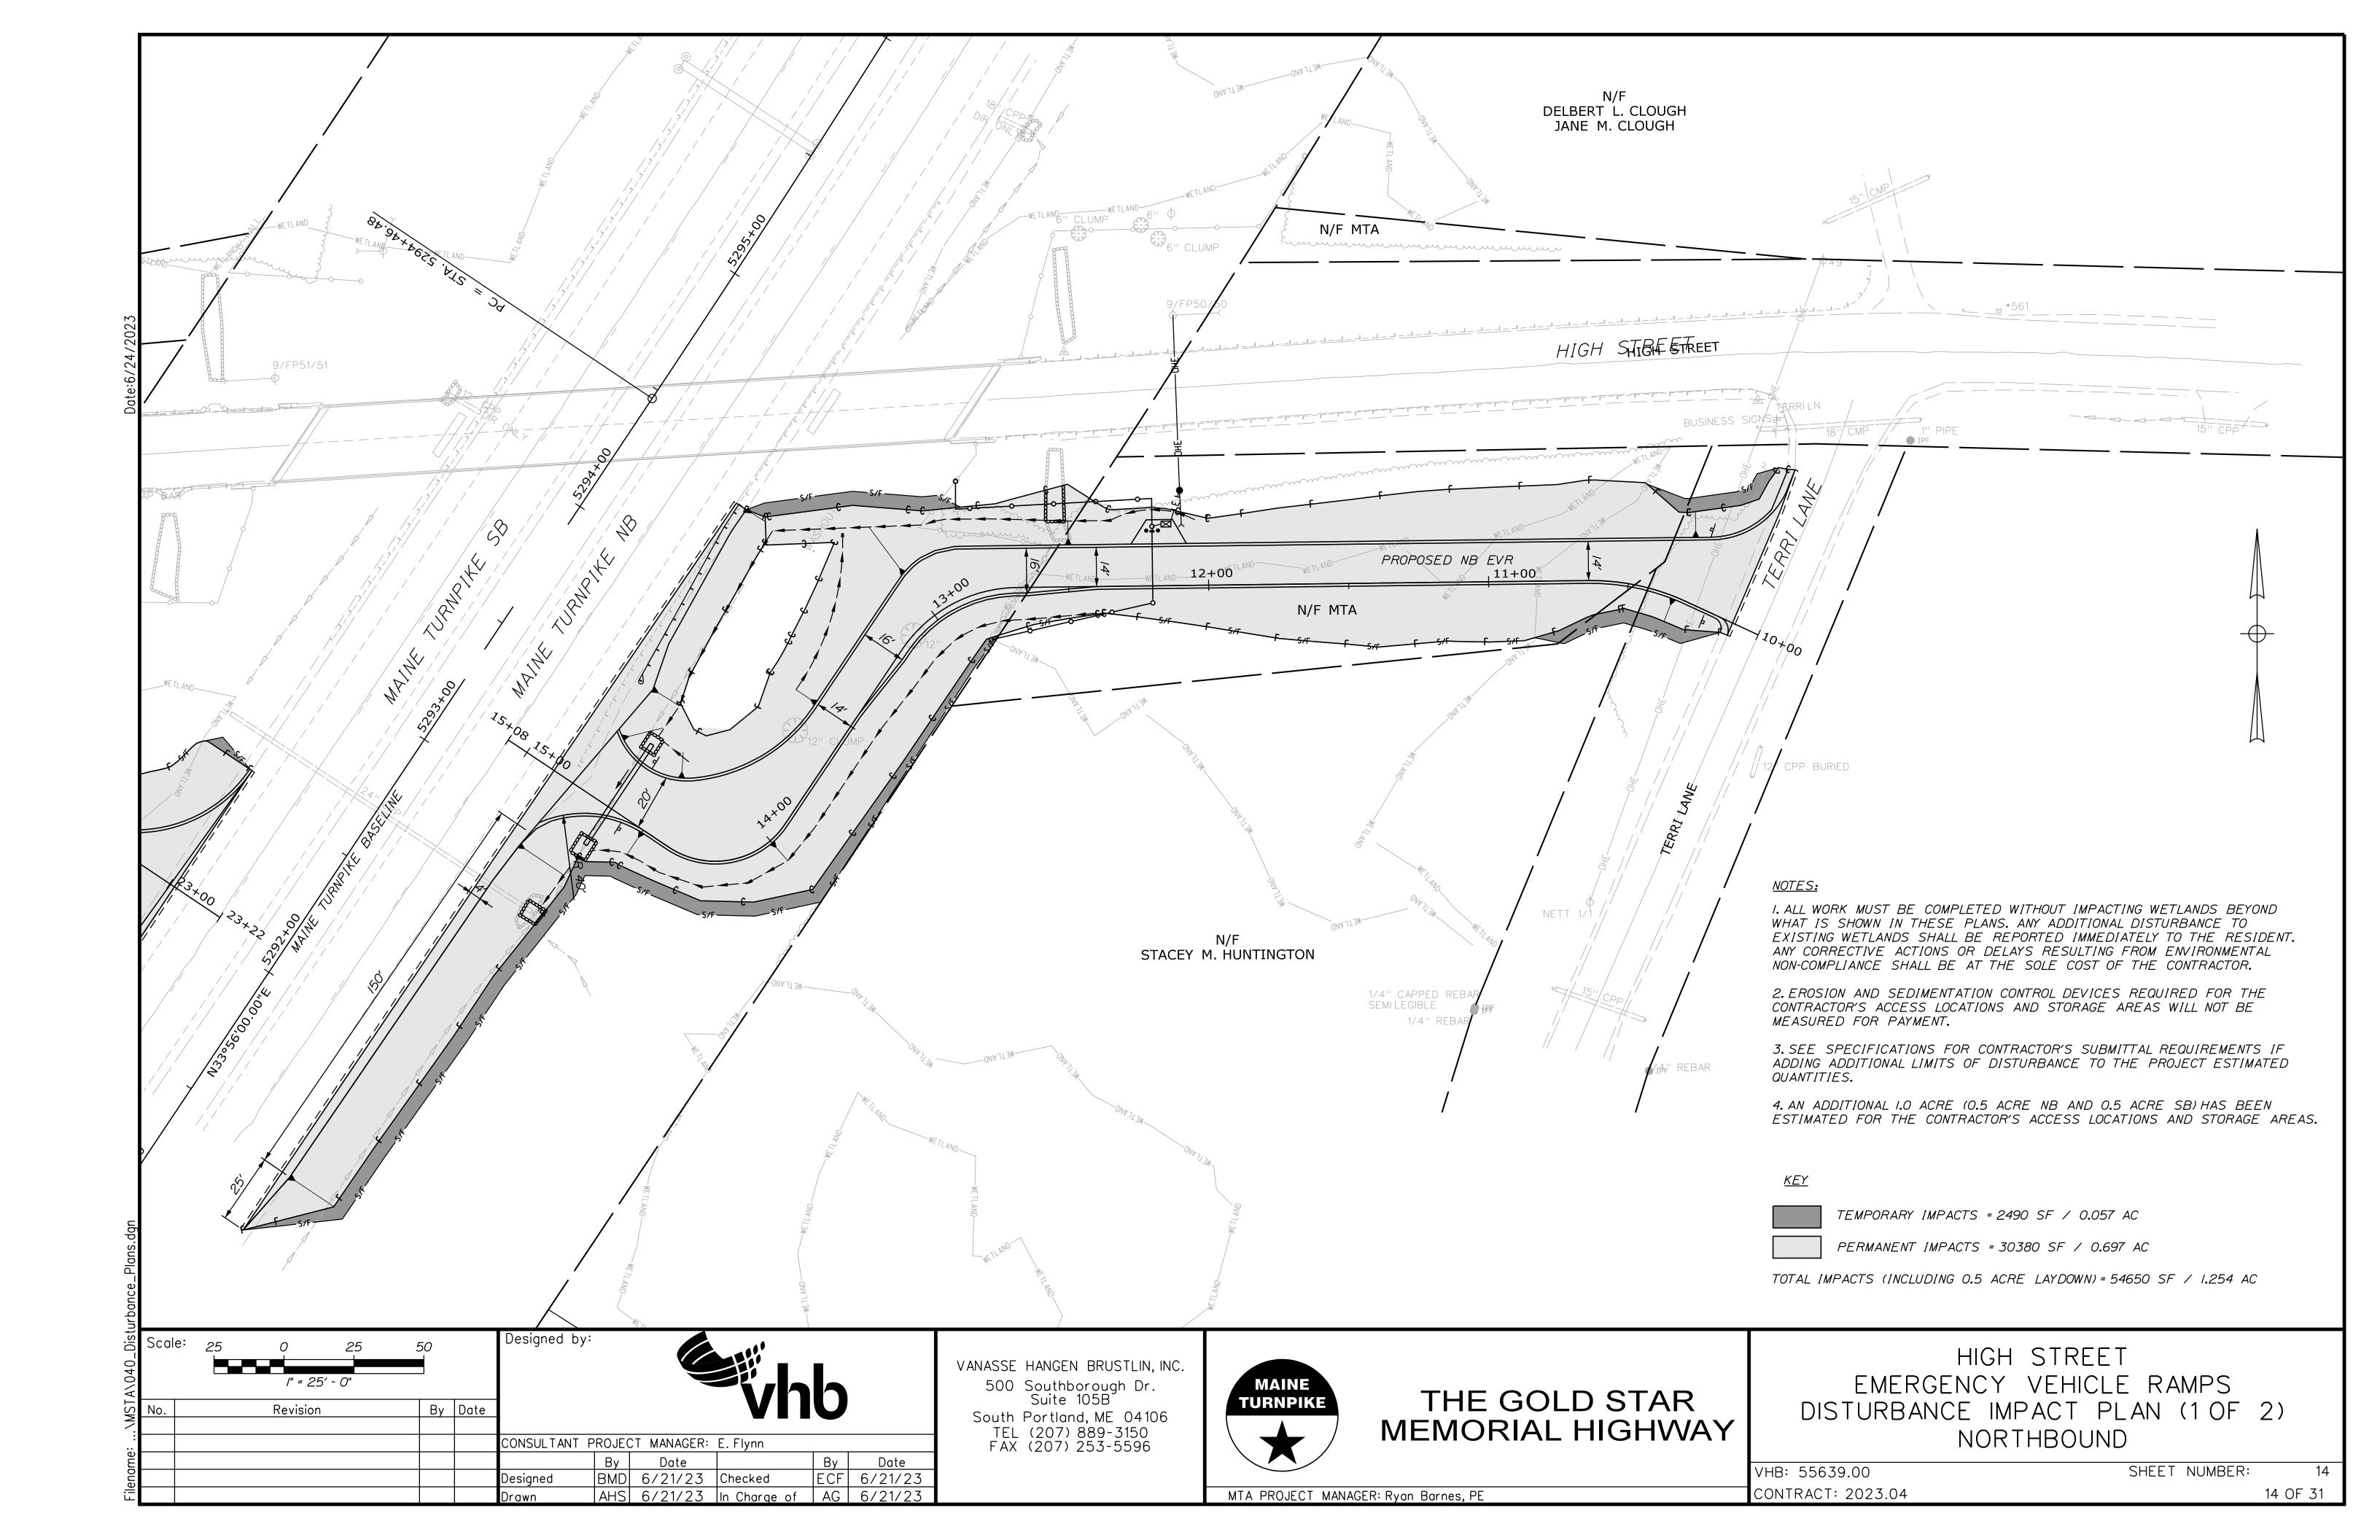

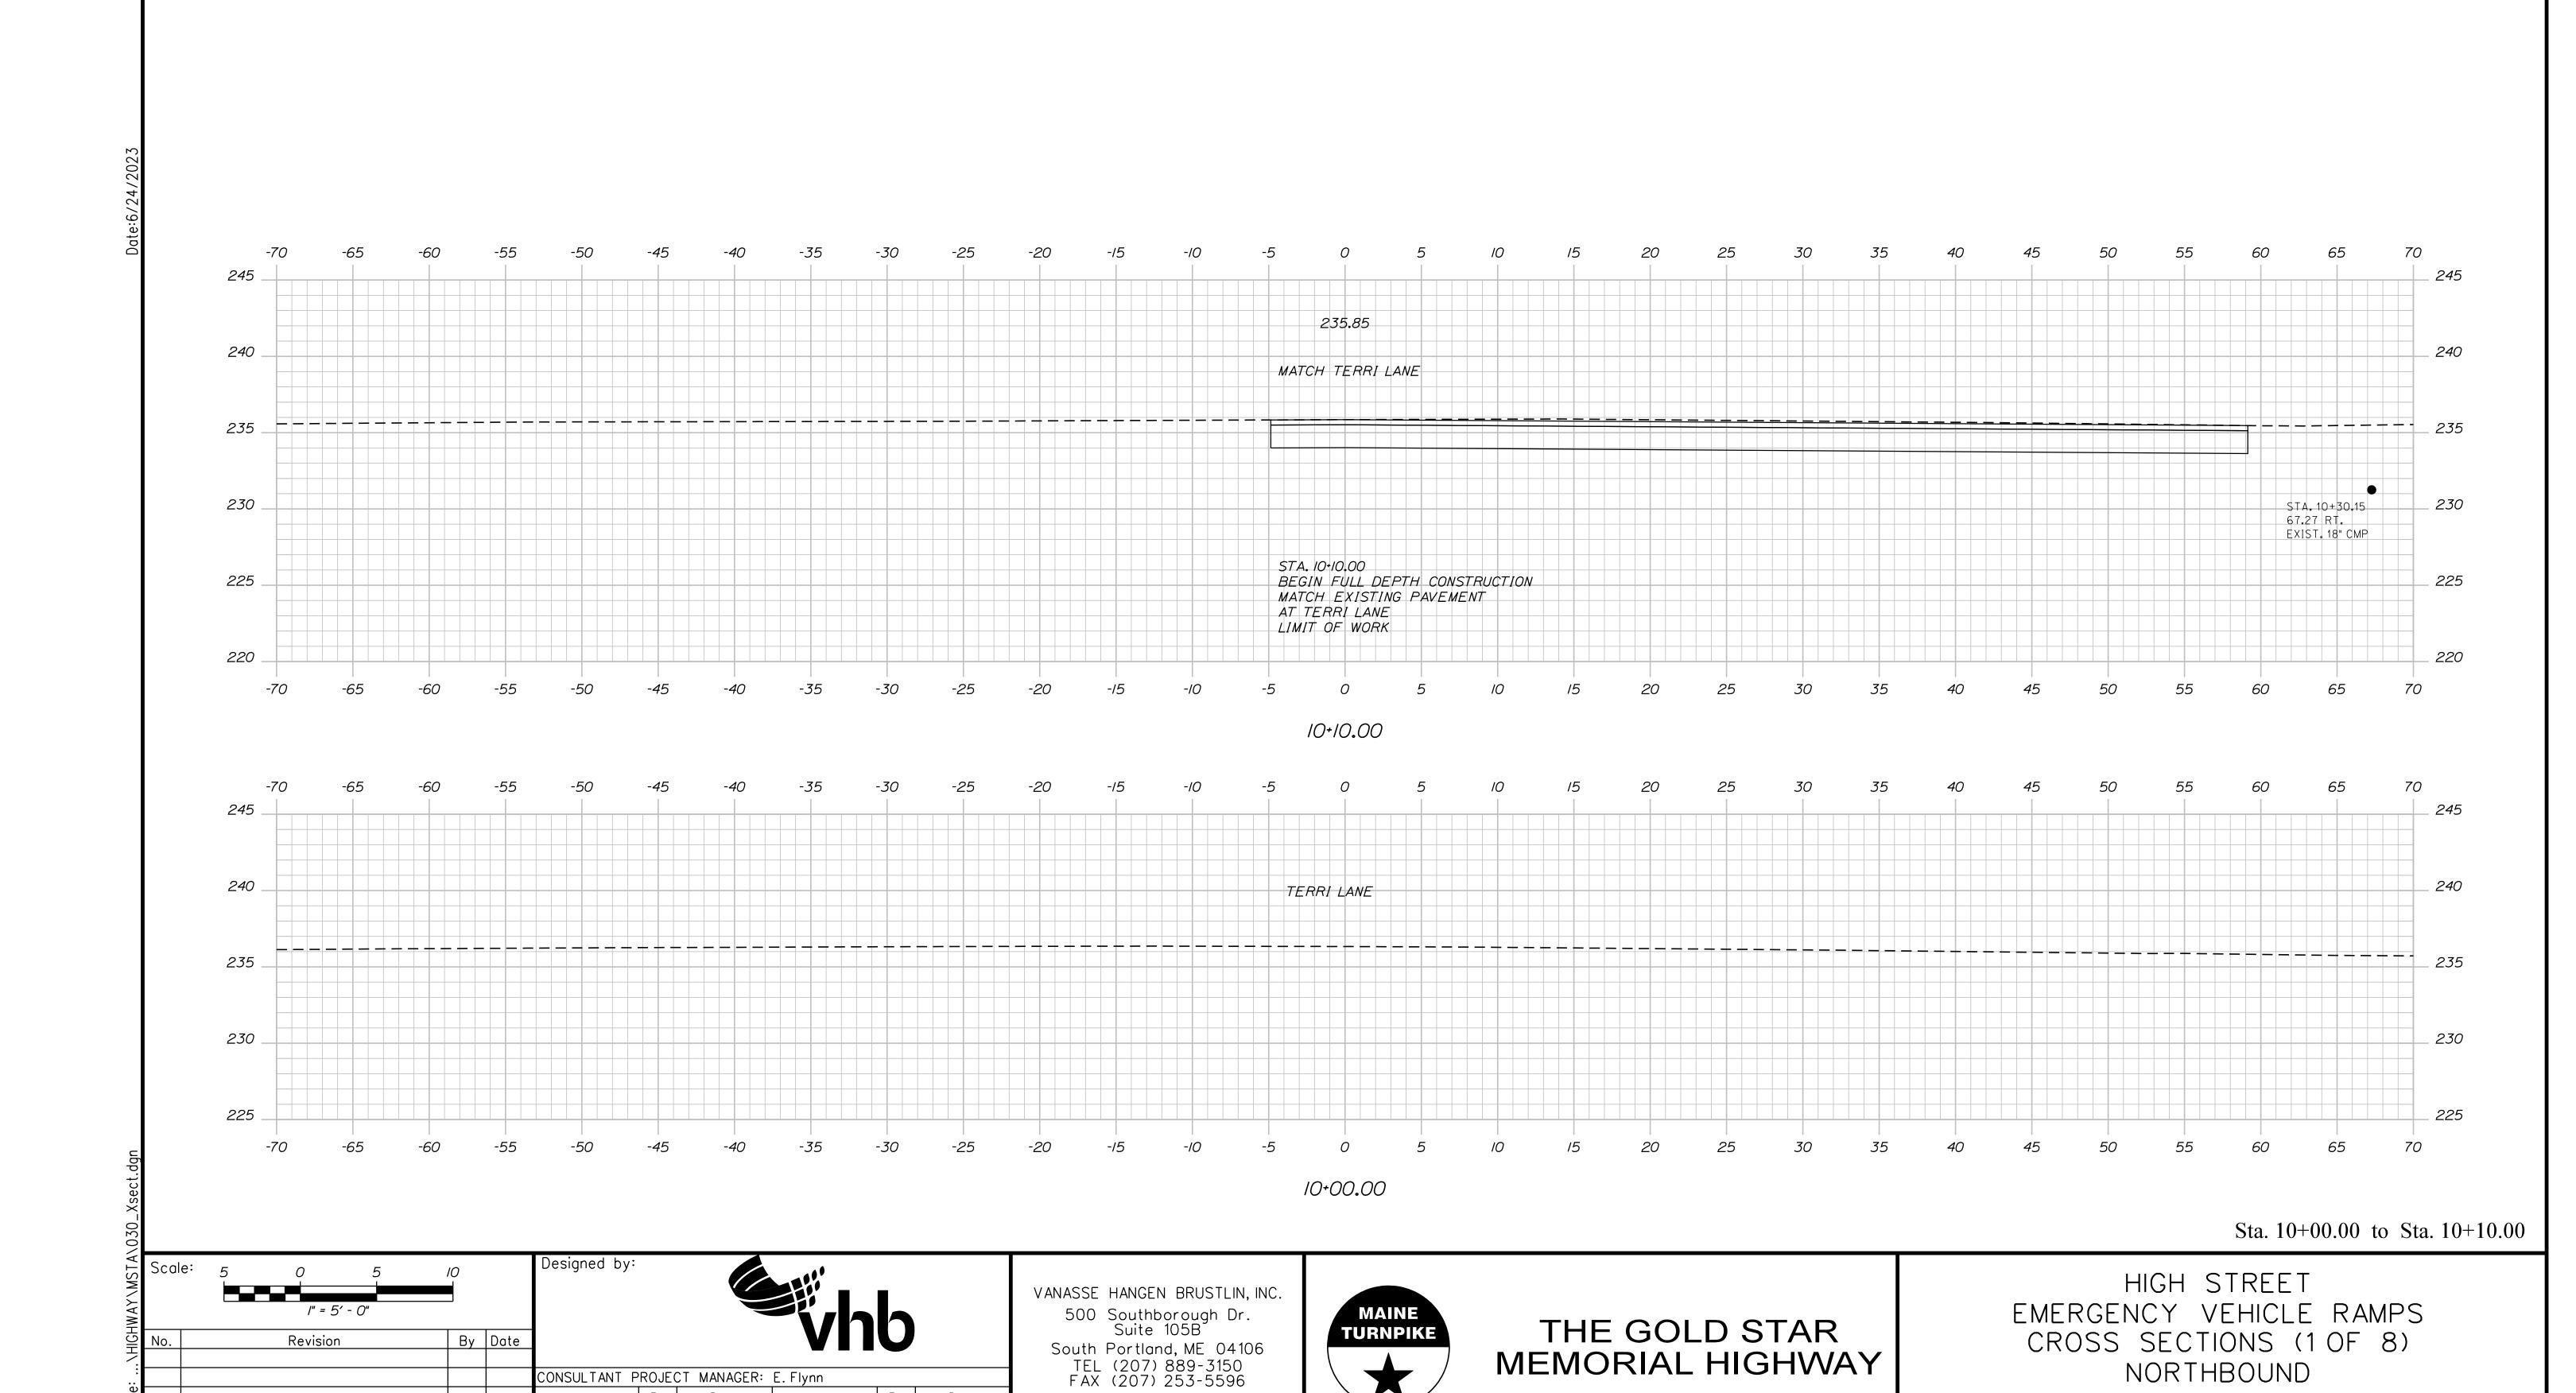

MTA PROJECT MANAGER: Ryan Barnes, PE

SHEET NUMBER: NB-XS-1

16 OF 31

VHB: 55639.00


CONTRACT: 2023.04

 By
 Date
 By
 Date

 BMD
 6/21/23
 Checked
 ECF
 6/21/23

 AHS
 6/21/23
 In Charge of
 AG
 6/21/23

Designed

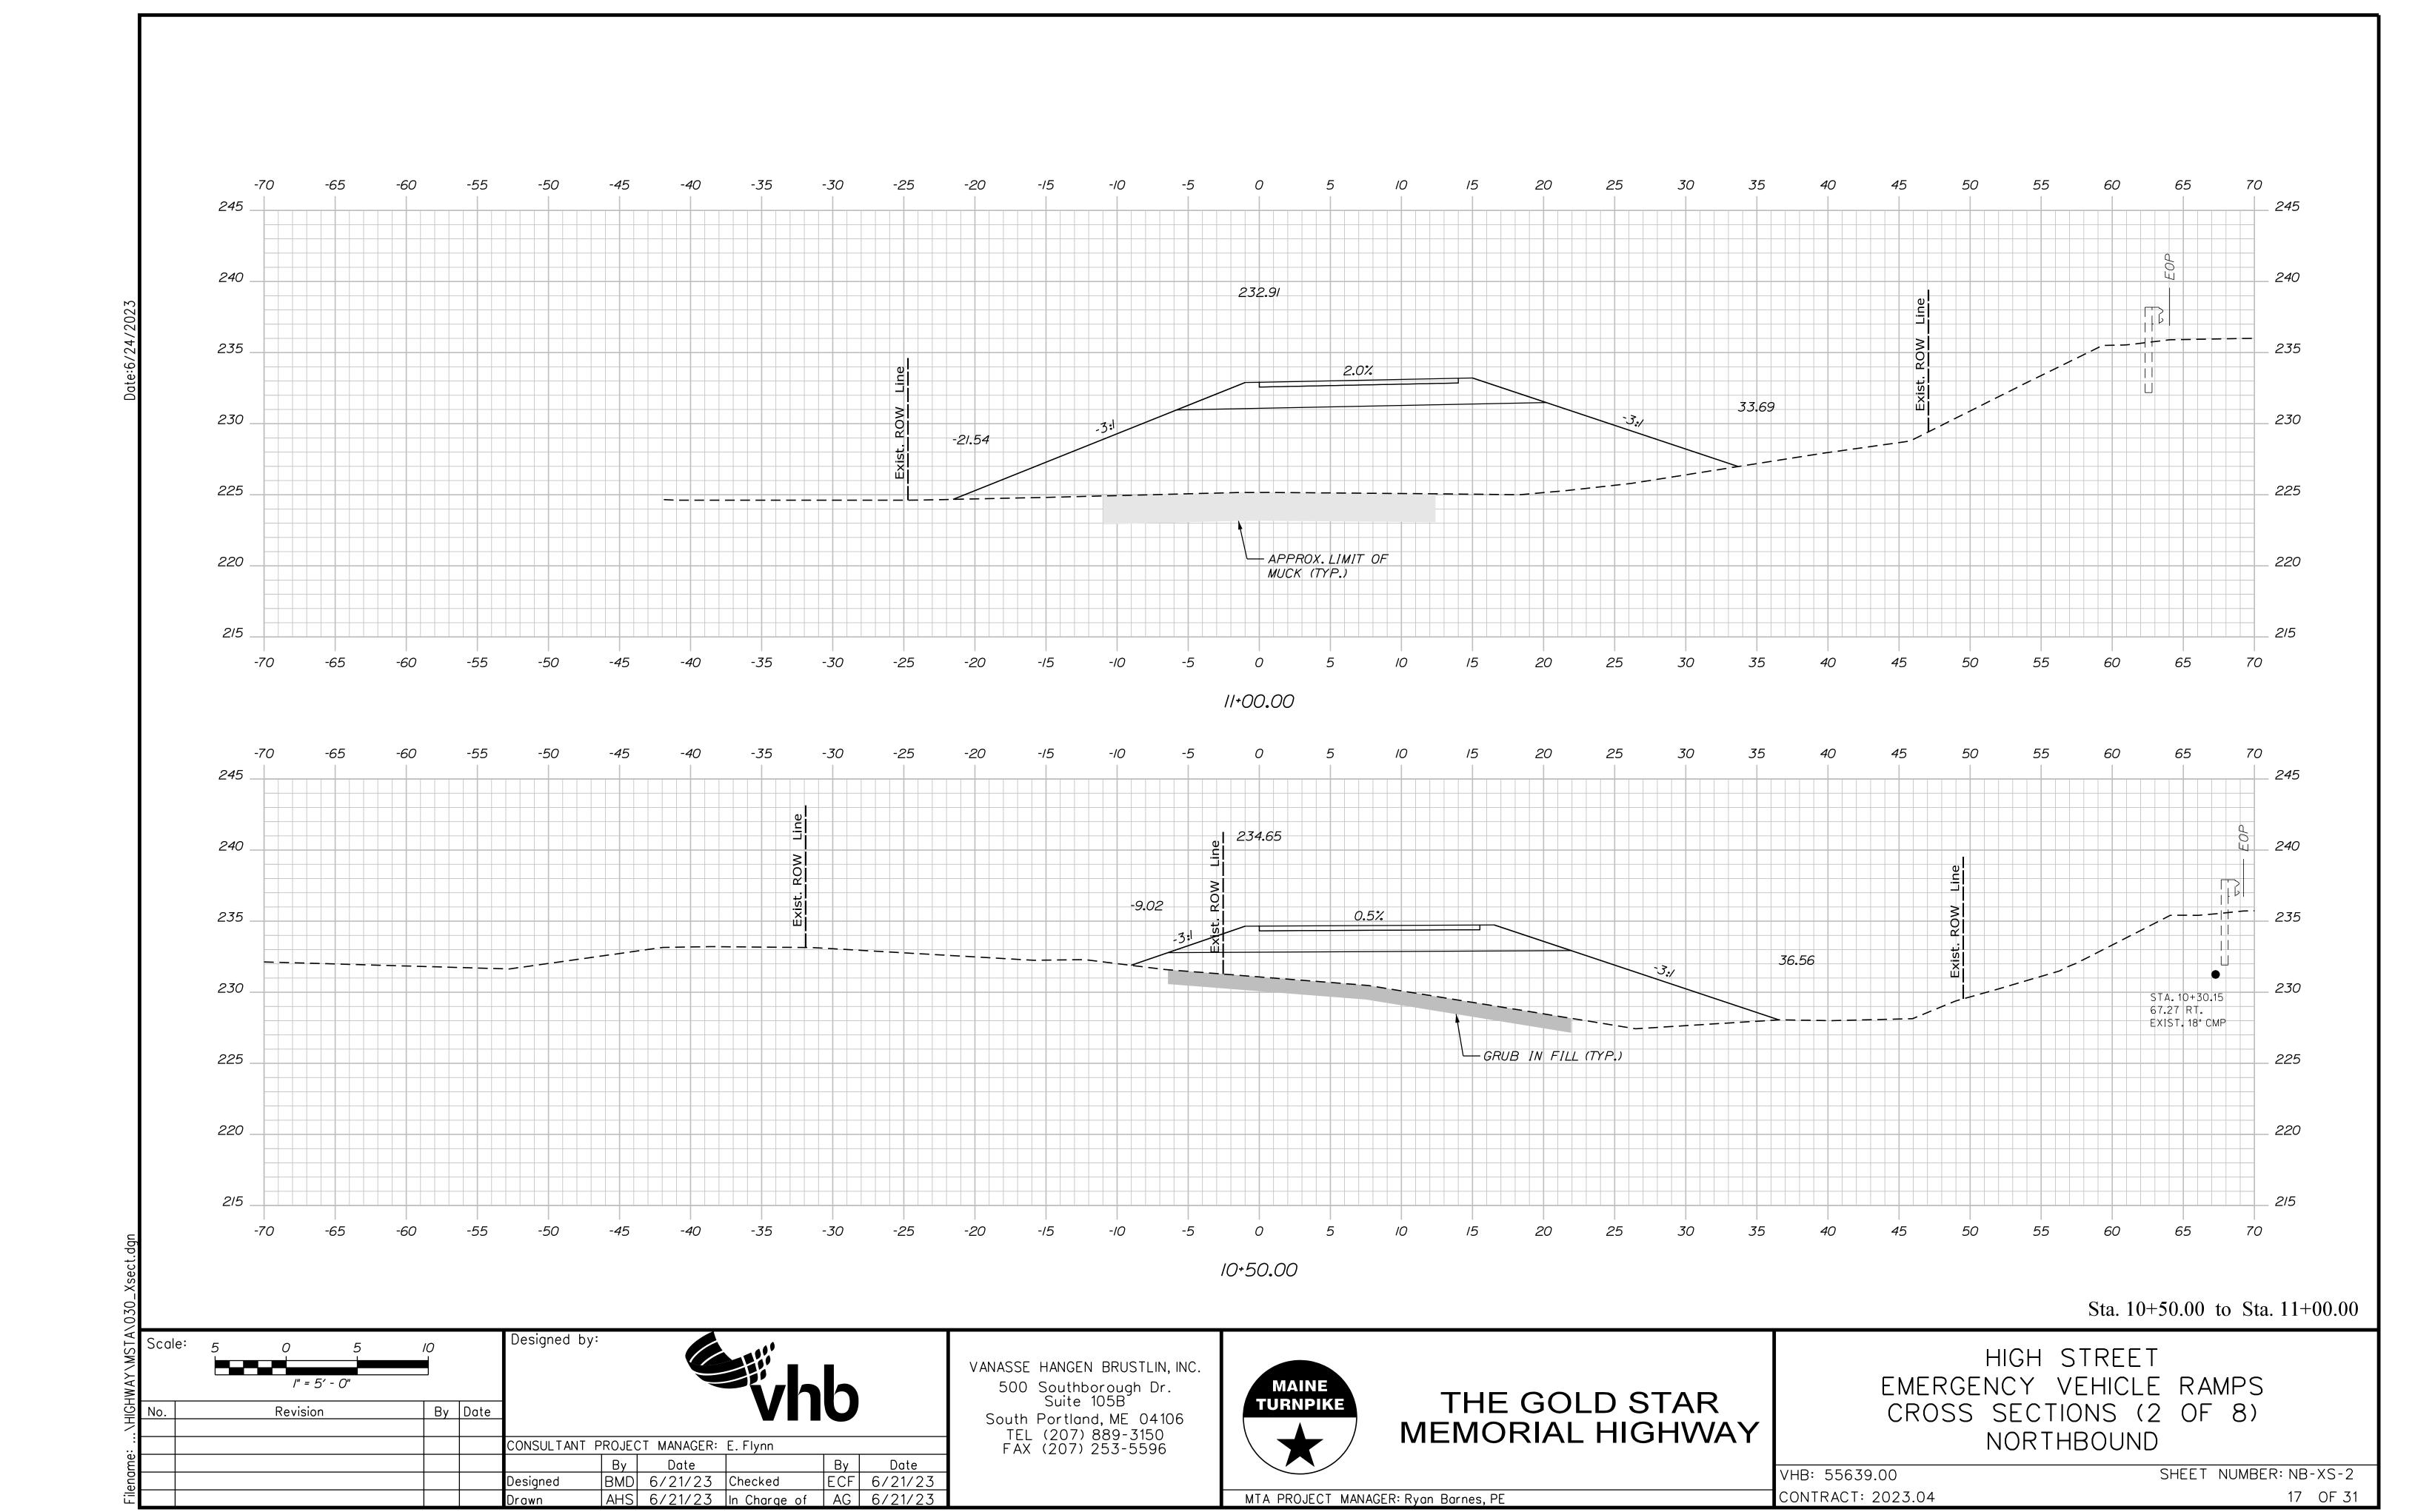

230.24 2.0% 230 230 29.84 -21.71 \_ 225 225 GRUB IN FILL (TYP.) 220 \_ 220 APPROX. LIMIT OF MUCK (TYP.) 215 -25 *2*5 65 70 //÷50**.**00 Sta. 11+50.00 Designed by: HIGH STREET VANASSE HANGEN BRUSTLIN, INC. EMERGENCY VEHICLE RAMPS CROSS SECTIONS (3 OF 8) 500 Southborough Dr. Suite 105B THE GOLD STAR By Date

MEMORIAL HIGHWAY

MTA PROJECT MANAGER: Ryan Barnes, PE

NORTHBOUND

VHB: 55639.00

CONTRACT: 2023.04

SHEET NUMBER: NB-XS-3

18 OF 31

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Revision


CONSULTANT PROJECT MANAGER: E.Flynn

Designed

 By
 Date
 By
 Date

 BMD
 6/21/23
 Checked
 ECF
 6/21/23

 AHS
 6/21/23
 In Charge of
 AG
 6/21/23

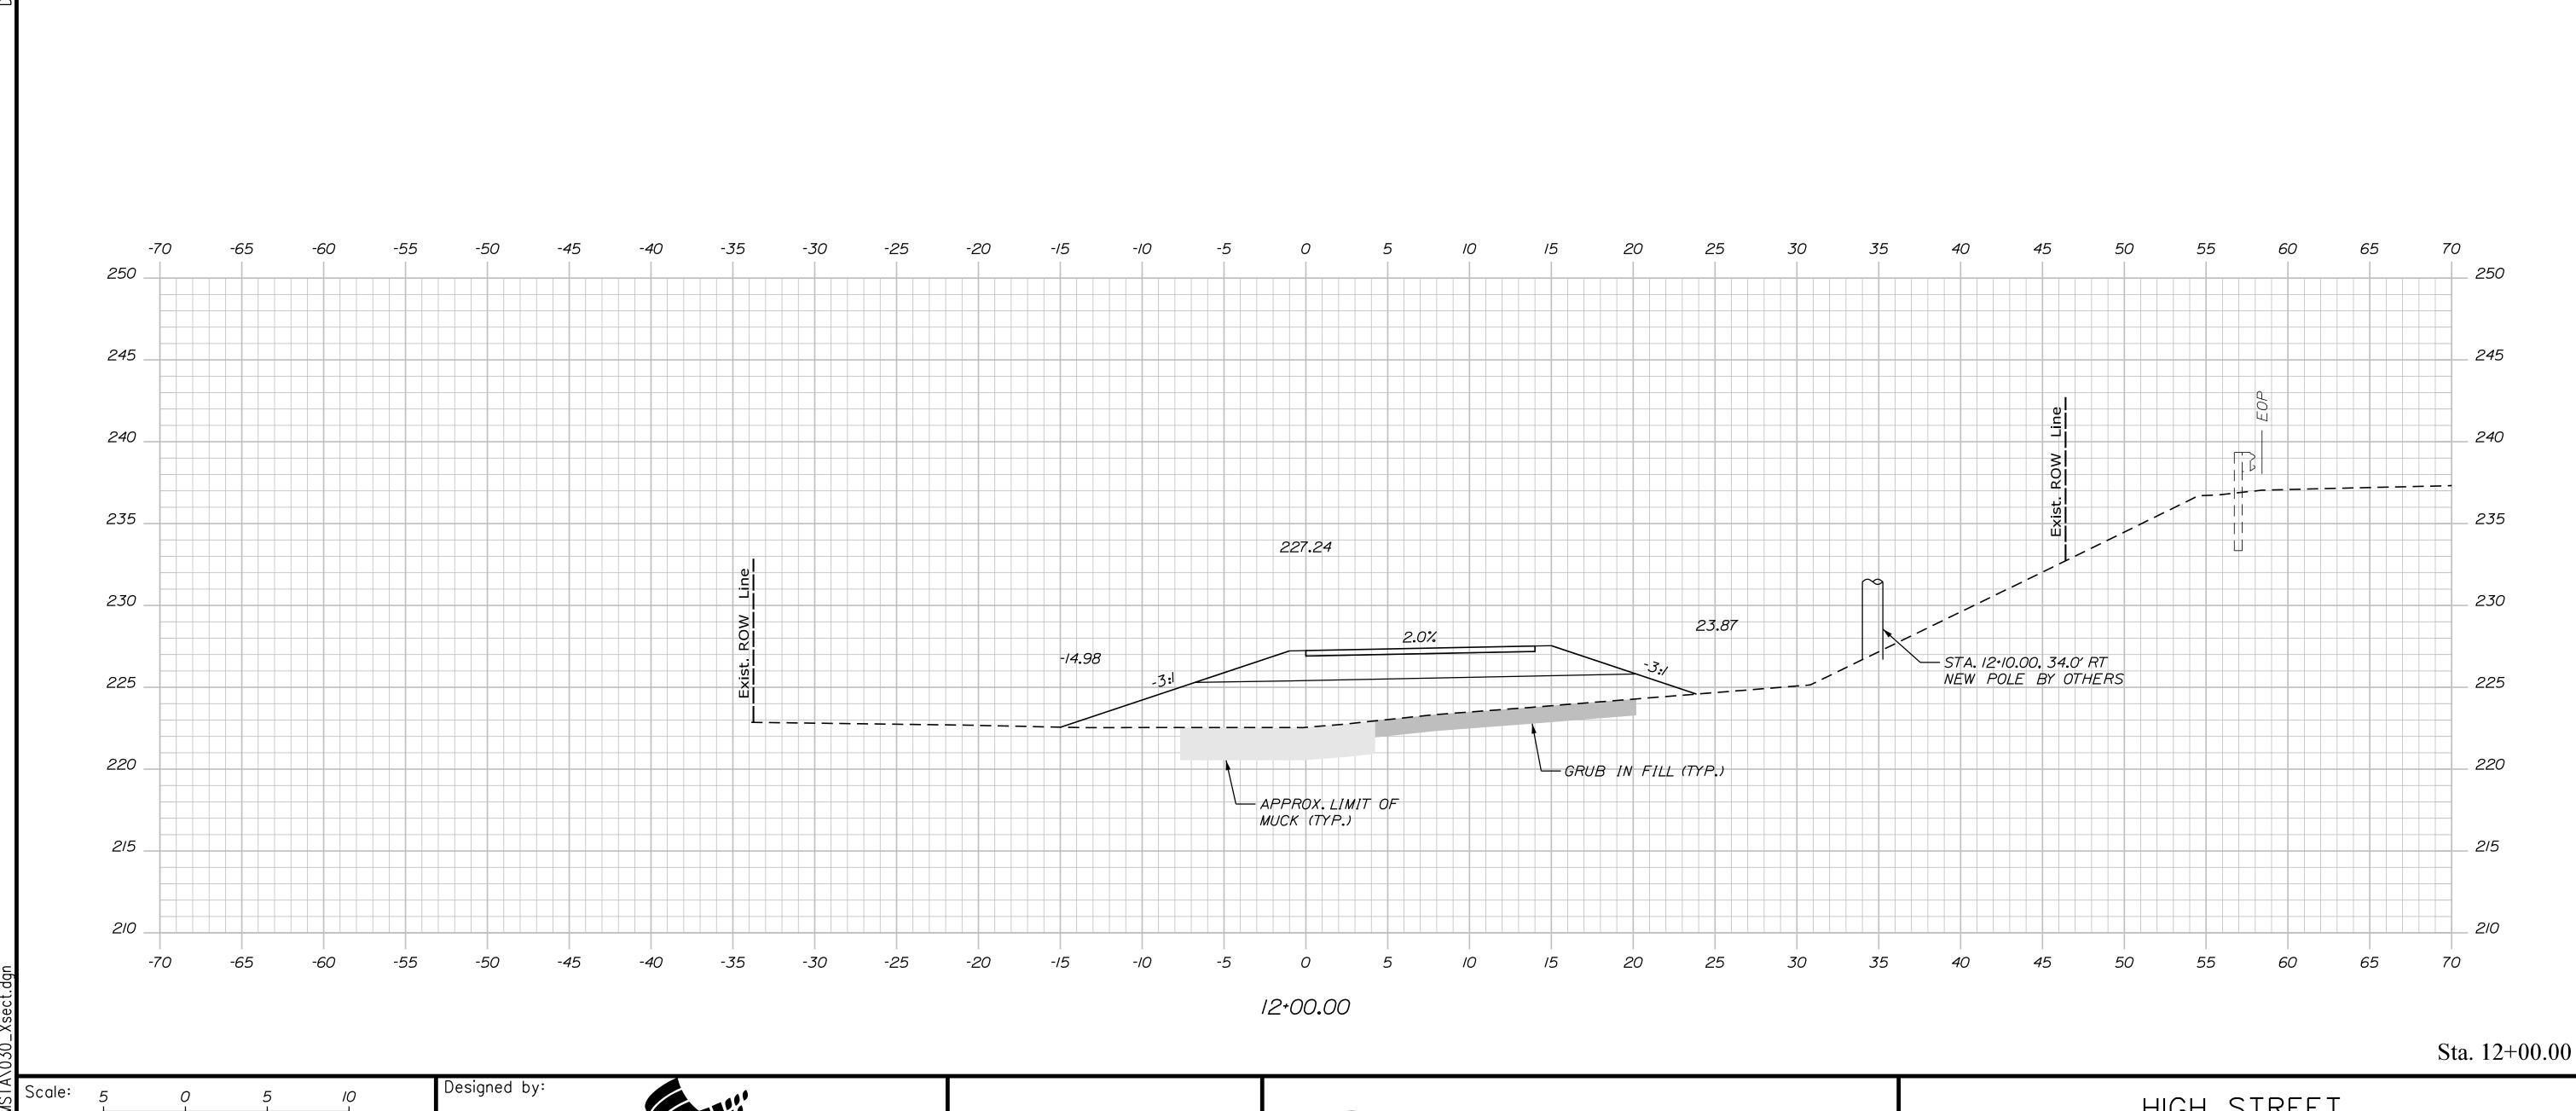

| No. | Revision | By | Date | CONSULTANT PROJECT MANAGER: E. Flynn | By | Date | Consultant Project | By | Date |

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500 Southborough Dr.
Suite 105B


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MAINE
TURNPIKE

# THE GOLD STAR MEMORIAL HIGHWAY

HIGH STREET
EMERGENCY VEHICLE RAMPS
CROSS SECTIONS (4 OF 8)
NORTHBOUND

VHB: 55639.00 SHEET NUMBER: NB-XS-4 CONTRACT: 2023.04 19 OF 31

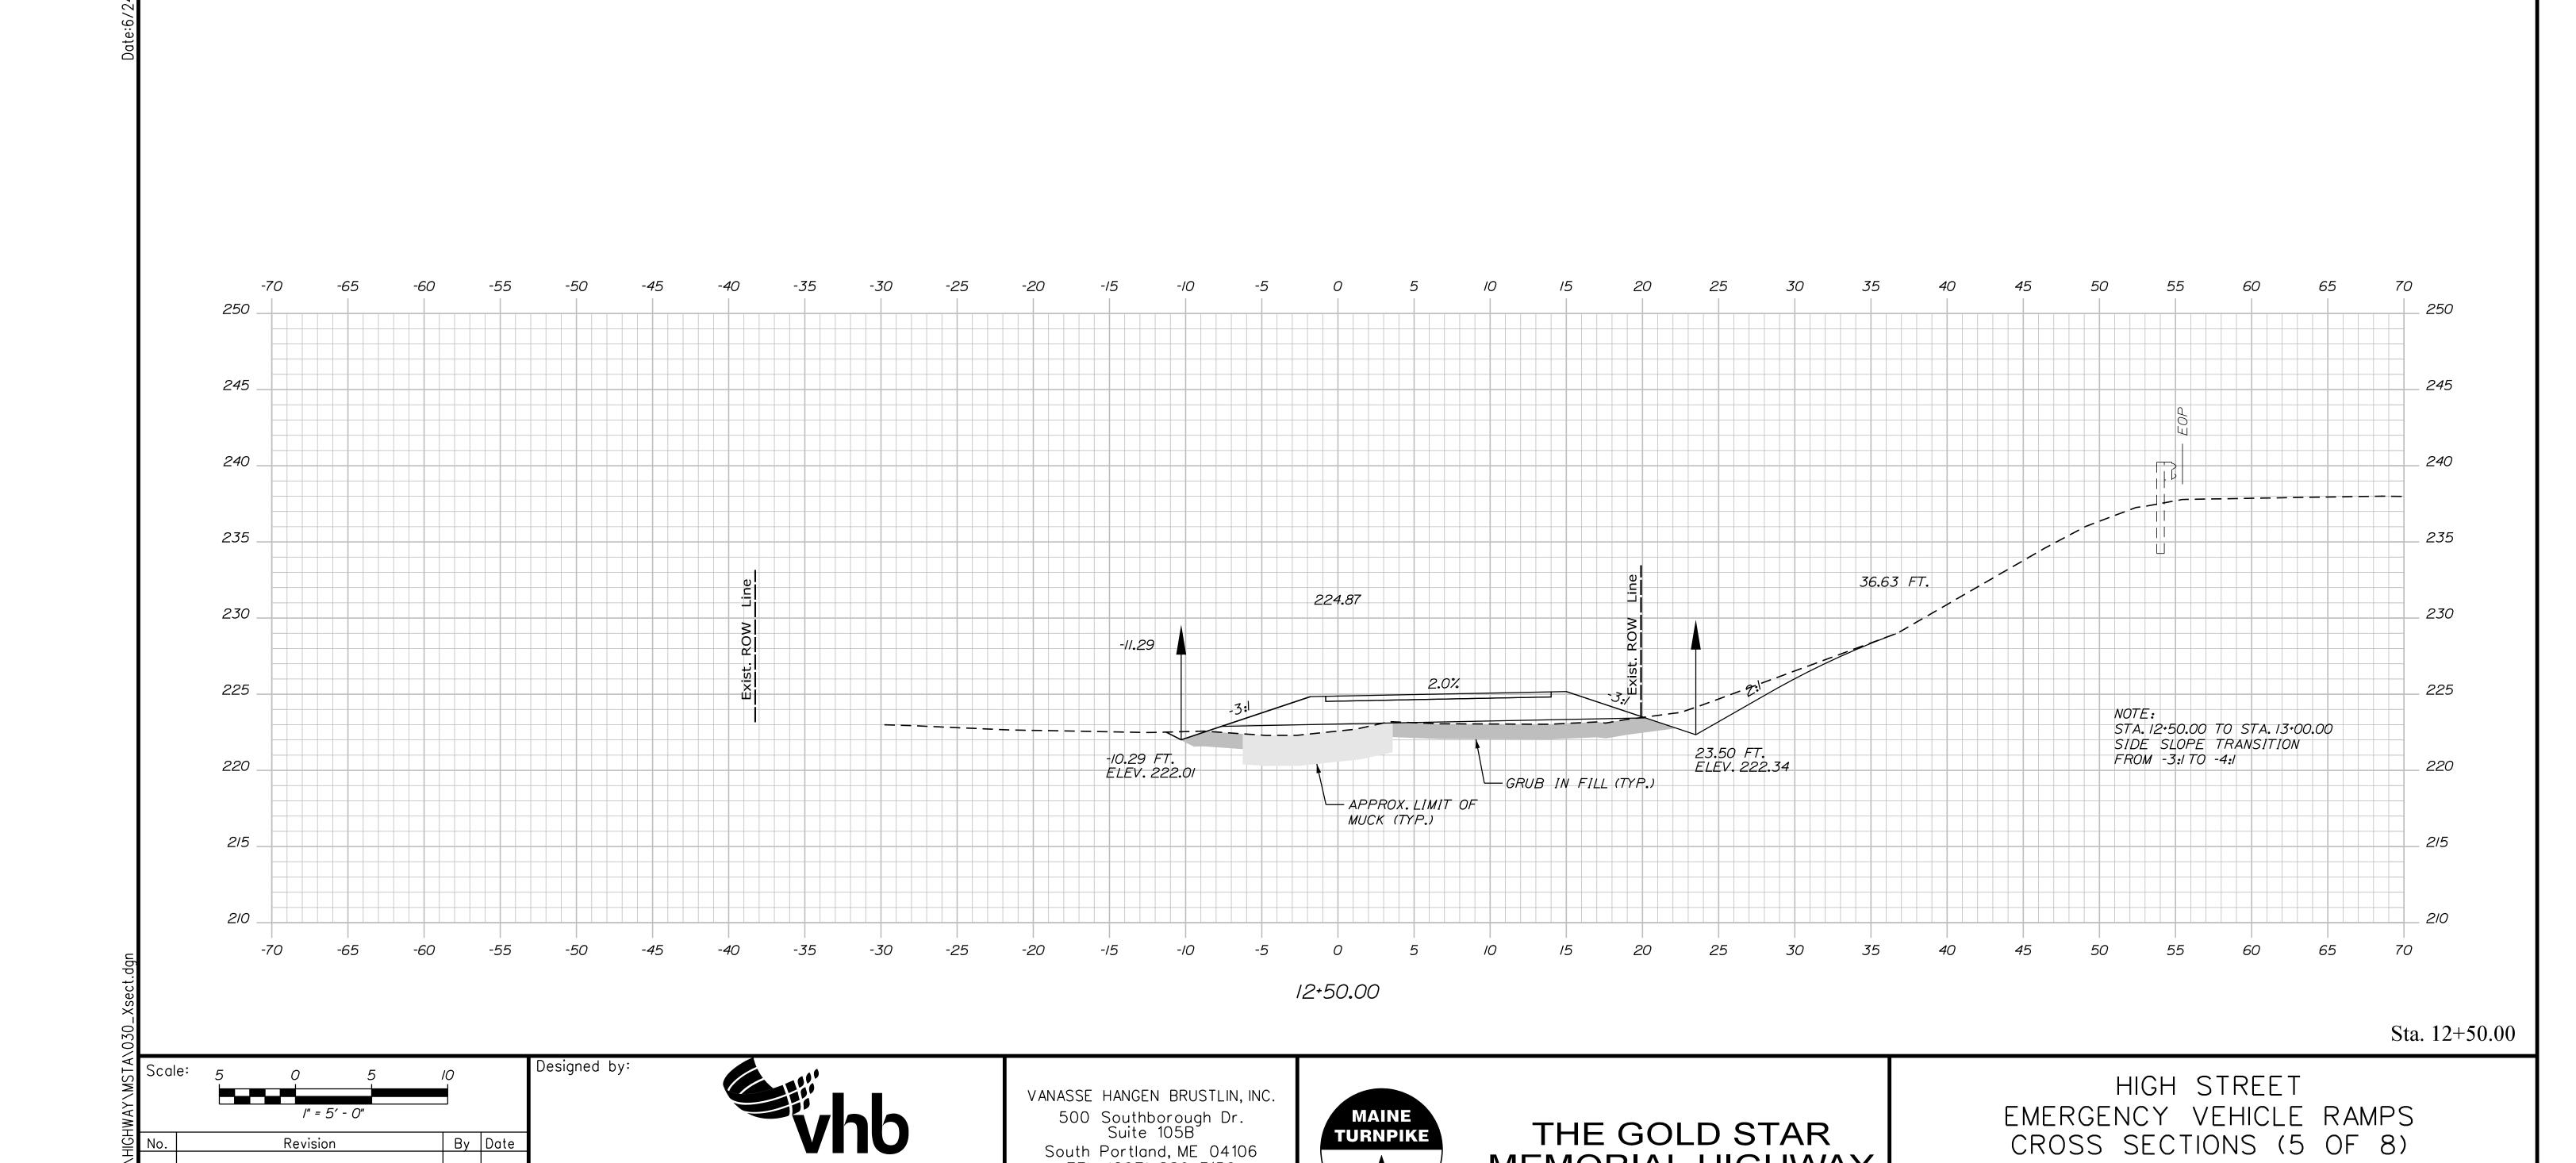

MEMORIAL HIGHWAY

MTA PROJECT MANAGER: Ryan Barnes, PE

NORTHBOUND

VHB: 55639.00

CONTRACT: 2023.04

SHEET NUMBER: NB-XS-5

20 OF 31

South Portland, ME 04106 TEL (207) 889-3150 FAX (207) 253-5596

By Date

Designed


CONSULTANT PROJECT MANAGER: E.Flynn


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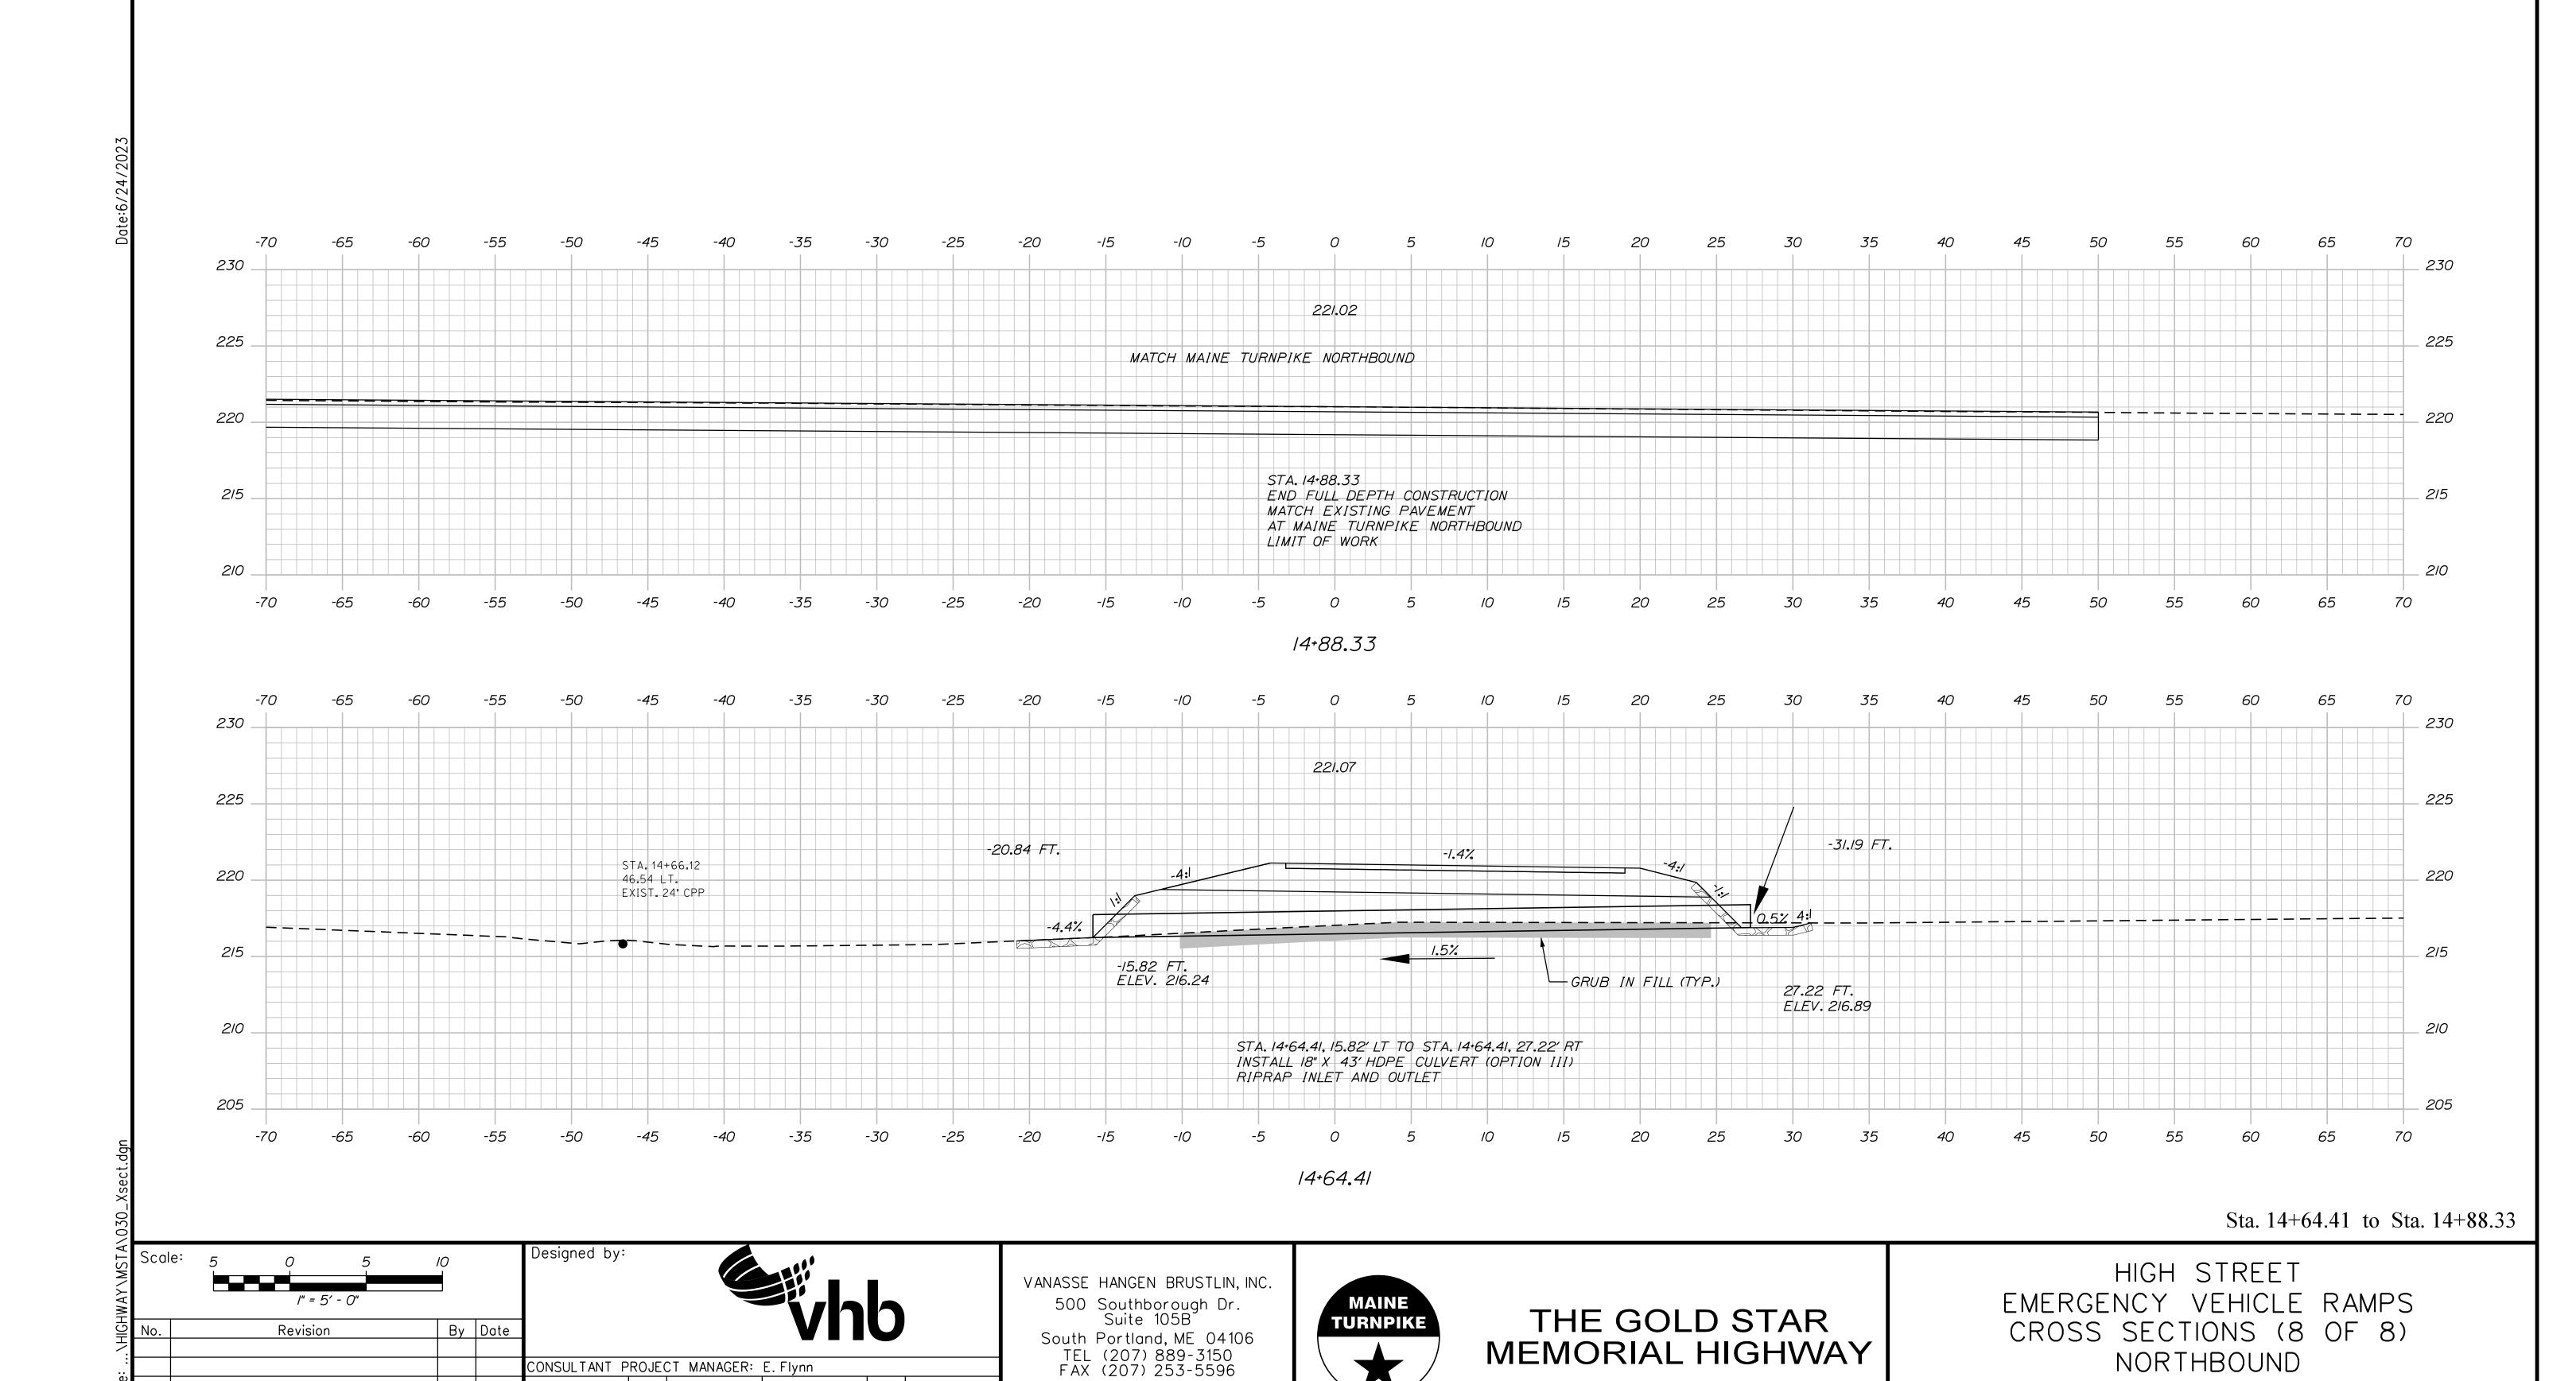
 BMD
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 ECF
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 AHS
 6/21/23
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 AG
 6/21/23

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MTA PROJECT MANAGER: Ryan Barnes, PE

SHEET NUMBER: NB-XS-8

23 OF 31

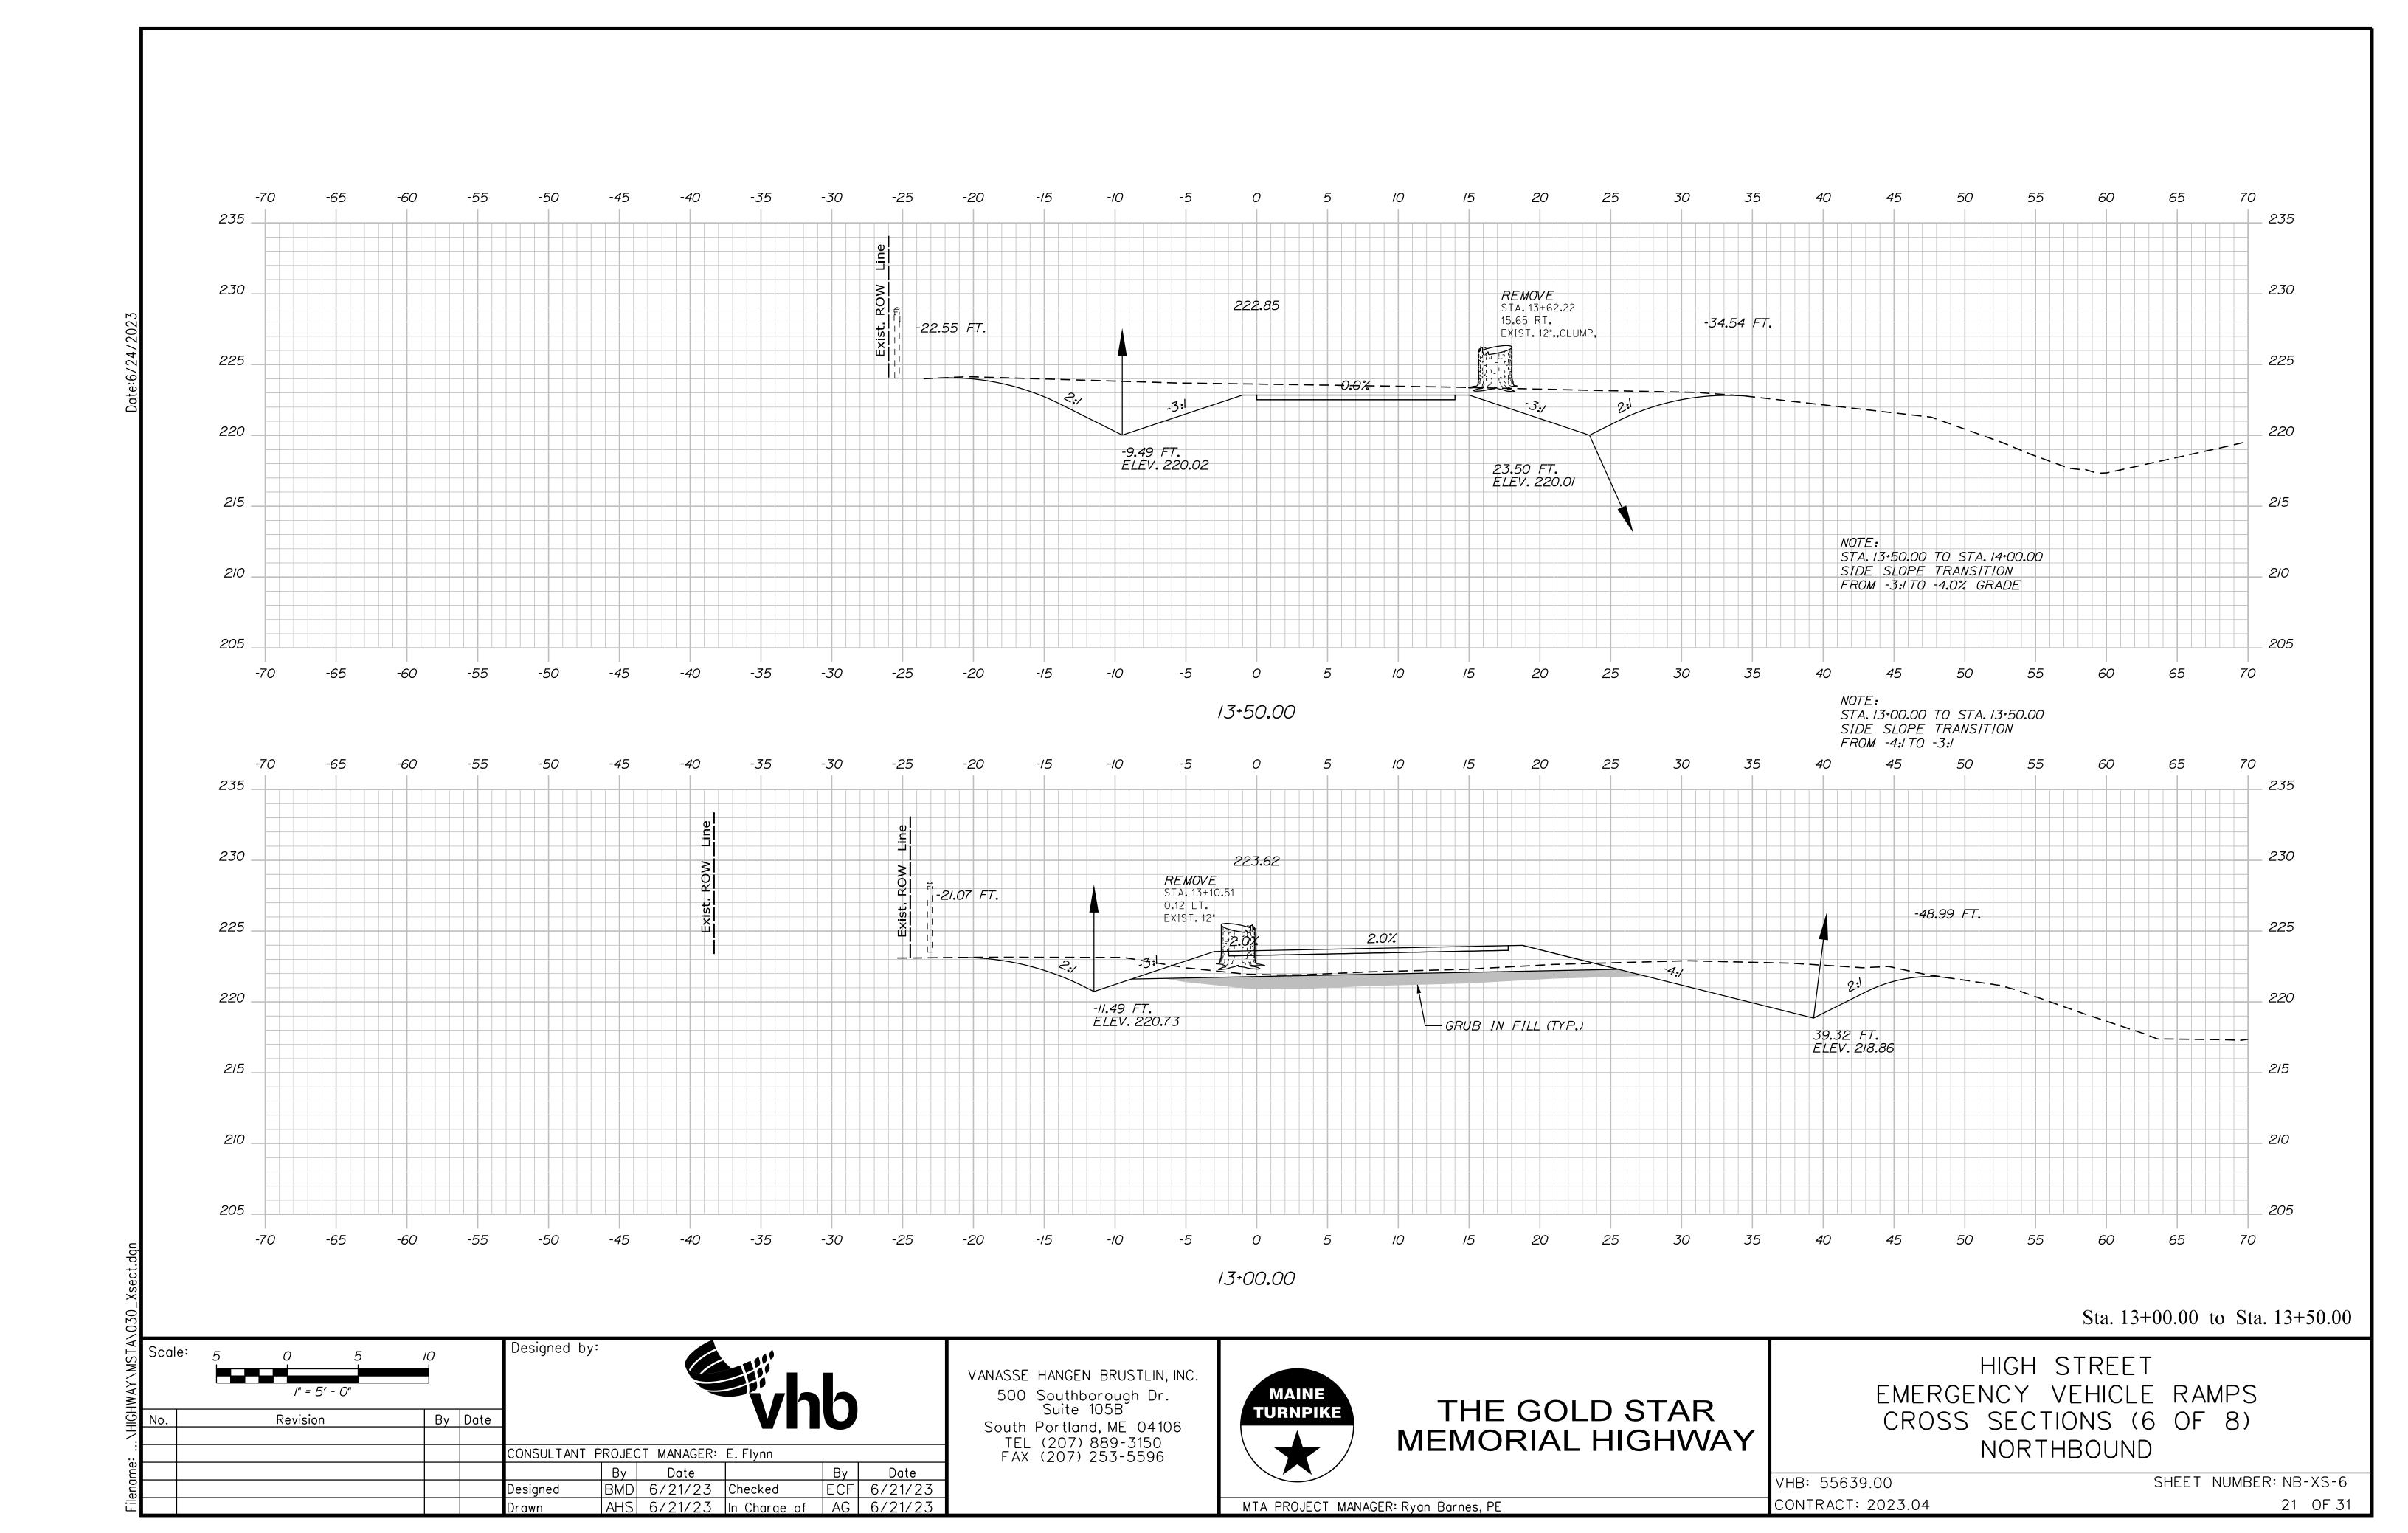VHB: 55639.00

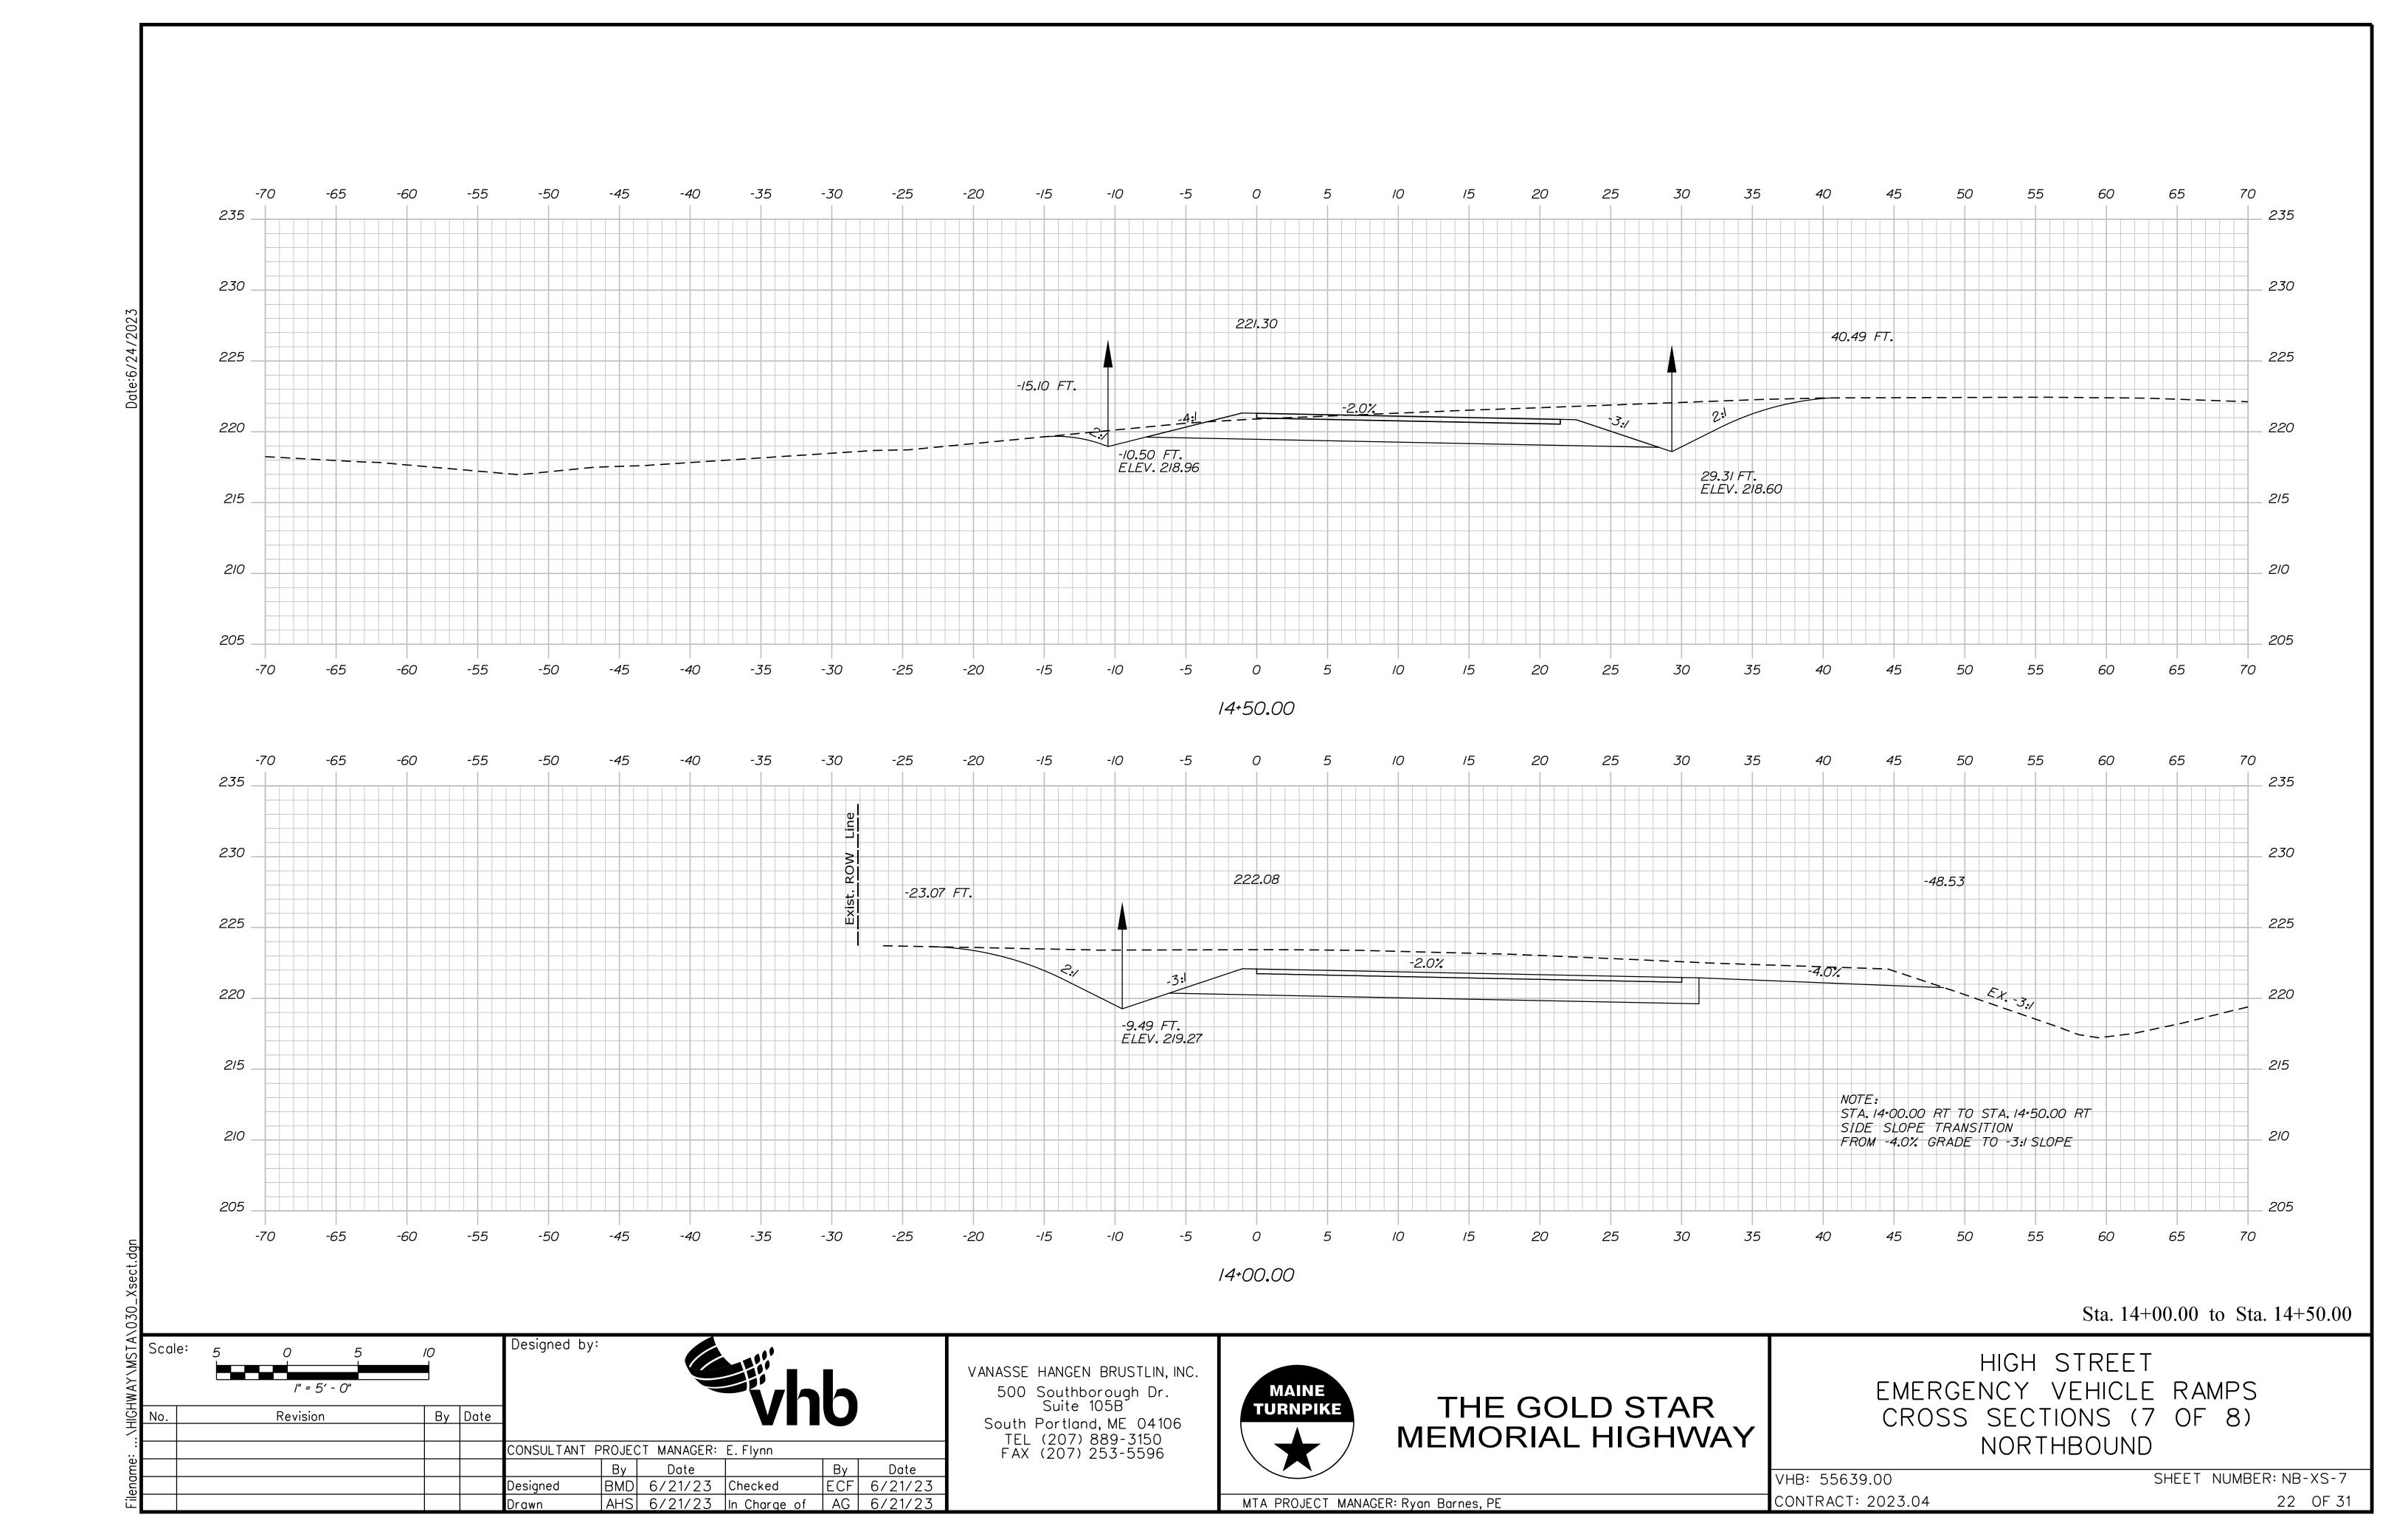
CONTRACT: 2023.04

By Date ECF 6/21/23

BMD 6/21/23 Checked

AHS 6/21/23 In Charge of AG 6/21/23

Designed

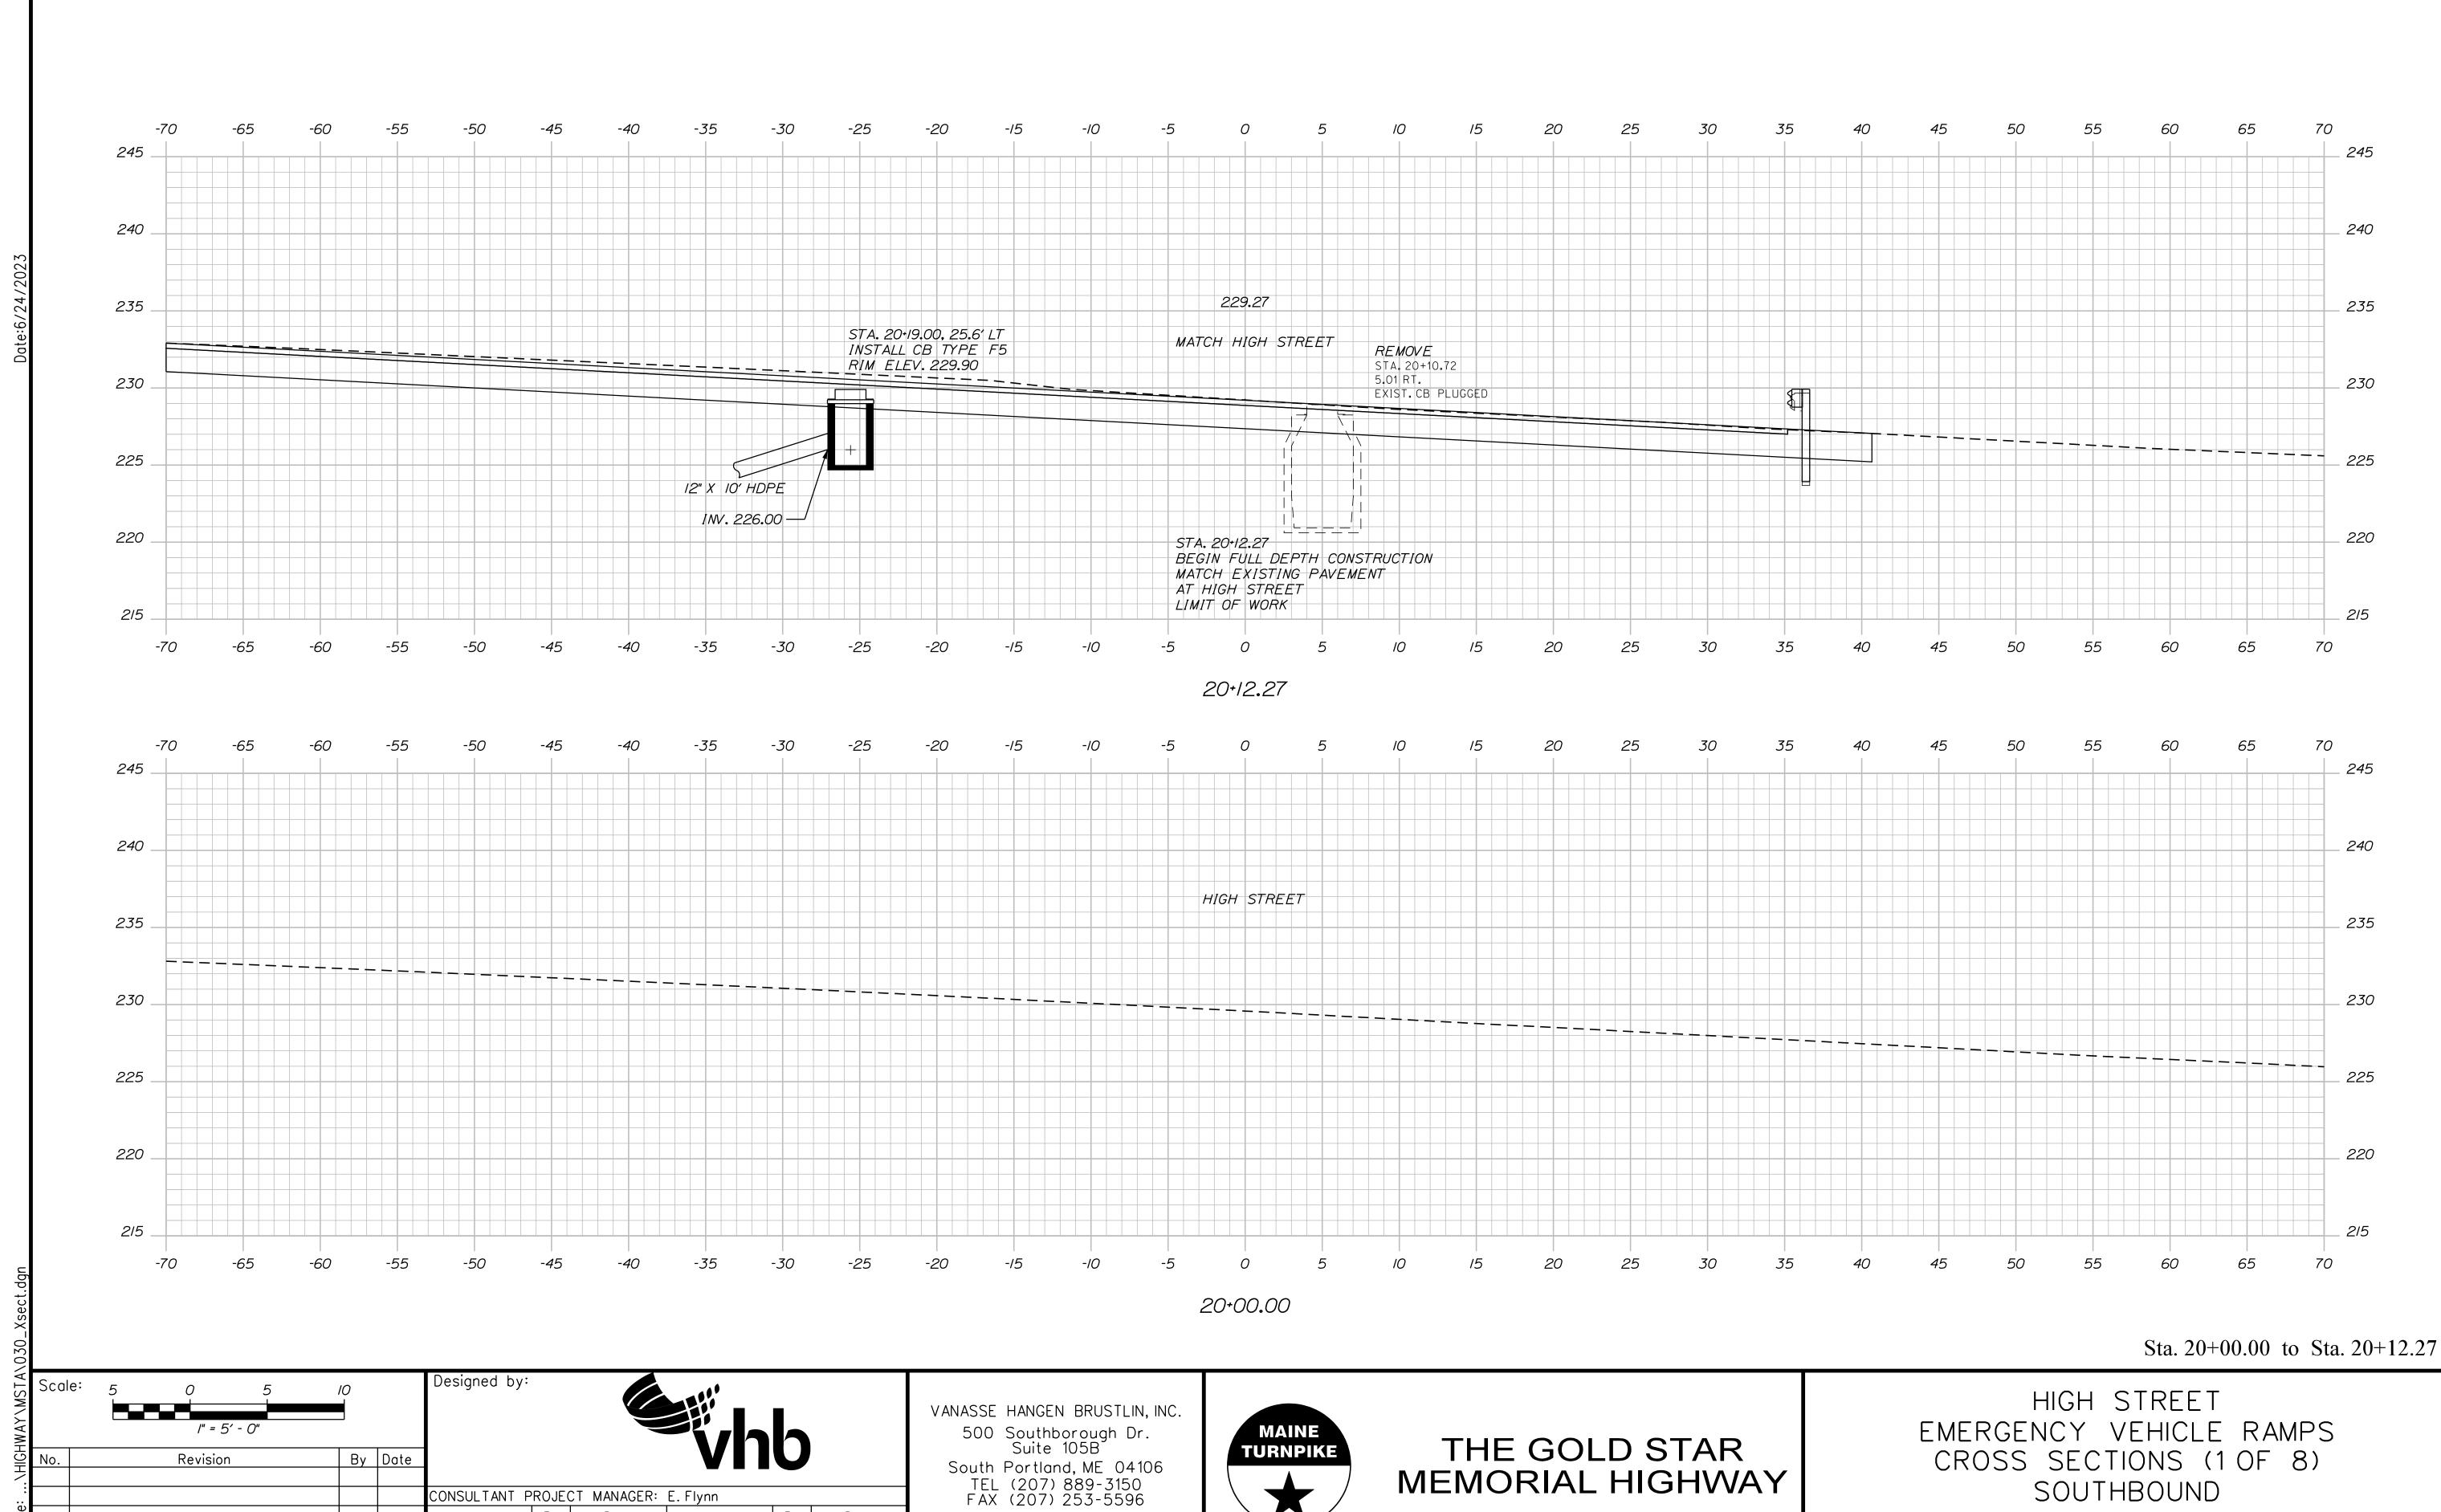

By Date ECF 6/21/23

BMD 6/21/23 Checked


AHS 6/21/23 In Charge of AG 6/21/23

Designed

MTA PROJECT MANAGER: Ryan Barnes, PE

SOUTHBOUND

SHEET NUMBER: SB-XS-1 VHB: 55639.00 CONTRACT: 2023.04 24 OF 31

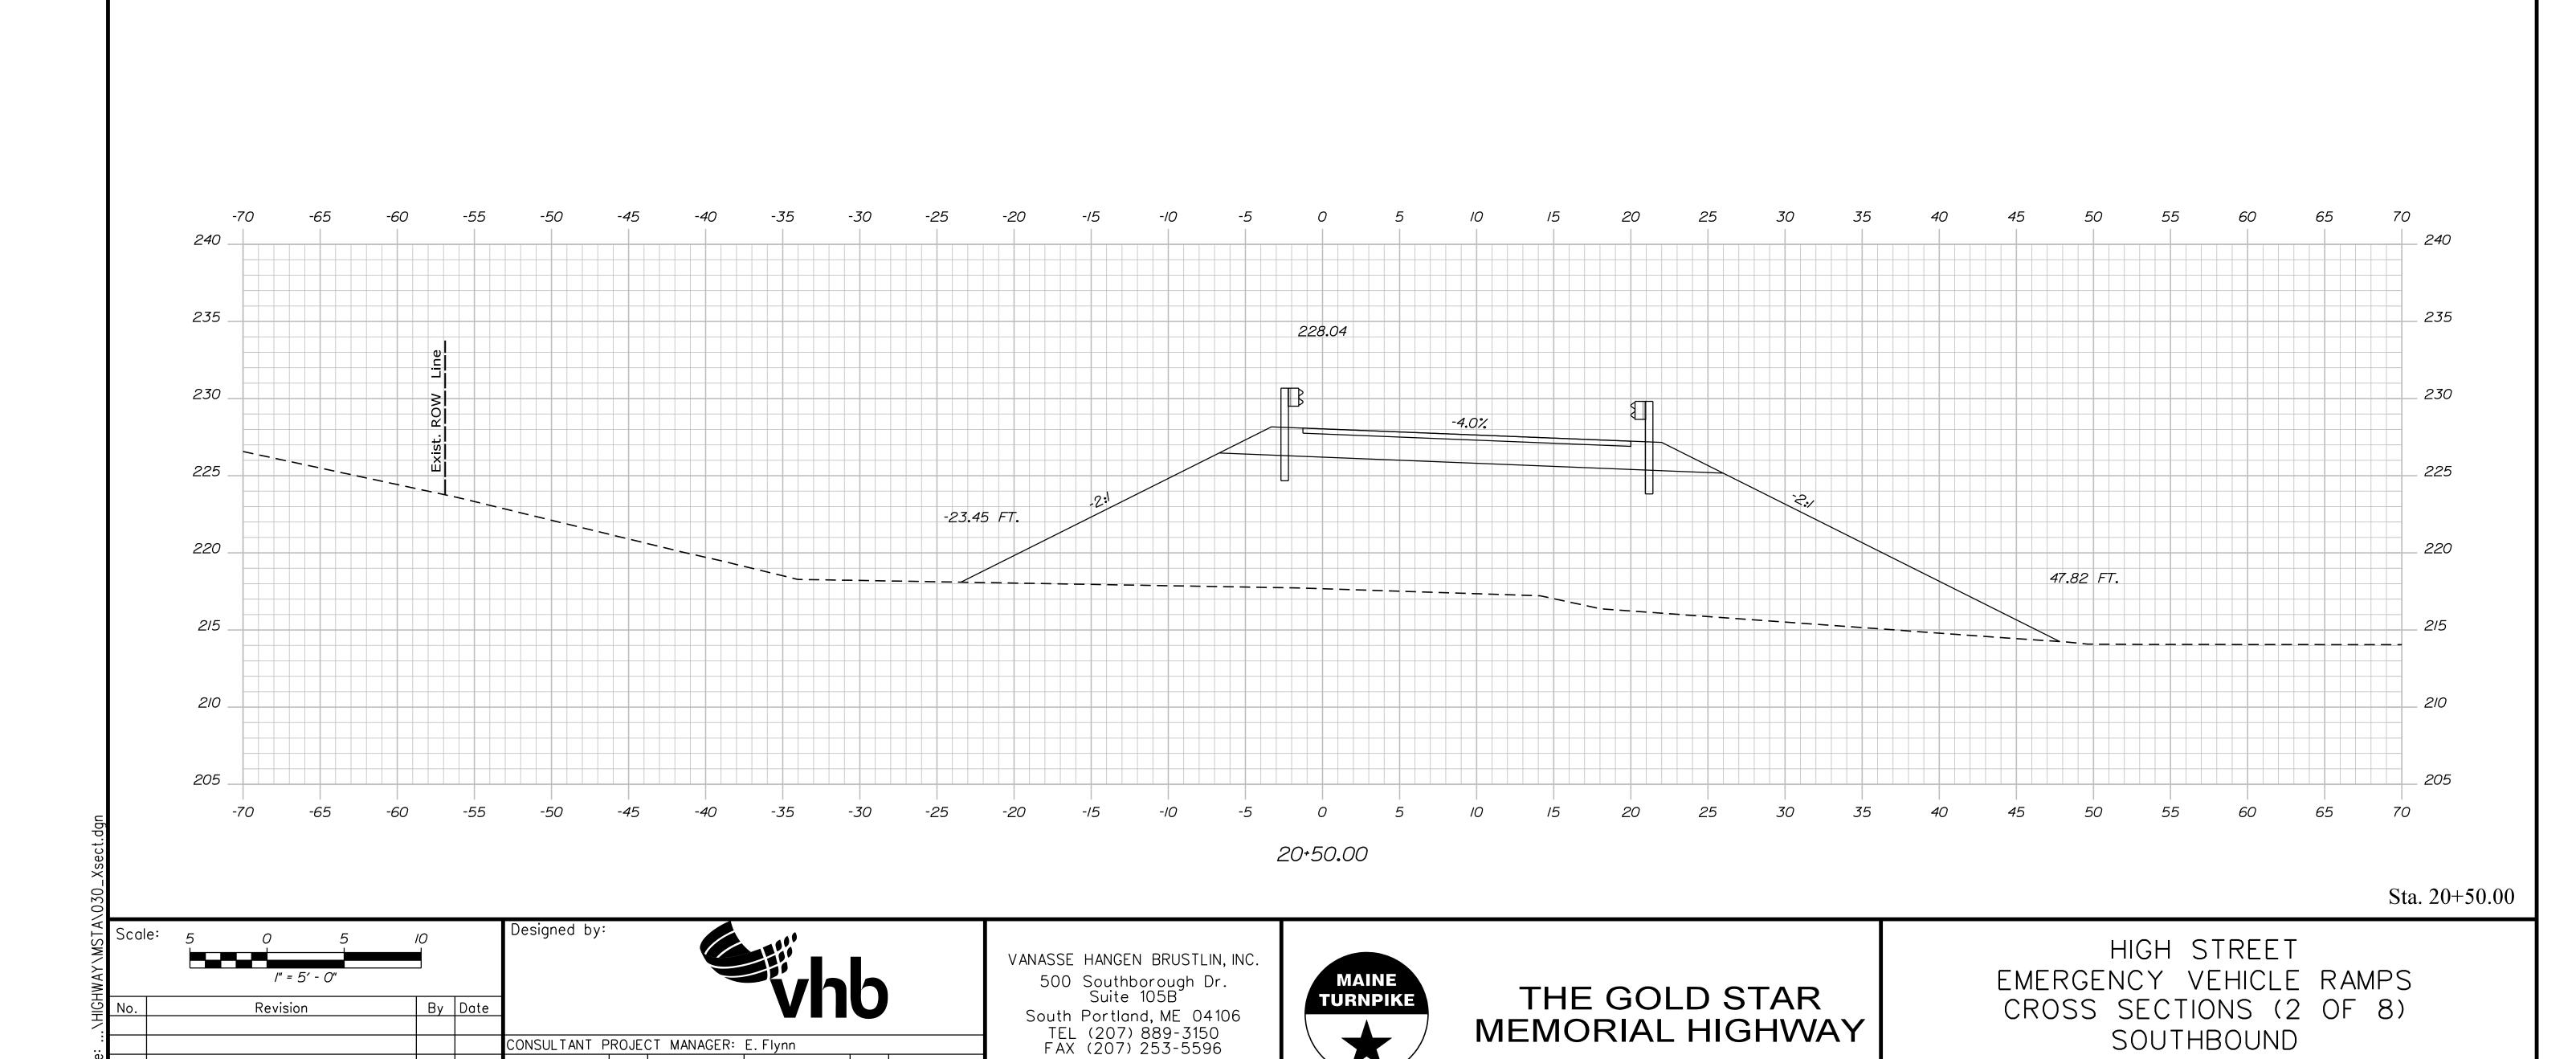

South Portland, ME 04106 TEL (207) 889-3150 FAX (207) 253-5596

By Date

Designed

CONSULTANT PROJECT MANAGER: E.Flynn

 By
 Date
 By
 Date

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 6/21/23
 Checked
 ECF
 6/21/23

 AHS
 6/21/23
 In Charge of
 AG
 6/21/23

Revision

THE GOLD STAR

MEMORIAL HIGHWAY


MTA PROJECT MANAGER: Ryan Barnes, PE

VHB: 55639.00

CONTRACT: 2023.04

SHEET NUMBER: SB-XS-2

25 OF 31

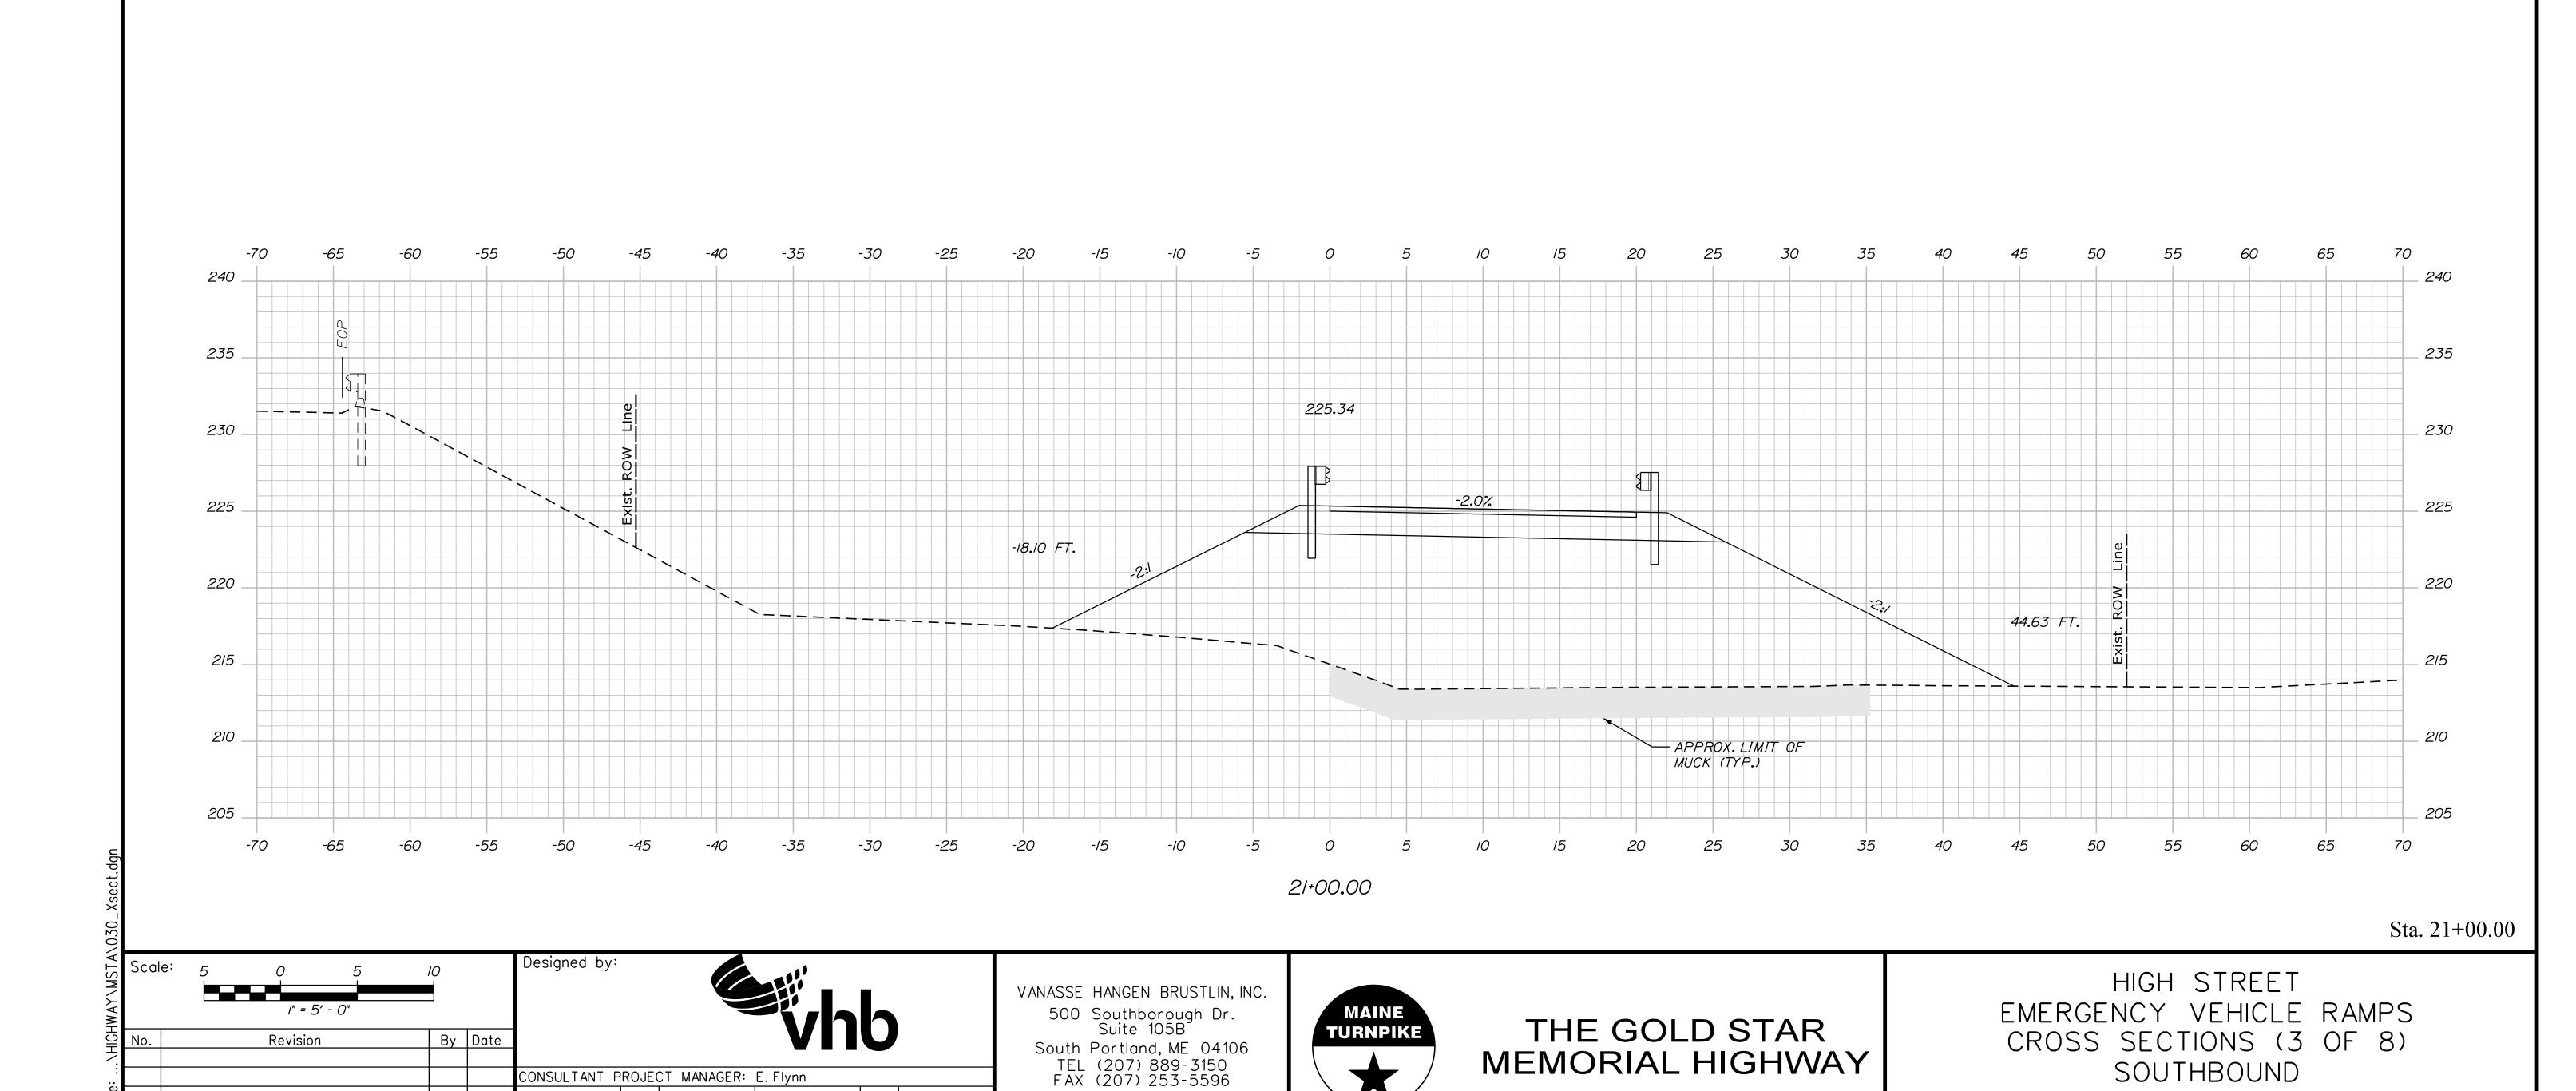

MEMORIAL HIGHWAY

MTA PROJECT MANAGER: Ryan Barnes, PE

VHB: 55639.00

CONTRACT: 2023.04

SHEET NUMBER: SB-XS-3

26 OF 31

South Portland, ME 04106 TEL (207) 889-3150 FAX (207) 253-5596

By Date

Designed

CONSULTANT PROJECT MANAGER: E.Flynn

 By
 Date
 By
 Date

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 6/21/23
 Checked
 ECF
 6/21/23

 AHS
 6/21/23
 In Charge of
 AG
 6/21/23

Revision

- CLEAN EXISTING INVERT INLET 225 -1.4% 220 \_ 220 -42.73 FT. 0.5% 215 -22.02 FT. ELEV. 213.61 40.06 FT. ELEV. 213.91 -28.93 FT. ELEV. 213.02 210 210 STA. 21+39.79, 21.93' LT TO STA. 21+34.37, 39.62' RT INSTALL 24" X 62' HDPE CULVERT (OPTION III)
RIPRAP INLET AND OUTLET APPROX. LIMIT OF -MUCK (TYP.) 205 205 *2*5 21+37.88 (SKEWED) Sta. 21+37.88

AHS 6/21/23 In Charge of AG 6/21/23


VANASSE HANGEN BRUSTLIN, INC.
500 Southborough Dr.
Suite 105B
South Portland, ME 04106
TEL (207) 889-3150
FAX (207) 253-5596

MAINE
TURNPIKE

## THE GOLD STAR MEMORIAL HIGHWAY

HIGH STREET
EMERGENCY VEHICLE RAMPS
CROSS SECTIONS (4 OF 8)
SOUTHBOUND

VHB: 55639.00 SHEET NUMBER: SB-XS-4 CONTRACT: 2023.04 27 OF 31

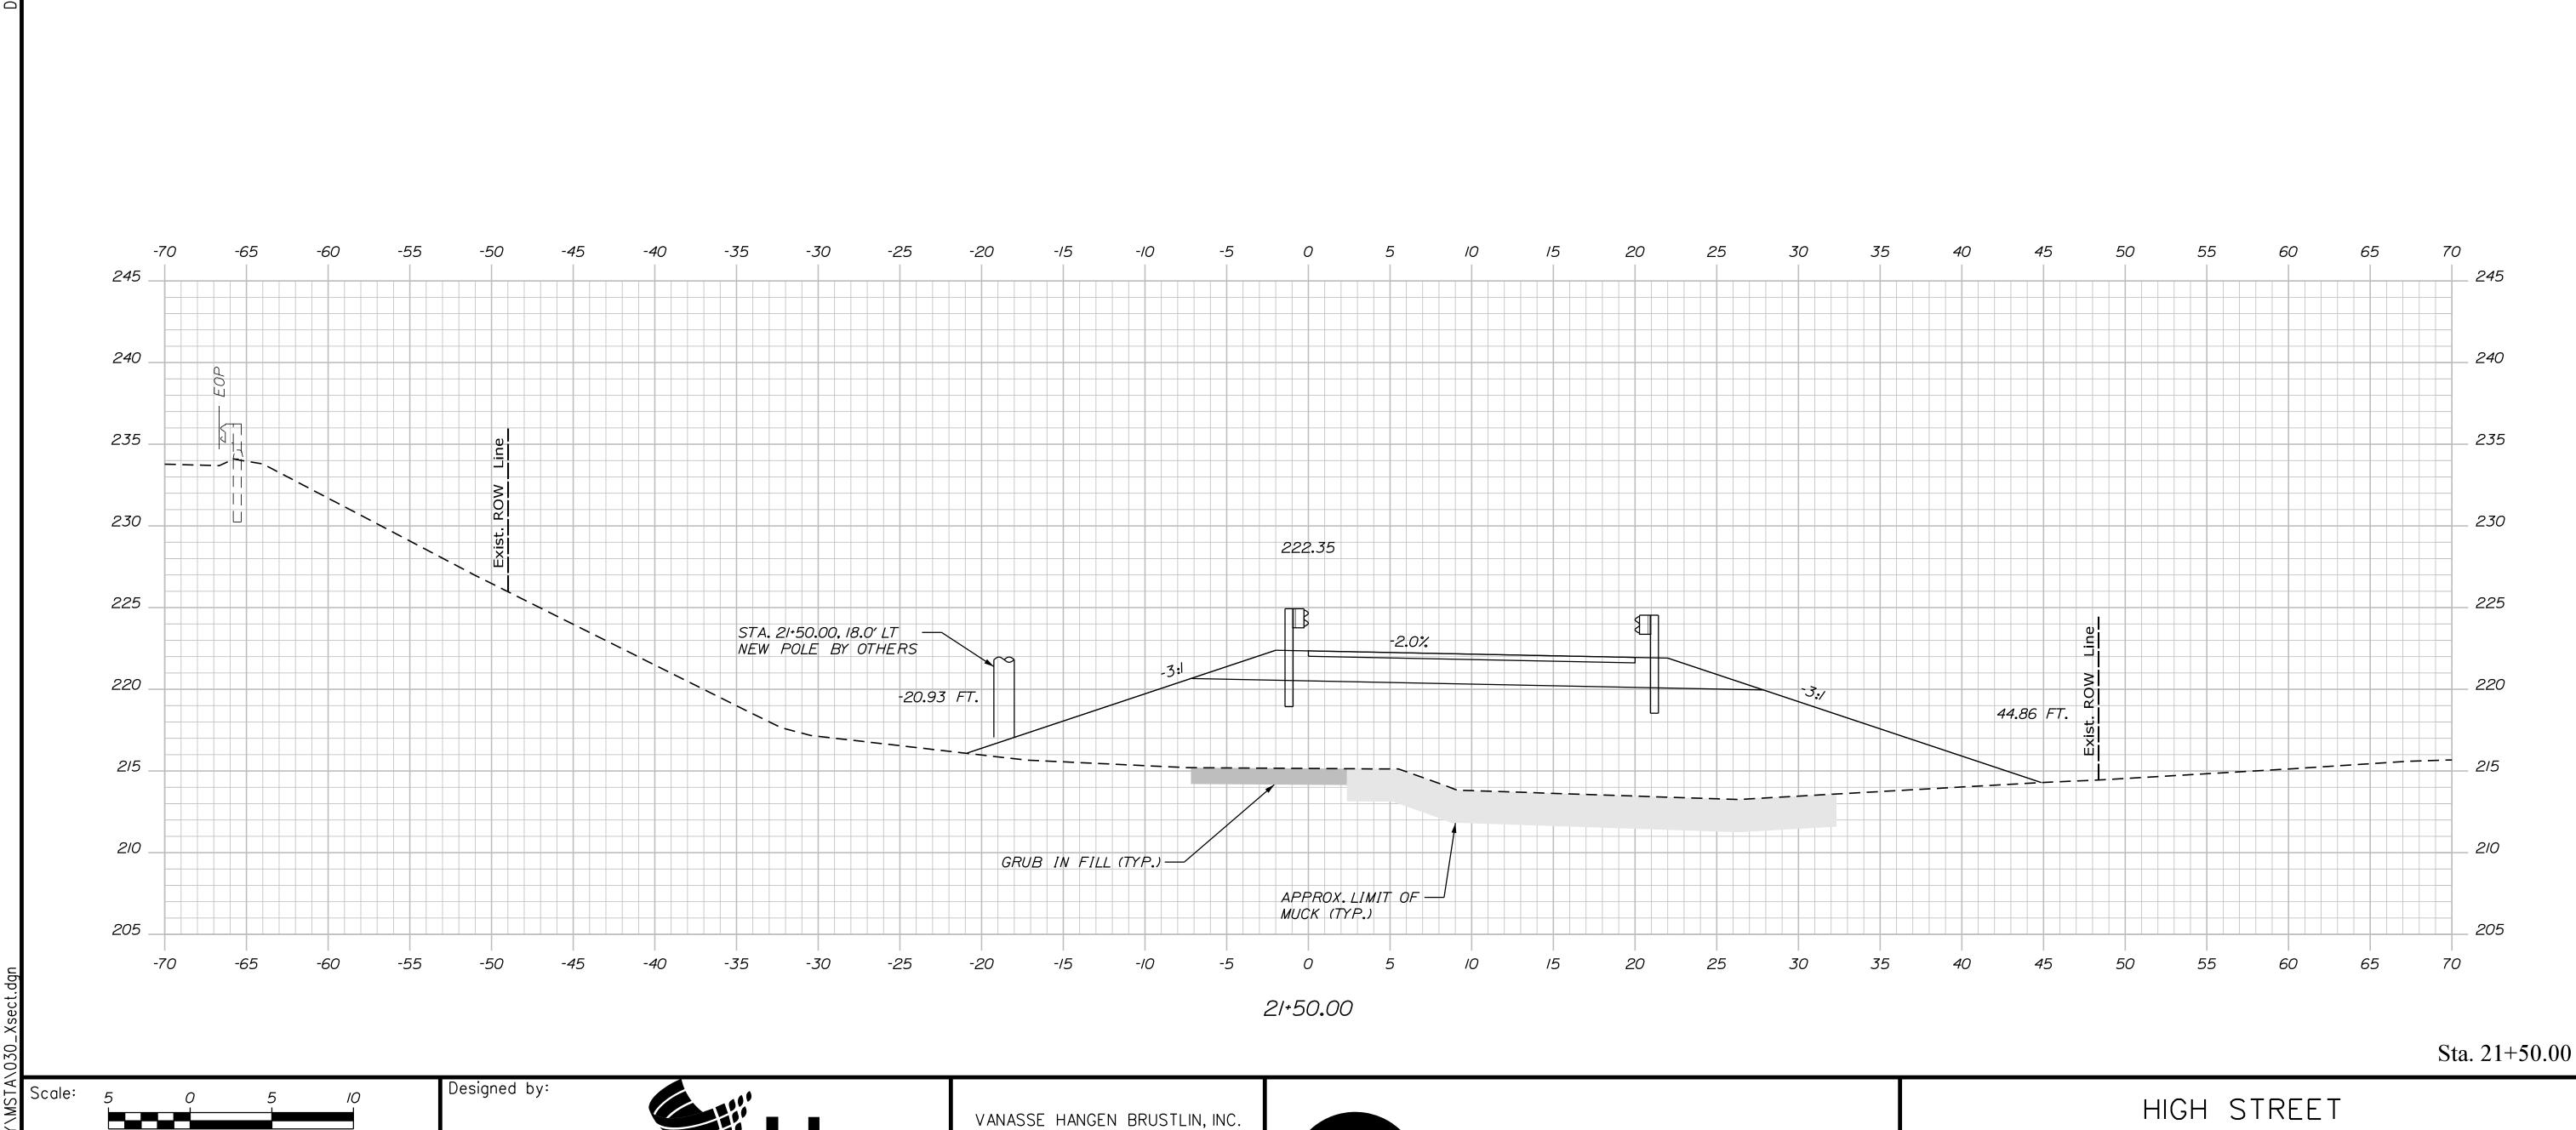


VANASSE HANGEN BRUSTLIN, INC 500 Southborough Dr. Suite 105B South Portland, ME 04106 TEL (207) 889-3150 FAX (207) 253-5596

MAINE
TURNPIKE

## THE GOLD STAR MEMORIAL HIGHWAY

EMERGENCY VEHICLE RAMPS CROSS SECTIONS (5 OF 8) SOUTHBOUND

VHB: 55639.00 SHEET NUMBER: SB-XS-5 CONTRACT: 2023.04 28 OF 31

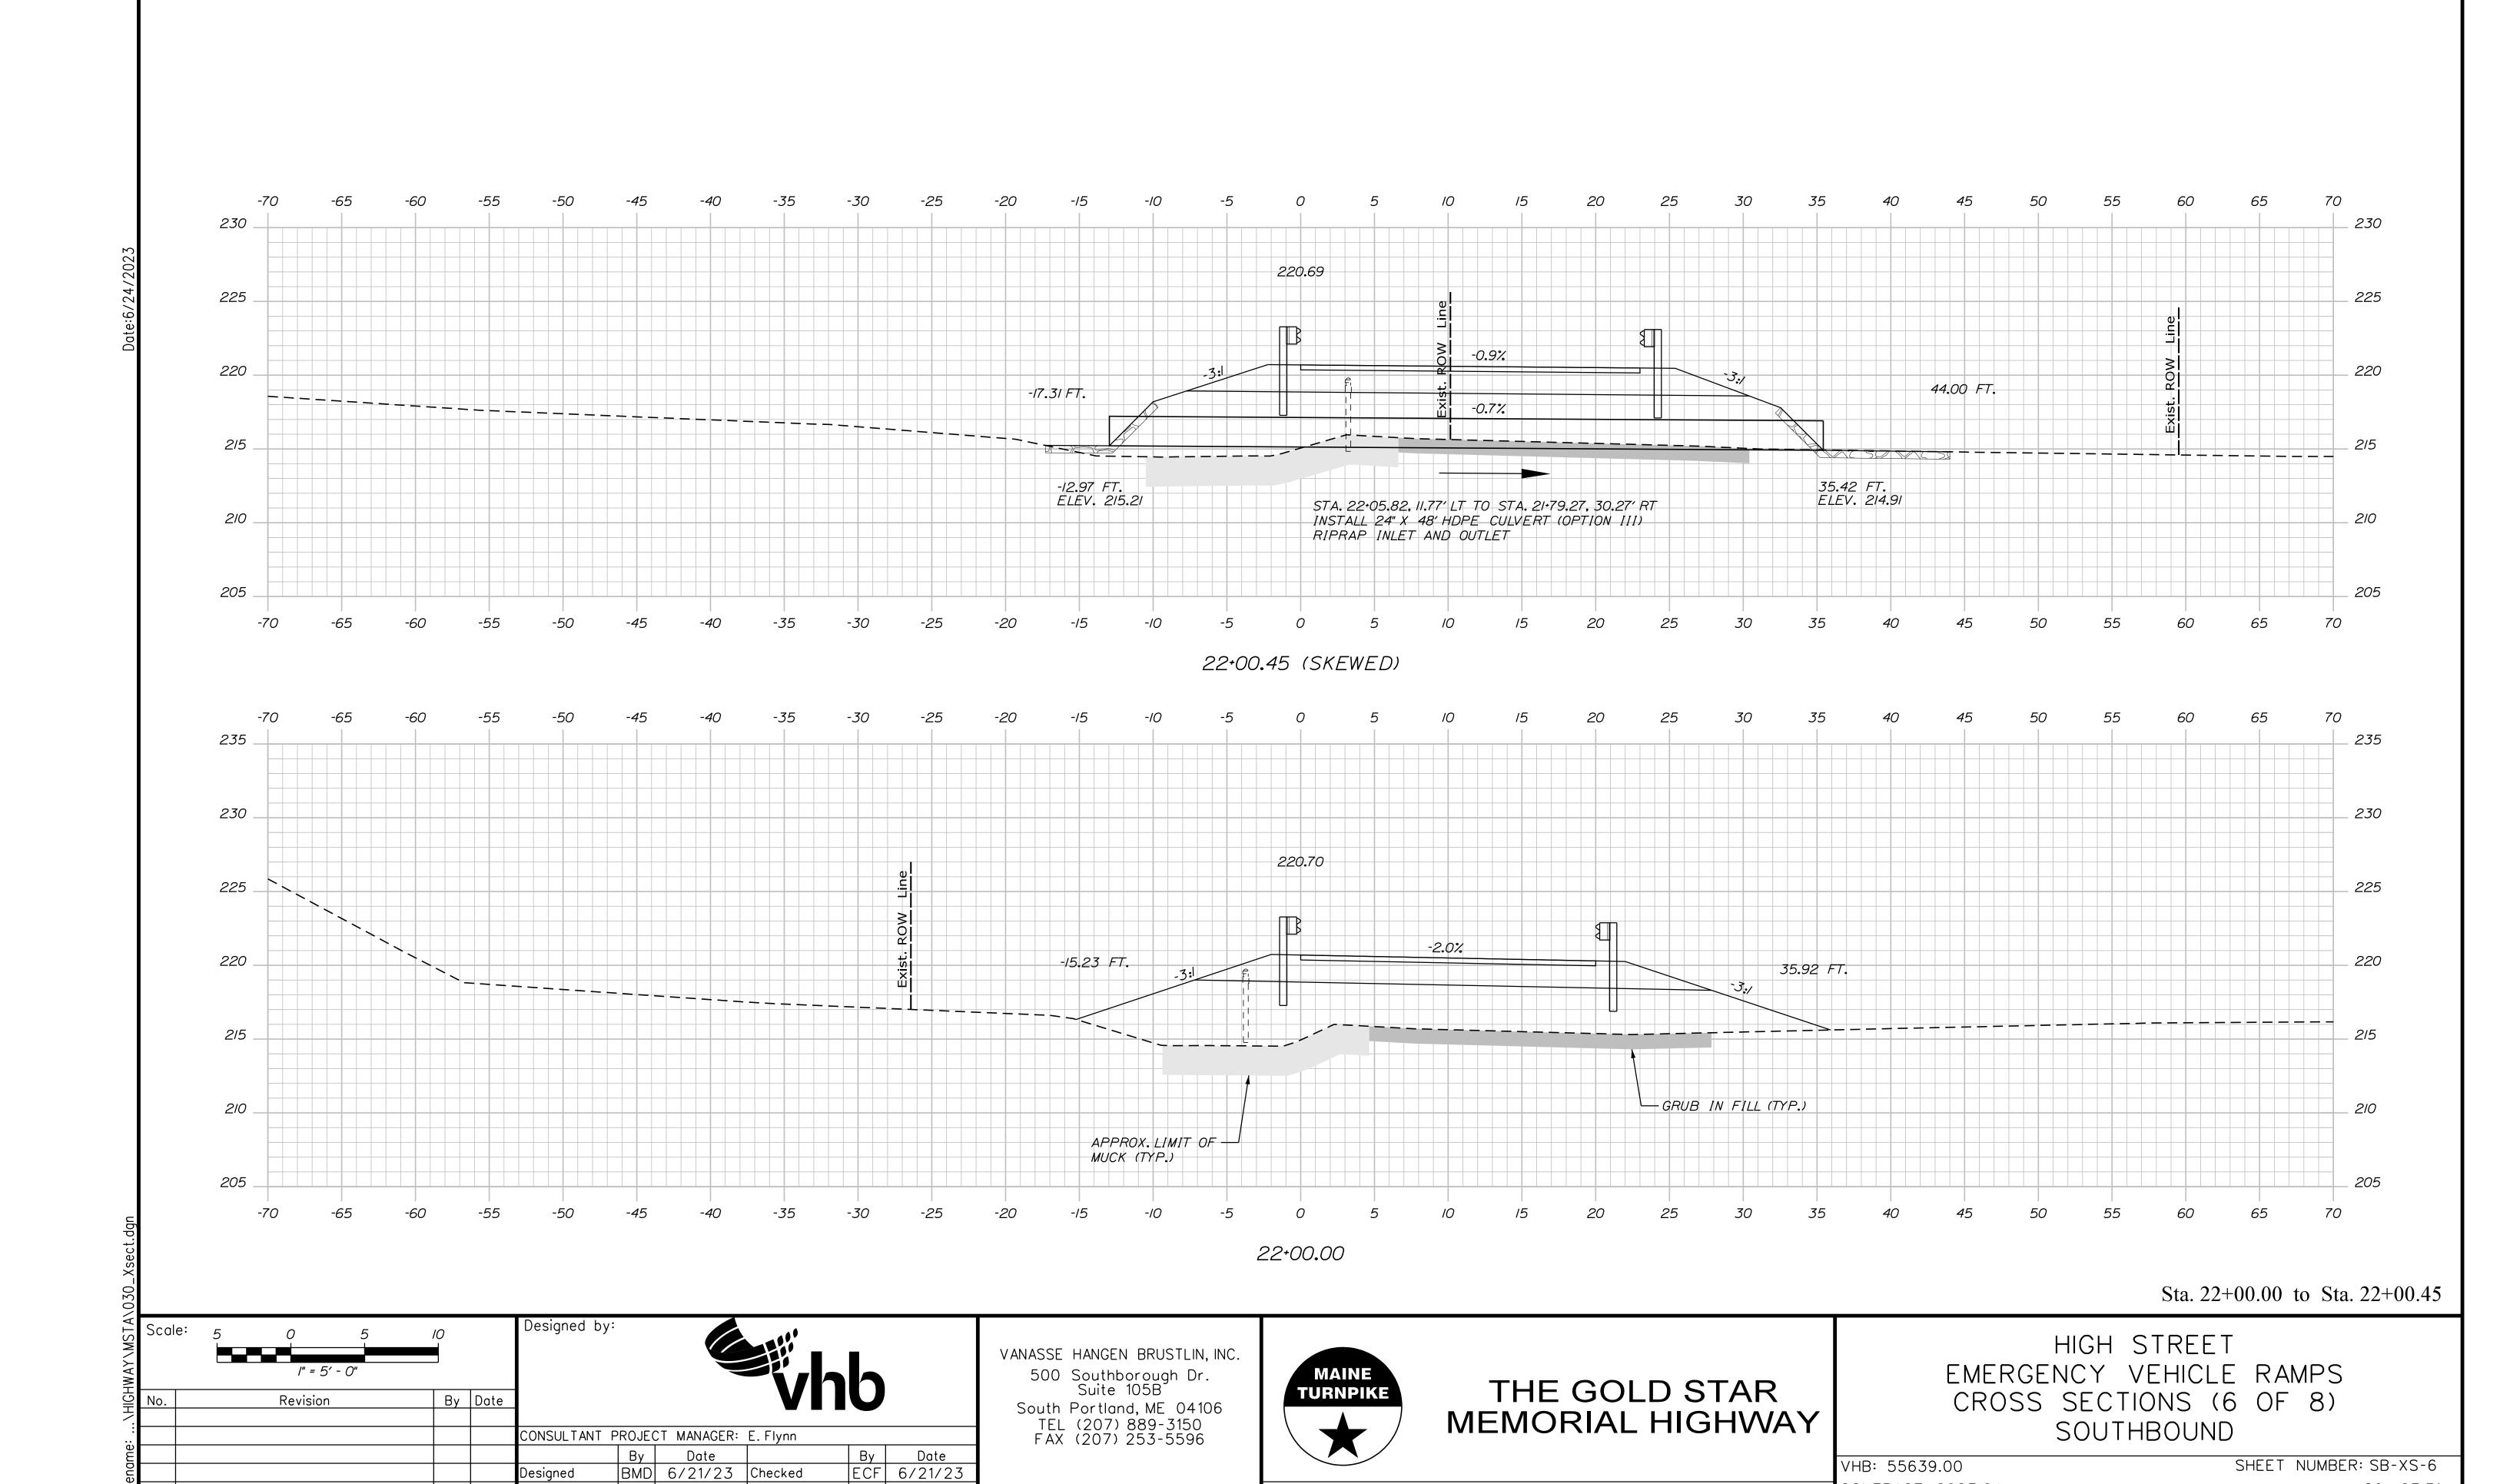


MTA PROJECT MANAGER: Ryan Barnes, PE

AHS 6/21/23 In Charge of AG 6/21/23

29 OF 31

CONTRACT: 2023.04

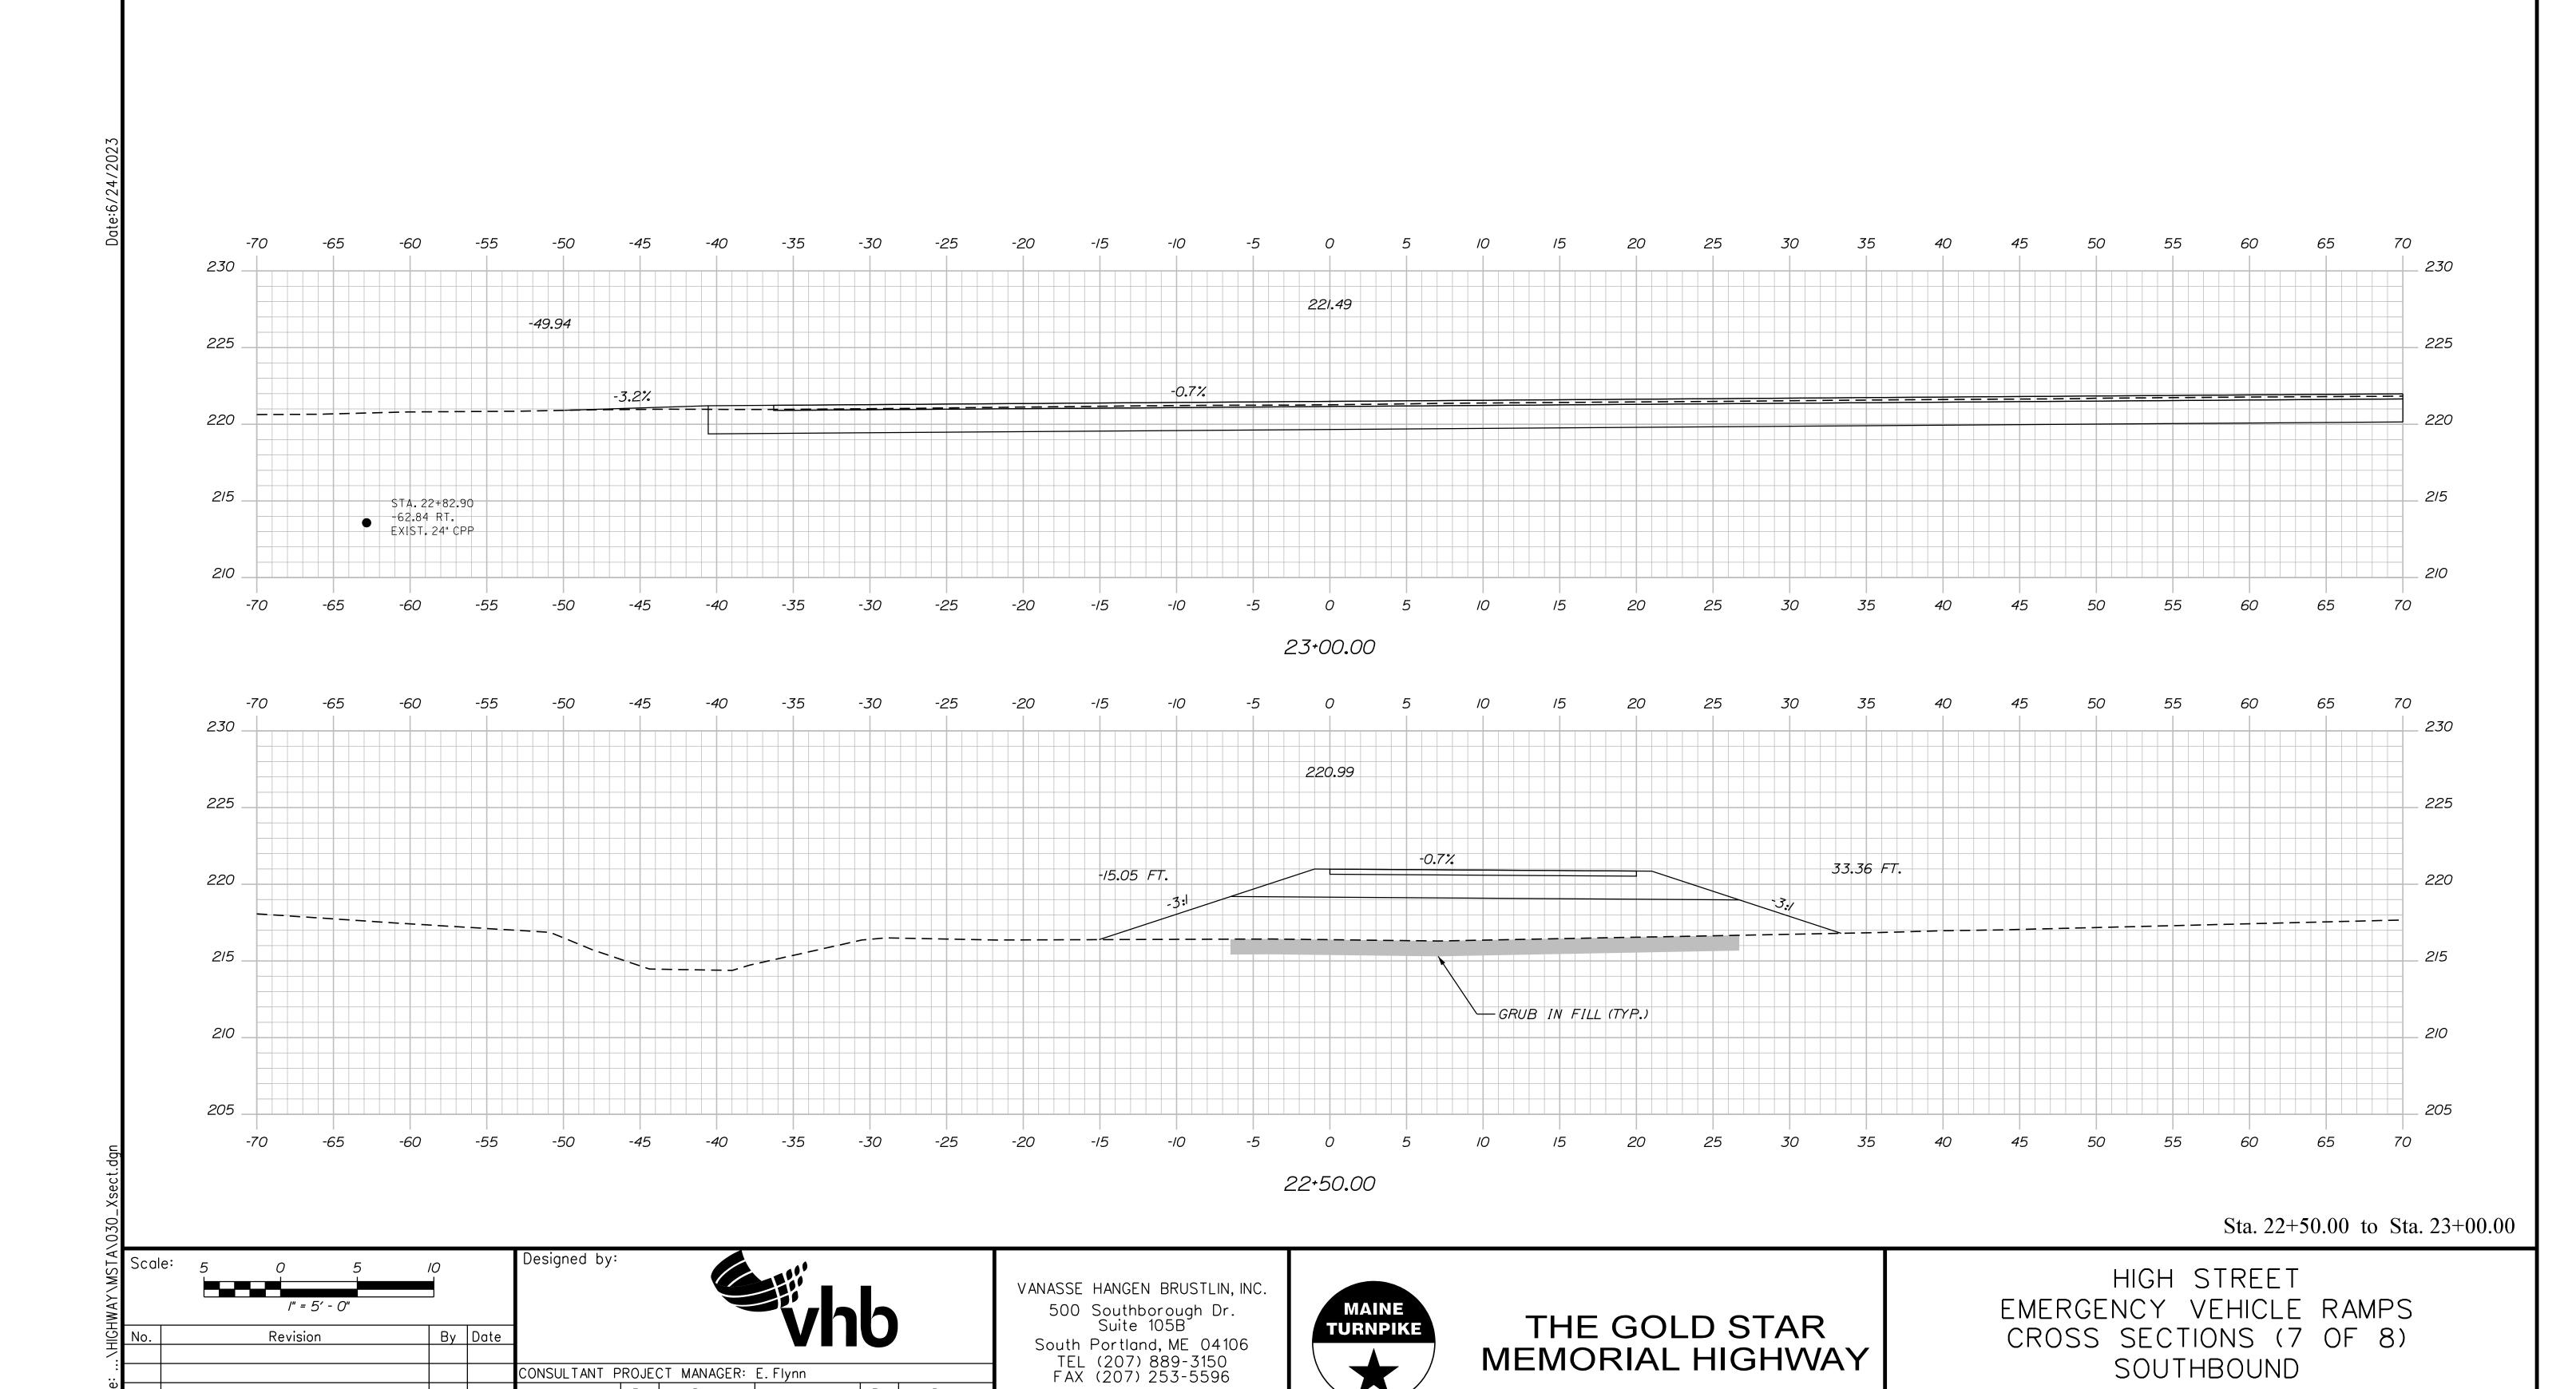

MTA PROJECT MANAGER: Ryan Barnes, PE

SHEET NUMBER: SB-XS-7

30 <u>OF 31</u>

VHB: 55639.00

CONTRACT: 2023.04

 By
 Date
 By
 Date

 BMD
 6/21/23
 Checked
 ECF
 6/21/23

 AHS
 6/21/23
 In Charge of
 AG
 6/21/23

Designed

221.51 MATCH MAINE TURNPIKE SOUTHBOUND 225 \_ 225 220 STA. 22+82.90 -62.84 RT. EXIST. 24" CPP STA. 23+01.75 END FULL DEPTH CONSTRUCTION 215 215 MATCH EXISTING PAVEMENT
AT MAINE TURNPIKE SOUTHBOUND
LIMIT OF WORK 210 -25 25 65 70 *23+01.*75 Sta. 23+01.75 Designed by: HIGH STREET VANASSE HANGEN BRUSTLIN, INC.

Revision

By Date

Designed

CONSULTANT PROJECT MANAGER: E. Flynn

BMD 6/21/23 Checked

By Date ECF 6/21/23 AHS 6/21/23 In Charge of AG 6/21/23

500 Southborough Dr. Suite 105B South Portland, ME 04106 TEL (207) 889-3150 FAX (207) 253-5596



# THE GOLD STAR MEMORIAL HIGHWAY

EMERGENCY VEHICLE RAMPS CROSS SECTIONS (8 OF 8) SOUTHBOUND

VHB: 55639.00 CONTRACT: 2023.04 SHEET NUMBER: SB-XS-8 31 OF 31