**INDEX OF SHEETS** 

Concrete Repair Typical Details

Maintenance of Traffic Details (4 Sheets)

Structure 1 Beech Ridge Road Underpass

Structure 2 New County Road Underpass

Temporary Signal Plans (3 Sheets)

Structure 3 Route 9 / Middle Road Underpass


**Estimated Quantities** 

Traffic Control Plan

**Bridge Typical Section** 

Bridge Plan and Elevation

**Bridge Sections** Traffic Control Plan

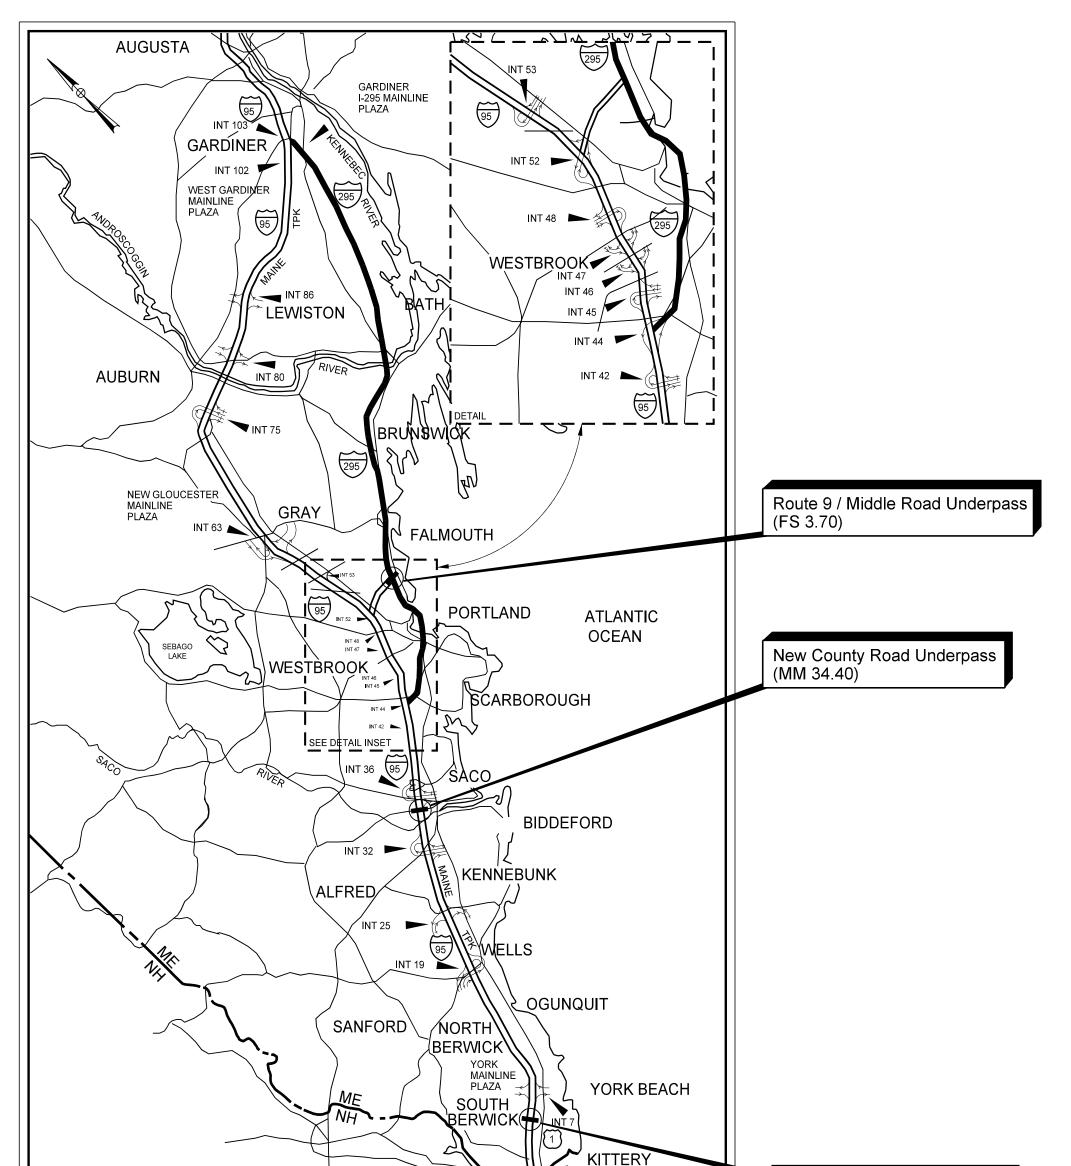



# MAINE TURNPIKE AUTHORITY

MICHAEL J. CIANCHETTE, CHAIR ANDREW MCLEAN, MEMBER JANE L. LINCOLN, MEMBER THOMAS J. ZUKE, MEMBER NINA FISHER, MEMBER BRUCE A. VAN NOTE, EX-OFFICIO MEMBER


PETER S. MERFELD, INTERIM EXECUTIVE DIRECTOR


**CONTRACT 2025.04** 

**BRIDGE REPAIRS** BEECH RIDGE ROAD UNDERPASS (MM 4.80) **NEW COUNTY ROAD UNDERPASS (MM 34.40)** ROUTE 9 / MIDDLE ROAD UNDERPASS (FS 3.70)





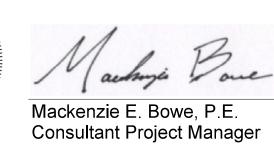

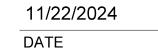

APPROVED: MAINE TURNPIKE AUTHORITY

PETER S. MERFELD, P.E. - CHIEF OPERATIONS OFFICER, INTERIM EXECUTIVE DIRECTOR

**LOCATION MAP** 

STEPHEN R. TARTRE, P.E., - DIRECTOR OF ENGINEERING

Beech Ridge Road Underpass (MM 4.80)

MACKENZIE E. BOWE No. 13757

ITEM NO.

202.1211 Removing Existing Girder Haunches

403.208 Hot Mix Asphalt, 12.5 mm Nominal Maximum Size

403.210 Hot Mix Asphalt, 9.5 mm Nominal Maximum Size

409.15 Bituminous Tack Coat RS-I or RSIh - Applied

5/5.202 Clear Protective Coating for Concrete Surfaces

520.234 Expansion Device - Silicone Coated and Pre-compressed Seal

526.306 Temporary Concrete Barrier, Type I - Supplied by the Authority (New County Road)

5/5.203 Broadcast Sealant for Concrete Surfaces

518.864 Elastomeric Concrete Header Repair

527.341 Work Zone Crash Cushion - TL-3

606.265 Terminal End-Single Rail - Galvanized Steel

627.78 Temporary Pavement Marking Line, White or Yellow

652.361 Maintenance of Traffic Control Devices (Beech Ridge Road)

652.36I Maintenance of Traffic Control Devices (New County Road)

652.361 Maintenance of Traffic Control Devices (Middle Road)

656.75 Temporary Soil Erosion and Water Pollution Control

627.712 White or Yellow Pavement Marking Line

627.77 Removing Existing Pavement Marking

652.41 Portable Changeable Message Sign

830.17 Utility Conduit Hanger System Hardware

652.45 Truck Mounted Attenuator

Mobilization

202.202 Removing Pavement Surface

502.70II Weep Drain Extensions

518.865 Concrete Header Repair

643.72 Temporary Traffic Signal

652.30 Flashing Arrow Board

652.312 Type III Barricade

652.35 Construction Signs

652.33 Drum

652.34 Cone

652.38 Flaggers

659.10

518.48 Reseal Joints

520.40 Joint Seal Repair

520.98 Joint Weld Repair

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Scale	: AS NOTED			Designed b	y:		•		
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No.	Revision	Ву	Date	-					
				CONSULTANT	PROJE(	CT MANAGER:	M. Bowe		
					Ву	Date		Ву	D
				Designed	HMR	11/22/24	Checked	HNH	11/2
				Designed					

ESTIMATED QUANTITIES

DESCRIPTION

UNIT

SY

TON

TON

GAL

EΑ

SY

LF CF

CF

EΑ

EΑ

ΕA

SF

LF

LS

ΕA

EΑ

EΑ

ΕA

LS

LS

LS

HR

EΑ CD

LS

LS

LS

Underpass (MM 4.80)

110

*820* 

175

VANASSE HANGEN BRUSTLIN, INC. 500 Southborough Dr. Suite 105B South Portland, ME 04106

Beech Ridge Rd New County Rd Rt 9 / Middle Rd Quantity

Underpass

(MM 34.40)1,250

1,025

760

700

46

75

1,130

350

40

4

136

25

1,338

80

Underpass (FS 3.70)

200

675

33

29

126

160

Total .

1**,**250

1**,**145

85

9

1,070

*820* 

1**,**375

71

4

75

2

1,900

350

40

191

1**,**545

415

20

1

46

TEL (207) 889-3150 FAX (207) 253-5596



MTA PROJECT NO. 2025.04 BRIDGE REPAIRS ESTIMATED QUANTITIES

VHB:55807.00 SHEET NUMBER: 2 OF 22 CONTRACT:2025.04

MTA PROJECT MANAGER: Kristi Van Ooyen, PE

#### <u>SPECIFICATIONS</u>

Design: AASHTO LRFD Bridge Design Specifications, 2020.

Construction: State of Maine Department of Transportation Standard Specifications, 2014 Edition, with all revisions thereto.

State of Maine Department of Transportation Standard Details for Highways and Bridges, 2020 Edition, with all revisions thereto.

AASHTO LRFD Bridge Construction Specifications, Fourth Edition

#### NEW MATERIALS

Concrete (Unless noted otherwise)
Structural Steel: All Material (except as noted) ASTM A709/A709M, Grade 36 High Strength Bolts (except as noted) ASTM A325, Type I
BASIC DESIGN STRESSES (NEW MATERIALS)
Concrete f'c = 4,500 psi
Reinforcing Steel fy = 60,000 psi
Structural Steel:  ASTM A 709/A 709M, Grade 36
TRAFFIC AND DESIGN LOADING DATA
BEECH RIDGE ROAD UNDERPASS

### NEW COUNTY ROAD UNDERPASS

DESIGN LIVE LOAD (for existing components)	<i>Unknown</i>
AADT	
Design Speed (MPH) (for existing)	<i>30</i>
Functional Class	Major Collector

#### ROUTE 9 / MIDDLE ROAD UNDERPASS

DESIGN LIVE LOAD (for existing	components)
AADT	
Design Speed (MPH) (for existing)	
Functional Class	

#### GENERAL CONSTRUCTION NOTES


- I. All details shall be in conformance with Maine Department of Transportation (MaineDOT) 2020 Standard Details for Highways and Bridges with all updates and MaineDOT Best Management Practices for Erosion and Sediment Control, latest revision unless otherwise noted in these plans.
- 2. All work must be completed within the limits shown in these Plans.
- 3. The Contractor shall submit proposed staging area(s) and field trailer location to the Resident for approval prior to starting work.
- 4. Any portions of the existing bridges removed by the Contractor shall become the property of the Contractor. The steel portions of the existing bridges may be coated with a lead-based paint system. The Contractor is responsible for the containment, proper management and disposal of all lead-contaminated hazardous waste generated by the work of this project.
- 5. Copies of the As-Built plans are posted on the Maine Turnpike Authority website at www.maineturnpike.com/projects/construction-contracts. The completeness and accuracy of these plans is not guaranteed.
- 6. Chamfer all exposed new concrete edges  $\frac{3}{4}$ " unless otherwise noted.
- 7. For all structures clear protective coating for concrete surfaces shall be applied to the following areas:
  - All bridge curbs, parapets, and transition barriers as shown in these plans.
     For the New County Road Underpass, all exposed faces of the substructure abutments and pier.
- 8. The Contractor shall place approach pavement at all locations to achieve a smooth transition between existing and proposed pavement.
- 9. Prior to the removal of any pavement, the Contractor shall document the location, type, and color of all pavement striping and provide that information to the Resident. The Maine Turnpike Authority will place all new striping at no cost to the Contractor.

#### EROSION CONTROL NOTE

I. All temporary and permanent erosion control devices shall be installed in accordance with the Maine Department of Transportation Best Management Practices.

#### UTILITIES NOTES

- I. Existing utilities on these plans were compiled from existing plans and various other sources. Locations are not guaranteed to be accurate nor is it guaranteed that all utilities are shown. No separate or additional compensation will be allowed to the Contractor due to any variance between the data shown on the plans and the actual field conditions encountered. No work shall be started until the owners of the various utilities are notified by the Contractor of the proposed construction. The Contractor is also required to call Dig Safe at I-888-344-7233 at least 72 hours prior to the start of the work.
- 2. The Contractor shall contact all non-members through www.OKtoDiG.com or as otherwise required by the Maine Public Utilities Commission. All proposed excavation locations shall be marked at the time of notification. No excavation shall be permitted until the authority has located and marked it's underground utilities. The Resident shall be provided an electronic copy of all Dig Safe tickets within 24 hours of their release for project notifications and 3rd party utility locater coordination.
- 3. The Contractor shall notify the Resident IO calendar days prior to submitting a utility locate request through Dig Safe so that the Resident can arrange for Maine Turnpike underground utility location. All proposed sign locations and excavation locations shall be marked at the notification time.
- 4. Contractor shall protect all new and existing utilities from damage during the construction as approved by the utility owners.
- 5. Following the completion of the initial utility locate the Contractor will GPS locate all utilities within the project limits and provide a copy of the Dig Safe records to the Authority. the Contractor, acting as the Authority's third party locator shall be responsible for remarking all Maine Turnpike facilities when a Dig Safe utility locate is call for in the project. This work shall be considered incidental to the contract.
- 6. The utilities involved in this contract are:
  Beech Ridge Road Underpass: Consolidated Communications, Inc. (CCI)
  New County Road Underpass: Central Maine Power (CMP), Spectrum, CCI
  Middle Road Underpass: CMP, CCI, Town of Falmouth (Sewer)

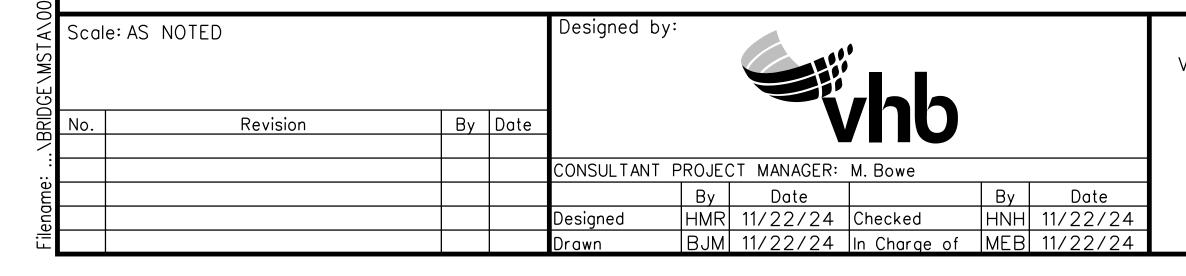

VANASSE HANGEN BRUSTLIN, INC.

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FAX (207) 253-5596



THE GOLD STAR MEMORIAL HIGHWAY

MTA PROJECT NO. 2025.04 BRIDGE REPAIRS GENERAL NOTES


VHB: 55807.00 SHEET

CONTRACT: 2025.04


MTA PROJECT MANAGER: Kristi Van Ooyen, PE

SHEET NUMBER: 3 OF 22

#### TYPICAL HORIZONTAL SURFACE CONCRETE REPAIR DETAILS

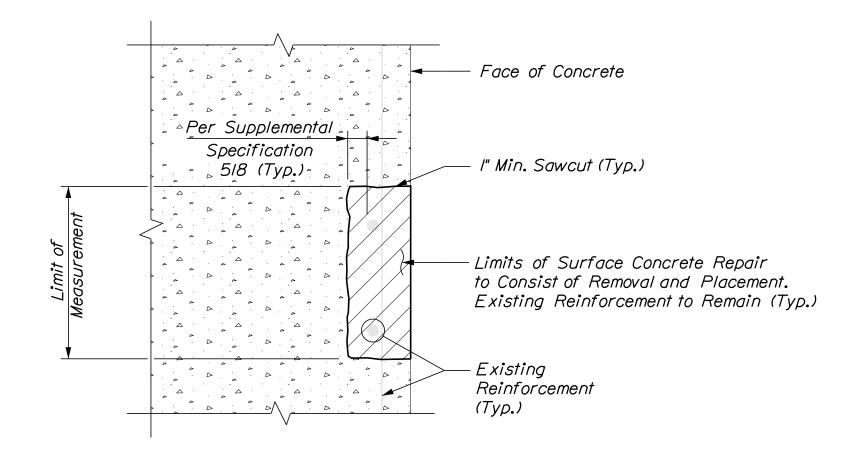


#### TYPICAL VERTICAL SURFACE CONCRETE REPAIR DETAILS

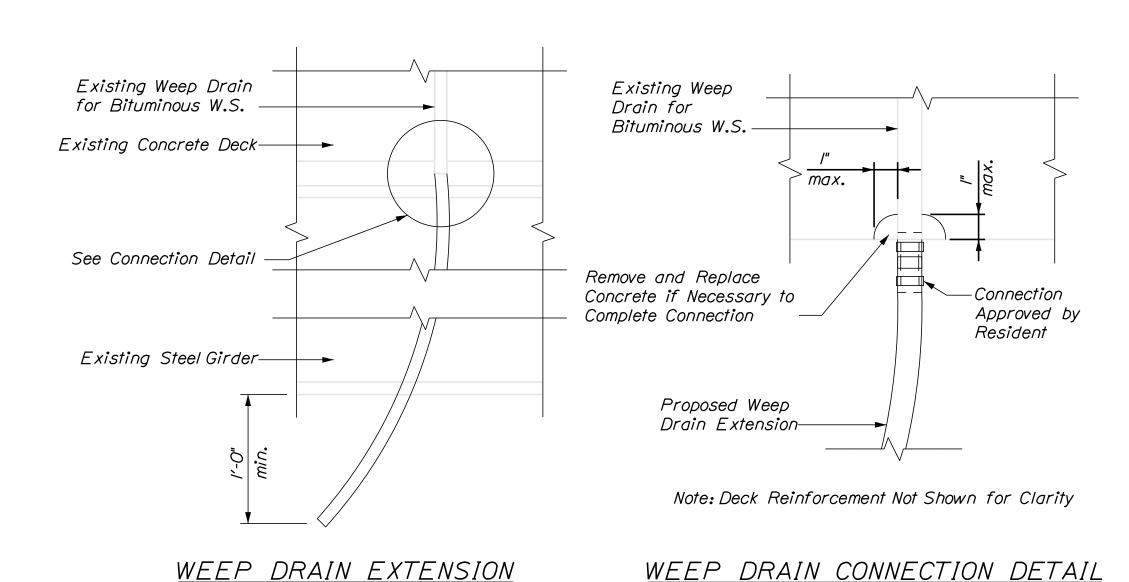


# Limit of Measurement - I" Min. Sawcut (Typ.) Existing - Limits of Full Depth Concrete Repair Reinforcement to Consist of Removal and Placement. Existing Reinforcement to Remain (Typ.) (Typ.) — - Face of Concrete

#### TYPICAL FULL DEPTH CONCRETE REPAIR DETAILS

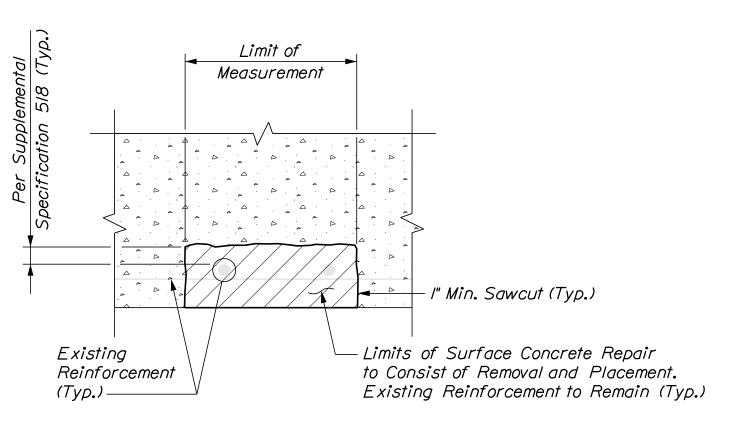

TYPICAL OVERHEAD SURFACE CONCRETE REPAIR DETAILS

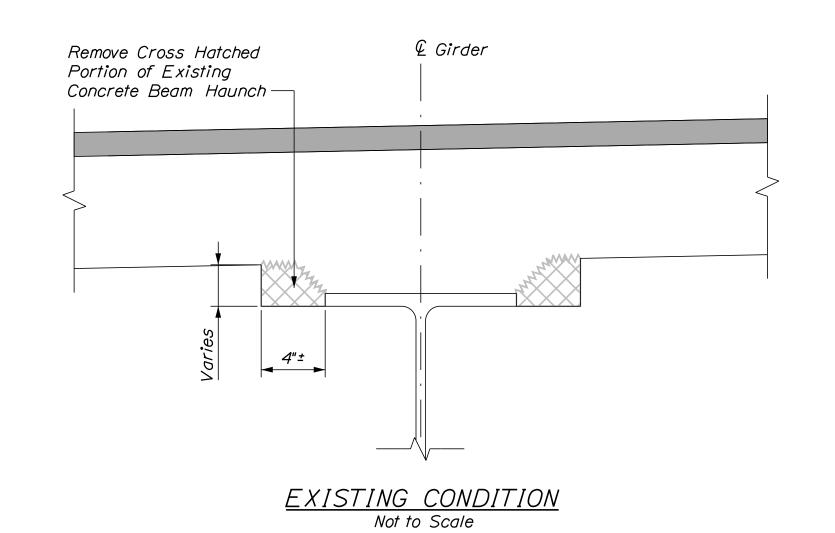

#### CONCRETE REPAIR NOTES

- I. Repair work shall include: surface concrete repairs, epoxy injection crack repair and providing access for inspection.
- 2. Where surface concrete repairs are specified the work shall include removal of unsound concrete and placement and curing of repair materials. Repairs shall be measured for payment under Item 518.10, Abutment Repairs.
- 3. Prior to the start of any concrete repairs the Resident and the Contractor shall sound all concrete surfaces and agree on the repair limits. Estimated repair quantities may increase or decrease at the Resident's discretion.
- 4. The estimated repair quantities are based on inspections completed in July and August 2024.

#### CONCRETE REPAIR PROCEDURE


- I. Perform I" deep saw cuts along limits of removal.
- 2. Chip concrete to the depth specified in Supplemental Specification 518. If the removal limits change during the demolition process the Contractor shall notify the Resident. The Resident and Contractor shall agree on the revised pay limits prior to the Contractor continuing the removal.
- 3. Prepare and patch repair areas with Class AAA modified concrete or other materials selected from the applicable non-emergency list of materials in Supplemental Specification 518.
- 4. Perform general finishing.

#### WEEP DRAIN EXTENSION NOTE

I. All PVC deck weeps which drain onto piers, abutments or structural steel shall be extended and diverted away from bridge components below deck, and shall extend I foot below bottom flange, as directed by the Resident. Payment shall be made under pay Item 502.7011, Weep Drain Extensions.

#### CONCRETE HAUNCH REMOVAL NOTES

- 1. The removal of the portion of the concrete haunch shown shall be paid for at the contract unit price per linear foot under Item 202.1211, Removing Existing Girder Haunches. The Haunch on each side of the girder shall be measured separately for payment.
- 2. If over-removal results, apply two coats of epoxy resin to deck reinforcing steel exposed during haunch removal. All reasonable precautions shall be taken to avoid this condition. Epoxy resin and application shall be incidental to Item 202,1211, Removing Existing Girder Haunches.
- 3. After concrete removal, the exposed concrete shall be sealed with clear protective coating. Clear protective coating and application shall be incidental to Item 202.1211, Removing Existing Girder Haunches.
- 4. Prior to the start of any concrete haunch removal, the Resident and Contractor shall jointly inspect all haunches for removal and agree on the removal limits. Estimated haunch removal quantities may increase or decrease at the Resident's discretion.

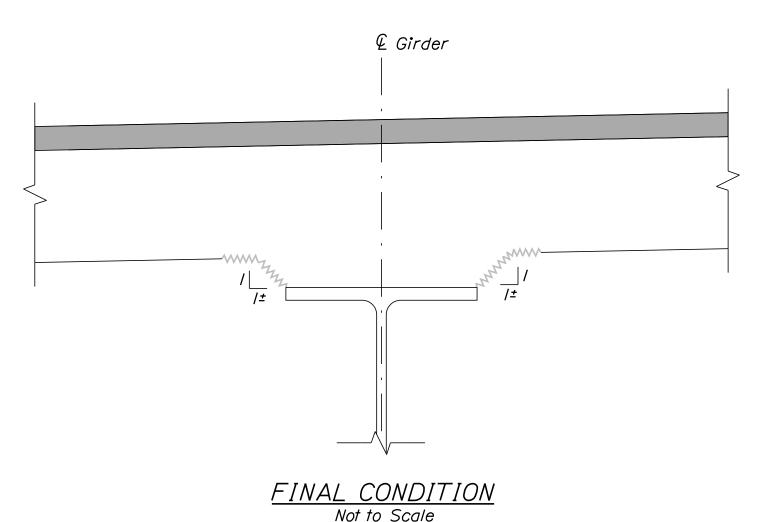

CONCRETE HAUNCH REMOVAL DETAILS

Designed by: Scale: NOT TO SCALE By Date Revision CONSULTANT PROJECT MANAGER: M. Bowe By Date |HNH| 11/22/24 |HMR| 11/22/24 |Checked Designed BJM 11/22/24 In Charge of MEB 11/22/24

Not to Scale

VANASSE HANGEN BRUSTLIN, INC. 500 Southborough Dr. Suite 105B South Portland, ME 04106 TEL (207) 889-3150

Not to Scale

**TURNPIKE** FAX (207) 253-5596

# THE GOLD STAR MEMORIAL HIGHWAY

MTA PROJECT NO. 2025.04 BRIDGE REPAIRS CONCRETE REPAIR TYPICAL DETAILS

SHEET NUMBER: VHB: 55807.00 CONTRACT:2025.04

MTA PROJECT MANAGER: Kristi Van Ooyen, PE

4 OF 22

#### MAINTENANCE OF TRAFFIC GENERAL NOTES

- I. These traffic control plans and details apply to all of the project sites included in this Project. Where typical traffic control layouts may be appropriate, the Contractor is directed to use a typical layout from this project's Maintenance of Traffic Details or from the Maine Turnpike Authority Traffic Control Plans located on the MTA website at www.maineturnpike.com/Projects/Construction-Related-Documents.aspx. Where site-specific traffic control plans are required, see the applicable traffic control plans within the Plans. See also the Special Provisions for more details on site specific temporary traffic controls with time and date restrictions.
- 2. All orange construction signs shall be fluorescent orange with Type VIII, IX or XI sheeting. Placement of signs shall be adjusted to avoid obstructing existing signs and to ensure proper sight lines to the construction signs as determined by the Resident and shall be new or in like new condition.
- 3. Temporary lane closures will be required, with advanced approval, whenever work will occur within four feet of the I-95 traveled way. Temporary lane closures shall be removed if no work is occurring. See Special Provisions for more information.
- 4. All lane closures shall require approval from the Maine Turnpike Authority through the Resident. The Resident is required to submit a request for lane closures by noon on Thursday for any lane closures needed for the following week. The Contractor shall plan the work and requests for lane closures accordingly.
- 5. Approach ends of temporary concrete barrier shall be placed outside of the highway clear zone (minimum 34 feet from the traveled way along I-95) or protected by temporary impact attenuators or with guardrail overlaps as approved by the Resident.
- 6. Maximum spacing for channelizing devices (drums) on the mainline of the Turnpike shall be: 80' on center along tangents
  40' on center along tapers
- 7. Work Zone Speed Limits shall only be permitted when temporary lane closures are in place.

#### STABILIZED CONSTRUCTION ENTRANCE

CON	STRUCT	ION SIC	ON SUMM	ARY
<u> </u>		mensions thes)	Size	
Sign	Letter Height			Quantity and Color
G20-2 END ROAD WORK	Shall C	mensions Conform andard way	48" x24"	I - Black on Orange
W7-3aP NEXT NEXT X MILES	Signs"	- 2012   	36"x30"	I - Black on Orange
W20-I (AHEAD)			48" x 48"	2 - Black on Orange
W21-5 SHOULDER WORK			48"x48"	I - Black on Orange
CS-10 TRUCKS ENTERING			48" x 48"	l - Black on Orange

#### ABBREVIATIONS FOR ALL WORK ZONE PLANS


BWLL = BROKEN WHITE LANE LINE SWEL = SOLID WHITE EDGE LINE SYEL = SOLID YELLOW EDGE LINE

Scale	NOT TO SCALE	Designed by:							
No.	Revision	Ву	Date			<b>V</b>	/NO		
				CONSULTANT F	PROJEC	CT MANAGER:	M. Bowe		
					Ву	Date		Ву	Date
				Designed	MLG	11/22/24	Checked	MDS	11/22/24
				Drawn	JAR	11/22/24	In Charge of	MEB	11/22/24

VANASSE HANGEN BRUSTLIN, INC.

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# THE GOLD STAR MEMORIAL HIGHWAY

MTA PROJECT NO. 2025.04 BRIDGE REPAIRS

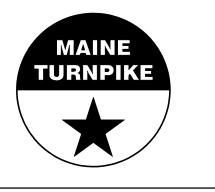MAINTENANCE OF TRAFFIC DETAILS (1 OF 4)

MTA PROJECT MANAGER: Kristi Van Ooyen, PE

 VHB: 55807.00
 SHEET NUMBER:
 5

 CONTRACT: 2025.04
 5 OF 22

### TURNPIKE SHOULDER CLOSURES

CON	STRUCT	ION SIC	GN SUMM	IARY
		nensions hes)		
Sign	Letter Height	Vertical Spacing	Size	Quantity and Color
G20-2 END ROAD WORK	Shall C	nensions Conform Indard way	48"x24"	4 - Black on Orange
W20-I (AHEAD)	Signs"	- 2012 	48" x 48"	4 - Black on Orange
W21-5aL LEFT SHOULDER CLOSED 1000 FT			48" x 48"	2 - Black on Orange
W21-5aR RIGHT SHOULDER CLOSED 1000 FT			48" x 48"	I - Black on Orange
W21-5bL LEFT SHOULDER CLOSED			48" x 48"	2 - Black on Orange
W21-5bR RIGHT SHOULDER CLOSED			48" x 48"	I - Black on Orange

### TEMPORARY SINGLE AND DOUBLE LANE CLOSURES

	CON	STRUCT	ION SIG	GN SUMN	IARY
_			mensions hes)		
Sign		Letter Height	Vertical Spacing	Size	Quantity and Color
CS-3	EXPECT STOPPED TRAFFIC	STOPPED \(\sigma\)		48" x 48"	4 - Black on Orange
G20-2	END ROAD WORK	Shall C	mensions Conform andard way	48"x24"	4 - Black on Orange
G20-5aP	WORK ZONE		- 2012	36"x24"	4 - Black on Orange
R2-I(60)	SPEED LIMIT 60			48"x60"	4 - Black on White
R2-6aP	FINES DOUBLE			36"x24"	4 - Black on White
W3-4	BE PREPARED TO STOP			48"x48"	4 - Black on Orange
W3-5(60)	SPEED LIMIT 60			48" x 48"	4 - Black on Orange
W4-2L				48" x 48"	8 - Black on Orange
W4-2R		,		48" x 48"	8 - Black on Orange

#### TEMPORARY SINGLE AND DOUBLE LANE CLOSURES CONTINUED

			mensions hes)		
Sign		Letter Height	Vertical Spacing	Size	Quantity and Color
W8-I	ВИМР	Shall C to "Sto Hig	hensions Conform andard hway	48"x48"	8 - Black on Orange
W8-24a	RUMBLE STRIP AHEAD	Signs"	- 2012 	48" x 48"	4 - Black on Orange
W20-I	ROAD WORK 1 MILE			48" x 48"	4 - Black on Orange
W20-5aL	2 LEFT LANES CLOSED 1/2 MILE			48" x 48"	4 - Black on Orange
W20-5aR	2 RIGHT LANES CLOSED 1/2 MILE			48" x 48"	4 - Black on Orange
W20-5L	LEFT LANE CLOSED 1/2 MILE			48" x 48"	4 - Black on Orange
W20-5R	RIGHT LANE CLOSED 1/2 MILE	,		48" x 48"	4 - Black on Orange

Scale: NOT TO SCALE

No. Revision

By Date

CONSULTANT PROJECT MANAGER: M. Bowe

By Date

Designed MLG 11/22/24 Checked MDS 11/22/24

Drawn

Designed by:

VANASSE HANGEN BRUSTLIN, INC.

500 Southborough Dr.
Suite 105B

South Portland, ME 04106
TEL (207) 889-3150
FAX (207) 253-5596




# THE GOLD STAR MEMORIAL HIGHWAY


MTA PROJECT NO. 2025.04 BRIDGE REPAIRS

MAINTENANCE OF TRAFFIC DETAILS (2 OF 4)

VHB: 55807.00 SHEET NUMBER: 6
CONTRACT: 2025.04 6 OF 22

MTA PROJECT MANAGER: Kristi Van Ooyen, PE

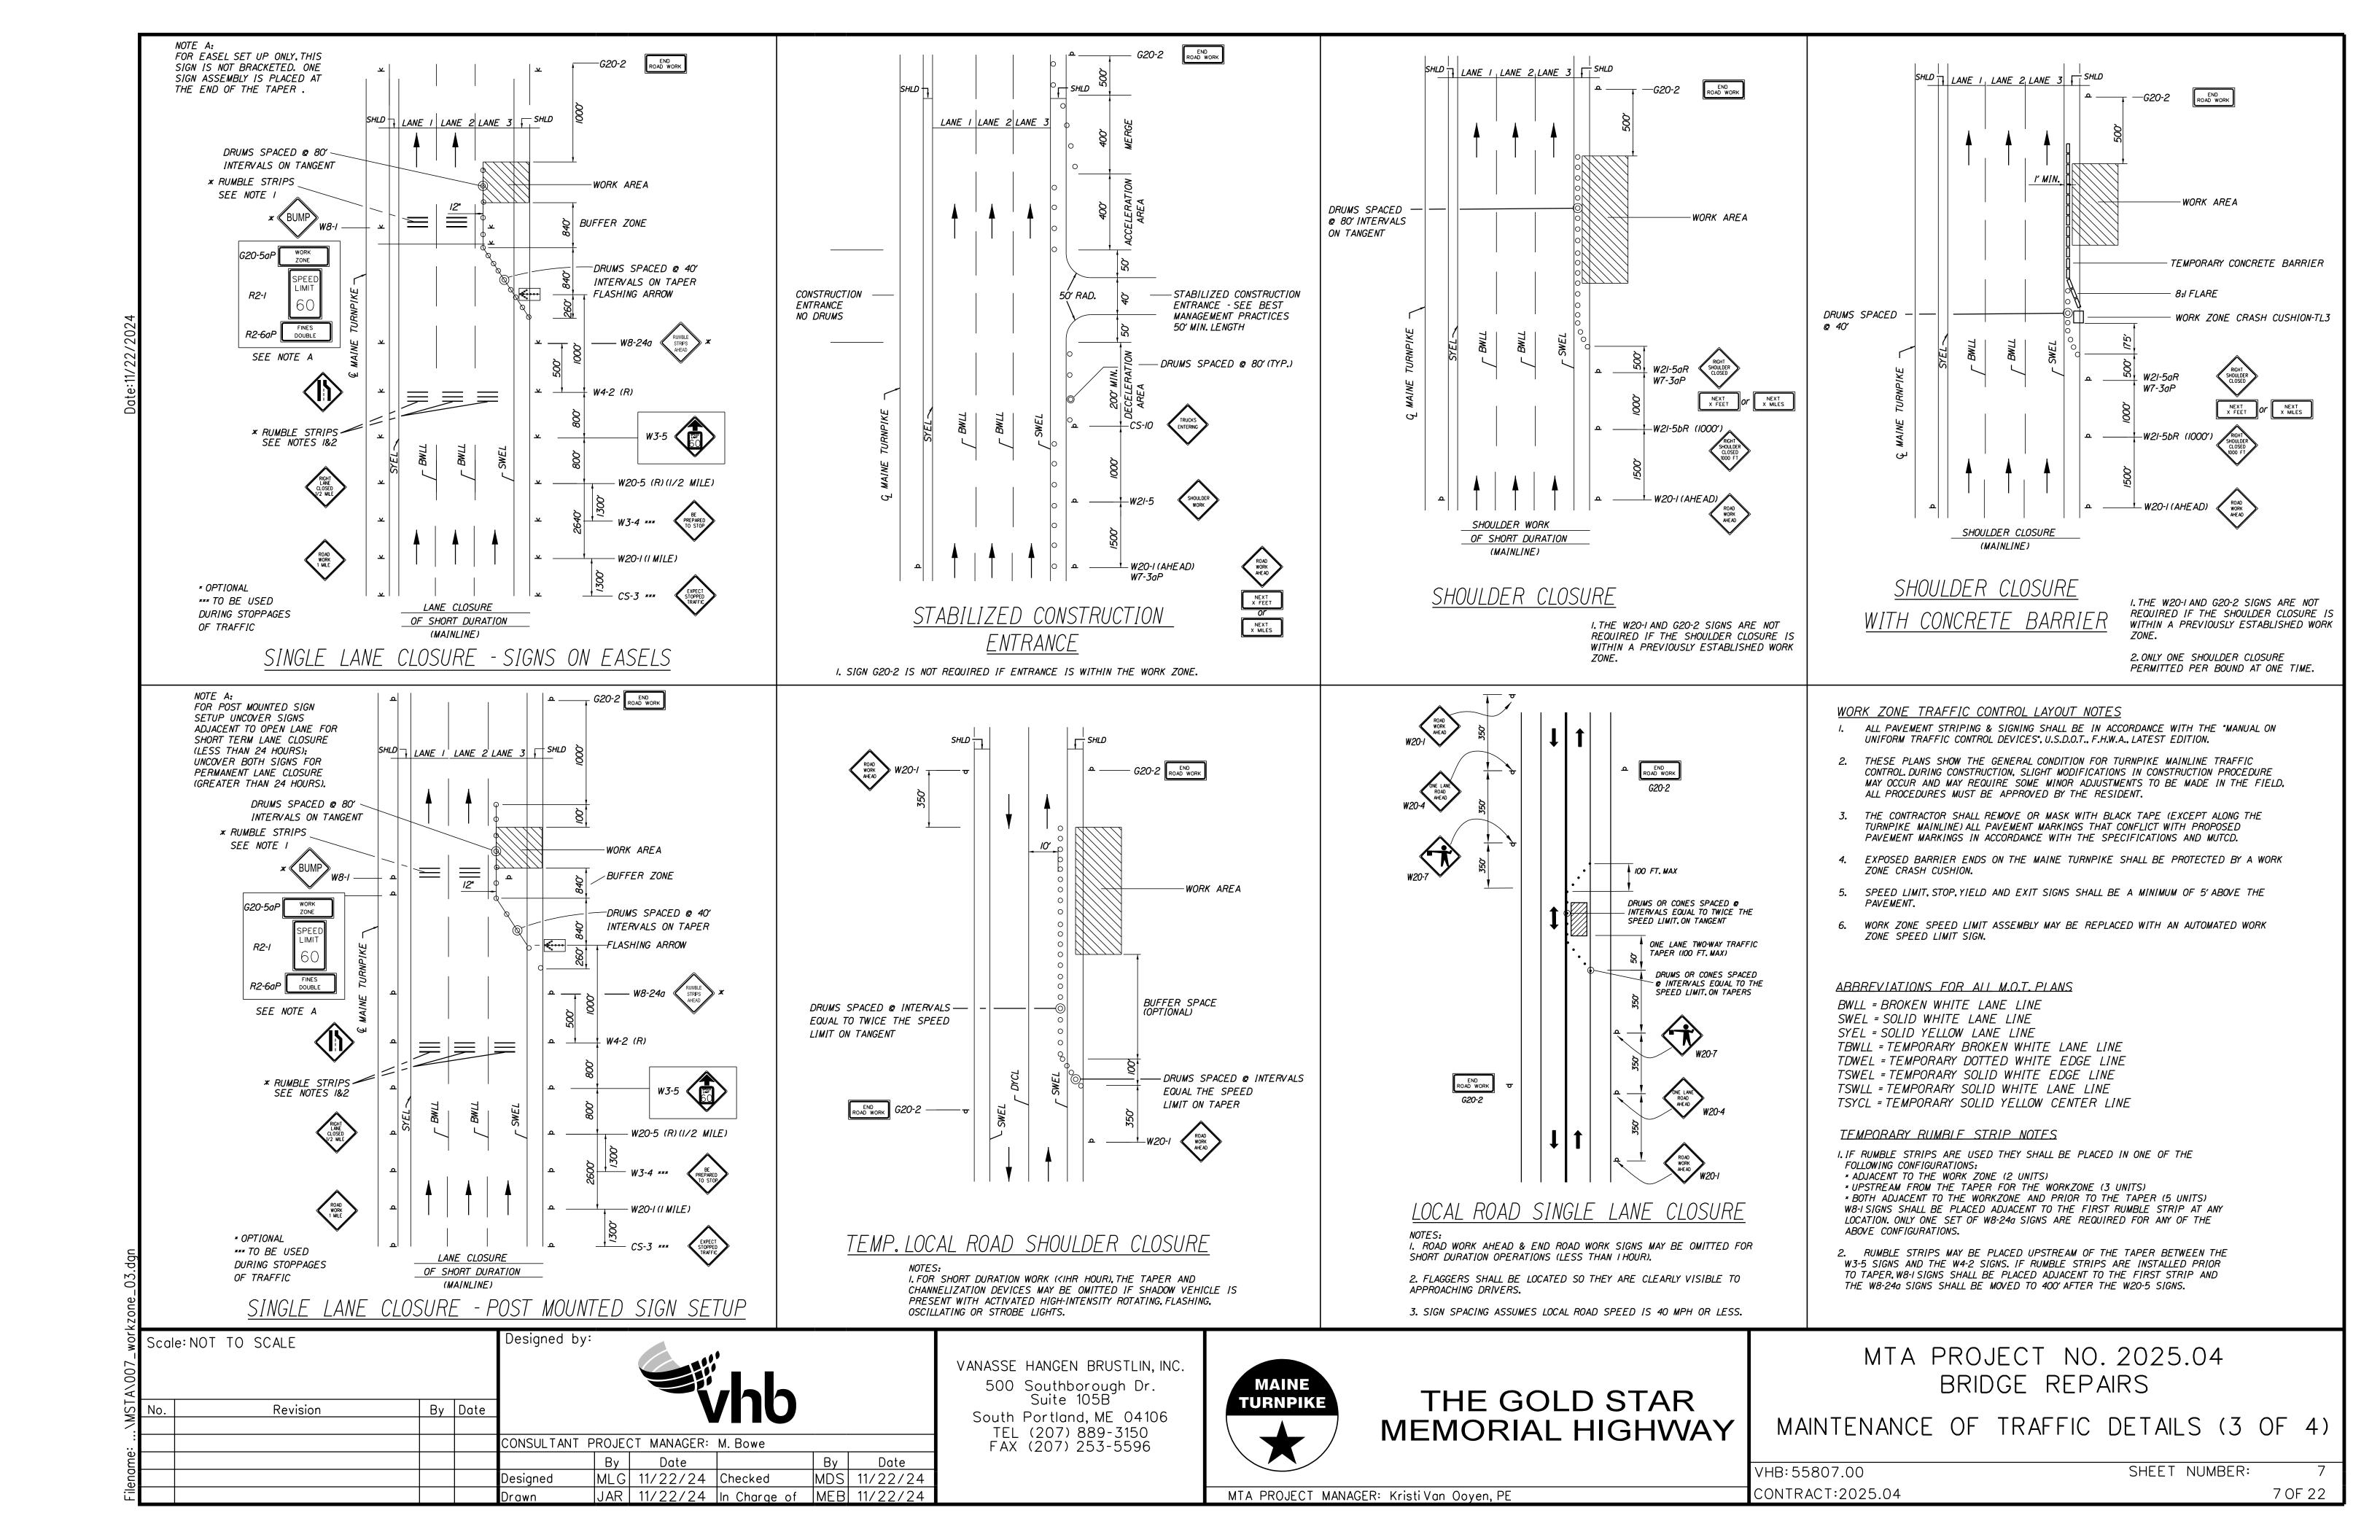

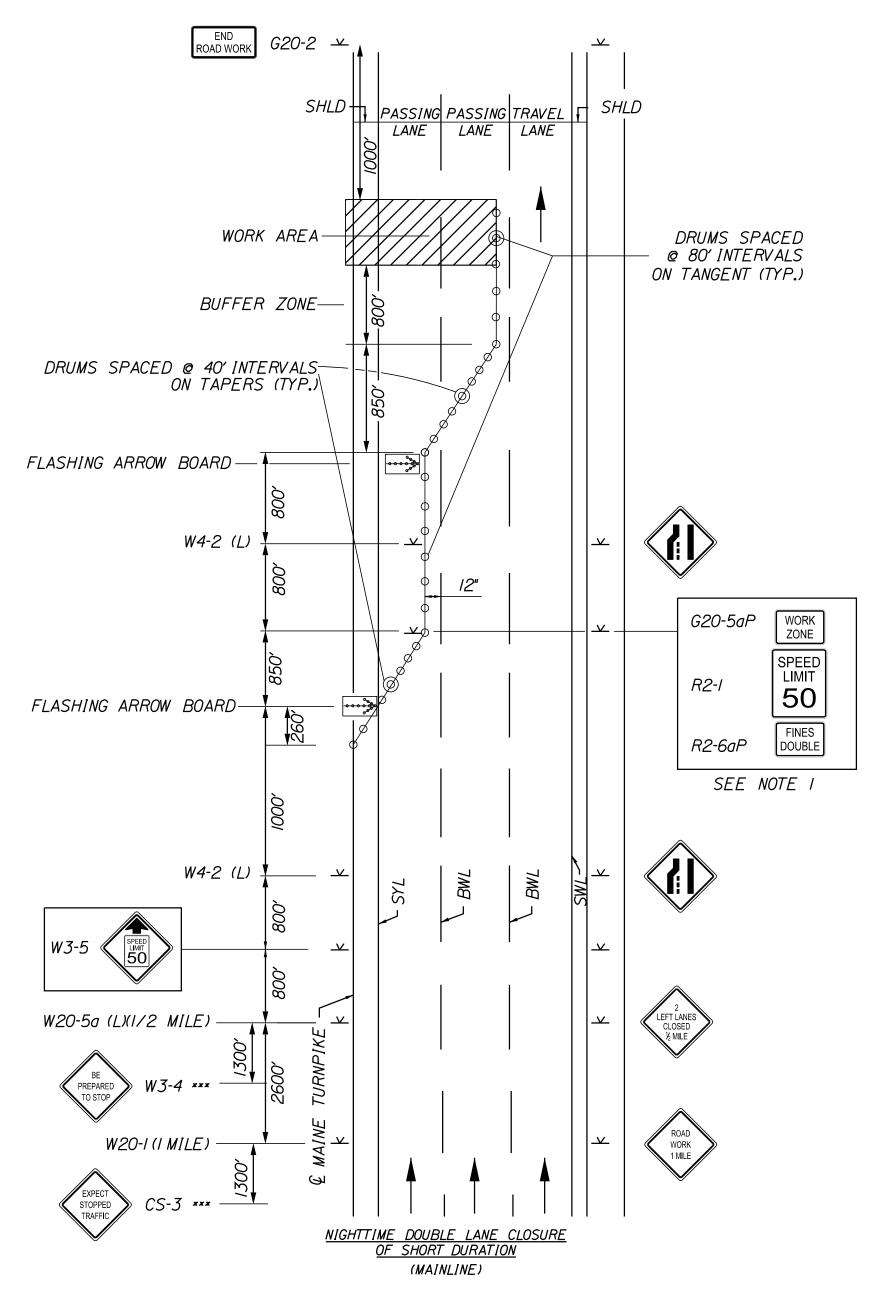


DOUBLE LANE CLOSURE (LEFT) SIGNS ON EASELS

I. For easel set up only, this sign is not bracketed. One sign assembly is placed at the end of the taper. Signs may be split onto two easels.

#### <u>GENERAL NOTES</u>

- I. For sign details, see construction sign summary.
- 2. When truck mounted attenuators are included in the contract (incidental or pay item), they shall not be located in the buffer zone.

#### <u>LEGEND</u> Construction Sign on Post Support Construction Sign on Easel Drums/Channelizing Devices <del>8 8 8 8</del> Temporary Concrete Barrier, Type I •••• Temporary Impact Attenuator Work Area $\square$ Type 3 Barricade with Sign Type 3 Barricade

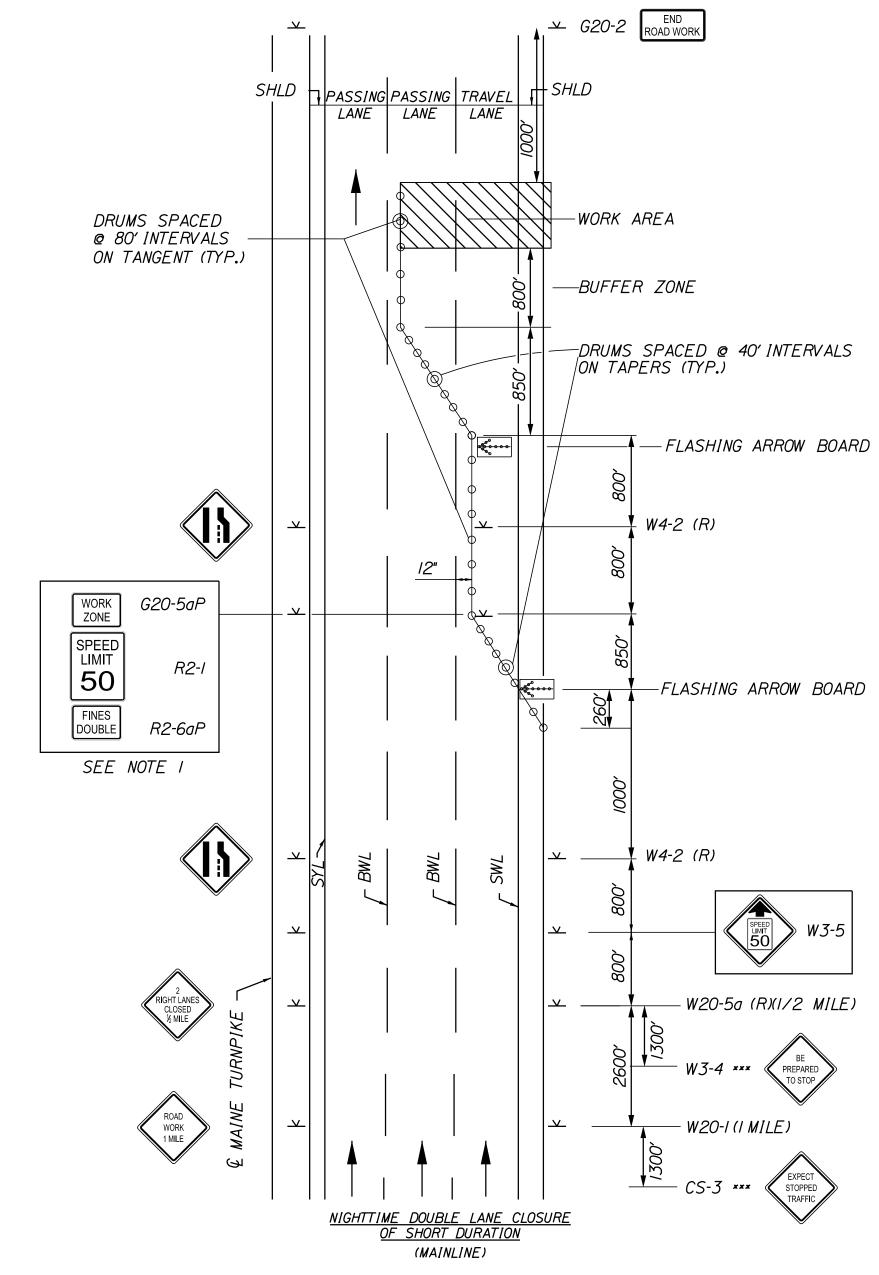

DOUBLE LANE CLOSURE (RIGHT) SIGNS ON EASELS

I. For easel set up only, this sign is not bracketed. One sign assembly is placed at the end of the taper. Signs may be split onto two easels.

A\008_wor	Scale: NOT TO SCALE				Designed by:					
\MST	No.	Revision	Ву	Date						
.:					CONSULTANT F	ROJEC	CT MANAGER:	M. Bowe		
me						Ву	Date		Ву	Date
ilename					Designed	MLG	11/22/24	Checked	MDS	11/22/24
ij					Drawn	JAR	11/22/24	In Charge of	MEB	11/22/24

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**MAINE** TEL (207) 889-3150 FAX (207) 253-5596




## THE GOLD STAR MEMORIAL HIGHWAY

MTA PROJECT NO. 2025.04 BRIDGE REPAIRS

MAINTENANCE OF TRAFFIC DETAILS (4 OF 4)


SHEET NUMBER: VHB: 55807.00 CONTRACT:2025.04 8 OF 22

MTA PROJECT MANAGER: Kristi Van Ooyen, PE

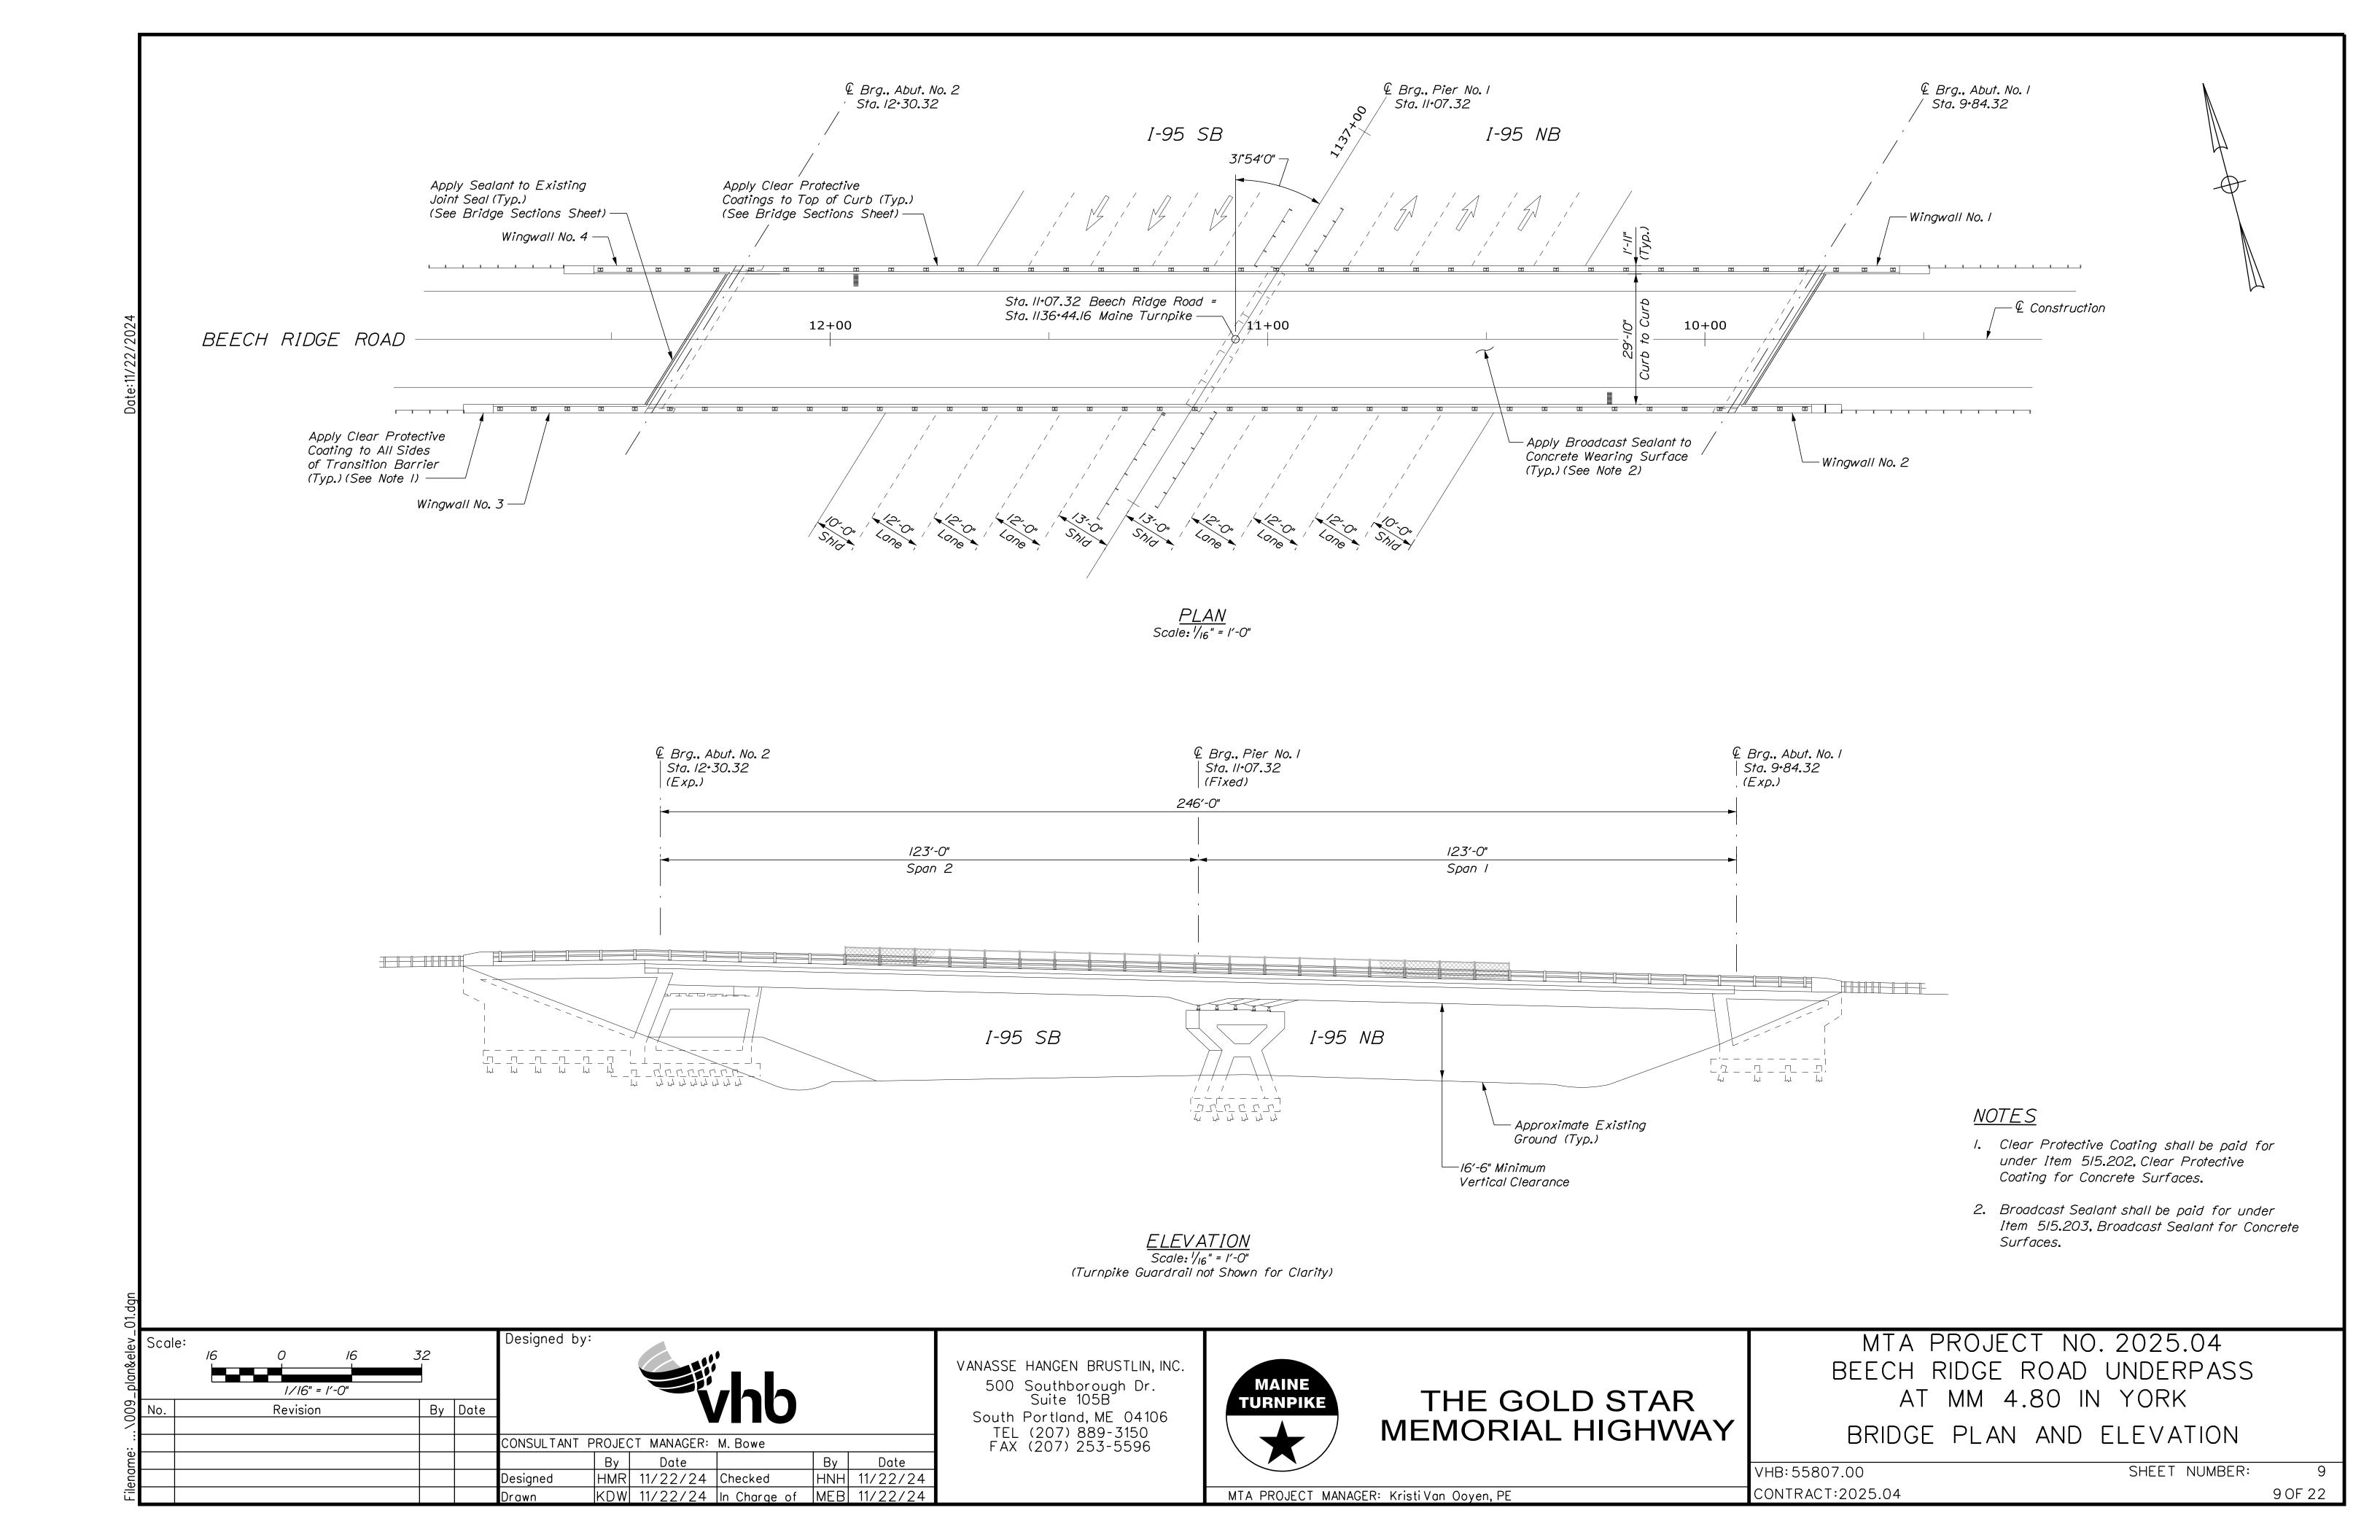

#### SECTION AT EXPANSION JOINT AT ABUTMENTS Not to Scale

#### ⊈ Roadway

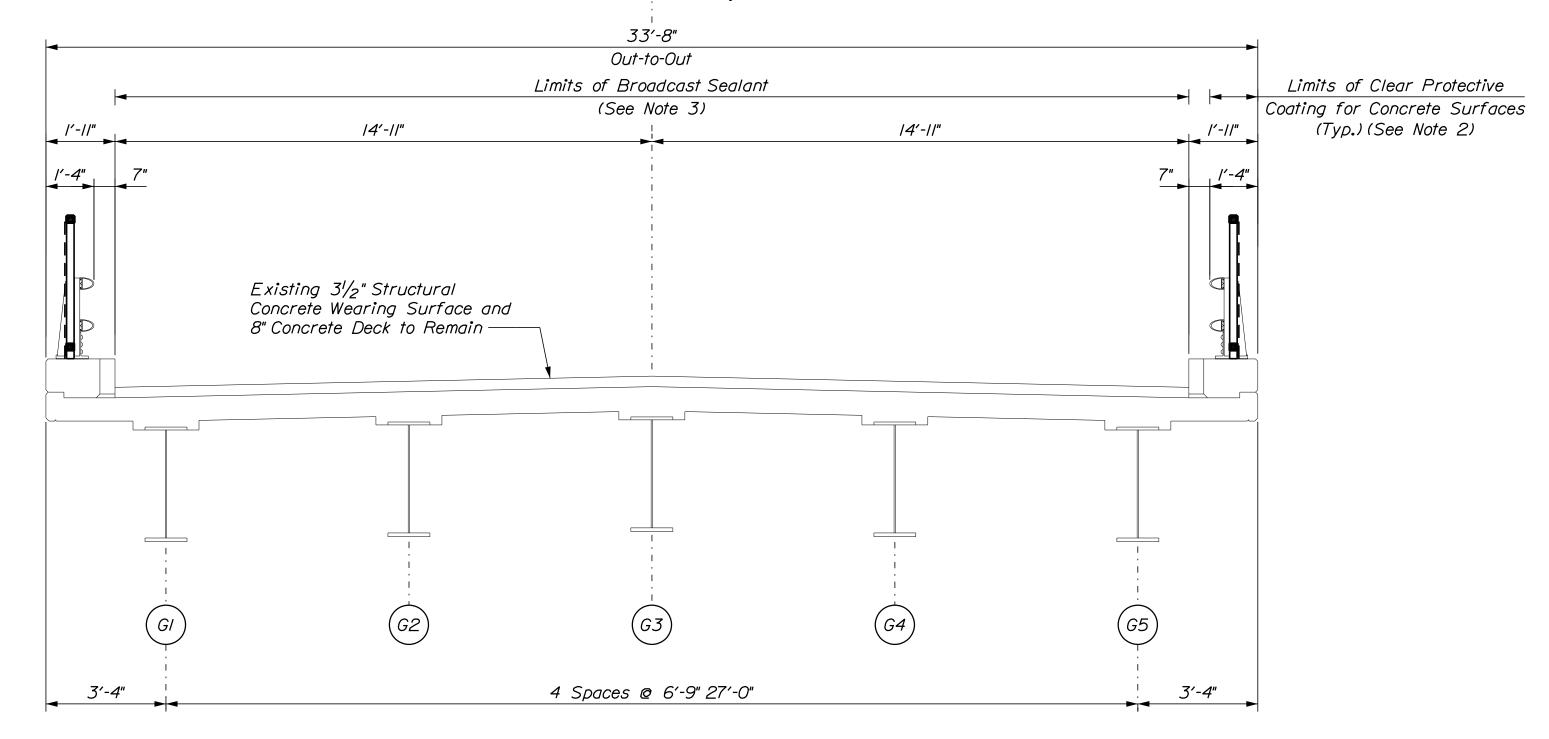

#### SUPERSTRUCTURE TYPICAL SECTION Scale: 3/8" = 1'-0"

#### <u>NOTES</u>

- I. Joint sealant shall be applied the full length of the joint, including into the curb. The existing joint seal shall be cleaned and inspected by the Resident before applying sealant. The Contractor shall ensure no sealant leaks through any tears in the existing joint seal. Sealant for joint seal shall be paid under Item 520.40, Joint Seal Repair, See Special Provision 520 for additional details.
- 2. Clear Protective Coating shall be paid under Item 515.202, Clear Protective Coating for Concrete Surfaces.
- 3. Broadcast Sealant shall be paid for under Item 515.203, Broadcast Sealant for Concrete Surfaces.

Scale:	3/8" = 1'-0"	7		Designed b	y:		, , , ,		
No.	Revision	Ву	Date	-		1			
				CONSULTANT	PROJEC	CT MANAGER:	M. Bowe		
					Ву	Date		Ву	Date
				Designed	HMR	11/22/24	Checked	HNH	11/22/24
				Drawn	KDW	11/22/24	In Charge of	MEB	11/22/24

VANASSE HANGEN BRUSTLIN, INC. 500 Southborough Dr. Suite 105B South Portland, ME 04106

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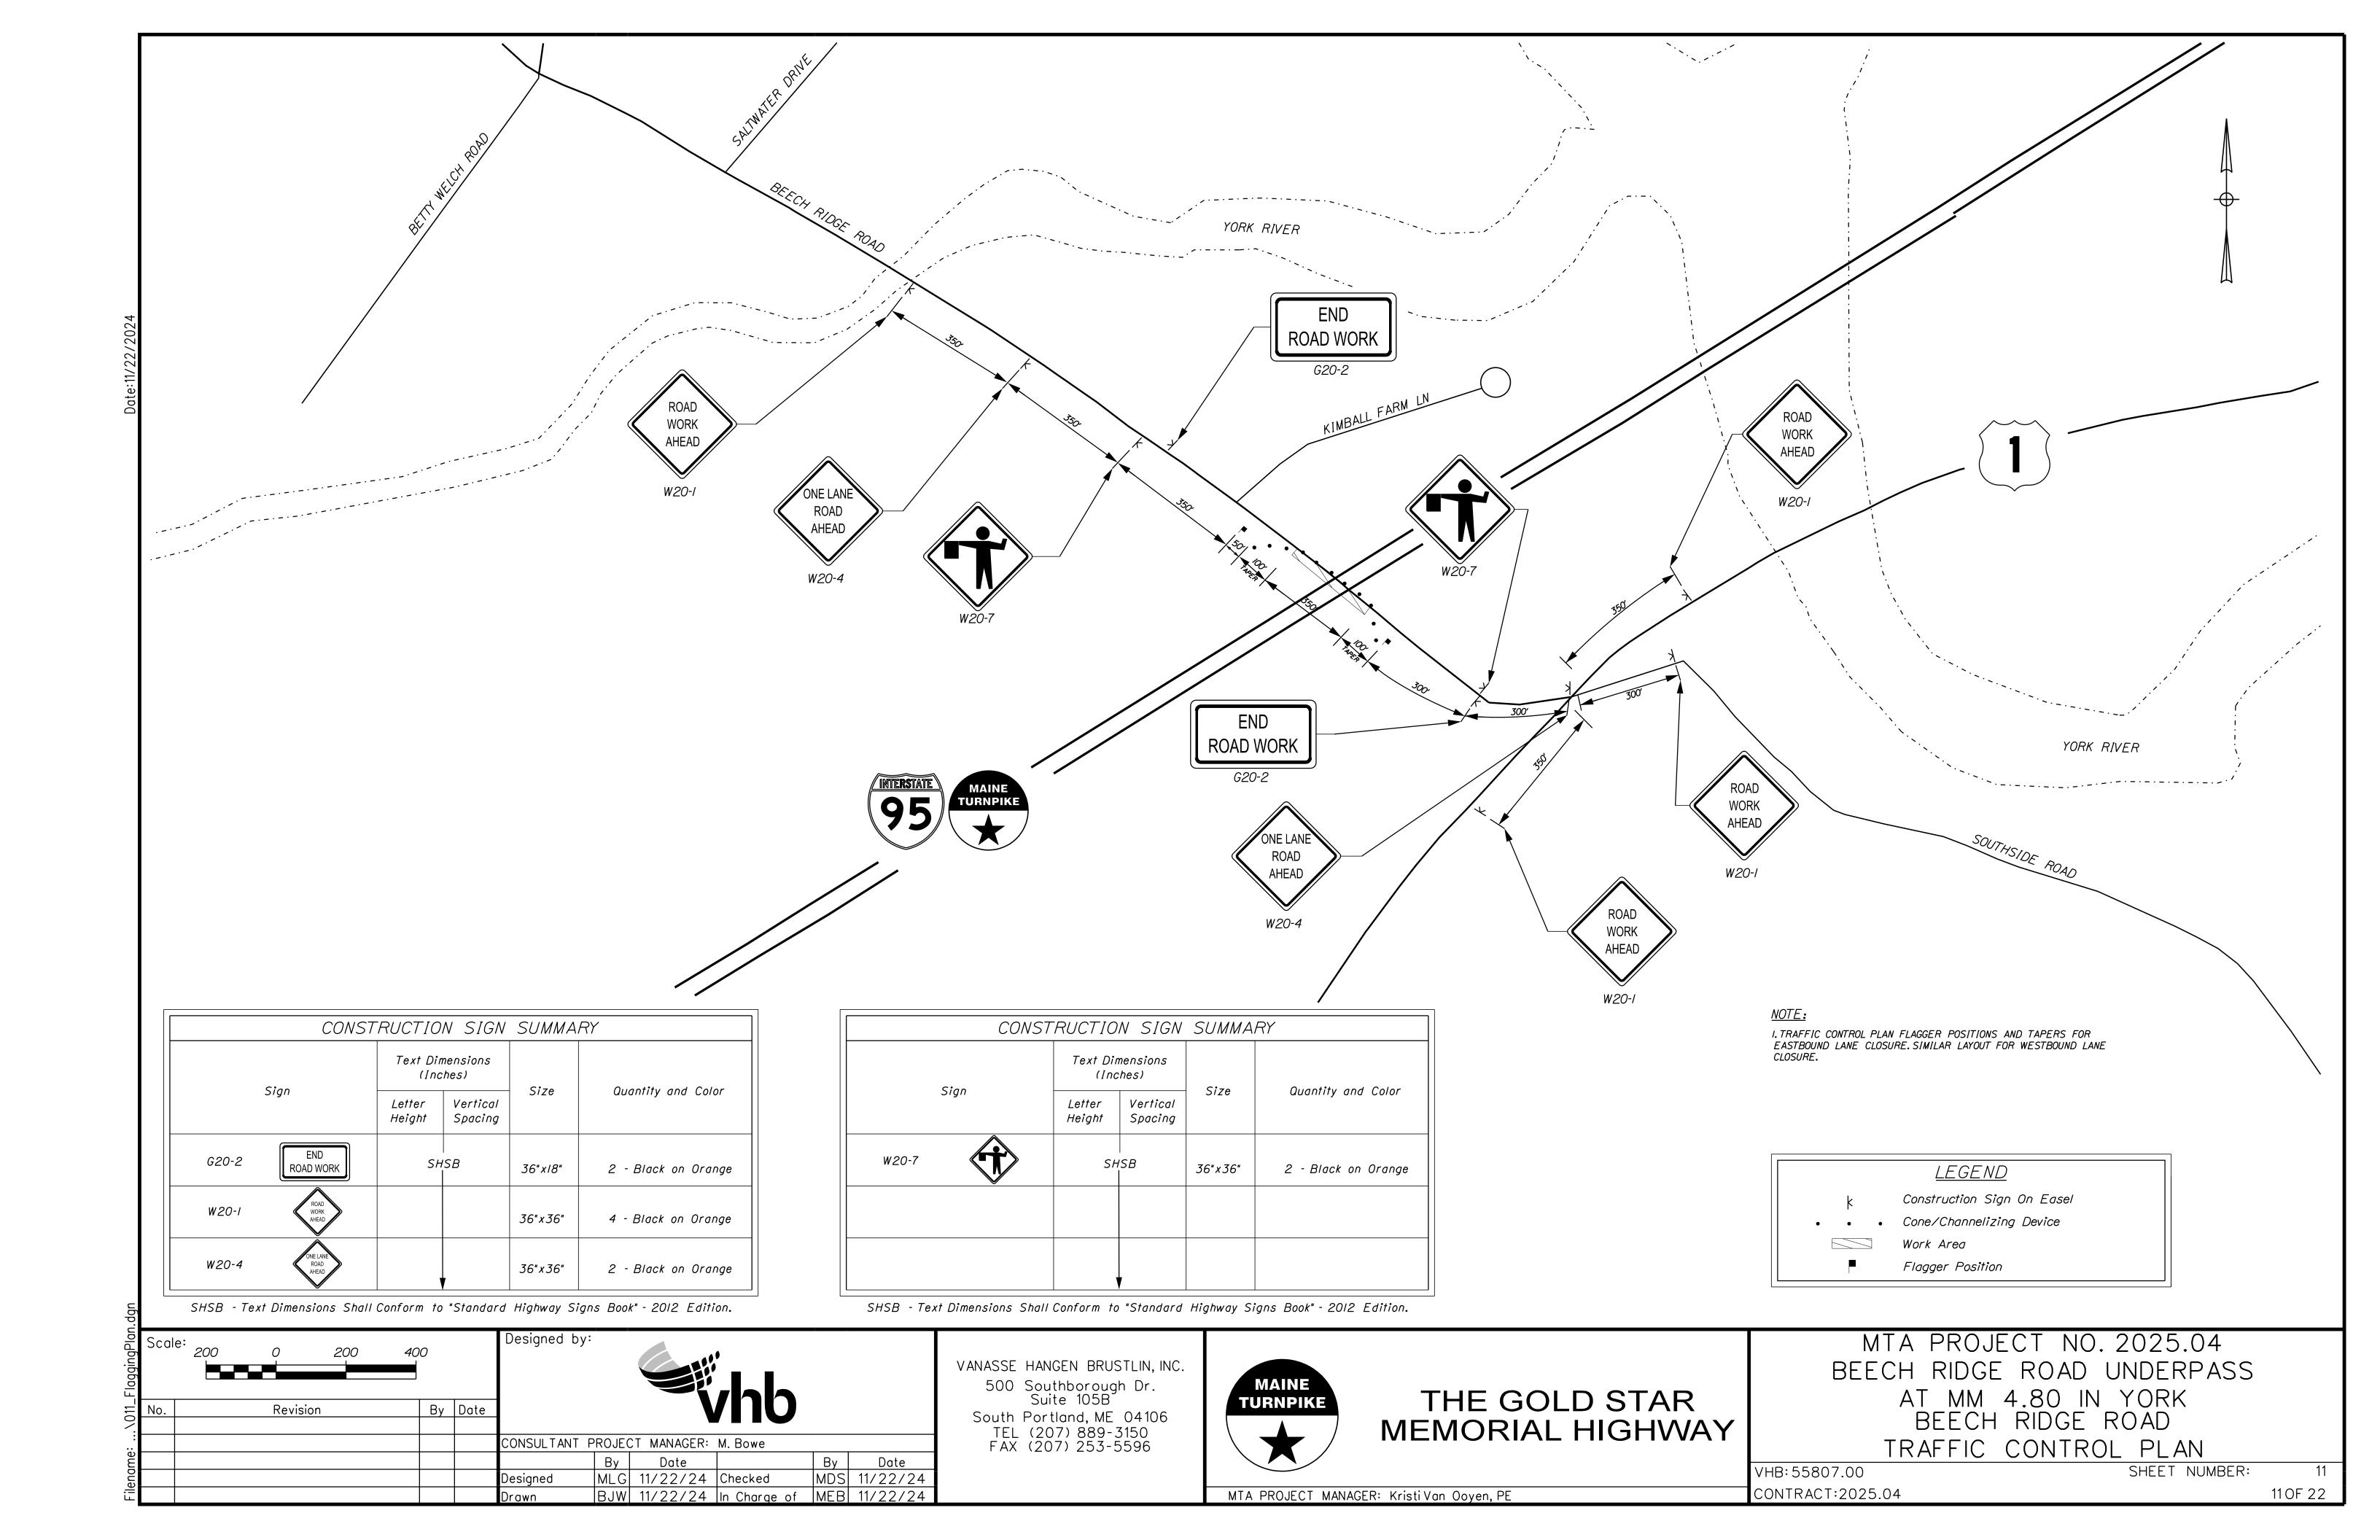



MTA PROJECT MANAGER: Kristi Van Ooyen, PE


THE GOLD STAR MEMORIAL HIGHWAY

MTA PROJECT NO. 2025.04 BEECH RIDGE ROAD UNDERPASS AT MM 4.80 IN YORK BRIDGE SECTIONS


SHEET NUMBER: VHB: 55807.00 CONTRACT:2025.04 10 OF 22



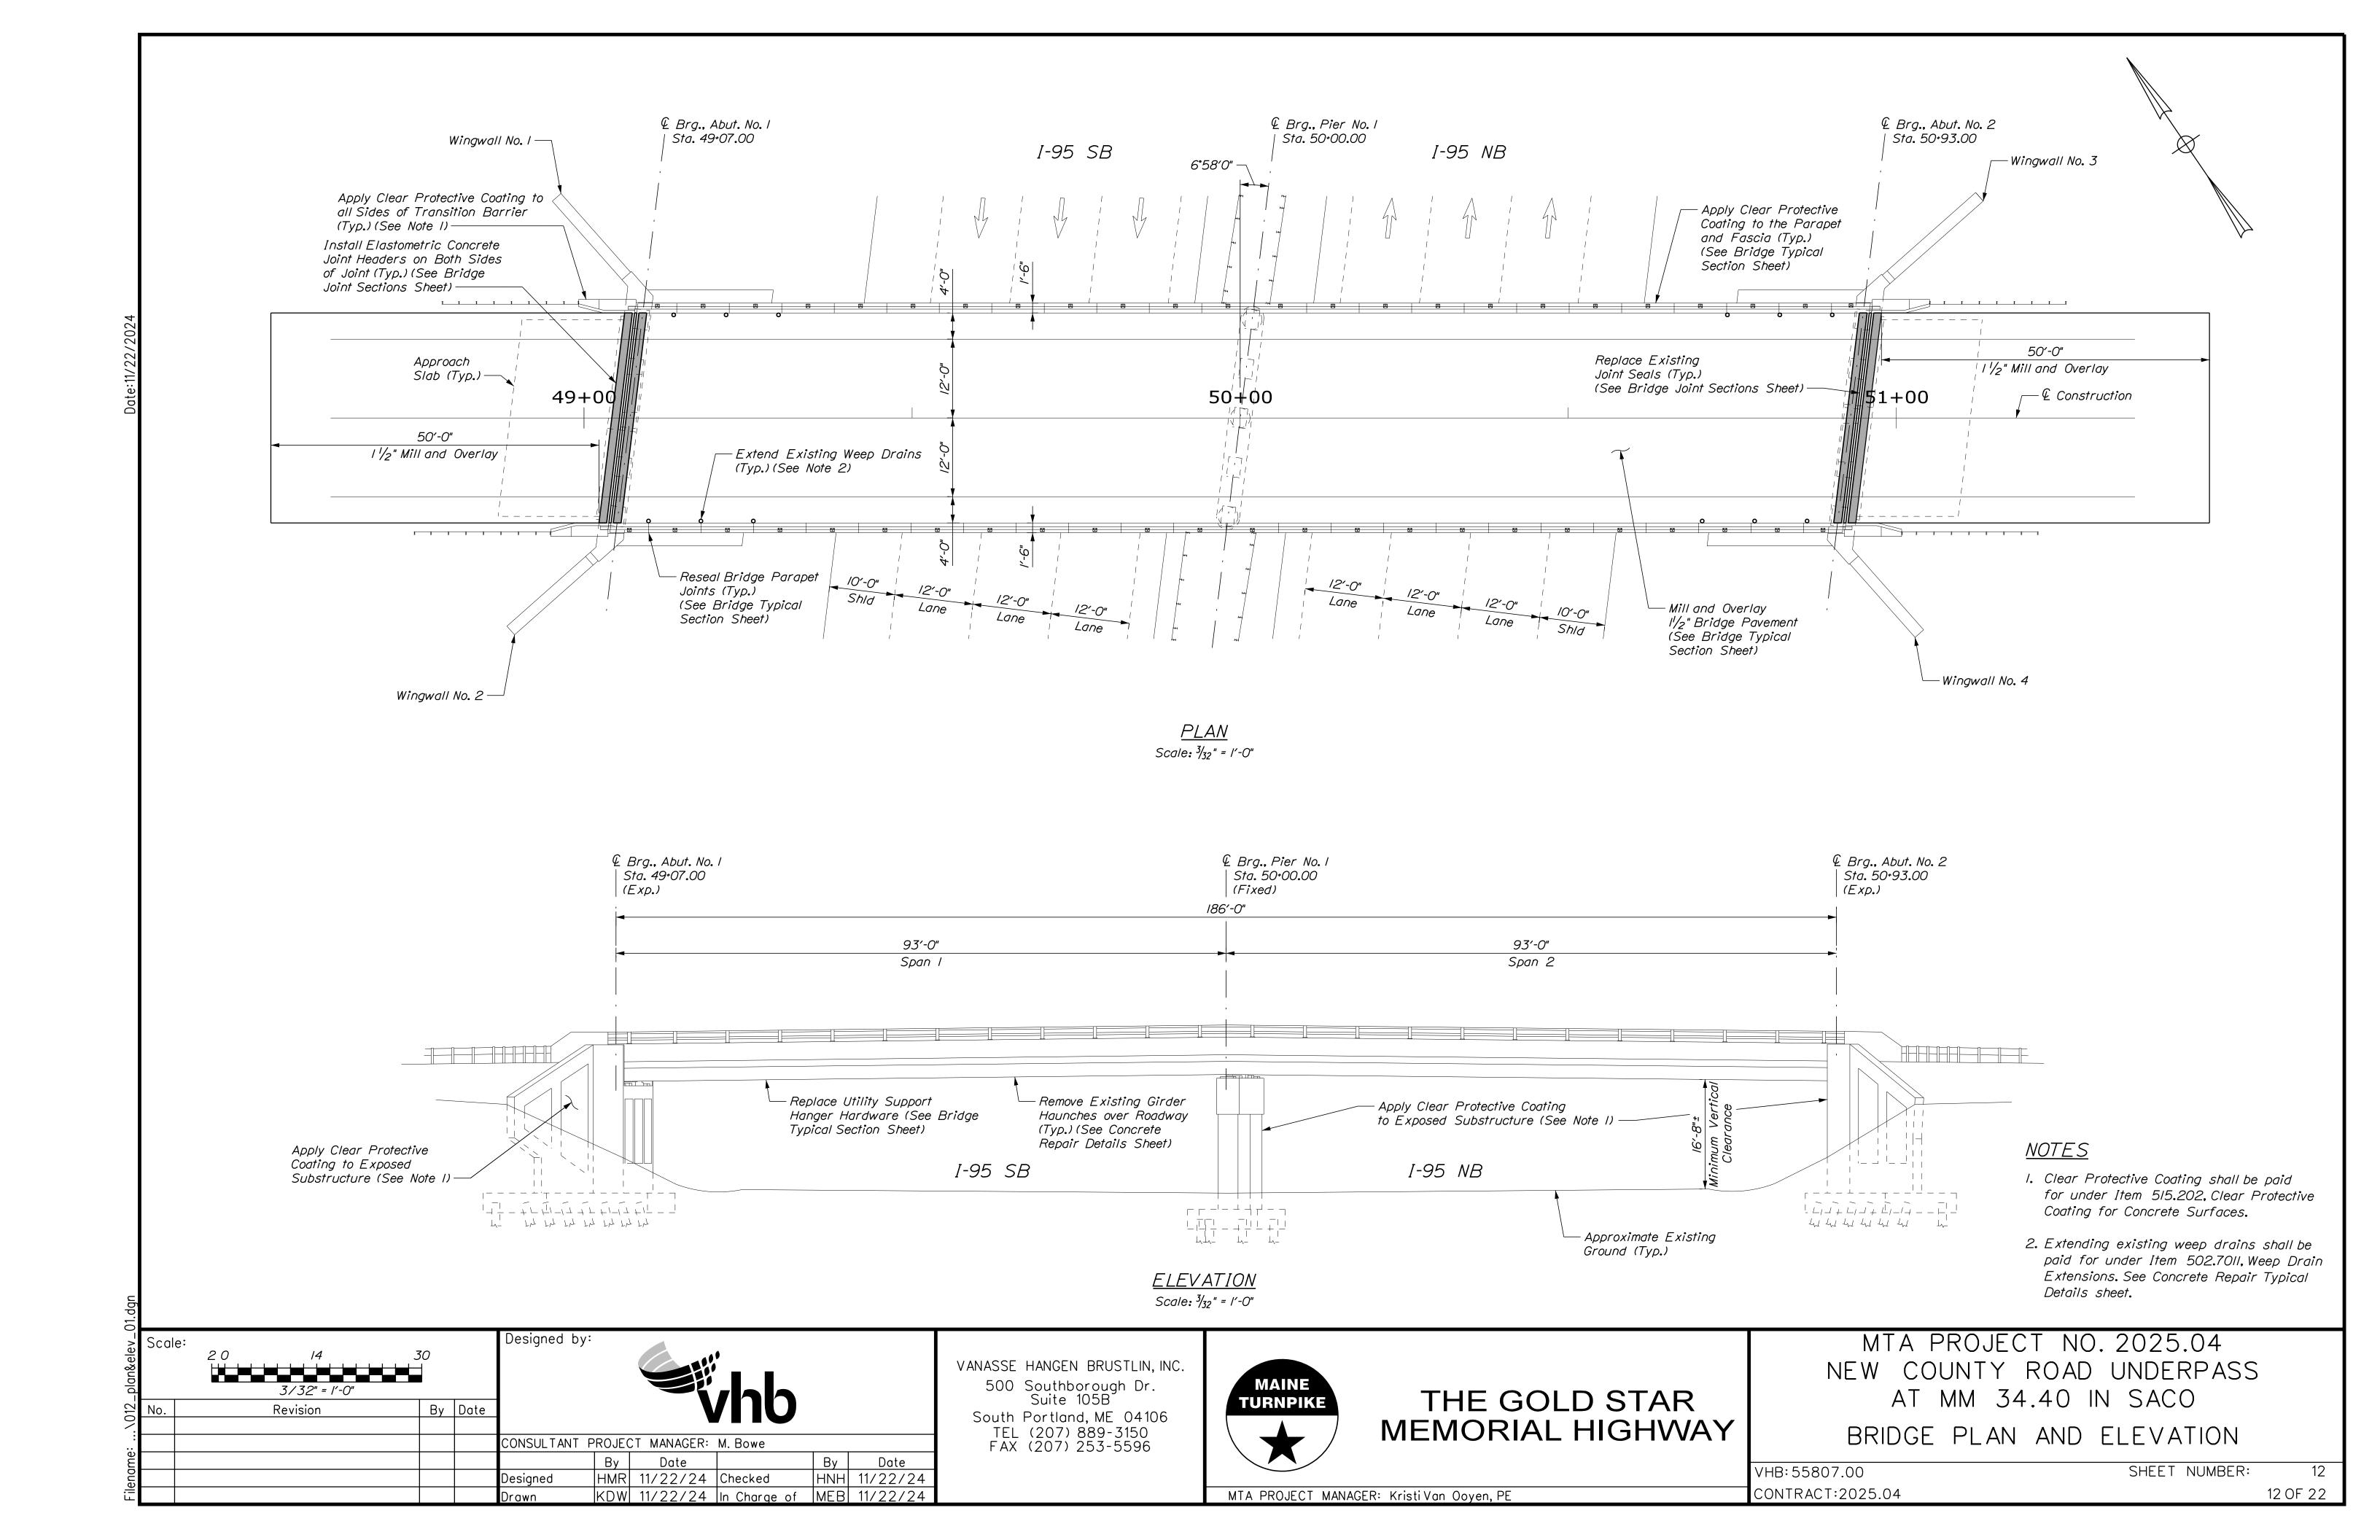

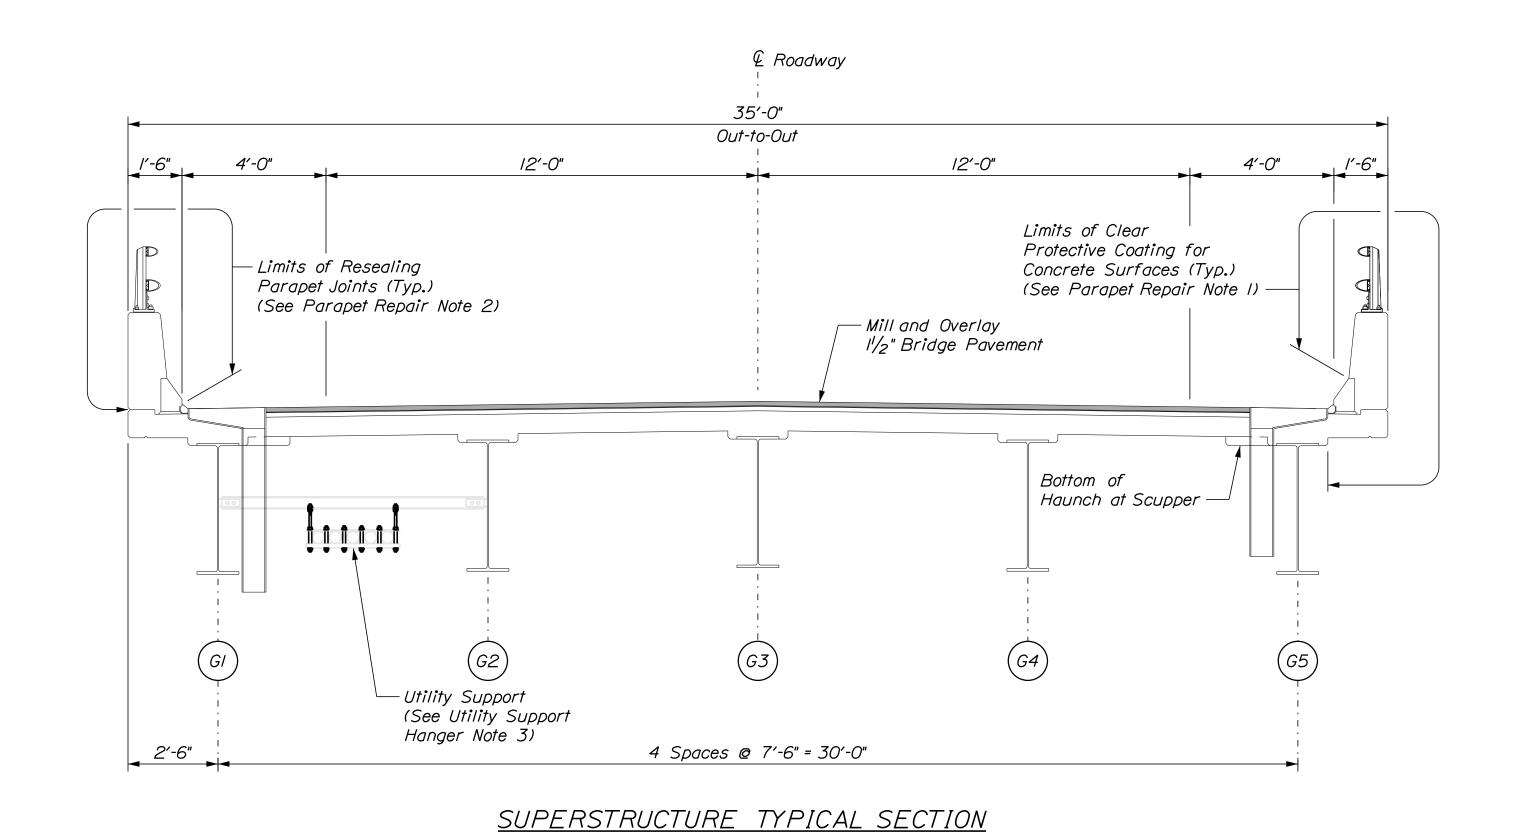

Scale: 3/8" = 1'-0"

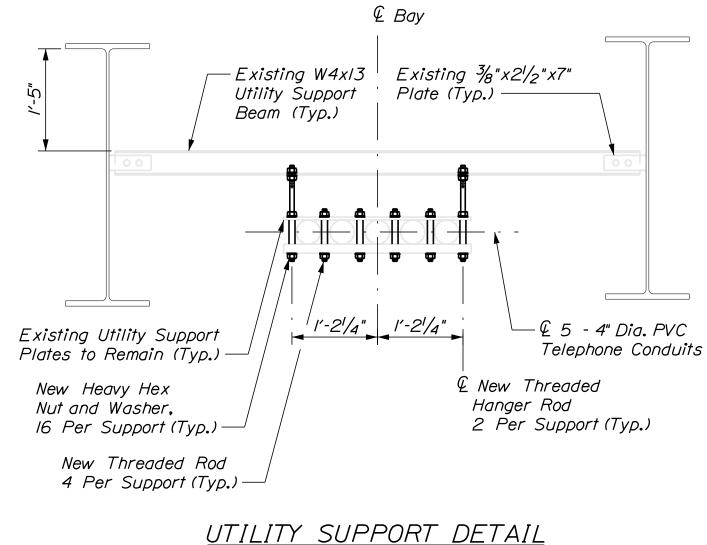

(Looking East) (24 Total Utility Supports)
Scale: 3/4" = 1'-0"

#### UTILITY SUPPORT HANGER NOTES


- I. The utility support hardware shall be replaced at all utility support hangers. The existing composite support hardware shall be re-used. The conduit shall be temporarily supported at the location being replaced. The Contractor shall design and submit an installation and temporary support plan at least three weeks prior to performing this work. The Contractor shall be fully responsible for replacing the existing pipe hardware if damaged during removal and re-installation.
- 2. Contractor shall field verify threaded rod lengths prior to rod and hardware procurement. Field cutting new threaded rod will not be
- 3. All labor, equipment, and materials necessary to repair the utility conduit hangers shall be paid for under Item 830.17, Utility Conduit Hanger System Hardware.

#### MATERIAL NOTE

I. All utility support hardware shall consist of  $\frac{3}{4}$ " dia. Grade A36 threaded rod, I'/4" Grade A563 heavy hex locking nuts and associated washers. All hardware shall be hot dipped galvanized.

#### PARAPET REPAIR NOTES

- I. Limits of clear protective coating shall be paid for under Item 515.202, Clear Protective Coating for Concrete Surfaces.
- 2. Reseal all parapet joints as directed by the Resident including the joint between the parapet and top of curb. Joint sealant shall be from the MaineDOT Qualified Product List for Silicone and Polyurethane Joint Sealant. Resealing joints shall be paid under Item 518.48, Réseal Joints.

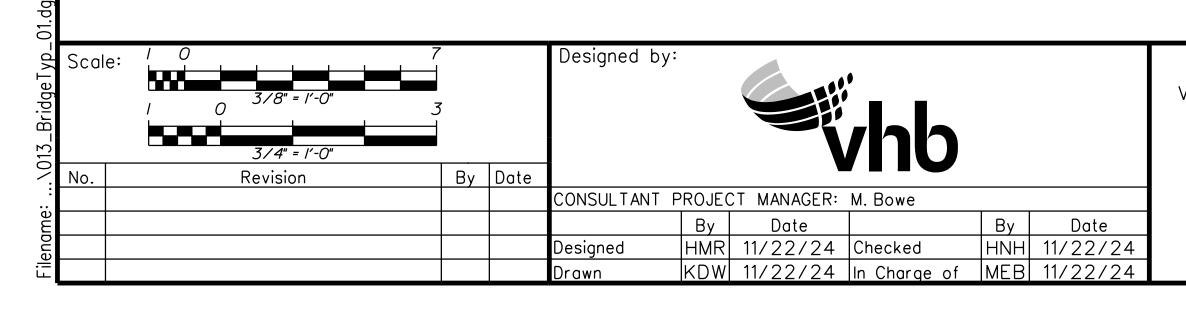

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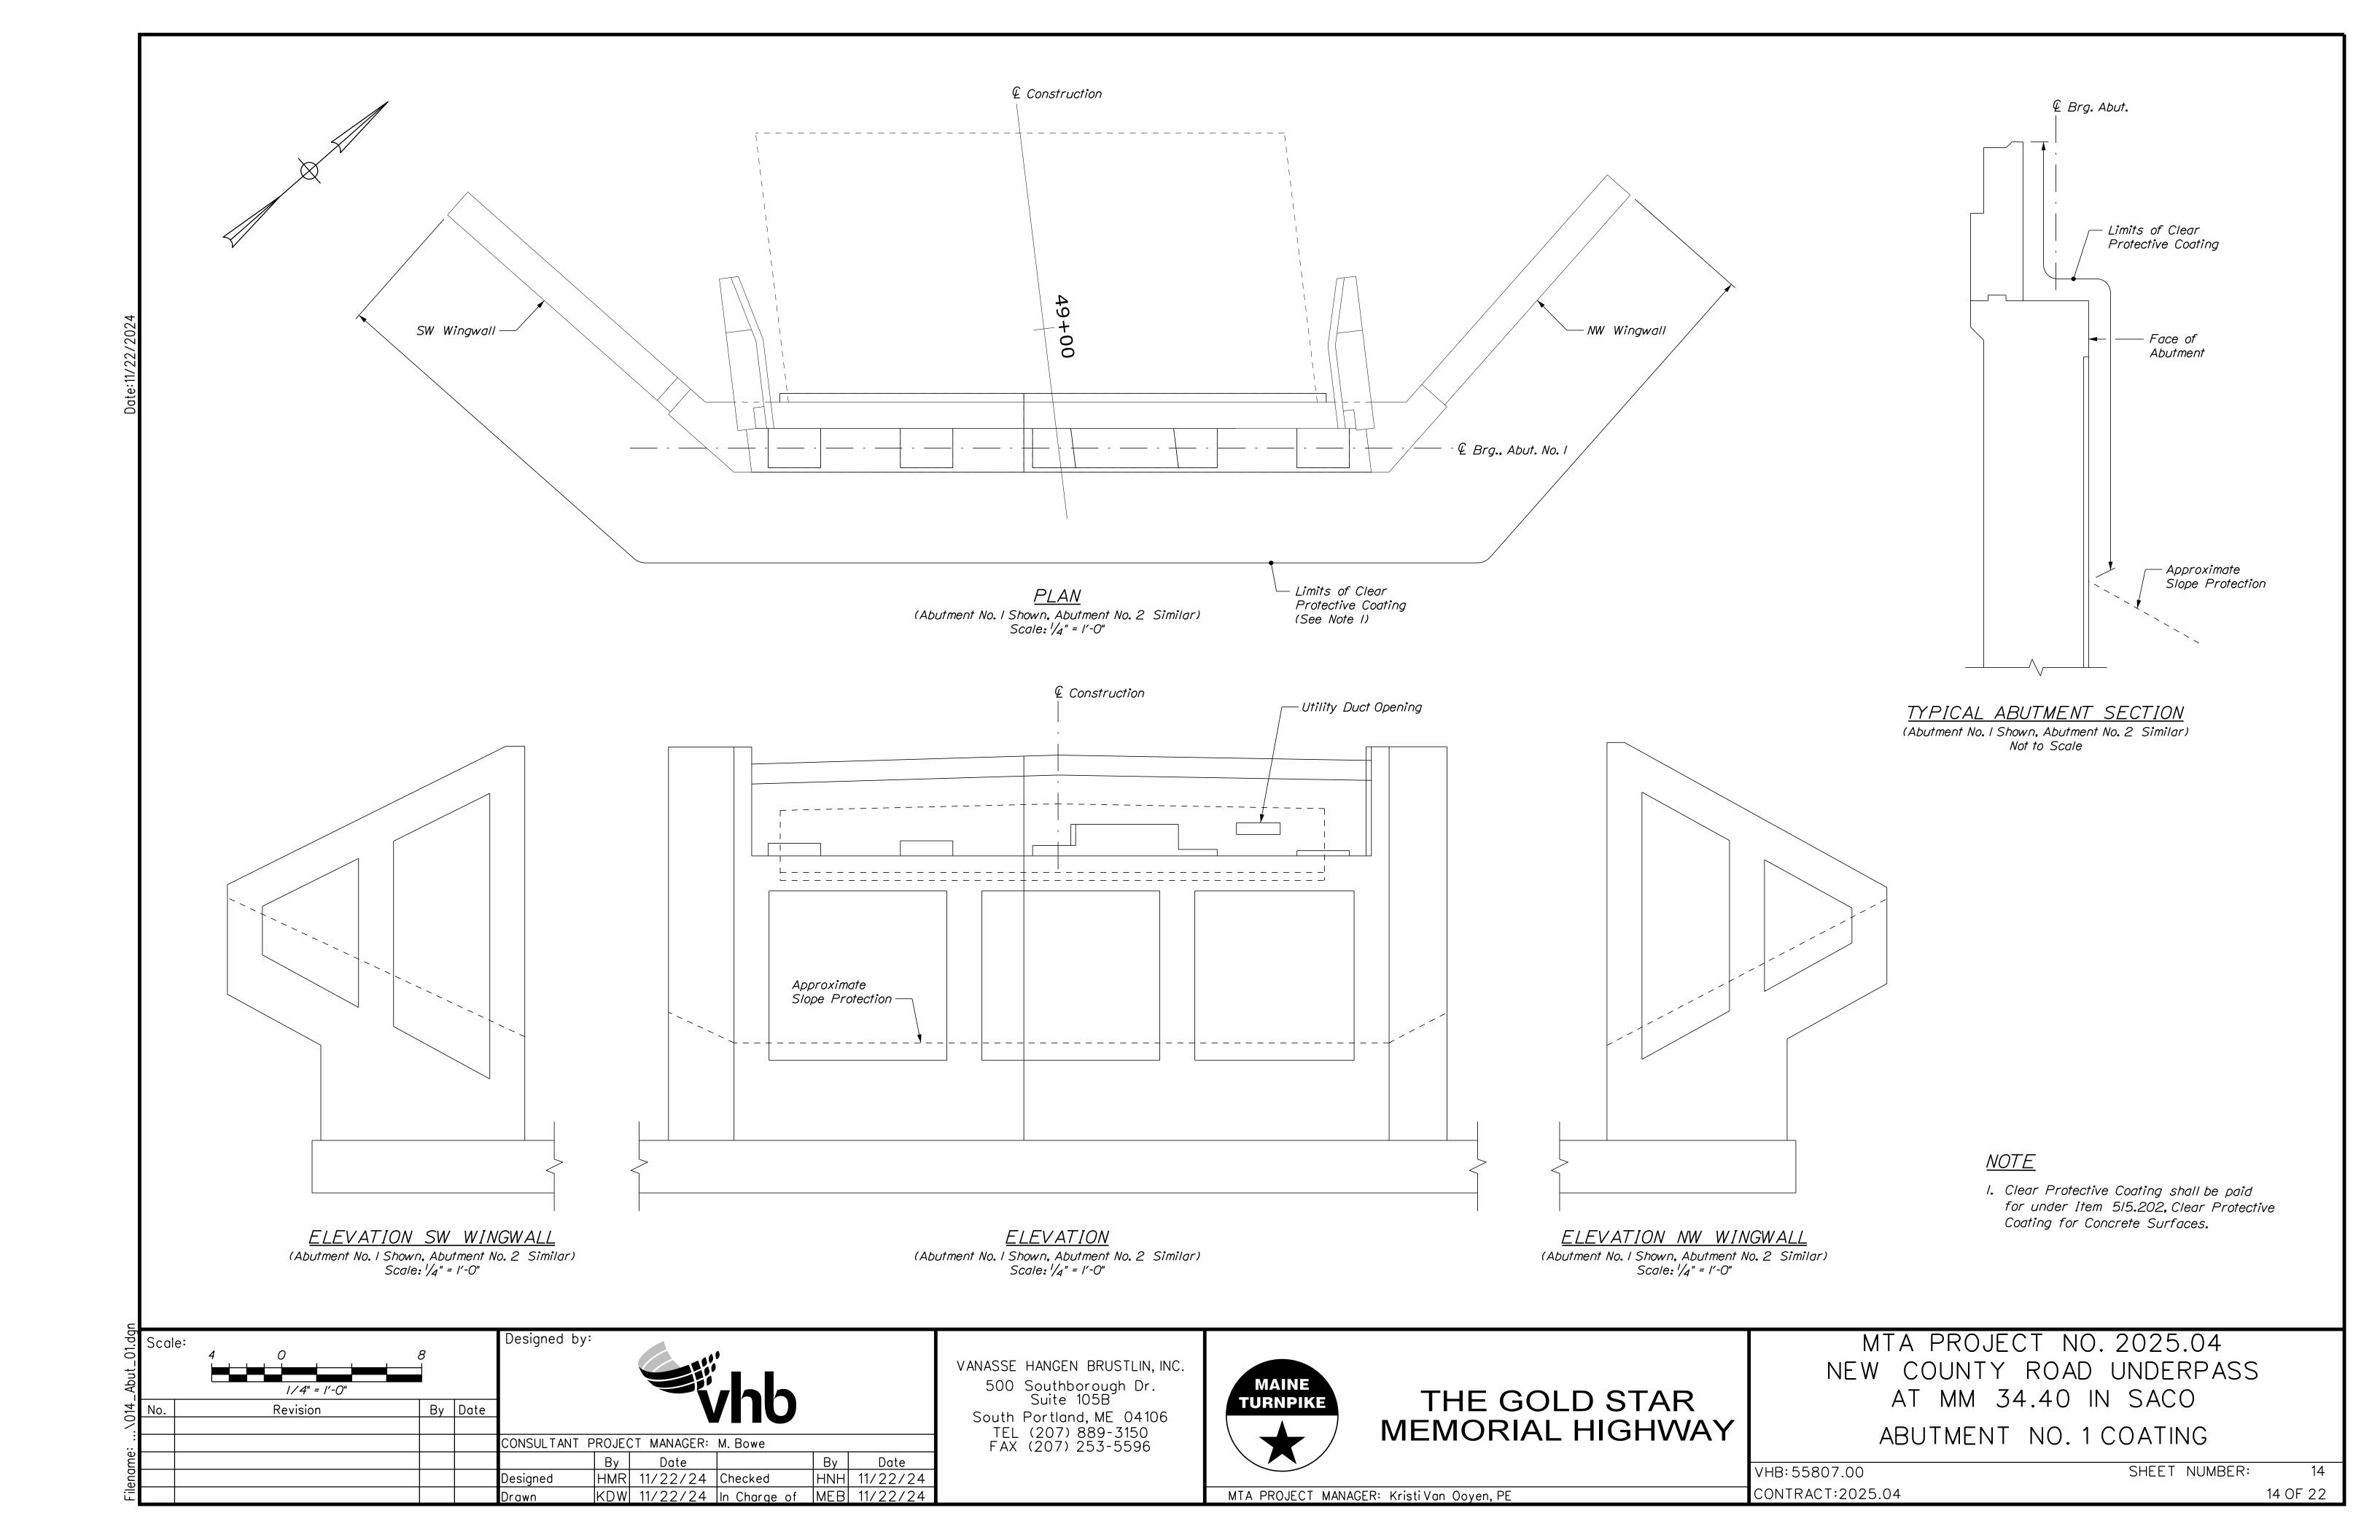
THE GOLD STAR MEMORIAL HIGHWAY


MTA PROJECT NO. 2025.04 NEW COUNTY ROAD UNDERPASS AT MM 34.40 IN SACO BRIDGE TYPICAL SECTION


SHEET NUMBER: VHB: 55807.00


MTA PROJECT MANAGER: Kristi Van Ooyen, PE

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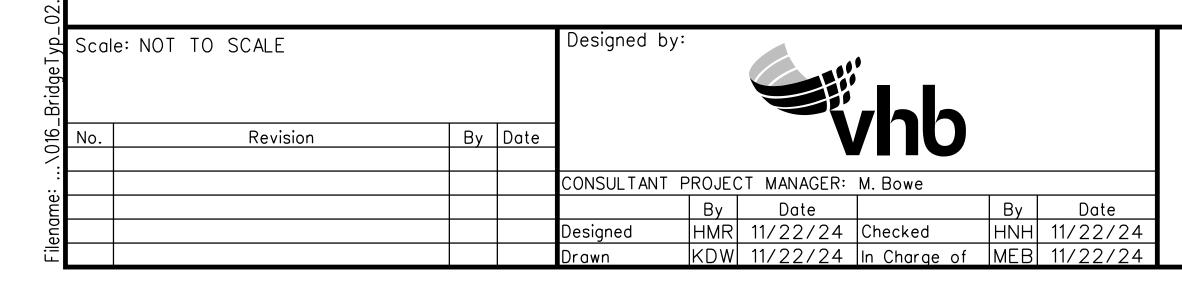




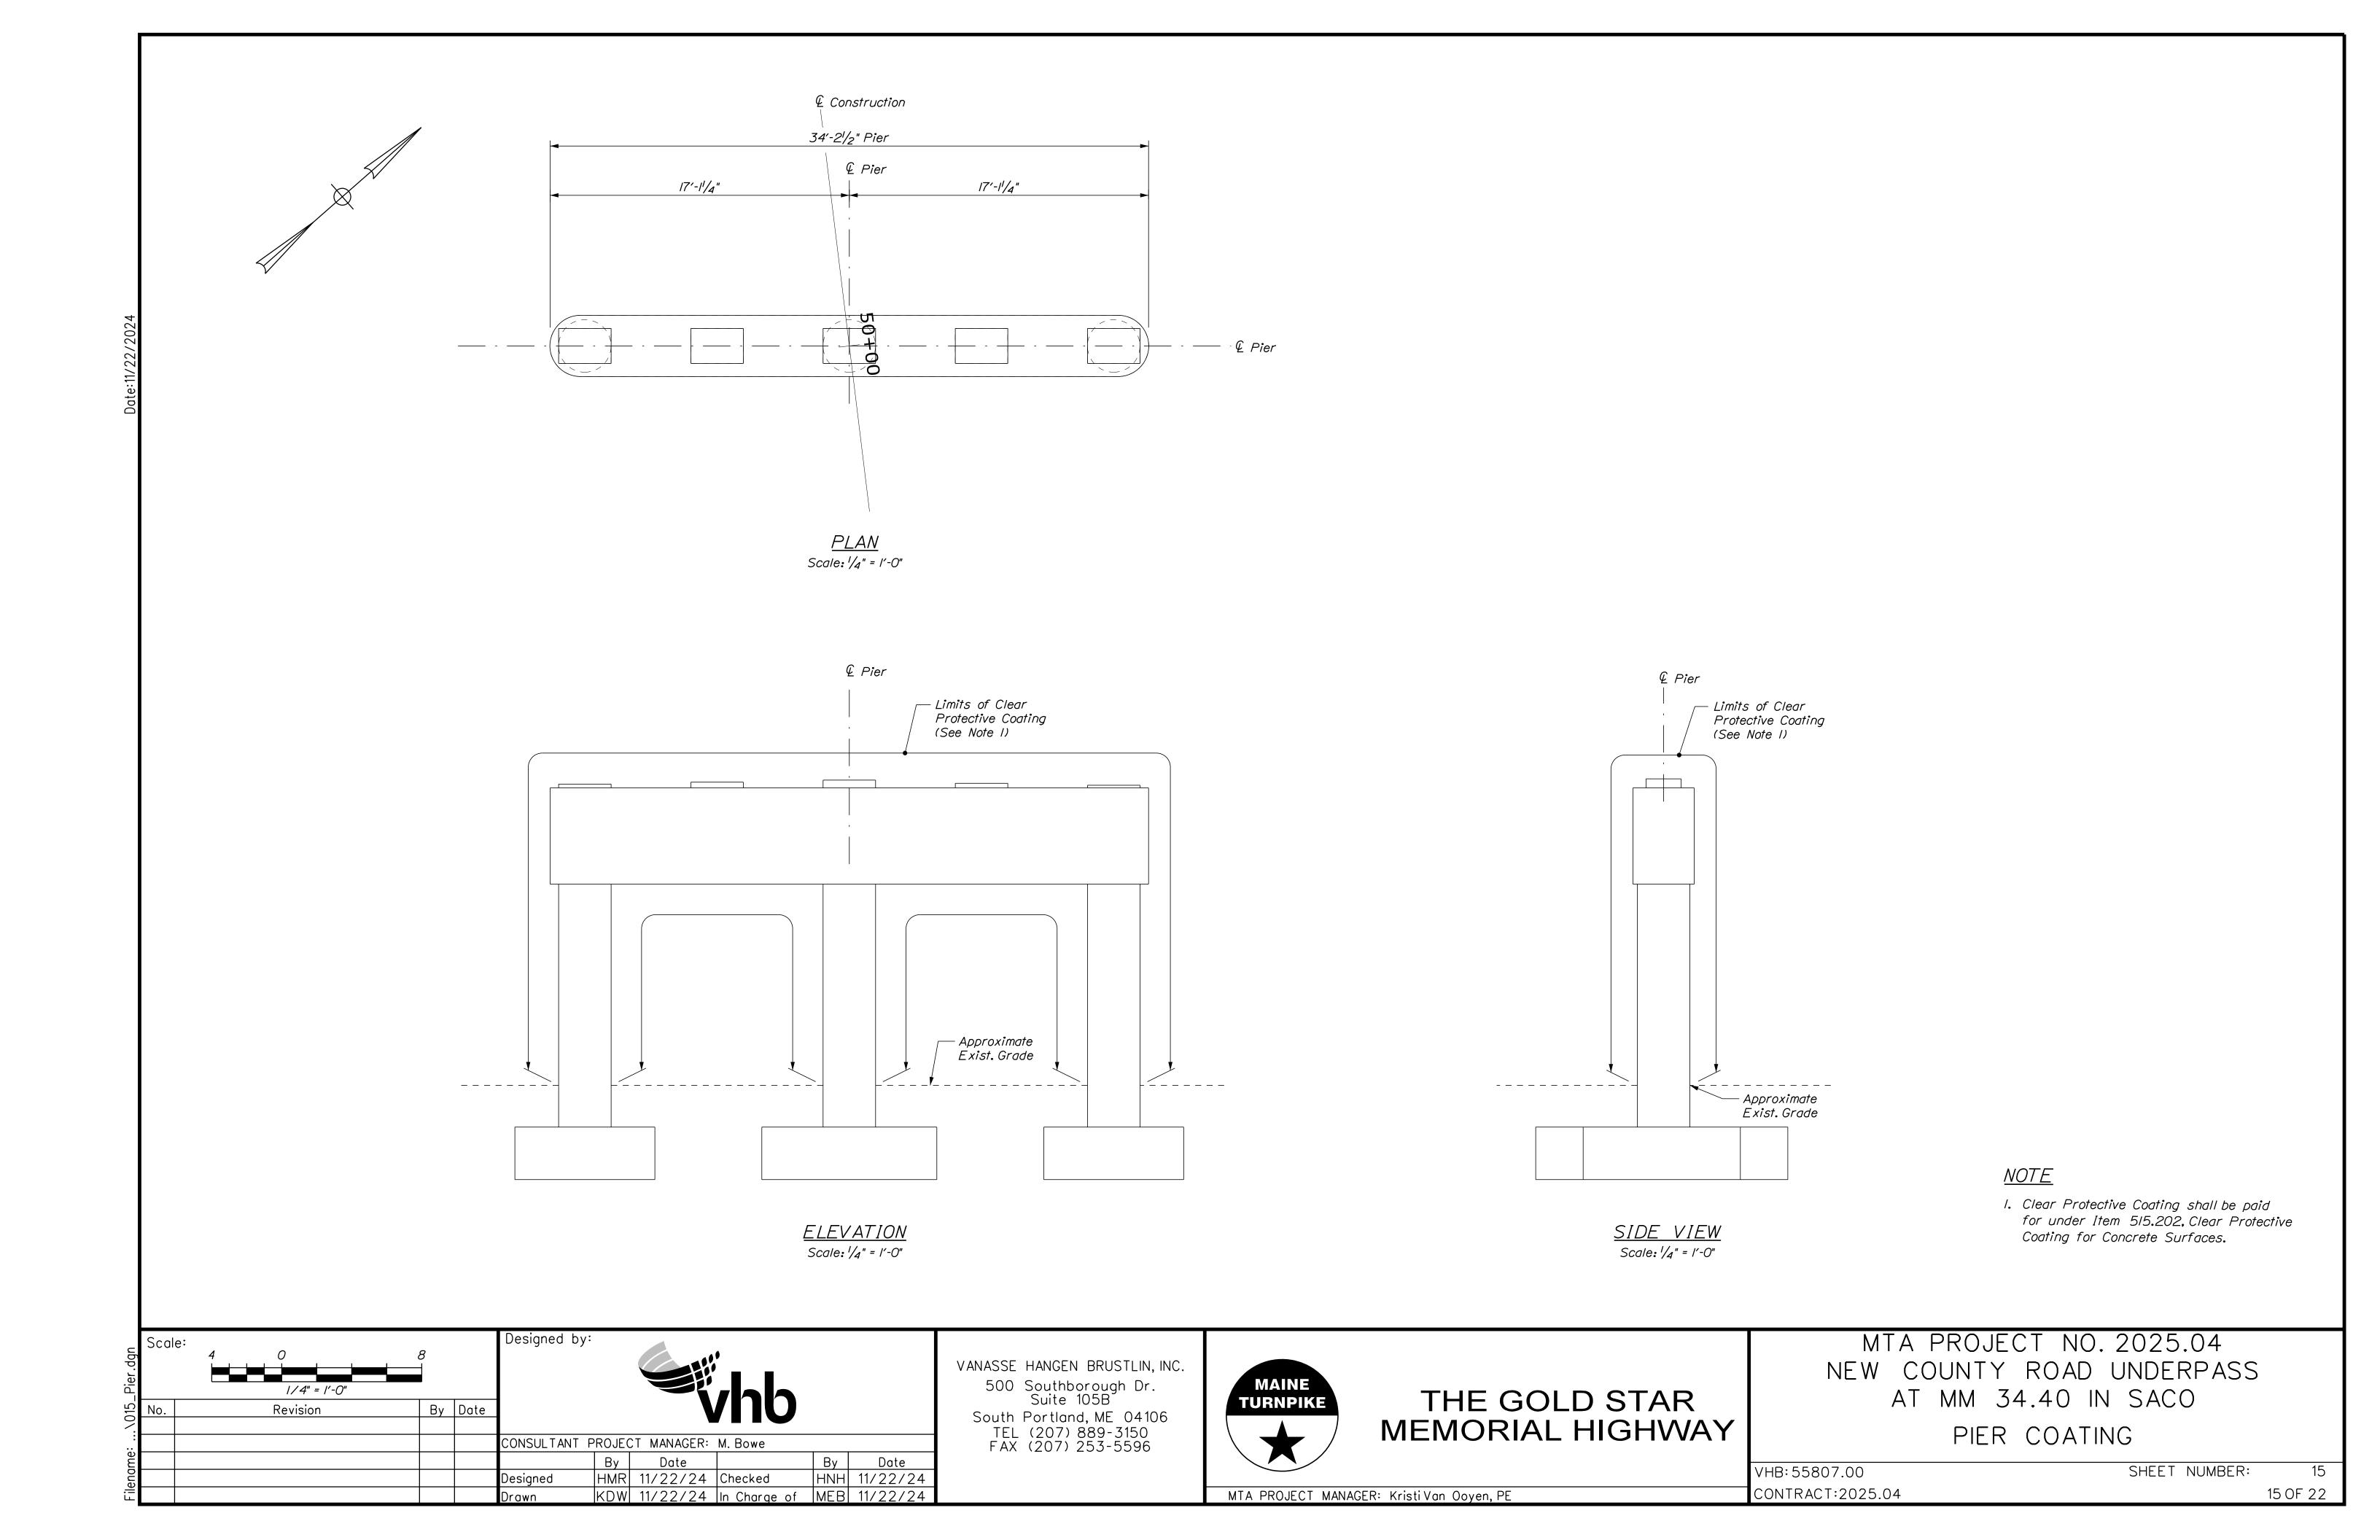
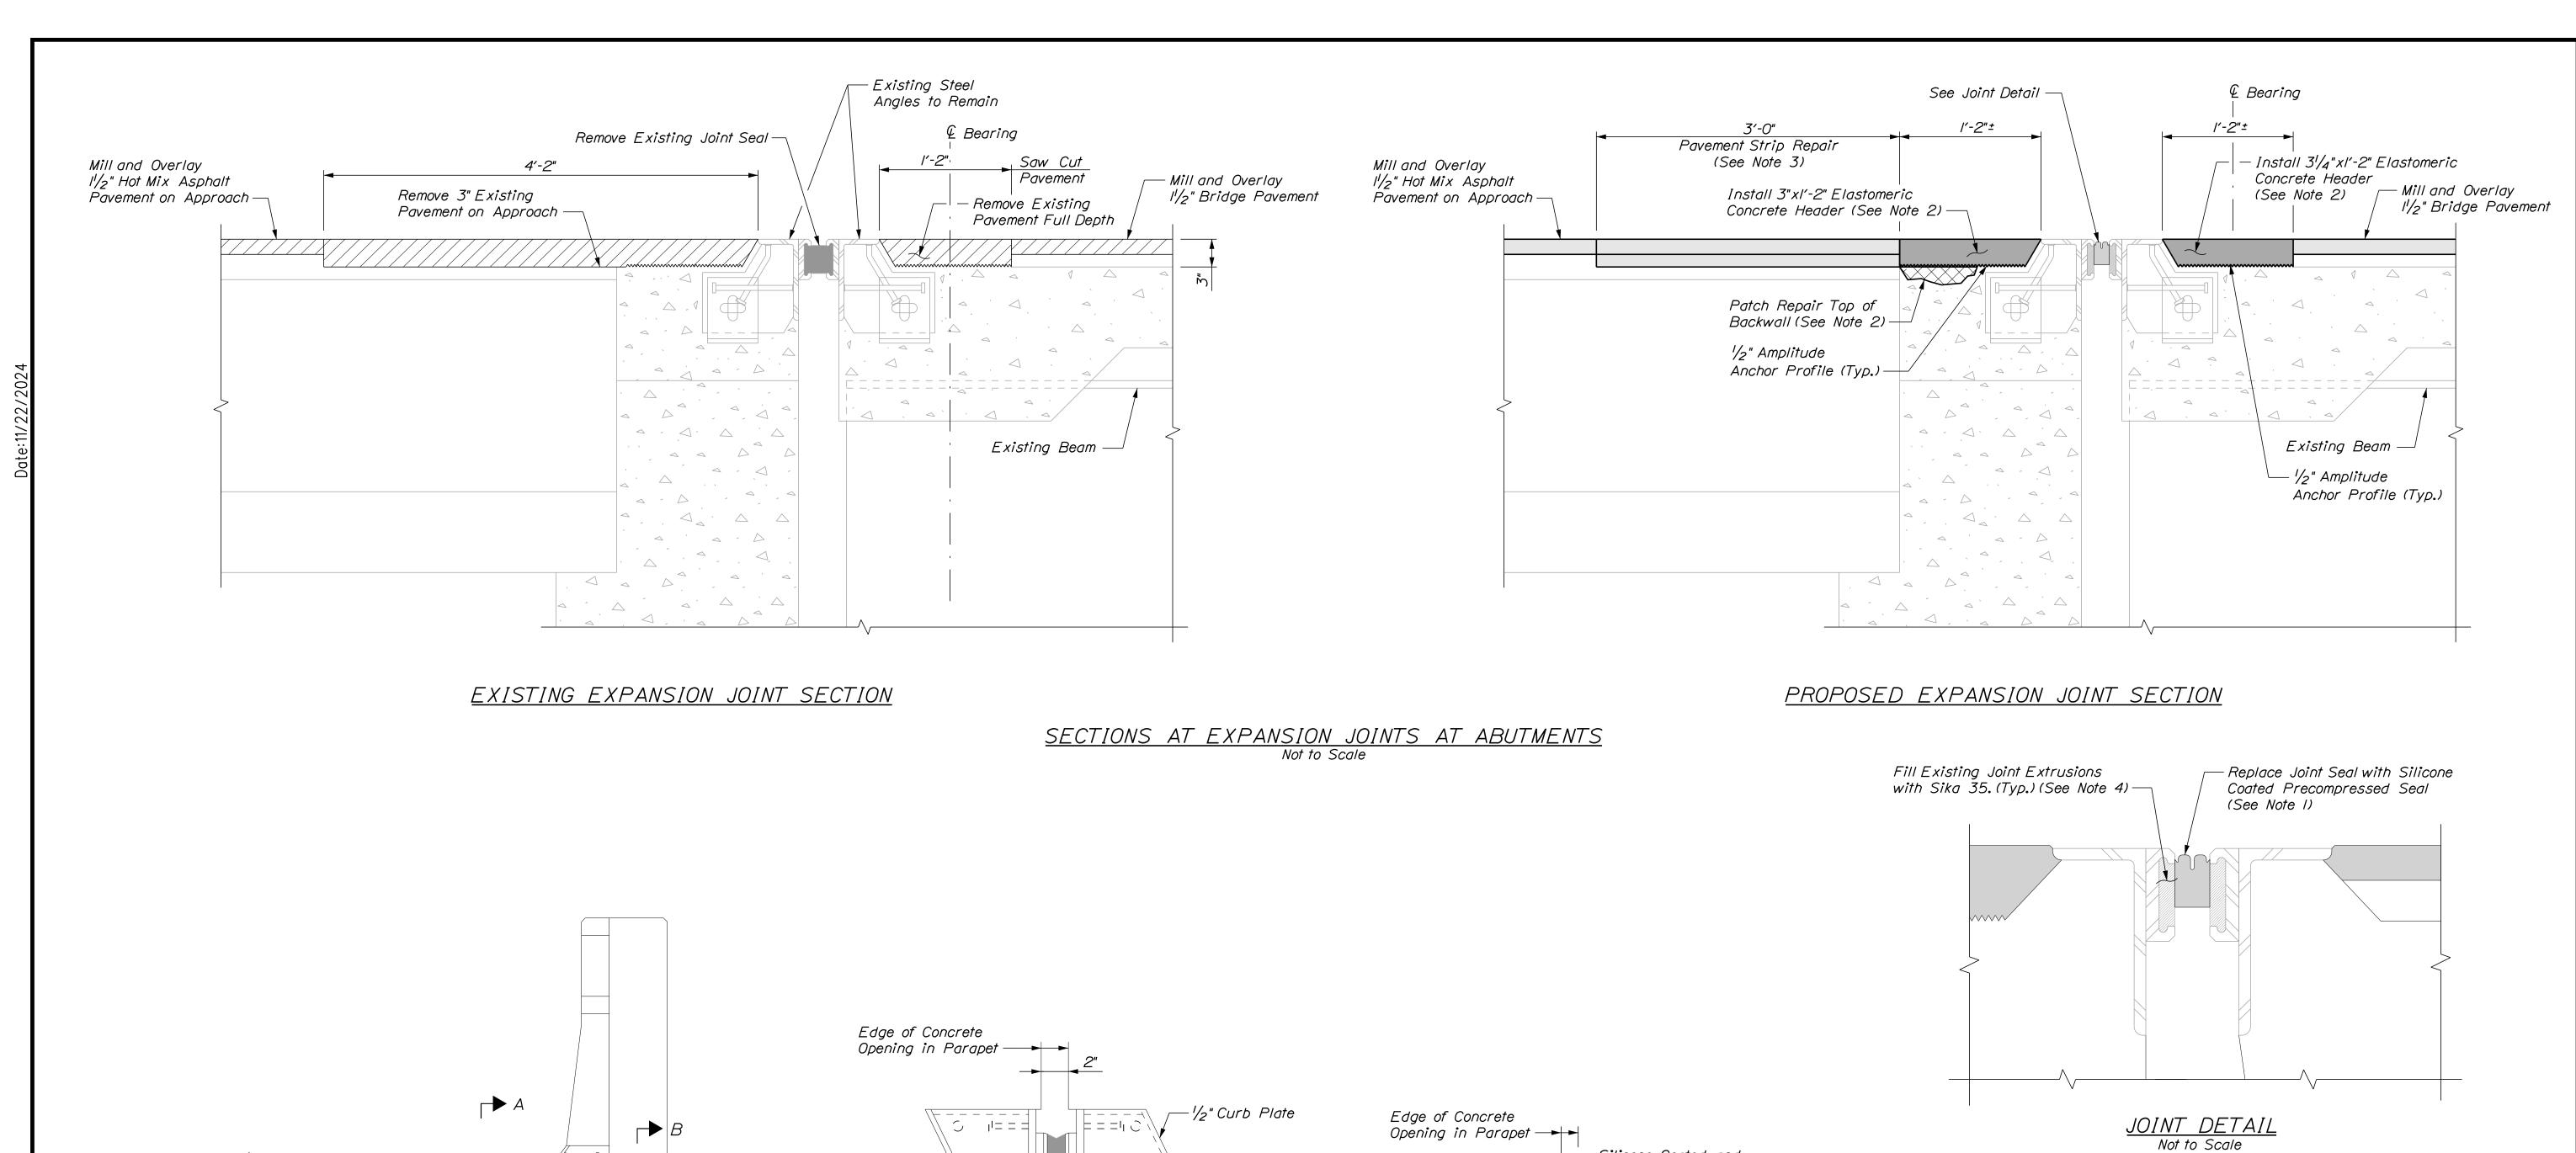
<u>NOTES</u>

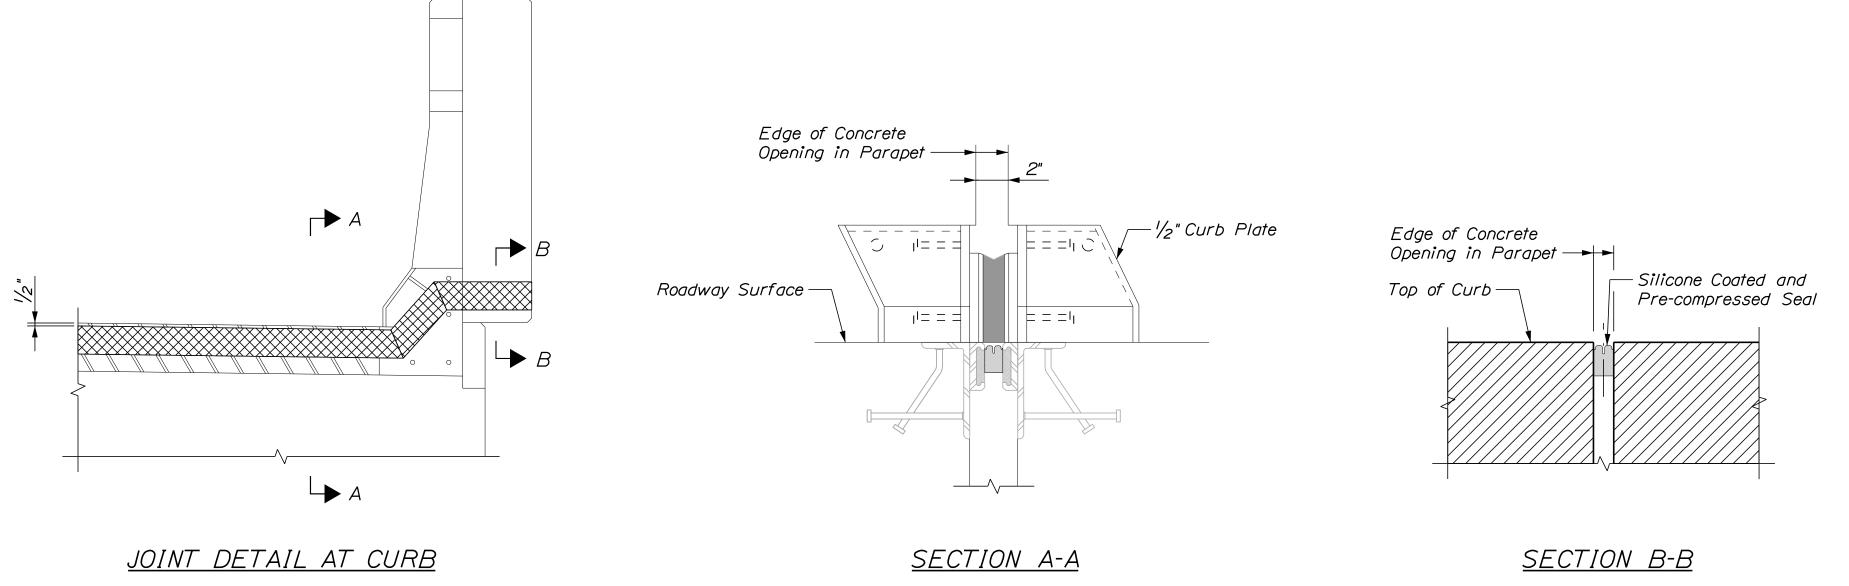- I. Silicone Coated and Pre-Compressed Seal shall be paid under Item 520.234, Expansion Device Silicone Coated and Pre-Compressed Seal.
- 2. Elastomeric Concrete Header shall be paid under Item 518,864, Elastomeric Concrete Header Repair. Prior to placing the elastomeric concrete, the Contractor shall remove any areas of deteriorated concrete in accordance with Supplemental Specification Section 518 and as directed by the Resident. If repairs to the top of the backwall are needed, the Contractor shall repair with elastomeric concrete and repairs shall be paid under Item 518.864, Elastomeric Concrete Header Repair. If repair depth is greater than 3" below the header, the repairs and the concrete header may be done with AAA concrete at the direction of the Resident and paid under Item 518.865, Concrete Header Repair.
- 3. Pavement Strip Repair shall be paid under Item 403.208, Hot Mix Asphalt 12.5mm Nominal Maximum Size.
- 4. Filling existing joint extrusions with Sika 35 shall be incidental to Item 520.234, Expansion Device Silicone Coated and Pre-Compressed Seal.



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CURB DETAIL

Not to Scale


MAINE
TURNPIKE


MTA PROJECT MANAGER: Kristi Van Ooyen, PE

THE GOLD STAR
MEMORIAL HIGHWAY

MTA PROJECT NO. 2025.04
NEW COUNTY ROAD UNDERPASS
AT MM 34.40 IN SACO
BRIDGE JOINT SECTIONS

VHB: 55807.00 SHEET NUMBER: 16 CONTRACT: 2025.04 16 OF 22

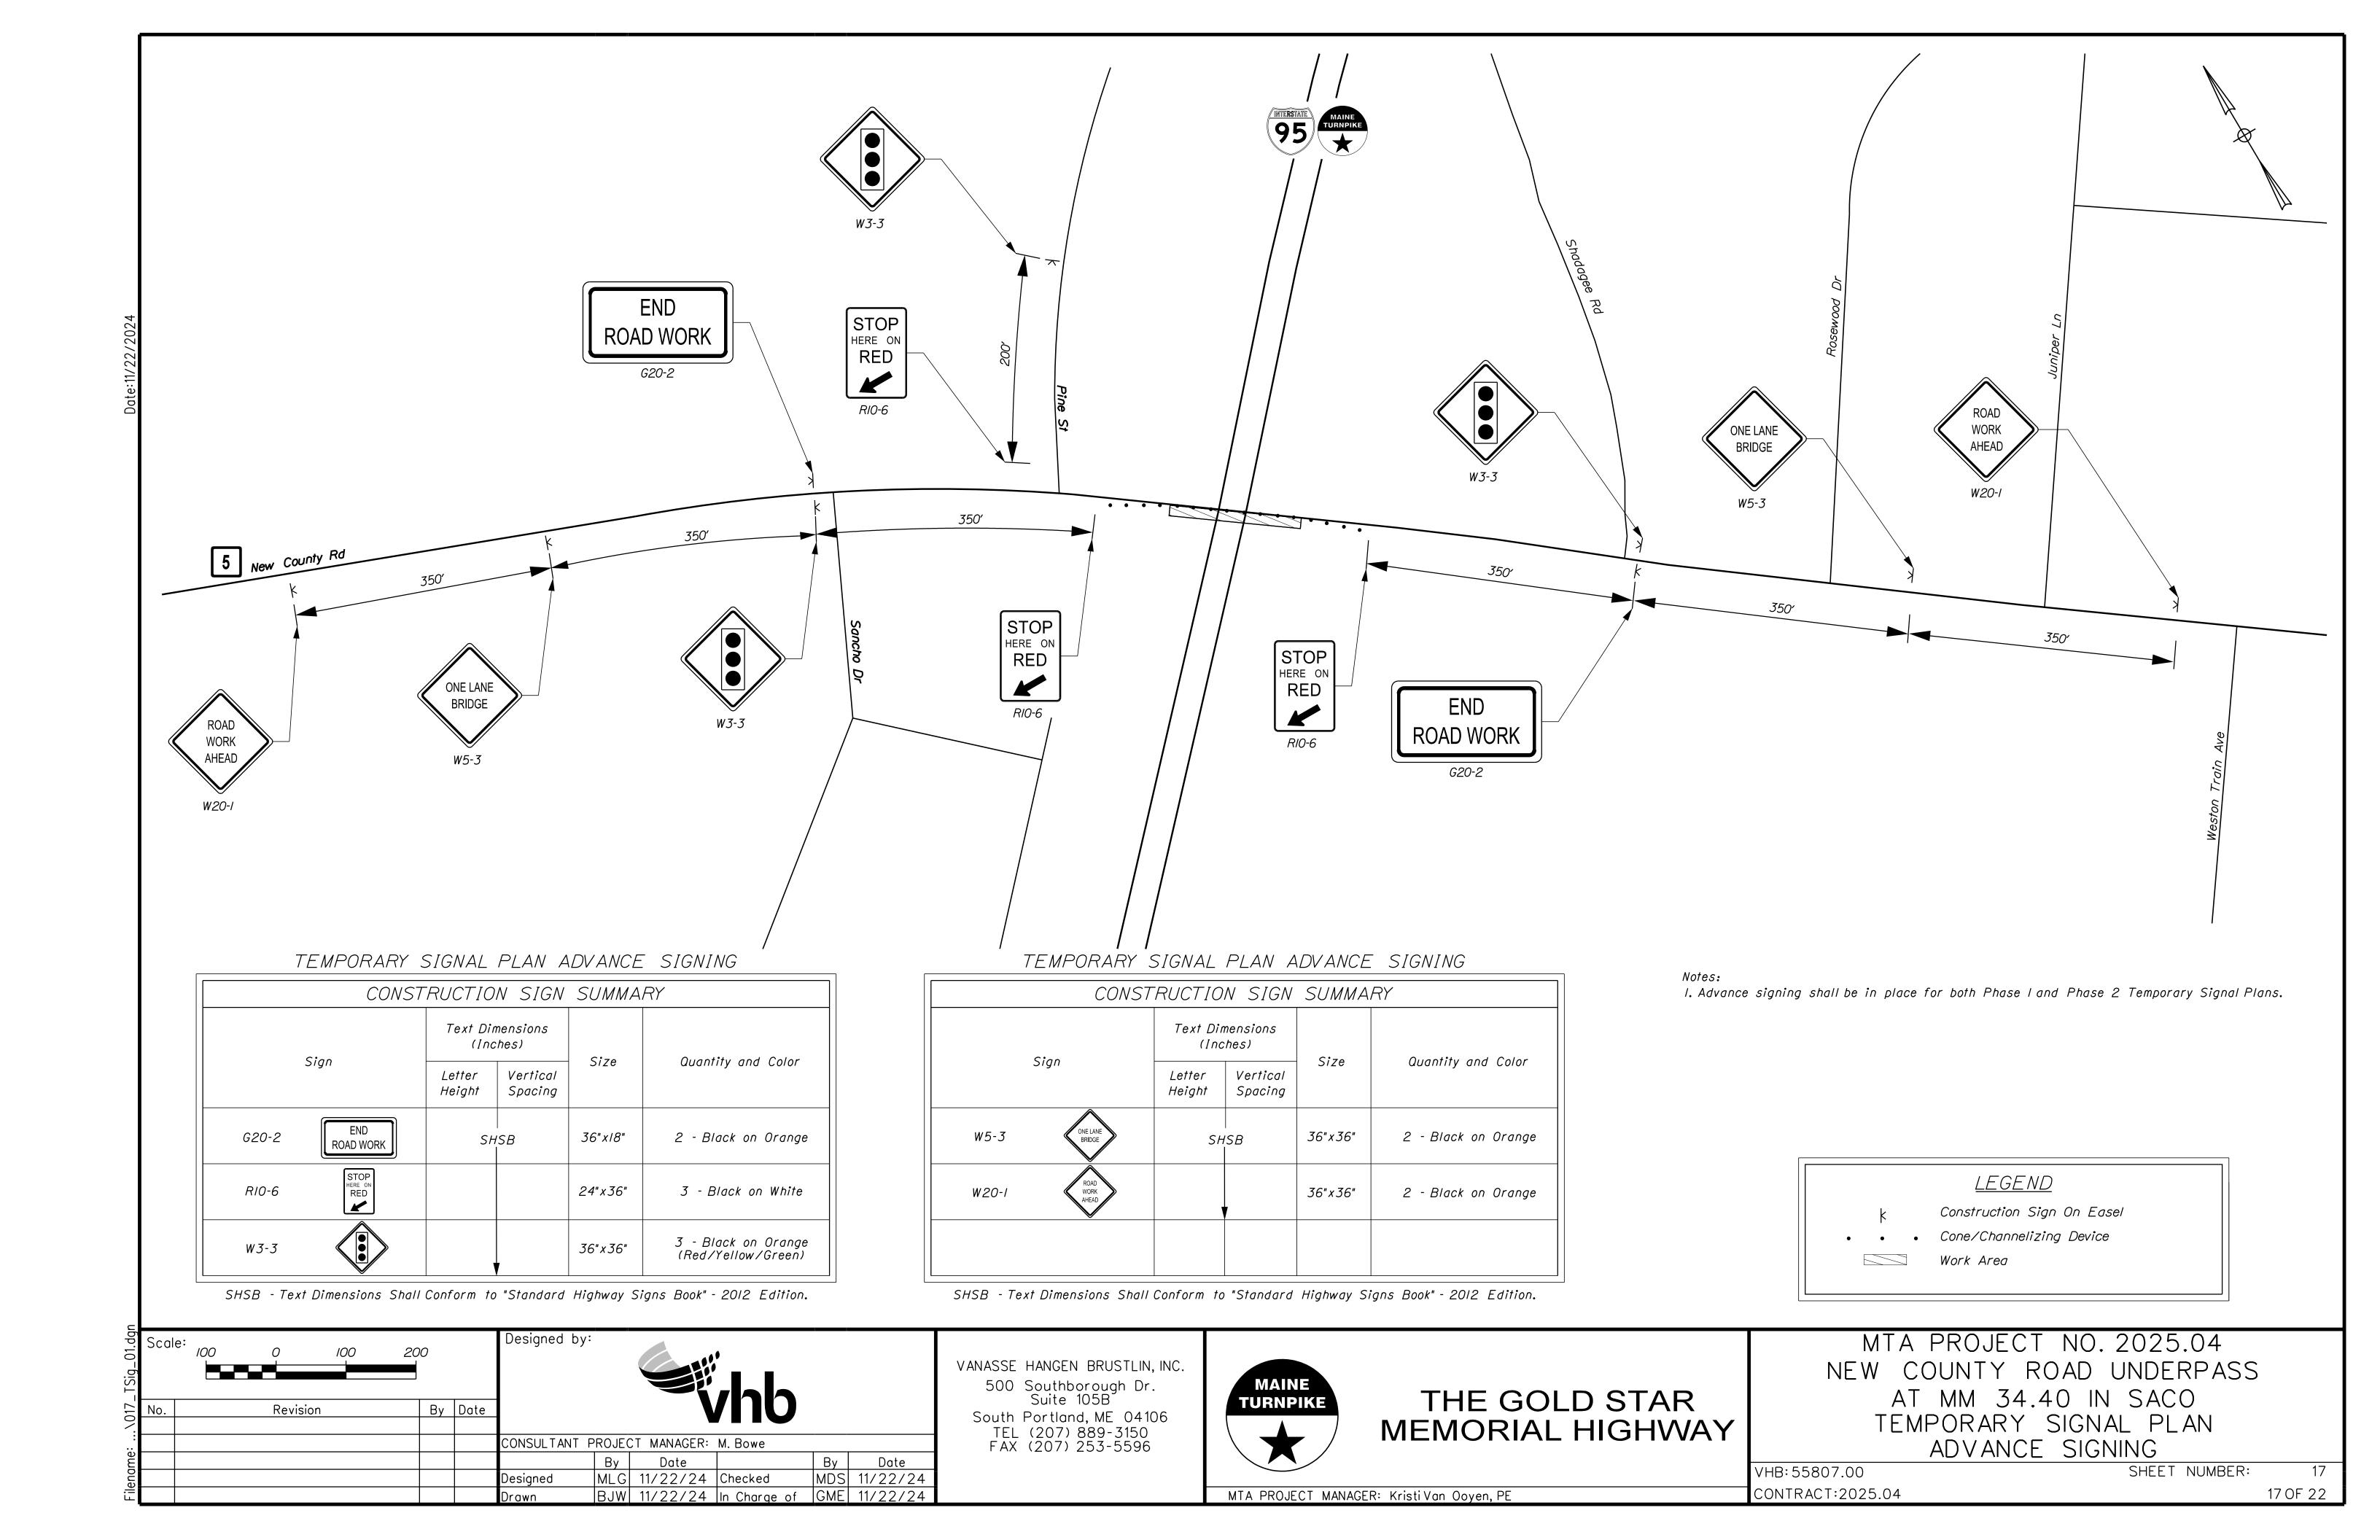

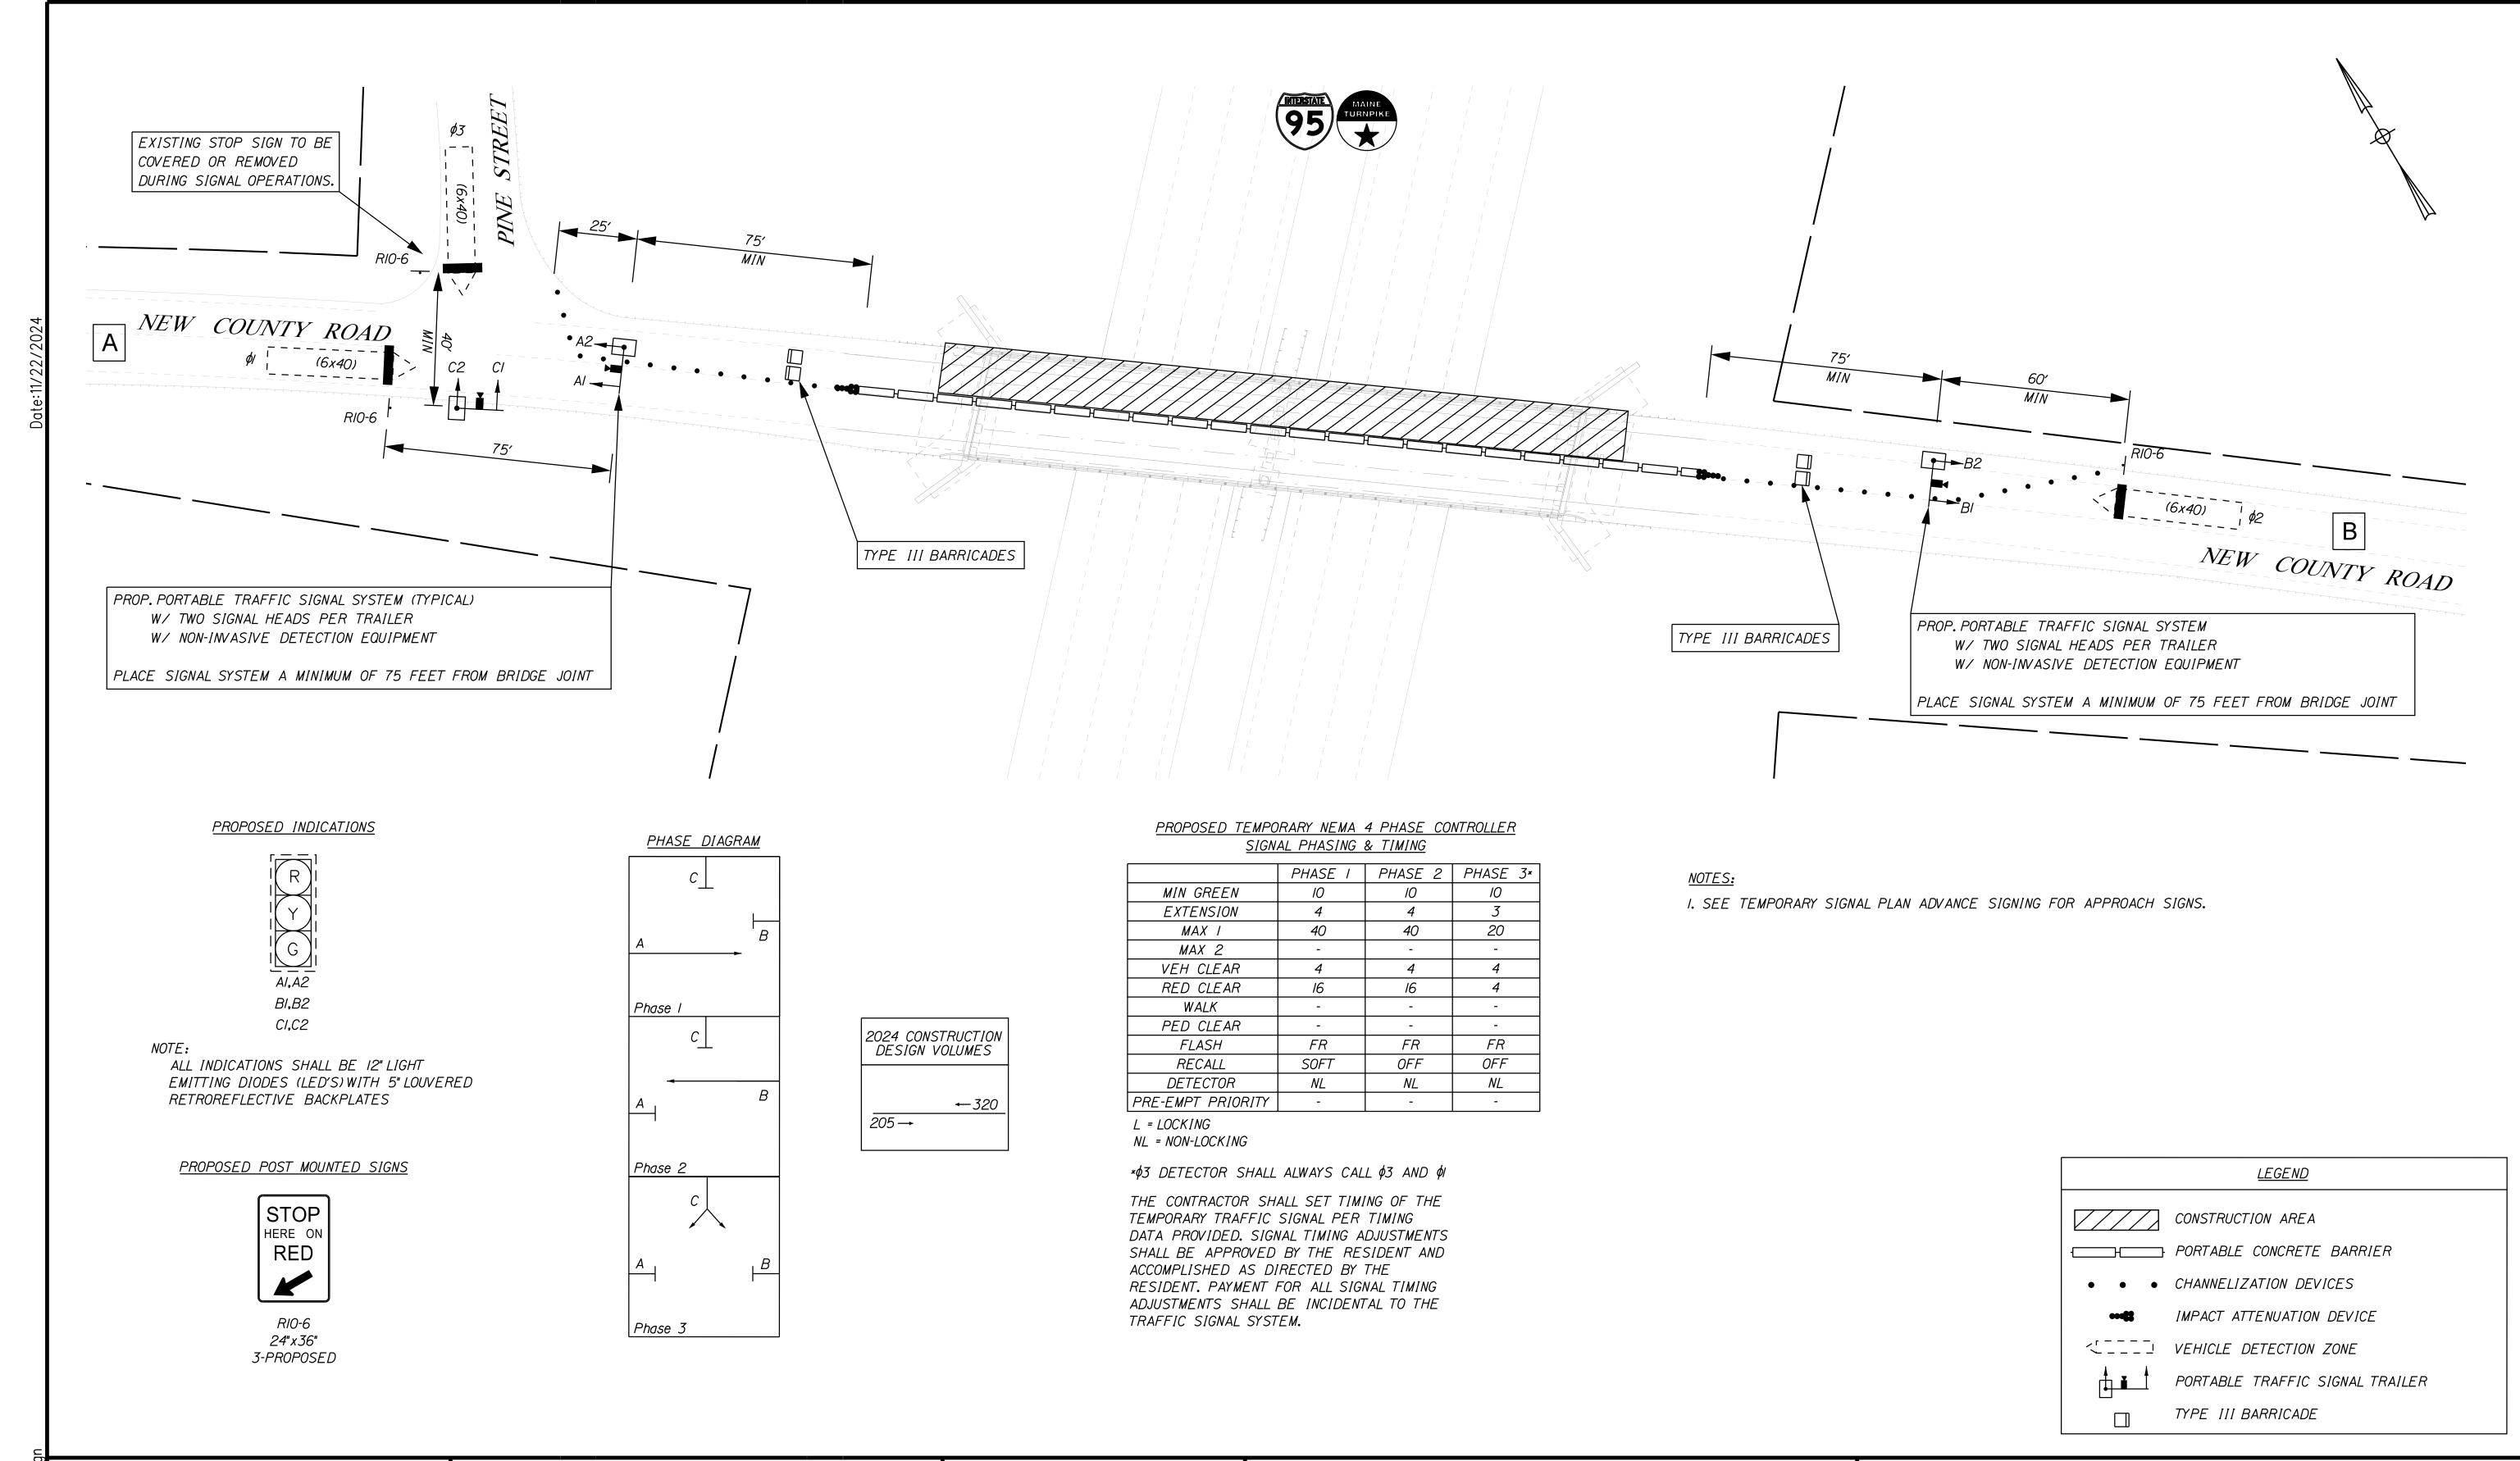

Designed by: By Date Revision CONSULTANT PROJECT MANAGER: M. Bowe By Date Date MLG 11/22/24 Checked MDS 11/22/24 Designed BJW 11/22/24 In Charge of GME 11/22/24

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# THE GOLD STAR MEMORIAL HIGHWAY


MTA PROJECT NO. 2025.04 NEW COUNTY ROAD UNDERPASS AT MM 34.40 IN SACO TEMPORARY SIGNAL PLAN PHASE 1


VHB: 55807.00 CONTRACT:2025.04

SHEET NUMBER:

MTA PROJECT MANAGER: Kristi Van Ooyen, PE

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CONSTRUCTION AREA PORTABLE CONCRETE BARRIER • • CHANNELIZATION DEVICES IMPACT ATTENUATION DEVICE VEHICLE DETECTION ZONE PORTABLE TRAFFIC SIGNAL TRAILER TYPE III BARRICADE
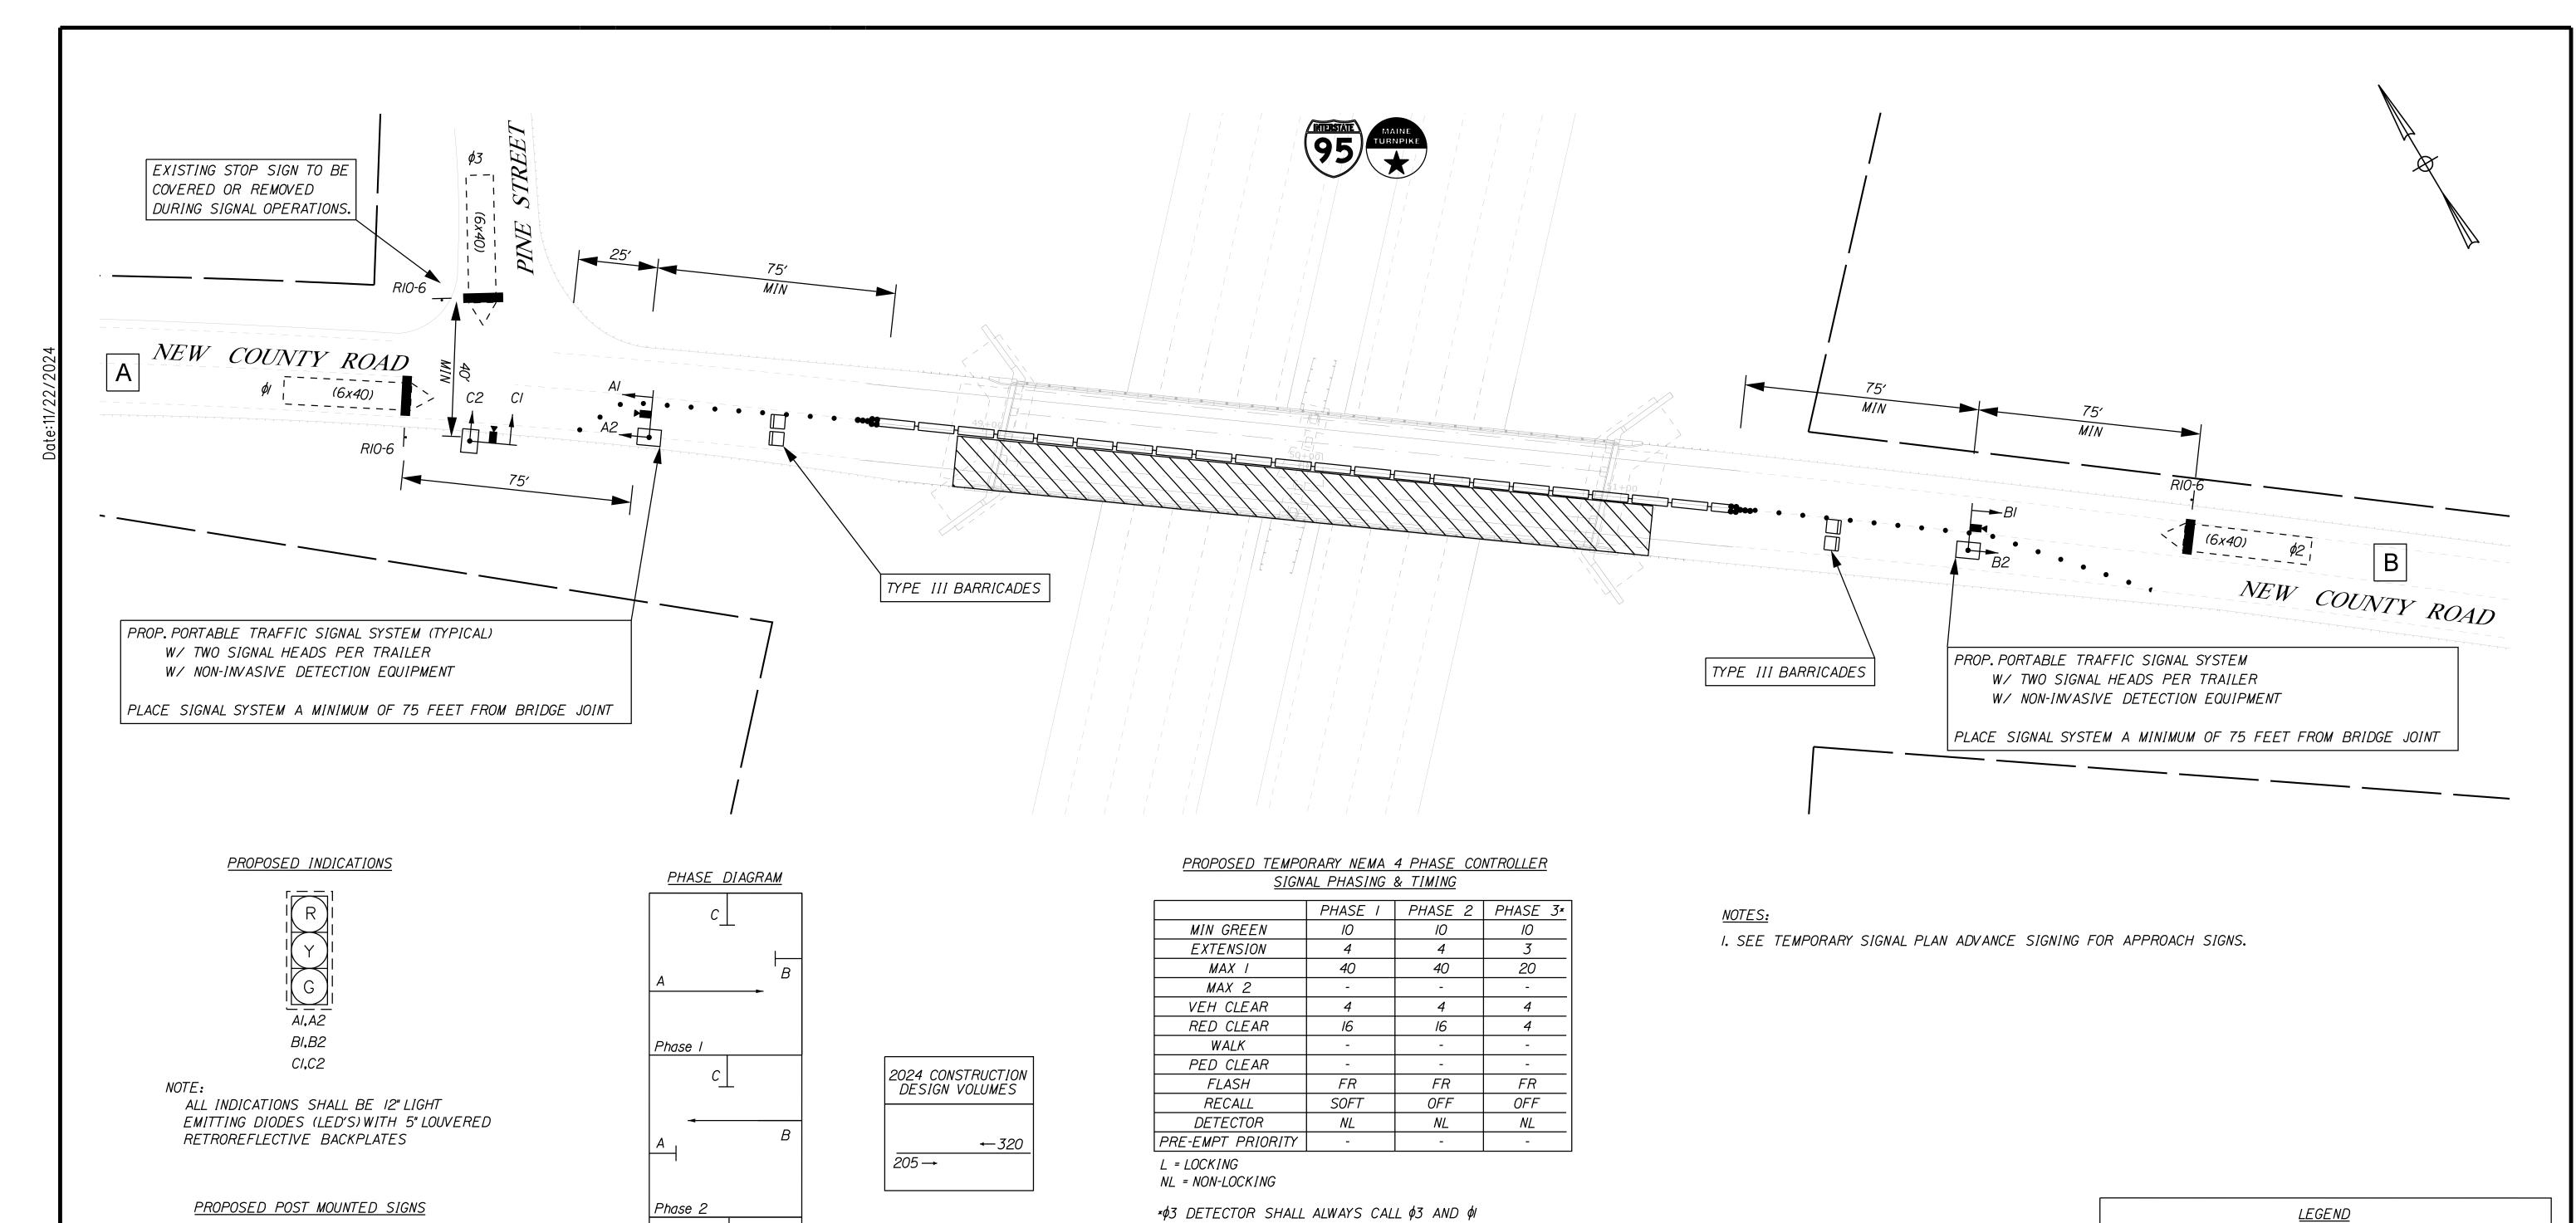
#### Designed by: By Date Revision CONSULTANT PROJECT MANAGER: M. Bowe By Date Date MDS 11/22/24 MLG 11/22/24 Checked Designed BJW 11/22/24 In Charge of GME 11/22/24

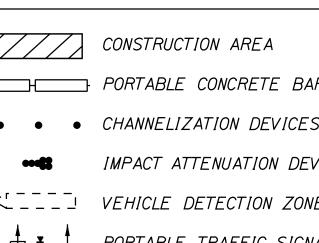Phase 3

STOP

HERE ON

R10-6

24" x 36"

3-PROPOSED

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THE CONTRACTOR SHALL SET TIMING OF THE

DATA PROVIDED, SIGNAL TIMING ADJUSTMENTS

SHALL BE APPROVED BY THE RESIDENT AND

RESIDENT. PAYMENT FOR ALL SIGNAL TIMING ADJUSTMENTS SHALL BE INCIDENTAL TO THE

TEMPORARY TRAFFIC SIGNAL PER TIMING

ACCOMPLISHED AS DIRECTED BY THE

TRAFFIC SIGNAL SYSTEM.


# THE GOLD STAR MEMORIAL HIGHWAY


MTA PROJECT NO. 2025.04 NEW COUNTY ROAD UNDERPASS AT MM 34.40 IN SACO TEMPORARY SIGNAL PLAN PHASE 2

VHB: 55807.00 CONTRACT:2025.04

MTA PROJECT MANAGER: Kristi Van Ooyen, PE

SHEET NUMBER: 19 OF 22

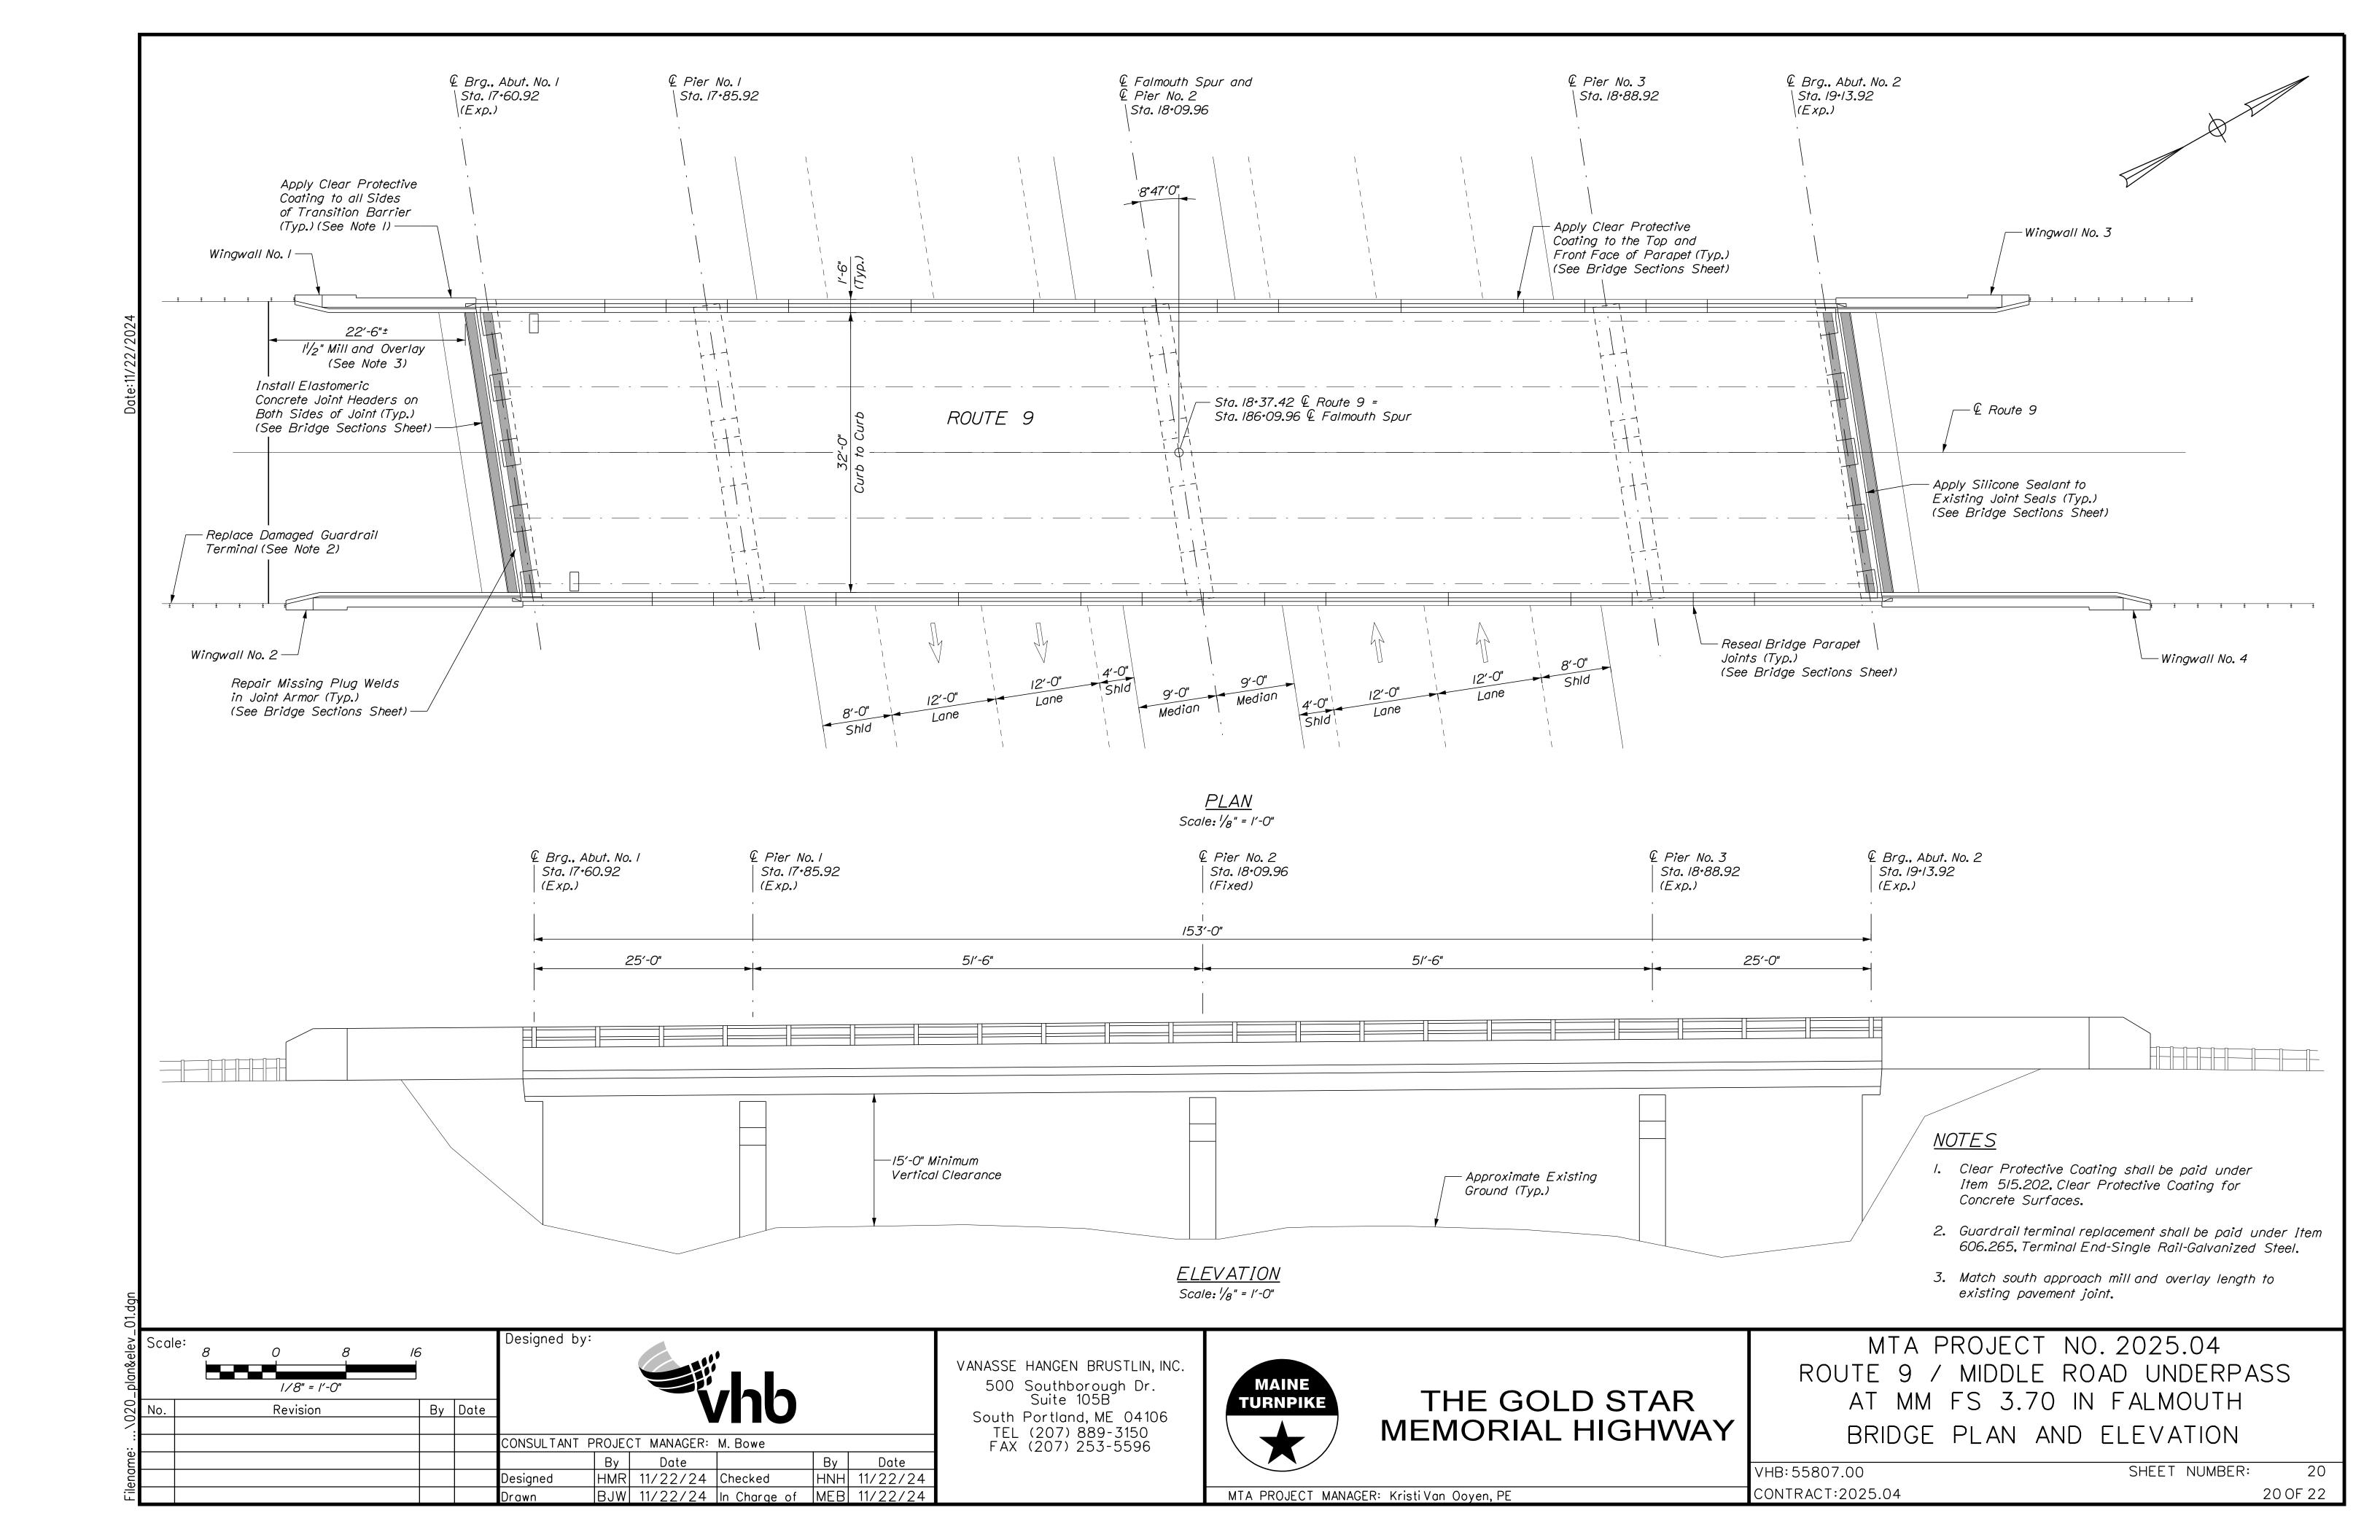

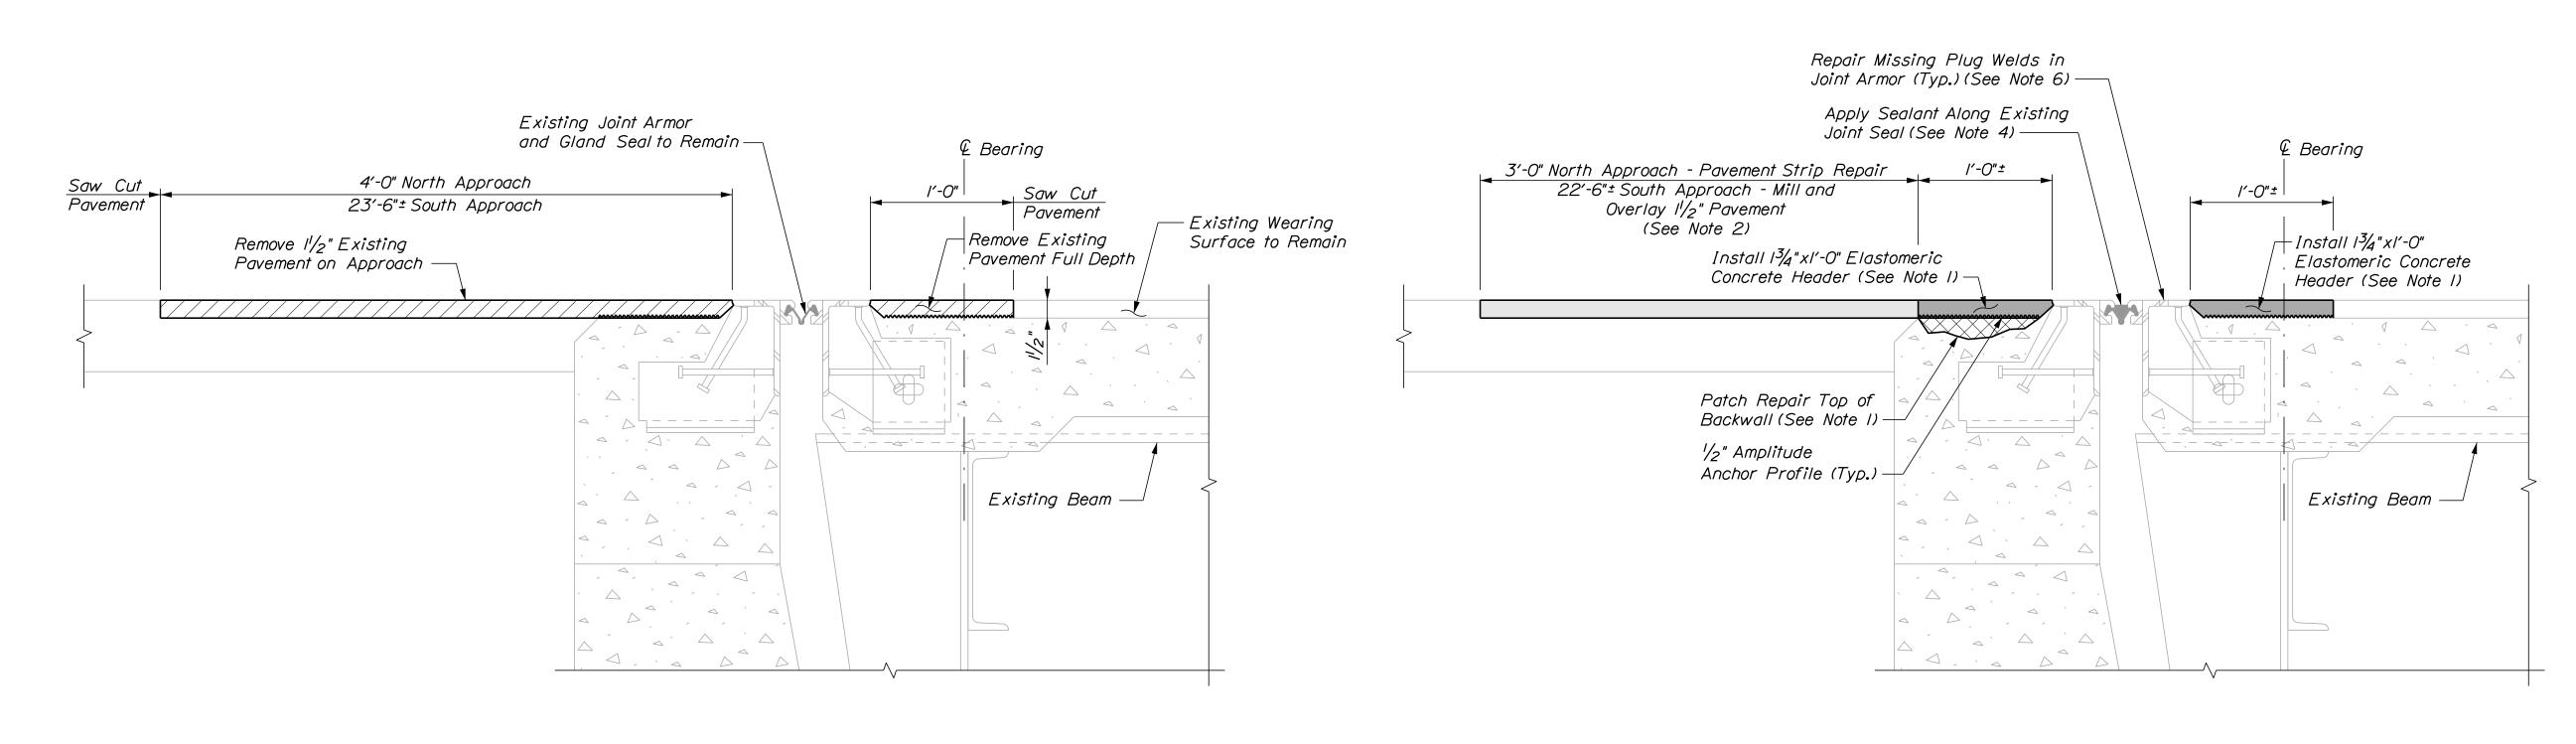

EXISTING EXPANSION JOINT SECTION


PROPOSED EXPANSION JOINT SECTION

<u>NOTES</u>

Nominal Maximum Size.

Coating for Concrete Surfaces.

SECTIONS AT EXPANSION JOINTS AT ABUTMENTS Not to Scale

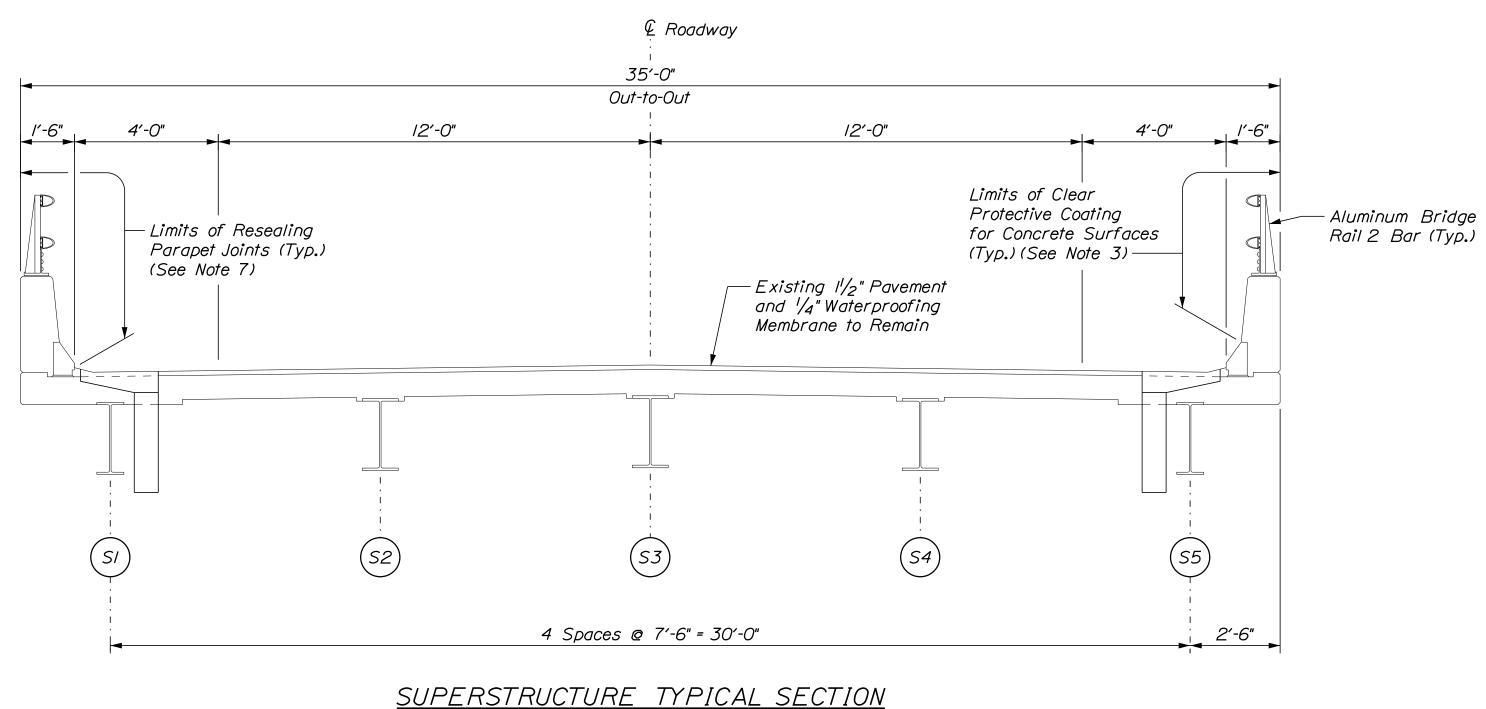

Scale: 3/8" = 1'-0"

Suite 105B



# THE GOLD STAR MEMORIAL HIGHWAY

MTA PROJECT NO. 2025.04 ROUTE 9 / MIDDLE ROAD UNDERPASS AT MM FS 3.70 IN FALMOUTH BRIDGE SECTIONS

I. Elastomeric Concrete Header shall be paid under Item 518.864, Elastomeric

Contractor shall remove any areas of deteriorated concrete in accordance

with elastomeric concrete and repairs shall be paid under Item 518.864,

If repairs to the top of the backwall are needed, the Contractor shall repair

2. Approach Pavement shall be paid under Item 403.210, Hot Mix Asphalt 9.5mm

3. Clear Protective Coating shall be paid under Item 515.202, Clear Protective

4. Joint sealant shall be applied the full length of the joint, including into the curb. The existing joint seal shall be cleaned and inspected by the Resident before applying sealant. The Contractor shall ensure no sealants leaks through any tears in the existing joint seal. Sealant for joint seal shall be paid under

Item 520,40, Joint Seal Repair. See Special Provision 520 for additional details.

6. Repair of missing plug welds in joint armor shall be paid under Item 520.98,

between the parapet and top of curb. Joint sealant shall be from the MaineDOT Qualified Product List for Silicone and Polyurethane Joint Sealant. Resealing

5. Match south approach mill and overlay length to existing pavement joint.

7. Reseal all parapet joints as directed by the Resident including the joint

Joint Weld Repair. See Special Provision 520 for more details.

joints shall be paid under Item 518.48, Reseal Joints.

with Supplemental Specification Section 518 and as directed by the Resident.

Elastomeric Concrete Header Repair. If repair depth is greater than 3" below

the header, the repairs and the concrete header may be done with AAA concrete at

the direction of the Resident and paid under Item 518.865, Concrete Header Repair.

Concrete Header Repair. Prior to placing the elastomeric concrete, the

SHEET NUMBER: 21 210F 22

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South Portland, ME 04106 TEL (207) 889-3150 FAX (207) 253-5596

> VHB: 55807.00 CONTRACT:2025.04

MTA PROJECT MANAGER: Kristi Van Ooyen, PE

By Date Revision CONSULTANT PROJECT MANAGER: M. Bowe By Date Date | HMR | 11/22/24 | Checked |HNH| 11/22/24 Designed BJW 11/22/24 In Charge of MEB 11/22/24

Designed by:

Scale:

3/8" = 1'-0"

