MAINE TURNPIKE AUTHORITY

ADDENDUM NO. 4

CONTRACT 2025.11

AUBURN VEHICLE STORAGE GARAGE

MILE 76.9

The bid opening date is June 17, 2025 at 11:00 A.M.

A pre-bid conference was held on May 13, 2025 at 10:00 A.M. at Maine Turnpike Authority.

A site walk-thru was held on Wednesday May 14, 2025 at 2:00 P.M. at Maine Turnpike's Auburn Maintenance Facility.

The following changes are made to the Proposal, Specifications and Plans. Refer to the Questions section for additional information.

GENERAL

All questions regarding Contract 2025.11 should be submitted by Noon on June 11, 2025 to be answered by Addendum on or before June 13, 2025. Questions received after that time may not be answered.

PROPOSAL

Intentionally left blank.

SPECIFICATIONS

1. Special Provision Section 263213 Engine Generators, Part 2, 2.2.C.1 Capacities and Characteristics, Power Ratings, page 263213-5: Contractor shall make a 'pen and ink' change by deleting "125 KW" and inserting "60 KW".

PLANS

- 1. Plan sheet 20 of 36 Details (Revised): Contractor shall make a 'pen and ink' change by deleting the words "Liner Panel" from Details 9 thru 15, and adding in its place, "Metal Closure Trim".
- Plan sheet 32 of 36 Electrical Site Plan: Contractor shall delete Sheet 32 of 36 Electrical Site Plan and replace with Sheet 32 of 36 Electrical Site Plan, with Revision Block noting Addendum #4 and dated 6/12/2025. The revised sheet provides clarification to the Electrical Equipment Enclosure and additional details for enclosed electrical equipment.
- 3. Plan sheet 33 of 36 Lighting Plan: Contractor shall delete Sheet 33 of 36 Lighting Plan and replace with Sheet 33 of 36 Lighting Plan, with Revision Block noting Addendum #4 and dated 6/12/2025. The revised sheet provides additional information for the Electrical Equipment Enclosure lighting.

4. Plan sheet 36 of 36 – Power Riser Diagram: Contractor shall delete Sheet 36 of 36 – Power Riser Diagram and replace with Sheet 36 of 36 – Power Riser Diagram, with Revision Block noting Addendum #4 and dated 6/12/2025. The revised sheet provides clarification to the electrical equipment within the electrical equipment enclosure.

OUESTIONS

The following are questions submitted to the Maine Turnpike Authority in writing. Answers to the questions are noted. Bidders shall utilize this information in preparing their bid.

- Question 1:What size generator is required, 60kw or 125kw?Answer:The generator output is to be a 60kw .
- Question 2:Please clarify the need for a liner panel as shown on some of the details on sheet 20 of 36.Answer:Contractor shall make the following 'pen and ink' change to Details 9 thru 15
on sheet 20 of 36: Delete the words "Liner Panels" and change to "Metal
Closure Trim".
- Question 3:A fire alarm vender brought to my attention there are no horn/strobes shown on the
drawing. To meet code, he believes there should be some. Also, the drawings do show 8
flame detectors which is not common or necessary for garage spaces. Please advise.Answer:Horn/strobes are required per plan; see sheet 14 of 36. Flame detectors shall be
provided per plan.
- Question 4: Please advise if there is a contact for the 8x8x8 metal building shown on the electrical drawings ES100 page 32. At this time, Hoffman does not have this size, and none of the local metal builders will build this.
 - Answer: This is not intended to be a building. It is a simple electrical equipment enclosure. The intent is an 8'x8'x9' tall stainless steel metal, enclosure with metal roof. The enclosure shall be secured to the concrete pad. If Hoffman does not offer the size requested, alternate manufacturers or alternate sizes will be considered. Revised electrical drawings included with this addendum are offered to clarify the design intent. Note that all panels/meters shall be mounted to Unistrut and that the Unistrut is free standing and not mounted to the enclosure. All electrical panels/ats/equipment shall be Nema 3R.

ATTACHMENTS

- (This document Addendum #4 (three pages))
- Specifications (none)
- Plans (three pages)

Notes: The above items shall be considered as part of the bid submittal.

The total number of pages included in this addendum is six (6) pages.

All bidders are requested to acknowledge the receipt of the Addendum No. 4 by signing below and emailing this sheet to Nathaniel Carll, Purchasing Department, Maine Turnpike Authority at ncarll@maineturnpike.com. Bidders are also required to acknowledge receipt of this Addendum No. 4 on Page P-8 of the bid package.

Business Name

Print Name and Title

Signature


Date


Very truly yours,

MAINE TURNPIKE AUTHORITY

Nathaniel Carll Purchasing Department Maine Turnpike Authority

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A1	ELECTRICAL S	ITE PLAN OVERHEA	D			
1" = 30'-0" Scale:			Designed by:			
			y	Bring-H	an iiii	BRIAN T. GARDNER No. 15506
As indicated	Revision	By Date	Anthony S. Davis, PE	, ,		BRIAN T. GARDNER No. 15506
1 Addendum 2 Addendum	n #3	SO 05/16/2025 SO 0612/2025			1	CENSEN SS /ONAL EN
			Designed:	By Date BTG 04/25/2025	Checked:	By BTG 0
			Drawn:	PMC 04/25/2025		

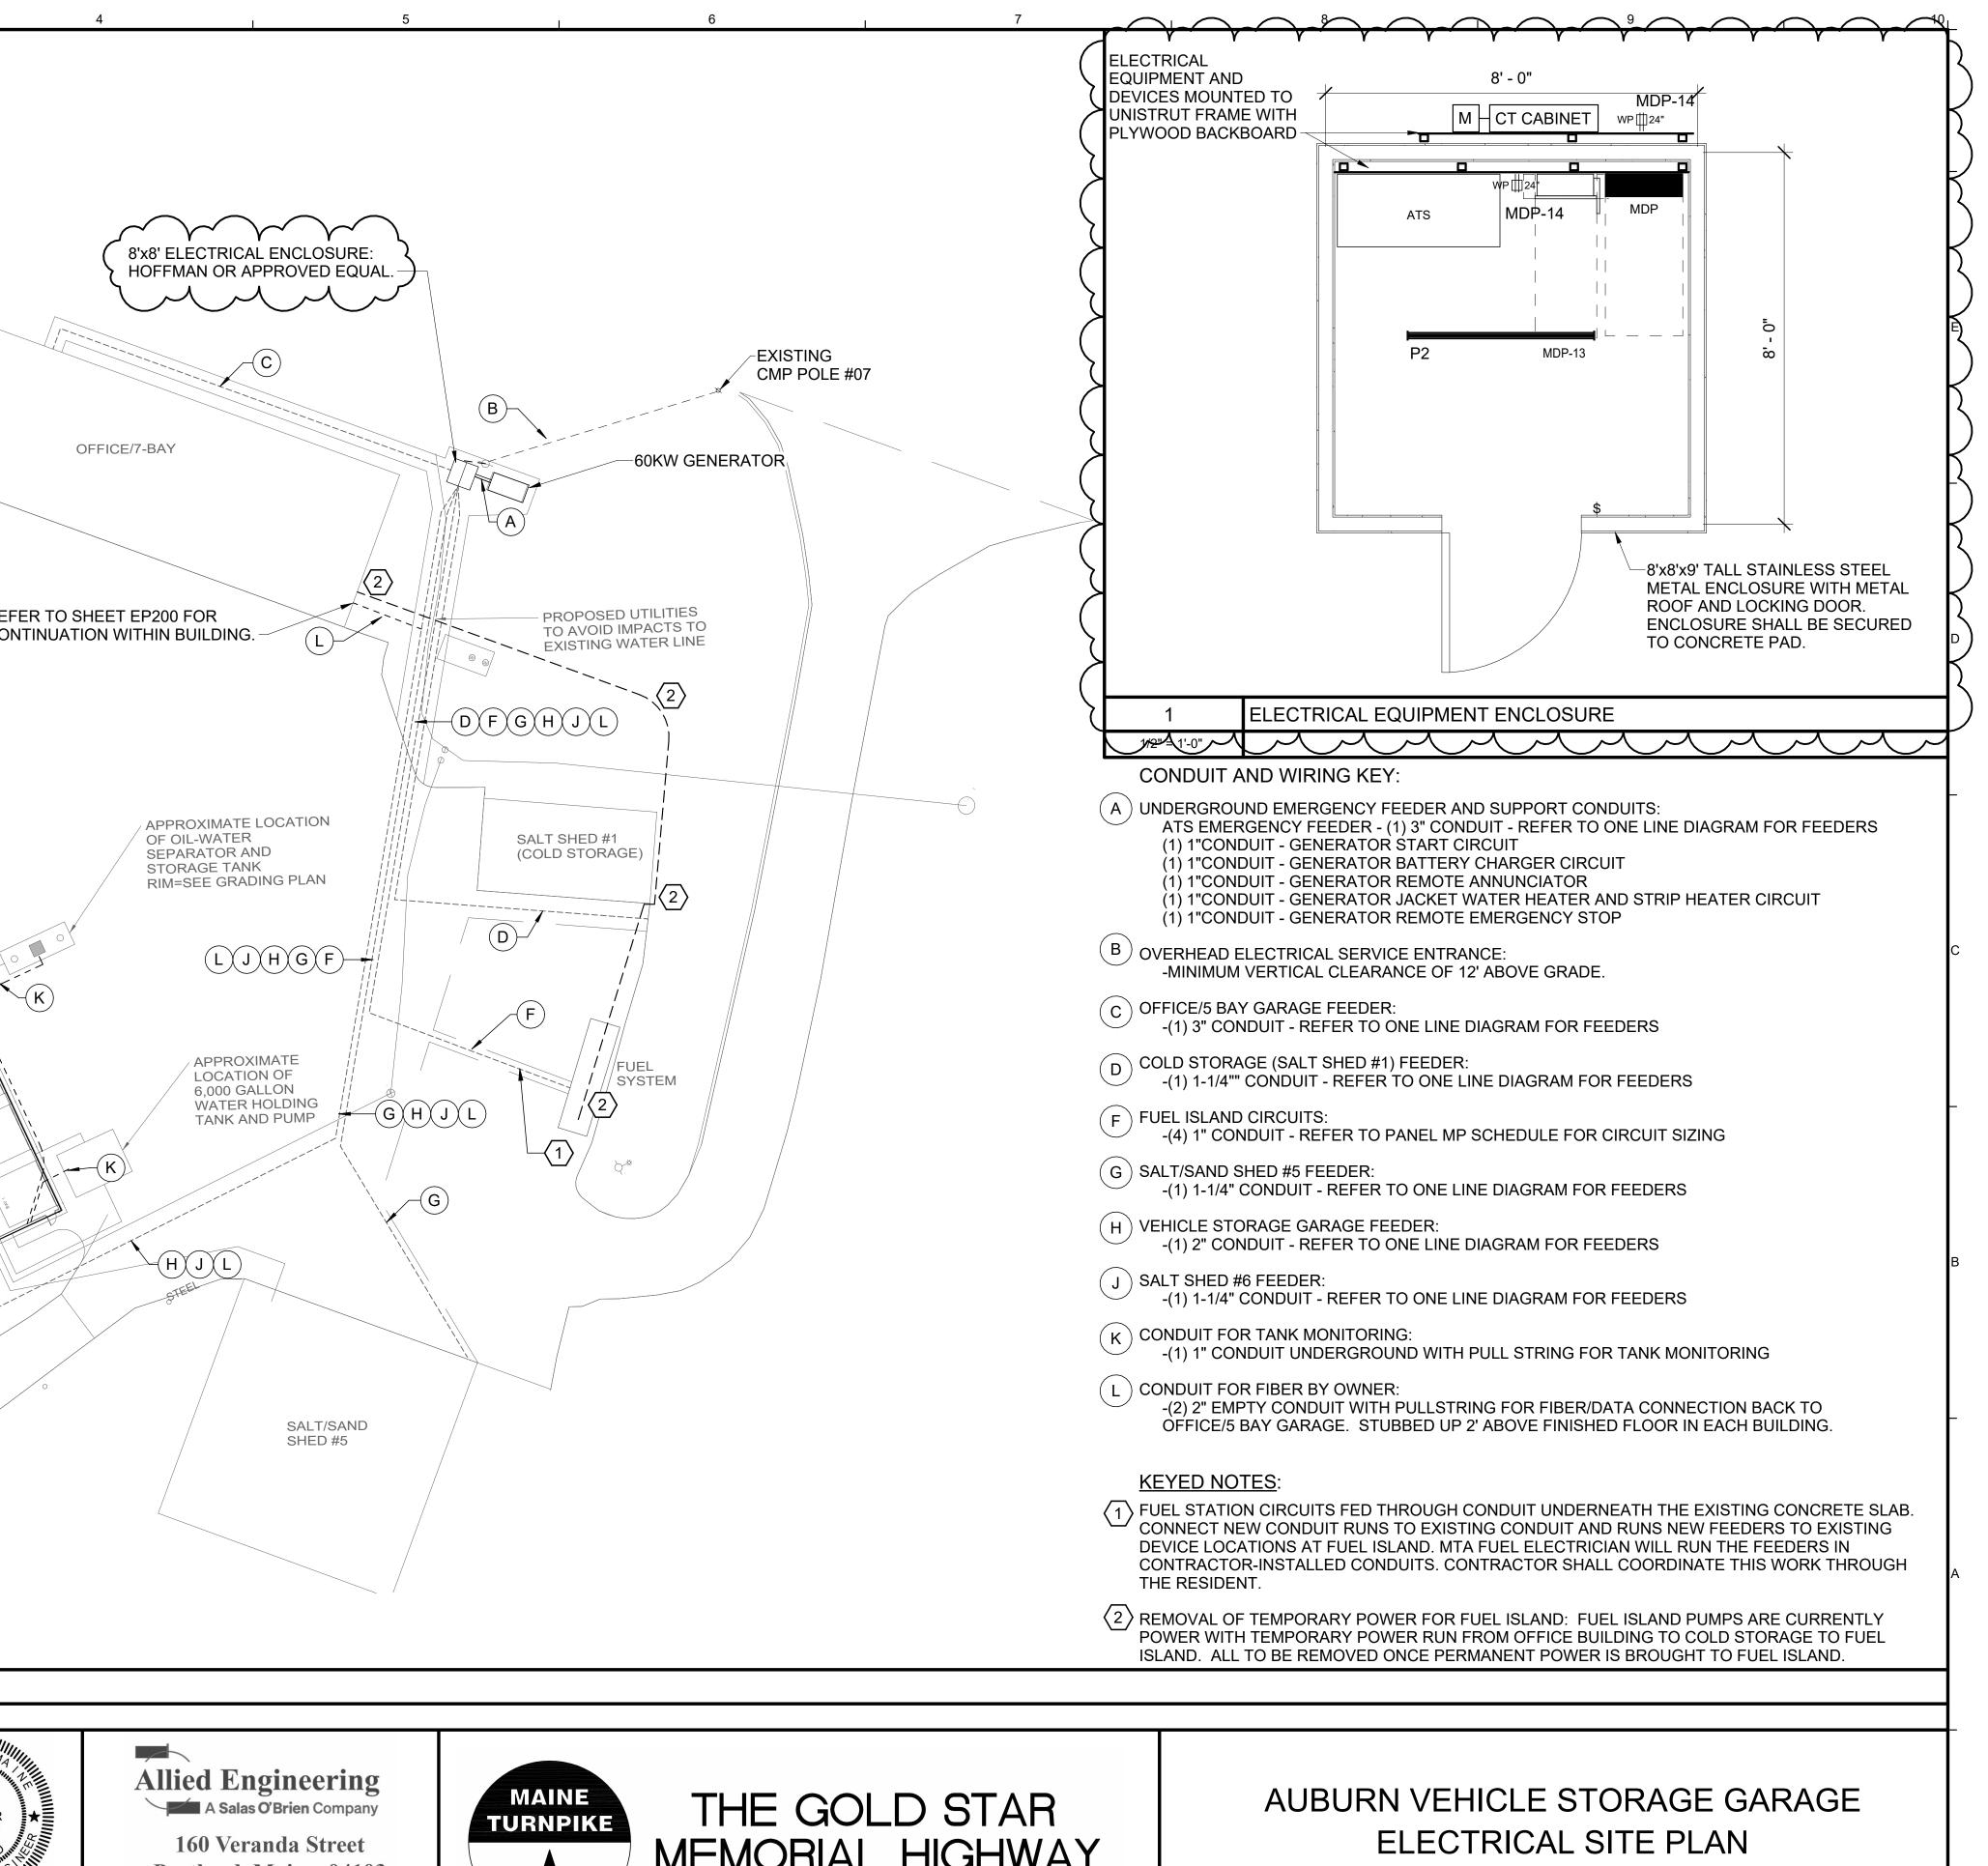


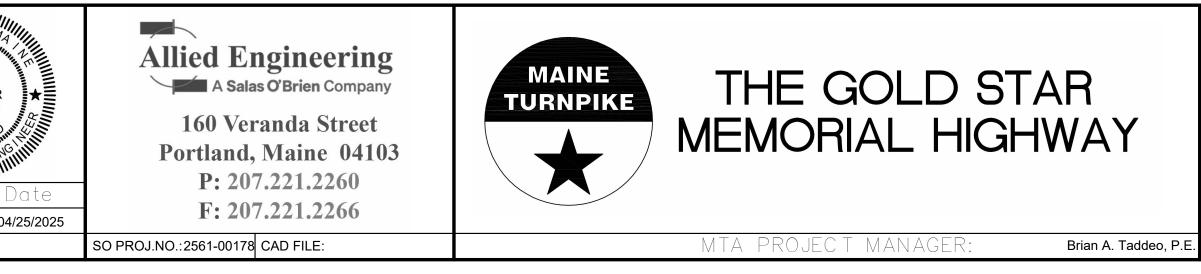

CONTRACT: 2025.11

SHEET NUMBER: **ES100**

32 OF 36

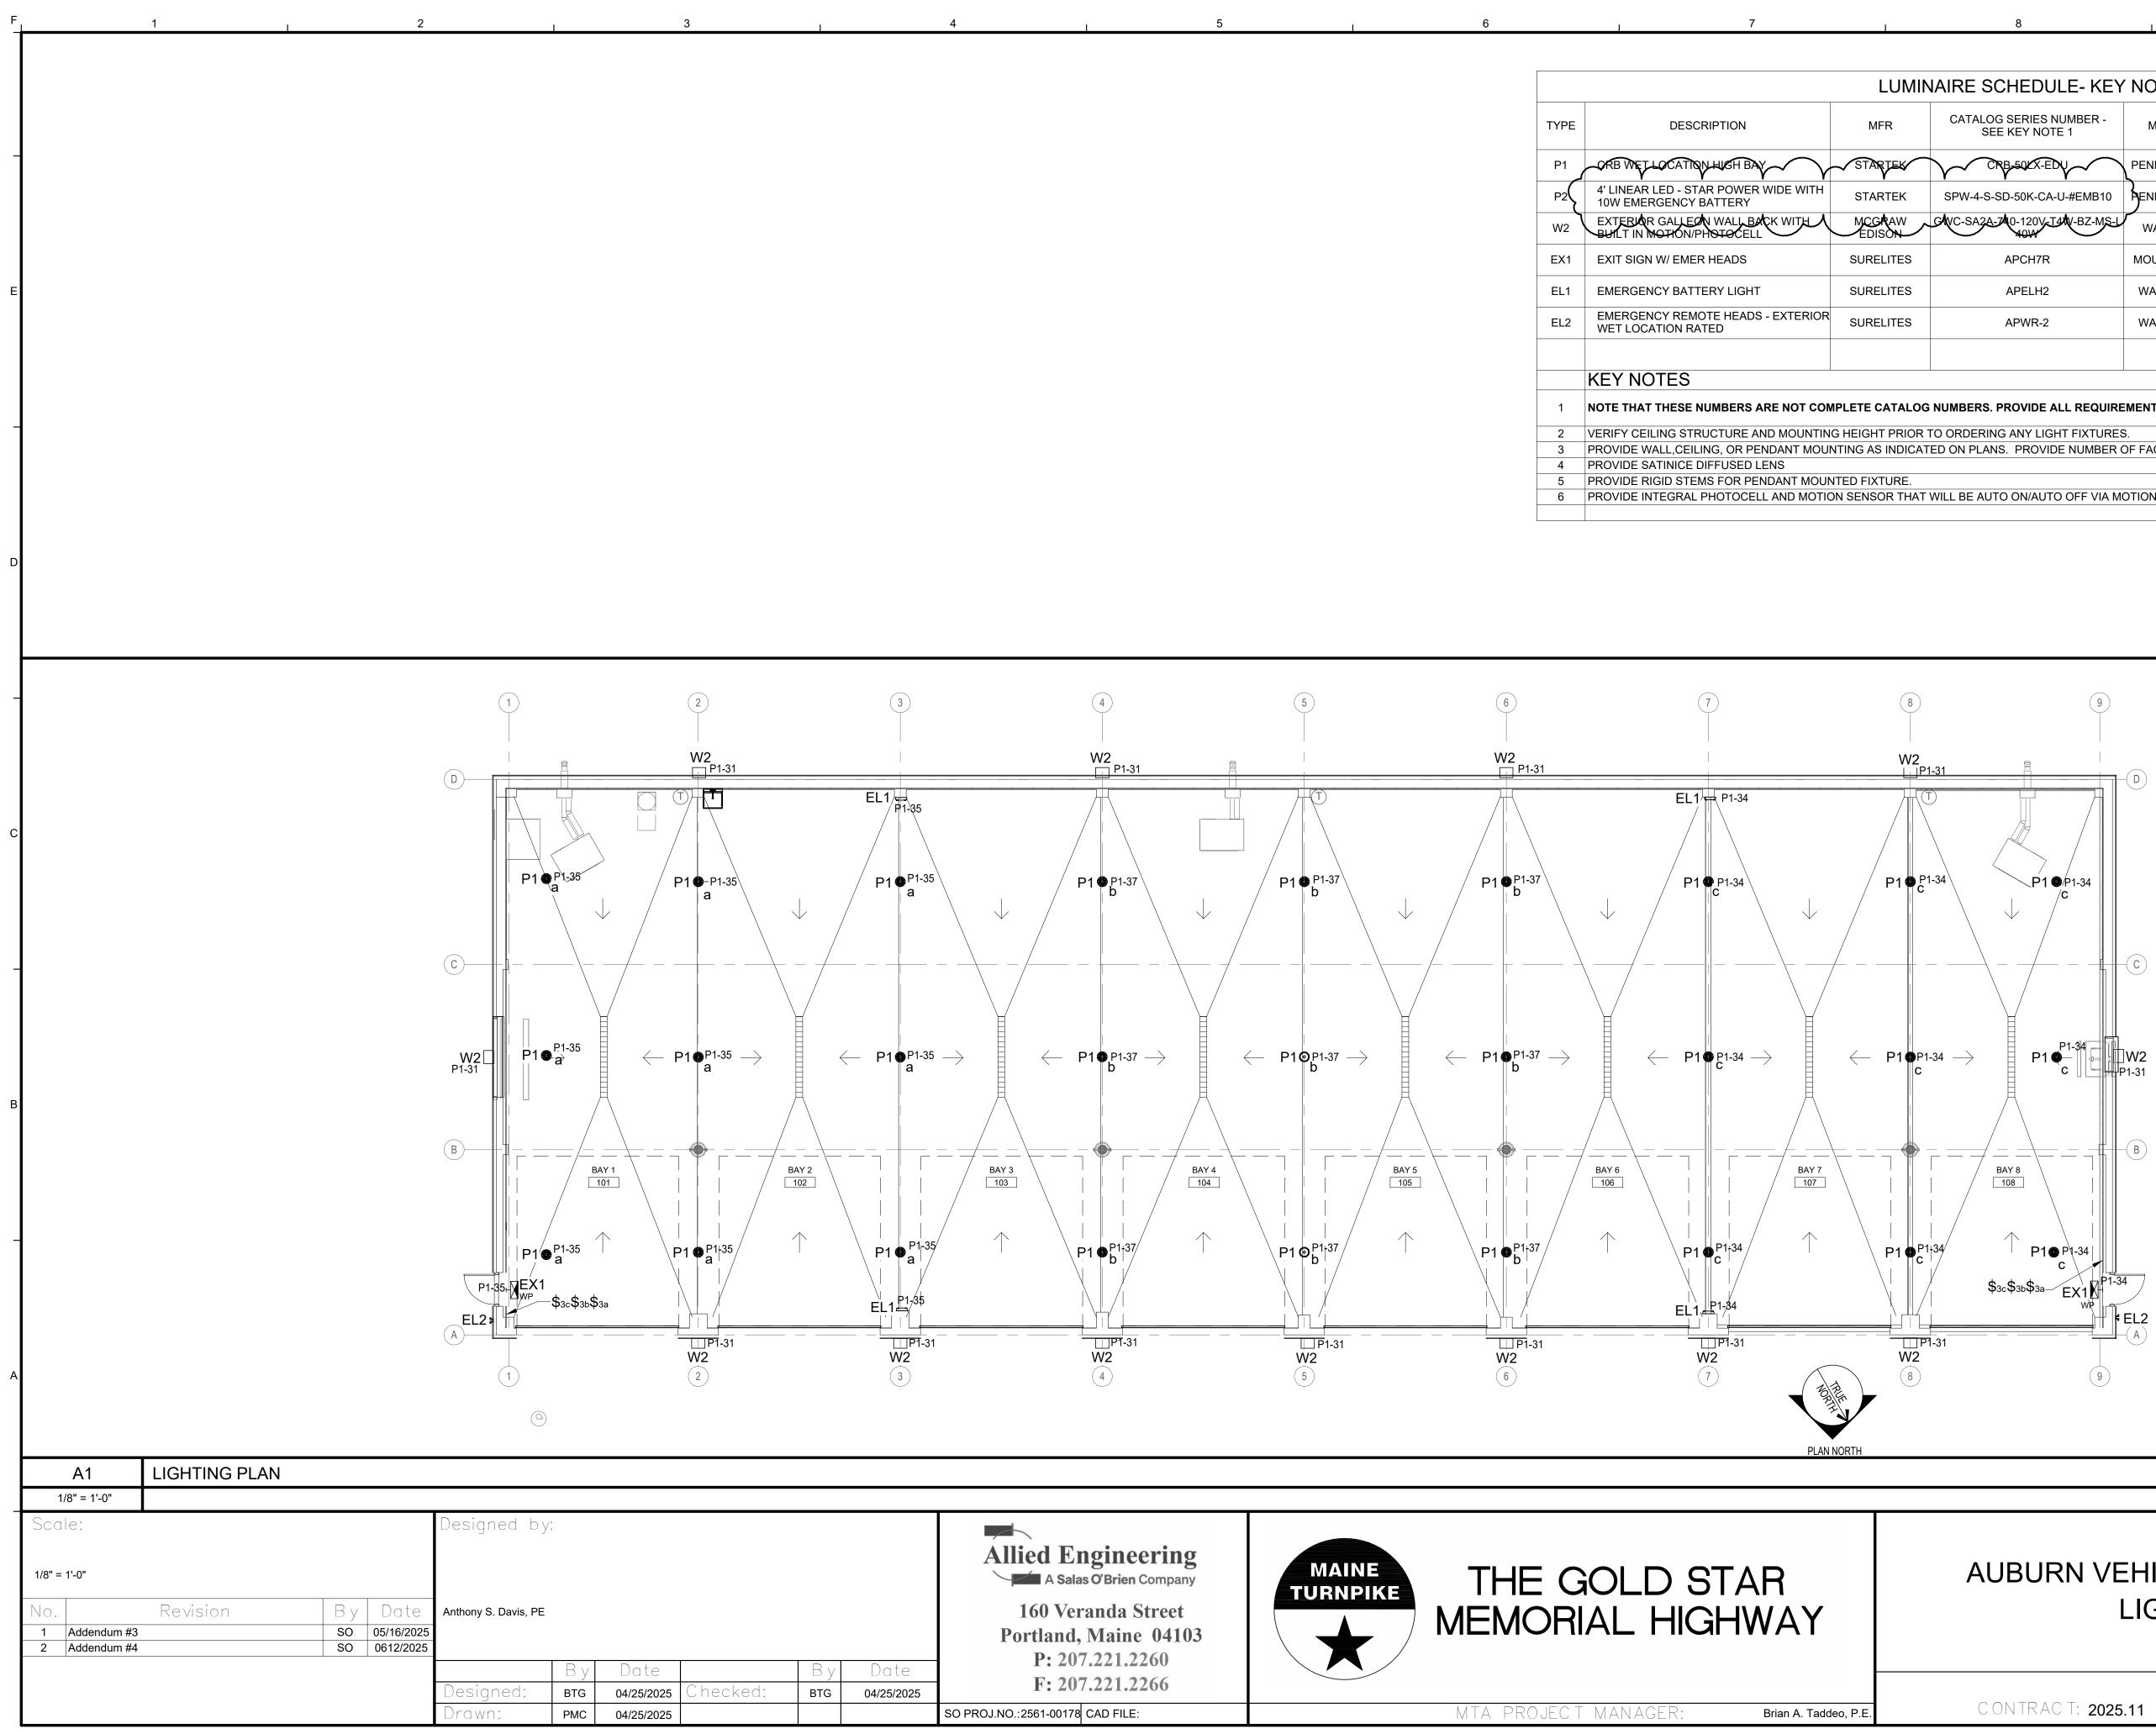

		LUMI	NAIRE SCHEDULE- KEY	NOTE 1,2					
							NGINE		
TYPE	DESCRIPTION	MFR	CATALOG SERIES NUMBER - SEE KEY NOTE 1	MOUNTING	VOLTS	WATTS	DELIVERED LUMENS	TYPE	NOTES
P1	ORB WETLOCATION HIGH BAY	STARTEK	CRB-50KX-EDV	PENDANT 16' AFF	120V	102W	14107	LED 5000K	5
P2	4' LINEAR LED - STAR POWER WIDE WITH 10W EMERGENCY BATTERY	STARTEK	SPW-4-S-SD-50K-CA-U-#EMB10	PENDANT 10' AFF	120V	68W	9764	LED 4000K	4
W2	EXTERIOR GALLEON WALL BACK WITH A	MCGRAW EDISON	CAVC-SA2A-740-120V-T4W-BZ-MS-L	WALL 17' AFF	120V	67	9658	LED 4000K	6
EX1	EXIT SIGN W/ EMER HEADS	SURELITES	APCH7R	MOUNT 7'-6" AFF	120VAC/ 12VDC	2.8W		LED	3
EL1	EMERGENCY BATTERY LIGHT	SURELITES	APELH2	WALL 7'-6" AFF	120VAC/ 12VDC	0.6W		LED	
EL2	EMERGENCY REMOTE HEADS - EXTERIOR WET LOCATION RATED	SURELITES	APWR-2	WALL 9'-0" AFF	120VAC/ 12VDC	.78W		LED	
	KEY NOTES								
1	NOTE THAT THESE NUMBERS ARE NOT COM	IPLETE CATALOG	NUMBERS. PROVIDE ALL REQUIRE	MENTS ON SCHEDU	ILE, NOTE	S, SPECS	, AND DRAWIN	IGS COMBINED).
2	VERIFY CEILING STRUCTURE AND MOUNTIN	G HEIGHT PRIOR	TO ORDERING ANY LIGHT FIXTURES	<u>д</u> .					
3	PROVIDE WALL, CEILING, OR PENDANT MOU	NTING AS INDICAT	ED ON PLANS. PROVIDE NUMBER (OF FACES AND ARR	OWS AS IN	DICATED			
4	PROVIDE SATINICE DIFFUSED LENS								
5	PROVIDE RIGID STEMS FOR PENDANT MOUI	NTED FIXTURE.							

AUBURN VEHICLE STORAGE GARAGE LIGHTING PLAN

SHEET NUMBER: **EL100**

F - †		1	I	2		I		3		I	
		MAXIMUM	PHASE AND N	EUTRAL GR				Е	PHASE A	ND NEUTRA	L
	TAG	AMPERE RATING	CONDUCT (NOTE 1		DUCTOR (NOTE DTE 2)			MPERE ATING		DUCTORS IOTE 1)	CC
	15D	15	3#12	1#12	3/4		00D	400	3#500 KCMIL		1#3
-	15Y 30D		4#12 3#10	1#12 1#10	3/4		00Y 50D	450	4#500 KCMIL 2 SETS OF 3#25	50 KCMIL	1#3 2 - #2
	30Y	30	4#10	1#10	3/4	' 4	50Y	450	2 SETS OF 4#25		2 - #2
	50D 50Y	50	3#8 4#8	1#10 1#10	3/4'		600D 600Y	500	2 SETS OF 3#25 2 SETS OF 4#25		2 - #2 2 - #2
	60D	60	3#6	1#10	3/4	' 6	00D	600	2 SETS OF 3#35	50 KCMIL	2 - #1
	60Y	00	4#6	1#10	1 1/2		000Y	000	2 SETS OF 4#35		2 - #1 2 - #1/
	80D 80Y	80	3#4 4#4	1#8 1#8	1 1/4		00D 00Y	700	2 SETS OF 3#50 2 SETS OF 4#50		2 - #1/
Е	100D	100	3#2	1#8	1 1/4		00D	800	2 SETS OF 3#60		2 - #1/
	100Y 125D		4#2 3#1	1#8 1#6	1 1/2		800Y		2 SETS OF 4#60 3 SETS OF 3#35		2 - #1/ 3 - #2/
	125Y	125	4#1	1#6	1 1/2		900Y	900	3 SETS OF 4#35		3 - #2/
	150D 150Y	150	3#1/0 4#1/0	1#6 1#6	1 1/2		0HD 0HY	1000	3 SETS OF 3#40 3 SETS OF 4#40		3 - #2/ 3 - #2/
	175D	175	3#2/0	1#6	2"	1	2HD	1200	3 SETS OF 3#60	00 KCMIL	3 - #3/
	175Y 200D		4#2/0 3#3/0	1#6 1#6	2"		2HY 6HD	1200	3 SETS OF 4#60 4 SETS OF 3#60		3 - #3/
_	200D	200	4#3/0	1#6	2"		6HY	1600	4 SETS OF 3#60		4 - #4/
	225D	225	3#4/0	1#4	2"		0HD	2000	5 SETS OF 3#60		5 - #25
	225Y 250D		4#4/0 3#250 KCMIL	1#4	2 1/2		0HY 5HD		5 SETS OF 4#60 6 SETS OF 3#60		5 - #25 6 - #35
	250Y	250	4#250 KCMIL	1#4	3"	2	5HY	2500	6 SETS OF 4#60	00 KCMIL	6 - #35
	300D 300Y	300	3#350 KCMIL 4#350 KCMIL	1#4 1#4	3"		0HD 0HY	3000	8 SETS OF 3#60 8 SETS OF 4#60		8 - #50 8 - #50
	350D	350	3#500 KCMIL	1#3	3 1/2		онр	4000	10 SETS OF 3#6		10 - #5
D	350Y			1#3			0HY 0HD	-000	10 SETS OF 4#6		10 - #5
		FEEDER SIZES	ANSFORMER SCHEDUL S	E FOR PRIMARY, SEC	JONDARY AND GRO		0HY	5000	12 SETS OF 3#6		12 - #5
			HEDULE NOTES:								1
		_	D ON COPPER THWN/T CONDUCTORS BASED (
			BASED ON EMT.								
			ENDIING IN "E" INDICAT EATER THAN 300 FEET								
-			STEM VOLTAGE IS 600							SIZES AFFR	OFRIATELT.
	7	FEEDER TAG E	ENDING IN "S" INDICAT	ES SERVICE ENTRAN	CE FEEDER. EXCL	JDE THE G	ROUND CON	IDUCTO	R INDICATED IN T	HE TABLE.	
-						/ R	EFER TO	CIVIL P	LANS FOR LO	CATION	
В						F	EMERGEN GENERAT 60KW 120/240 PHASE, 3 \	OR 1	METER AND CT CABINET		E • 400A (
A					 			400DS		JL	
	A1	POWE	ER RISER DIAG	RAM							
	NONE										
S	cale:				Designed k) у:	n -	<u></u>			
						9	Bring 1.	1/an	THE PROVIDENCE	Annum	ANNA N T
12	2" = 1'-0"						-1-	4		BRIAN T. GARDNEF	
N	0	Ravi	ision	By Date	Anthony S. Davis, I	ΡE			PR	No. 15506	
				SO 05/16/2025	, analony S. Davis, I	-				CENSE	Martin Allin
2				SO 06/10/2025						ONAL E	innu.
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					Designed:	BTG	04/25/20	25 C I	necked:	BTG (04/25/2025
					Drawn:	PMC	04/25/20	25			

L	GROUND CONDUCTOR (NOTE 2) CONDUIT (NOTE 3)			Location: BAY 1 101 Supply From: MDP					: 120/2 : 1	240 Si	ngle	M	A.I.C. Rating: REFER TO STUDY Mains Type: MCB		
	1#3	3 1/2"	-	Mounting: Surface				Wires:	3				us Rating: 250 A		
	1#3	4"	-									MC	CB Rating: 200 A		
	2 - #2	2 - 2 1/2"													
	2 - #2	2 - 3"	Notes												
	2 - #2	2 - 2 1/2"													
	2 - #2	2 - 3"												1	
	2 - #1	2 - 3"								- ·					
	2 - #1	2 - 3"	скт	Circuit Description	Trip Amps	Poles		4	в	2	Poles	Trip Amps	Circuit Description	скт	
	2 - #1/0	2 - 3 1/2"		CORD REELS BAYS 1-2	20	1	0.4	0.4		,	1	20	CORD REELS BAYS 3-4	2	
	2 - #1/0	2 - 4"	3	CORD REELS BAYS 5-6	20	1	0.4	0.4	0.4	0.4	1	20	CORD REELS BAYS 7-8	4	
	2 - #1/0	2 - 3 1/2"	5	Receptacles	20	1	0.9	1.1	0.1	0.1	1	20	Receptacles	6	
	2 - #1/0	2 - 4"	7	Receptacles	20	1			0.9	0.3	1	20	HEAT TRACE	8	
	3 - #2/0	3 - 3"	9	Receptacles	20	1	1.1	0.9			1	20	Receptacles	10	
	3 - #2/0	3 - 3"	11	HVAC CONTROL POWER	20	1			1.0	0.4	1	20	HVAC - DESTRAT FANS	12	
	3 - #2/0	3 - 2 1/2"	13	GAS UNIT HEATER 1	20	1	1.2	1.2			1	20	GAS UNIT HEATER 2	14	
	3 - #2/0	3 - 3"	15	GAS UNIT HEATER 3	20	1			1.2	4.8	2	00		16	
	3 - #3/0	3 - 4"	17	HVAC - EF-1	20	2	2.0	4.8			2	80	AC-1 - AIR COMPRESSOR	18	
	3 - #3/0	3 - 4"	19	HVAC - EF-1	30	2			2.0	2.3	2	30	HVAC - WH-1	20	
	4 - #4/0	4 - 4"	21	DOOR OPERATOR BAY 1	20	1	1.0	2.3			2			22	
	4 - #4/0	4 - 4"	23	DOOR OPERATOR BAY 2	20	1			1.0	1.0	1	20	DOOR OPERATOR BAY 3	24	
	5 - #250 KCMIL	5 - 4"	25	DOOR OPERATOR BAY 4	20	1	1.0	1.0			1	20	DOOR OPERATOR BAY 5	26	
	5 - #250 KCMIL	5 - 4"	27	DOOR OPERATOR BAY 6	20	1			1.0	1.0	1	20	DOOR OPERATOR BAY 7	28	
	6 - #350 KCMIL	6 - 4"	29	DOOR OPERATOR BAY 8	20	1	1.0	3.4			2	60	HVAC - SP-1	30	
	6 - #350 KCMIL	6 - 4"	31	EXTERIOR BUILDING	20	1			0.9	3.4				32	
	8 - #500 KCMIL	8 - 4"	33	LP GAS CO DETECTOR	20		0.5	0.9	0.0	0.0	1	20	Lighting Interior	34	
	8 - #500 KCMIL	8 - 4"	35	Lighting Interior	20	1	0.0	0.0	0.9	0.0	1	20	SPARE	36	
	10 - #500 KCMIL	10-4"	37	Lighting Interior	20	1	0.9	0.0	0.0	0.0	1	20	SPARE	38	
	10 - #500 KCMIL	10-4"	39	SPARE	20	1	0.0	0.0	0.0	0.0	1	20	SPARE	40	
	12 - #500 KCMIL	12-4"	41	SPARE	20	1	0.0			100/	1	20	SPARE	42	
	12 - #500 KCMIL	12-4"				al Load: al Amp:			22.5 187						
TROD	E SIZES).		HVAC Motor	;	nected L 15737 VA 9600 VA	Load De	mand 100.0 125.0	Facto 0% 0%		mateo 1573 1200	7 VA 0 VA	То	Panel Totals tal Conn. Load: 48.1 kW		
			Other		20 VA		100.0			20		Tot	al Est. Demand: 51.4 kW		
OPRIA	TELY.		Lightin	-	3507 VA		125.0			4383			Total Conn.: 200 A		
-			Powe	r	9430 VA	.	100.0	0%		9430) VA	Tot	al Est. Demand: 214 A		

4860 VA

3528 VA


Receptacle Heating


100.00%

100.00%

4860 VA

3528 VA

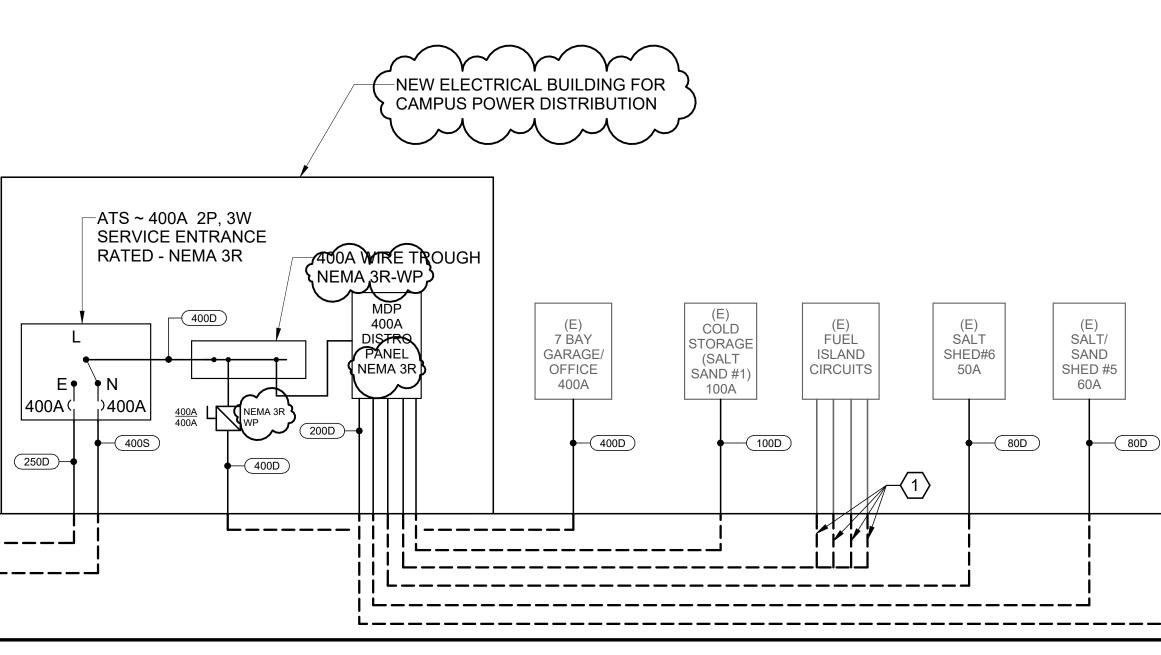

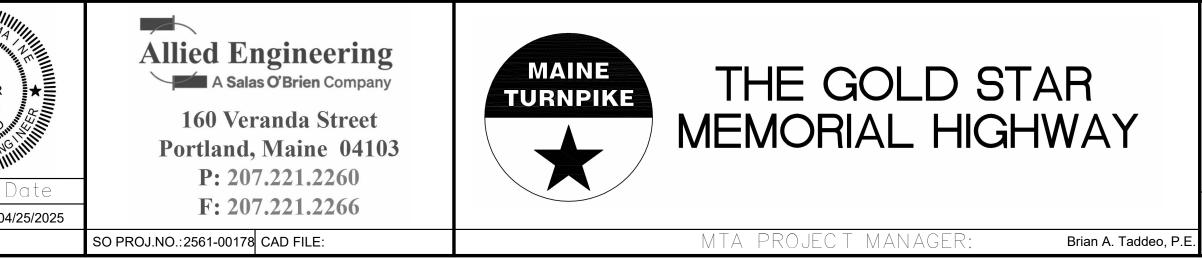

Lighting and Appliance Panelboard:MDP

Location:

Supply From:

Mounting: Surface

Volts: 120/240 Single Phases: Wires: 3

A.I.C. Rating: REFER TO STUDY Mains Type: MCB Bus Rating: 400 A MCB Rating: 400 A

① REFEEDING EXISTING PANELS/CIRCUITS ACROSS THE SITE WITH NEW FEEDERS


		Trip							Trip		
СКТ	Circuit Description	Amps	Poles	Α		E	В		Amps	Circuit Description	СКТ
1	(E) COLD STORAGE (SALT	100	2	0.0	0.0			2	50	(E) SALT SHED #6 (1)	2
3	SAND #1) (1)	100	2			0.0	0.0	2	50	(E) SALT SHED #0	4
5	(E) SALT/SAND SHED #5 (1)	60	2	0.0	0.0			2	20	GASOLINE SUB. (FUEL)	6
7	(E) SAET/SAIND SHED #3	00	2			0.0	0.0	2	20		8
9	DISPENSER HEAD (1)	20	1	0.0	0.0			2	20	DIESEL SUB.(FUEL) (1)	10
11	PETROVEND PUMP CNTL	20	1			0.0	0.0	2	20		12
13	LIGHTING - SHED	20	1	0.1	0.4			1	20	Receptacles - SHED	14
15	GEN. START CIRCUIT	20	1			0.0	0.0	1	20	GEN. BATTERY CHARGER	16
17	GEN JACKET/STRIP HEAT	20	1	0.0	25.6			2	200	P1 PANEL	18
19	SPARE	20	1			0.0	22.5	2	200		20
21	SPARE	20	1	0.0	0.0			1	20	SPARE	22
23	SPARE	20	1			0.0	0.0	1	20	SPARE	24
25	SPARE	20	1	0.0	0.0			1	20	SPARE	26
27	SPARE	20	1			0.0	0.0	1	20	SPARE	28
29	SPARE	20	1	0.0	0.0			1	20	SPARE	30
31	SPARE	20	1			0.0	0.0	1	20	SPARE	32
33	SPARE	20	1	0.0	0.0			1	20	SPARE	34
35	Space		1					1		Space	36
37	Space		1					1		Space	38
39	Space		1					1		Space	40
41	Space		1					1		Space	42
		Tota	al Load:	26.1	1 kW	22.5	5 kW				
		Tota	al Amp:	21	7 A	18	7 A				

Total Amp: 217 A 187 A

Load Classification	Connected Load	Demand Factor	Estimated Demand	Panel	Totals
HVAC	15737 VA	100.00%	15737 VA		
Motor	9600 VA	125.00%	12000 VA	Total Conn. Load:	48.5 kW
Other	88 VA	100.00%	88 VA	Total Est. Demand:	51.8 kW
Lighting	3507 VA	125.00%	4383 VA	Total Conn.:	202 A
Power	9430 VA	100.00%	9430 VA	Total Est. Demand:	216 A
Receptacle	5220 VA	100.00%	5220 VA		
Heating	3528 VA	100.00%	3528 VA		

KEY NOTES:

CONNECT TO EXISTING UNDERGROUND CONDUIT RUNS TO $^\prime$ EXISTING FUEL ISLAND EQUIPMENT. NEW FEEDERS SHALL BE RUN FROM FUEL EQUIPMENT AT ISLAND TO PANEL MDP. REFER TO PANEL MDP FOR CIRCUITING INFORMATION.

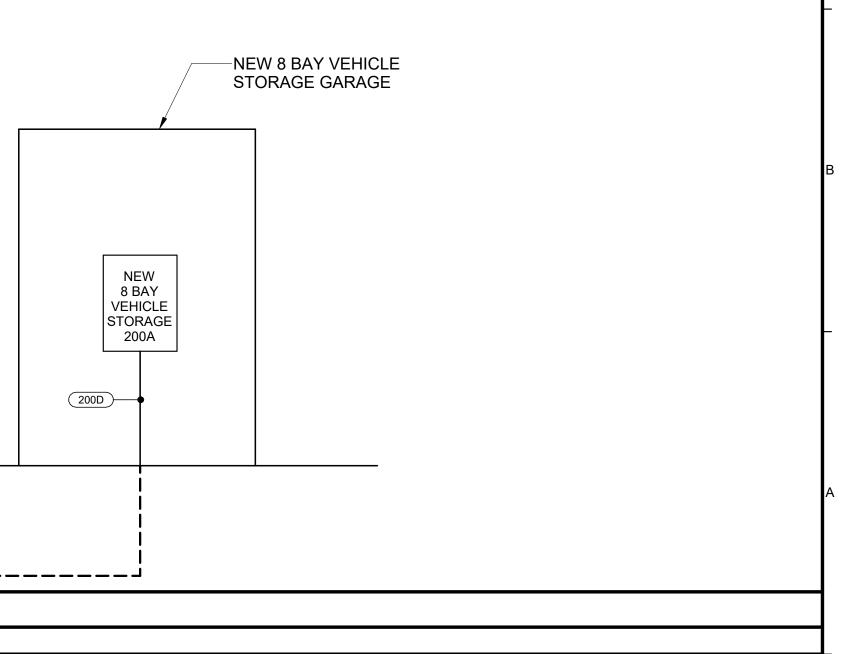

AUBURN VEHICLE STORAGE GARAGE POWER RISER DIAGRAM

CONTRACT: 2025.11

SHEET NUMBER: **EP500**